
SITE PLAN 241 RIVERVIEW AVENUE ASSESSORS MAP #40132 LOT #1 AUBURNDALE, MASSACHUSETTS

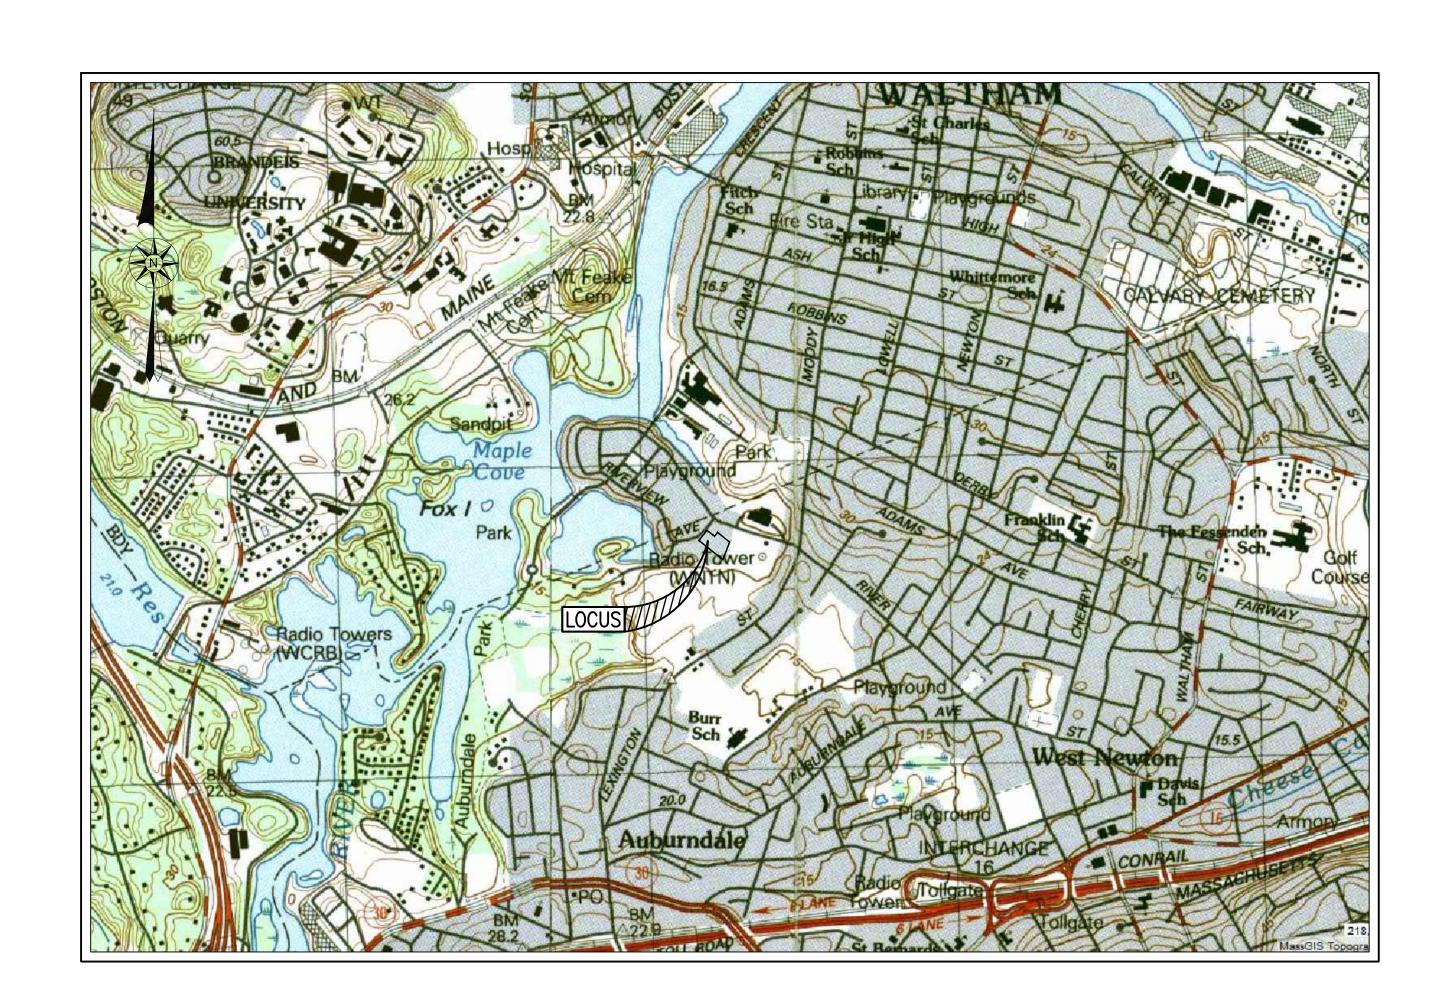

—AREA MAP— SCALE: 1"=1,000'±

- INDEX-

SHEET DESCRIPTION

COVER

LAYOUT & LANDSCAPING

UTILITIES

AVENUE -11032, LOT SSACHUSETTS

MAY 5, 2022

JOB NO. 21-575

LATEST REVISION: 051722

SHEET 1 OF 7


RECORD OWNER:
ASSESSORS MAP 41032 LOT 1 PACKARD COVE ASSOCIATES LLP 49 LEXINGTON STREET NEWTON, MA 02465 DEED BOOK 44587 PAGE 566



NOTES & LEGEND EXISTING CONDITIONS

DEMOLITION

DETAILS

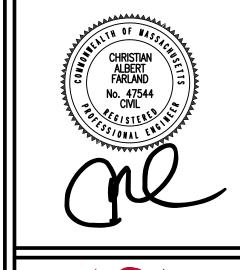



ENGINEERING SITEWORK LAND SURVEYING

DEVELOPMENT DRAWN BY: JKM

DESIGNED BY: JKM CHECKED BY: CAF

SCALE: N.T.S.

COVER

GENERAL CONSTRUCTION NOTES

- 1. THE CONTRACTOR IS SPECIFICALLY CAUTIONED THAT THE LOCATION AND/OR ELEVATION OF EXISTING UTILITIES AND STRUCTURES AS SHOWN ON THESE PLANS IS BASED ON RECORDS OF VARIOUS UTILITY COMPANIES AND WHERE POSSIBLE, MEASUREMENTS TAKEN IN THE FIELD. THIS INFORMATION IS NOT TO BE RELIED ON AS BEING EXACT OR COMPLETE. THE LOCATION OF ALL UNDERGROUND UTILITIES AND STRUCTURES SHALL BE VERIFIED IN THE FIELD BY THE CONTRACTOR PRIOR TO THE START OF CONSTRUCTION. THE CONTRACTOR MUST CONTACT THE
- APPROPRIATE UTILITY COMPANY, ANY GOVERNING PERMITTING AUTHORITY, AND "DIG SAFE" AT LEAST 72 HOURS PRIOR TO ANY EXCAVATION WORK TO REQUEST EXACT FIELD LOCATION OF UTILITIES INTERFERING WITH THE PROPOSED CONSTRUCTION AND APPROPRIATE REMEDIAL ACTION TAKEN BEFORE PROCEEDING WITH THE WORK. IT SHALL BE THE RESPONSIBILITY OF THE CONTRACTOR TO RELOCATE ALL EXISTING UTILITIES WHICH CONFLICT WITH THE PROPOSED IMPROVEMENTS SHOWN ON THE PLAN.
- PROPERTY LINE INFORMATION TAKEN FROM: DEED BOOK 44587, PAGE 566. TOPOGRAPHIC SURVEY PERFORMED BY FARLAND CORP. IN AUGUST 2021.
- VERTICAL ELEVATIONS REFER TO AN ASSUMED DATUM AND HORIZONTAL LOCATIONS REFER TO THE NORTH AMERICAN
- DATUM (NAD) OF 1983. 5. ALL CONSTRUCTION SHALL BE IN ACCORDANCE WITH ALL APPLICABLE STATE AND LOCAL STANDARDS AND
- REGULATIONS. 6. THE CONTRACTOR SHALL BE RESPONSIBLE FOR ESTABLISHING AND MAINTAINING ALL CONTROL POINTS AND BENCH
- MARKS NECESSARY FOR THE WORK. WHERE PROPOSED PAVEMENT AND WALKS ARE TO MEET EXISTING, THE CONTRACTOR SHALL SAWCUT A NEAT LINE AND MATCH GRADE. SEAL ALL JOINTS WITH HOT BITUMINOUS ASPHALT JOINT SEALER.
- 8. CURBING TO BE AS INDICATED ON THE PLANS. 9. ALL EXISTING TREES, SHRUBS AND GROUND COVER WHERE NATURAL GRADE IS TO BE RETAINED SHALL BE KEPT IN THEIR EXISTING STATE UNLESS REMOVAL IS REQUIRED FOR CONSTRUCTION PURPOSES. THE NUMBER OF REMOVED
- TREES SIX CALIPER OR LARGER SHALL BE MINIMIZED. 10. ALL AREAS DISTURBED BY CONSTRUCTION AND NOT TO BE PAVED OR OTHERWISE TREATED AS NOTED ON PLAN
- SHALL BE TREATED WITH 4" OF LOAM, SEEDED AND HAY MULCHED FOR EROSION CONTROL. 11. SITE IMPROVEMENTS SHALL CONFORM TO A.D.A. SPECIFICATIONS.
- 12. THE CONTRACTOR SHALL PROTECT AND/OR CAP OFF ALL EXISTING ON-SITE UTILITY SERVICES ACCORDING TO THE LOCAL AUTHORITY'S SPECIFICATIONS. SERVICES SHALL BE CAPPED OFF WHERE SAME ENTER THE PERIMETER OF
- 13. CONTRACTOR SHALL THOROUGHLY FAMILIARIZE THEMSELVES WITH ALL CONSTRUCTION DOCUMENTS, SPECIFICATIONS
- AND SITE CONDITIONS PRIOR TO BIDDING AND PRIOR TO CONSTRUCTION. 14. ANY DISCREPANCIES BETWEEN DRAWINGS. SPECIFICATIONS AND SITE CONDITIONS SHALL BE REPORTED IMMEDIATELY TO THE OWNER'S REPRESENTATIVE FOR CLARIFICATION AND RESOLUTION PRIOR TO BIDDING OR CONSTRUCTION.
- 15. THESE PLANS ARE PERMITTING PLANS AND SHALL NOT TO BE USED FOR CONSTRUCTION. A FINAL SET OF STAMPED PLANS FOR CONSTRUCTION WILL BE ISSUED AFTER RECEIVING FINAL APPROVAL FROM THE LOCAL AND/OR STATE DEPARTMENTS.
- 16. ANY MINOR MODIFICATIONS (AS DETERMINIED BY THE CITY PLANNER) TO THE INFORMATION SHOWN ON THE APPROVED SITE PLANS SHALL BE SUBMITTED TO THE CITY PLANNER AS A MINOR PLAN REVISION FOR APPROVAL PRIOR TO WORK BEING PERFORMED.
- 17. ANY WORK AND MATERIAL WITHIN THE CITY RIGHT-OF-WAY SHALL CONFORM TO THE CITY OF NEWTON
- REQUIREMENTS.
- 18. ALL HANDICAP PARKING, RAMPS, AND ACCESS SHALL CONFORM TO AAB & MAAB REQUIREMENTS. 19. ALL EROSION CONTROL MEASURES SHALL BE IN PLACE PRIOR TO CONSTRUCTION. EROSION CONTROL SHALL CONFORM TO CITY OF NEW BEDFORD CONSERVATION COMMISSION REQUIREMENTS AS STATED IN THE ORDER OF CONDITIONS.
- 20. ALL PAVEMENT MARKINGS AND SIGNS SHALL CONFORM TO MUTCD REQUIREMENTS.
- 21. THE CONTRACTOR SHALL OBTAIN DPW SIDEWALK INSTALLATION AND TRENCH PERMIT PRIOR TO ANY CONSTRUCTION WITHIN THE RIGHT OF WAY.
- 22. THE CITY SHALL BE NOTIFIED AT LEAST 24 HOURS PRIOR TO THE REQUIRED INSPECTIONS.

LAYOUT AND MATERIAL NOTES


- CONTRACTOR SHALL THOROUGHLY FAMILIARIZE THEMSELVES WITH ALL CONSTRUCTION DOCUMENTS. SPECIFICATIONS AND SITE CONDITIONS PRIOR TO BIDDING AND PRIOR TO CONSTRUCTION.
- ANY DISCREPANCIES BETWEEN DRAWINGS, SPECIFICATIONS AND SITE CONDITIONS SHALL BE REPORTED IMMEDIATELY TO THE OWNER'S REPRESENTATTIVE FOR CLARIFICATION AND RESOLUTION PRIOR TO BIDDING OR CONSTRUCTION.
- 3. SEE ARCHITECTURAL DRAWINGS FOR EXACT BUILDING DIMENSIONS AND ALL DETAILS CONTIGUOUS TO THE BUILDING INCLUDING SIDEWALKS, RAMPS, UTILITY ENTRANCE LOCATIONS, WALL PACKS, CONCRETE DOOR PADS, ROOF DRAINS, ETC.
- ACCESSIBLE CURB RAMPS SHALL BE PER THE MASSACHUSETTS ARCHITECTURAL ACCESS BOARD AND THE
- AMERICANS WITH DISABILITIES ACT ACCESSIBLITY GUIDELINES, WHICHER IS MORE STRINGENT. THE FOLLOWING LAYOUT CRITERIA SHALL CONTROL UNLESS OTHERWISE NOTED ON THE PLAN:
- ALL DIMENSIONS ARE TO OUTSIDE FACE OF BUILDING.
- ALL DIMENSIONS ARE TO FACE OF CURB AT GUTTER LINE. ALL DIMENSIONS ARE TO CENTER OF PAVEMENT MARKINGS.
- ALL TIES TO PROPERTY LINES ARE PERPENDICULAR TO THE PROPERTY LINE UNLESS OTHERWISE NOTED.


SITE PREPARATION NOTES


- 1. WITHIN THE LIMIT OF WORK LINE AS NOTED ON THE SITE PLANS, REMOVE AND DISCARD ALL CONCRETE PAVEMENT, BITUMINOUS CONCRETE PAVEMENT, BRICK PAVEMENT, TOP SOIL, MULCH, TRASH, DEAD TREES AND STUMPS, SHRUBBERY, CHAIN LINK FENCE POSTS, RAILS, FABRIC, GATES, FOOTINGS AND ALL APPURTENANCES, BOLLARDS, POSTS, CONCRETE FOOTINGS AND FOUNDATIONS, WALLS AND CURBS UNLESS OTHERWISE NOTED.
- 2. THE OWNER'S REPRESENTATIVE SHALL BE CONSULTED AND WILL REVIEW THE WORK ON SITE WITH THE CONTRACTOR BEFORE ANY WORK SHALL COMMENCE.
- 3. THE CONTRACTOR SHALL VERIFY ALL EXISTING CONDITIONS IN THE FIELD AND REPORT ANY DISCREPANCIES
- BETWEEN PLANS AND ACTUAL CONDITIONS TO THE OWNER'S REPRESENTATIVE PRIOR TO STARTING WORK. 4. THE CONTRACTOR IS RESPONSIBLE FOR ANY DAMAGE TO EXISTING CONDITIONS TO REMAIN THAT ARE DUE TO CONTRACTOR OPERATIONS.
- ≝5. ALL ITEMS TO BE REMOVED THAT ARE NOT STOCKPILED FOR LATER REUSE ON THE PROJECT OR DELIVERED TO THE OWNER SHALL BE LEGALLY DISPOSED OF OFF SITE BY THE CONTRACTOR.
- THE CONTRACTOR SHALL BE RESPONSIBLE FOR COORDINATING HIS EFFORTS OF THE DEMOLITION WITH ALL TRADES. THE CONTRACTOR SHALL COORDINATE ALL ADJUSTMENT OR ABANDONMENT OF UTILITIES WITH THE RESPECTIVE UTILITY COMPANY.
- THE CONTRACTOR SHALL MAINTAIN OR ADJUST TO NEW FINISH GRADES AS NECESSARY ALL UTILITY AND SITE STRUCTURES SUCH AS LIGHT POLES, SIGN POLES, MANHOLES, CATCH BASINS, HAND HOLES, WATER AND GAS GATES, HYDRANTS, ETC., FROM MAINTAINED UTILITY AND SITE SYSTEMS UNLESS OTHERWISE NOTED OR DIRECTED BY THE OWNER'S REPRESENTATIVE.

UTILITY AND GRADING NOTES

- 1. WHERE PROPOSED GRADES MEET EXISTING GRADES, CONTRACTOR SHALL BLEND GRADES TO PROVIDE A SMOOTH TRANSITION BETWEEN EXISTING AND NEW WORK. PONDING AT TRANSITION AREAS WILL NOT BE ALLOWED. CONTRACTOR SHALL MAINTAIN POSITIVE DRAINAGE AWAY FROM ALL BUILDING FOUNDATIONS AND STRUCTURES.
- MAXIMUM SLOPE IN DISTURBED AREAS SHALL NOT EXCEED 3:1, UNLESS OTHERWISE NOTED.
- CONTRACTOR SHALL VERIFY EXISTING GRADES AND NOTIFY OWNER'S REPRESENTATIVE OF ANY DISCREPANCIES. CONTRACTOR SHALL ADJUST UTILITY ELEMENT MEANT TO BE FLUSH WITH GRADE THAT IS AFFECTED BY SITE WORK
- OR GRADE CHANGES. WHETHER SPECIFICALLY NOTED ON PLANS OR NOT. WHERE AN EXISTING UTILITY IS FOUND TO CONFLICT WITH THE PROPOSED WORK, THE LOCATION, ELEVATION AND SIZE OF THE UTILITY SHALL BE ACCURATELY DETERMINED WITHOUT DELAY BY THE CONTRACTOR, AND THE
- INFORMATION FURNISHED TO THE OWNER'S REPRESENTATIVE FOR RESOLUTION OF THE CONFLICT. DEVELOPER TO CHECK CONDITION OF EXISTING SEWER AND WATER SERVICES TO BE MAINTAINED AND REUSED.
- THE CONTRACTOR SHALL MAKE ALL ARRANGEMENTS FOR THE ALTERATION AND ADJUSTMENT OF ALL GAS. ELECTRIC. TELEPHONE AND ANY OTHER PRIVATE UTILITIES BY THE UTILITY COMPANIES.
- THE LOCATION, SIZE, DEPTH AND SPECIFICATIONS FOR CONSTRUCTION OF PRIVATE UTILITY SERVICES SHALL BE INSTALLED ACCORDING TO THE REQUIREMENTS PROVIDED BY AND APPROVED BY THE RESPECTIVE UTILITY COMPANY (GAS, TELEPHONE AND ELECTRICAL). FINAL DESIGN AND LOCATIONS AT THE BUILDING WILL BE PROVIDED BY THE ARCHITECT. THE CONTRACTOR SHALL COORDINATE THE INSTALLATION OF THE UTILITY CONNECTIONS WITH THE RESPECTIVE COMPANIES PRIOR TO ANY UTILITY CONSTRUCTION.

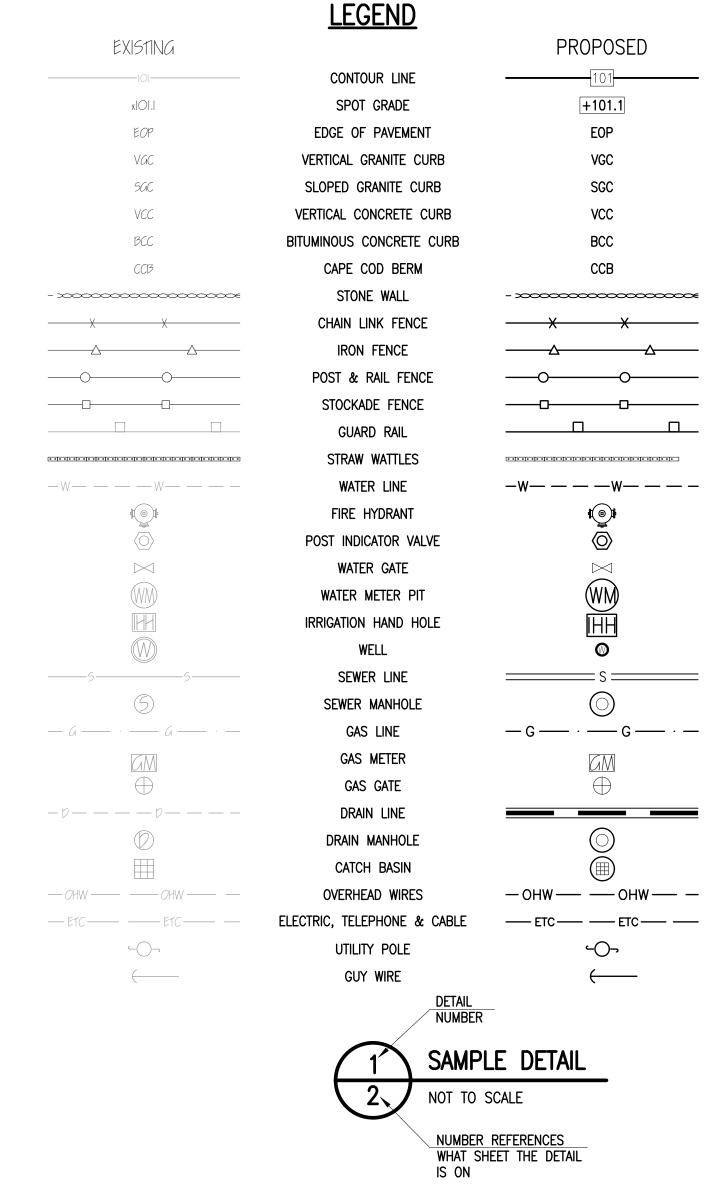

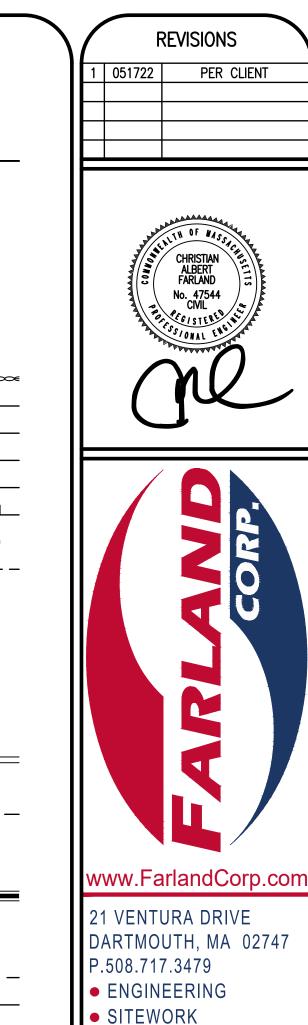

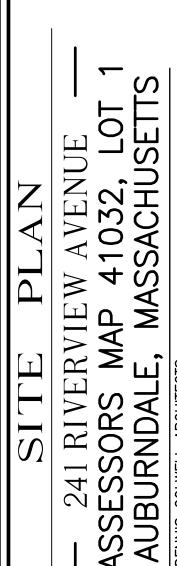

LAND SURVEYING

DEVELOPMENT

DRAWN BY: JKM

DESIGNED BY: JKM


CHECKED BY: CAF

MAY 5, 2022


SCALE: 1" = 10"JOB NO. 21-575 LATEST REVISION: 051722

SHEET 2 OF 7

NOTES & LEGEND

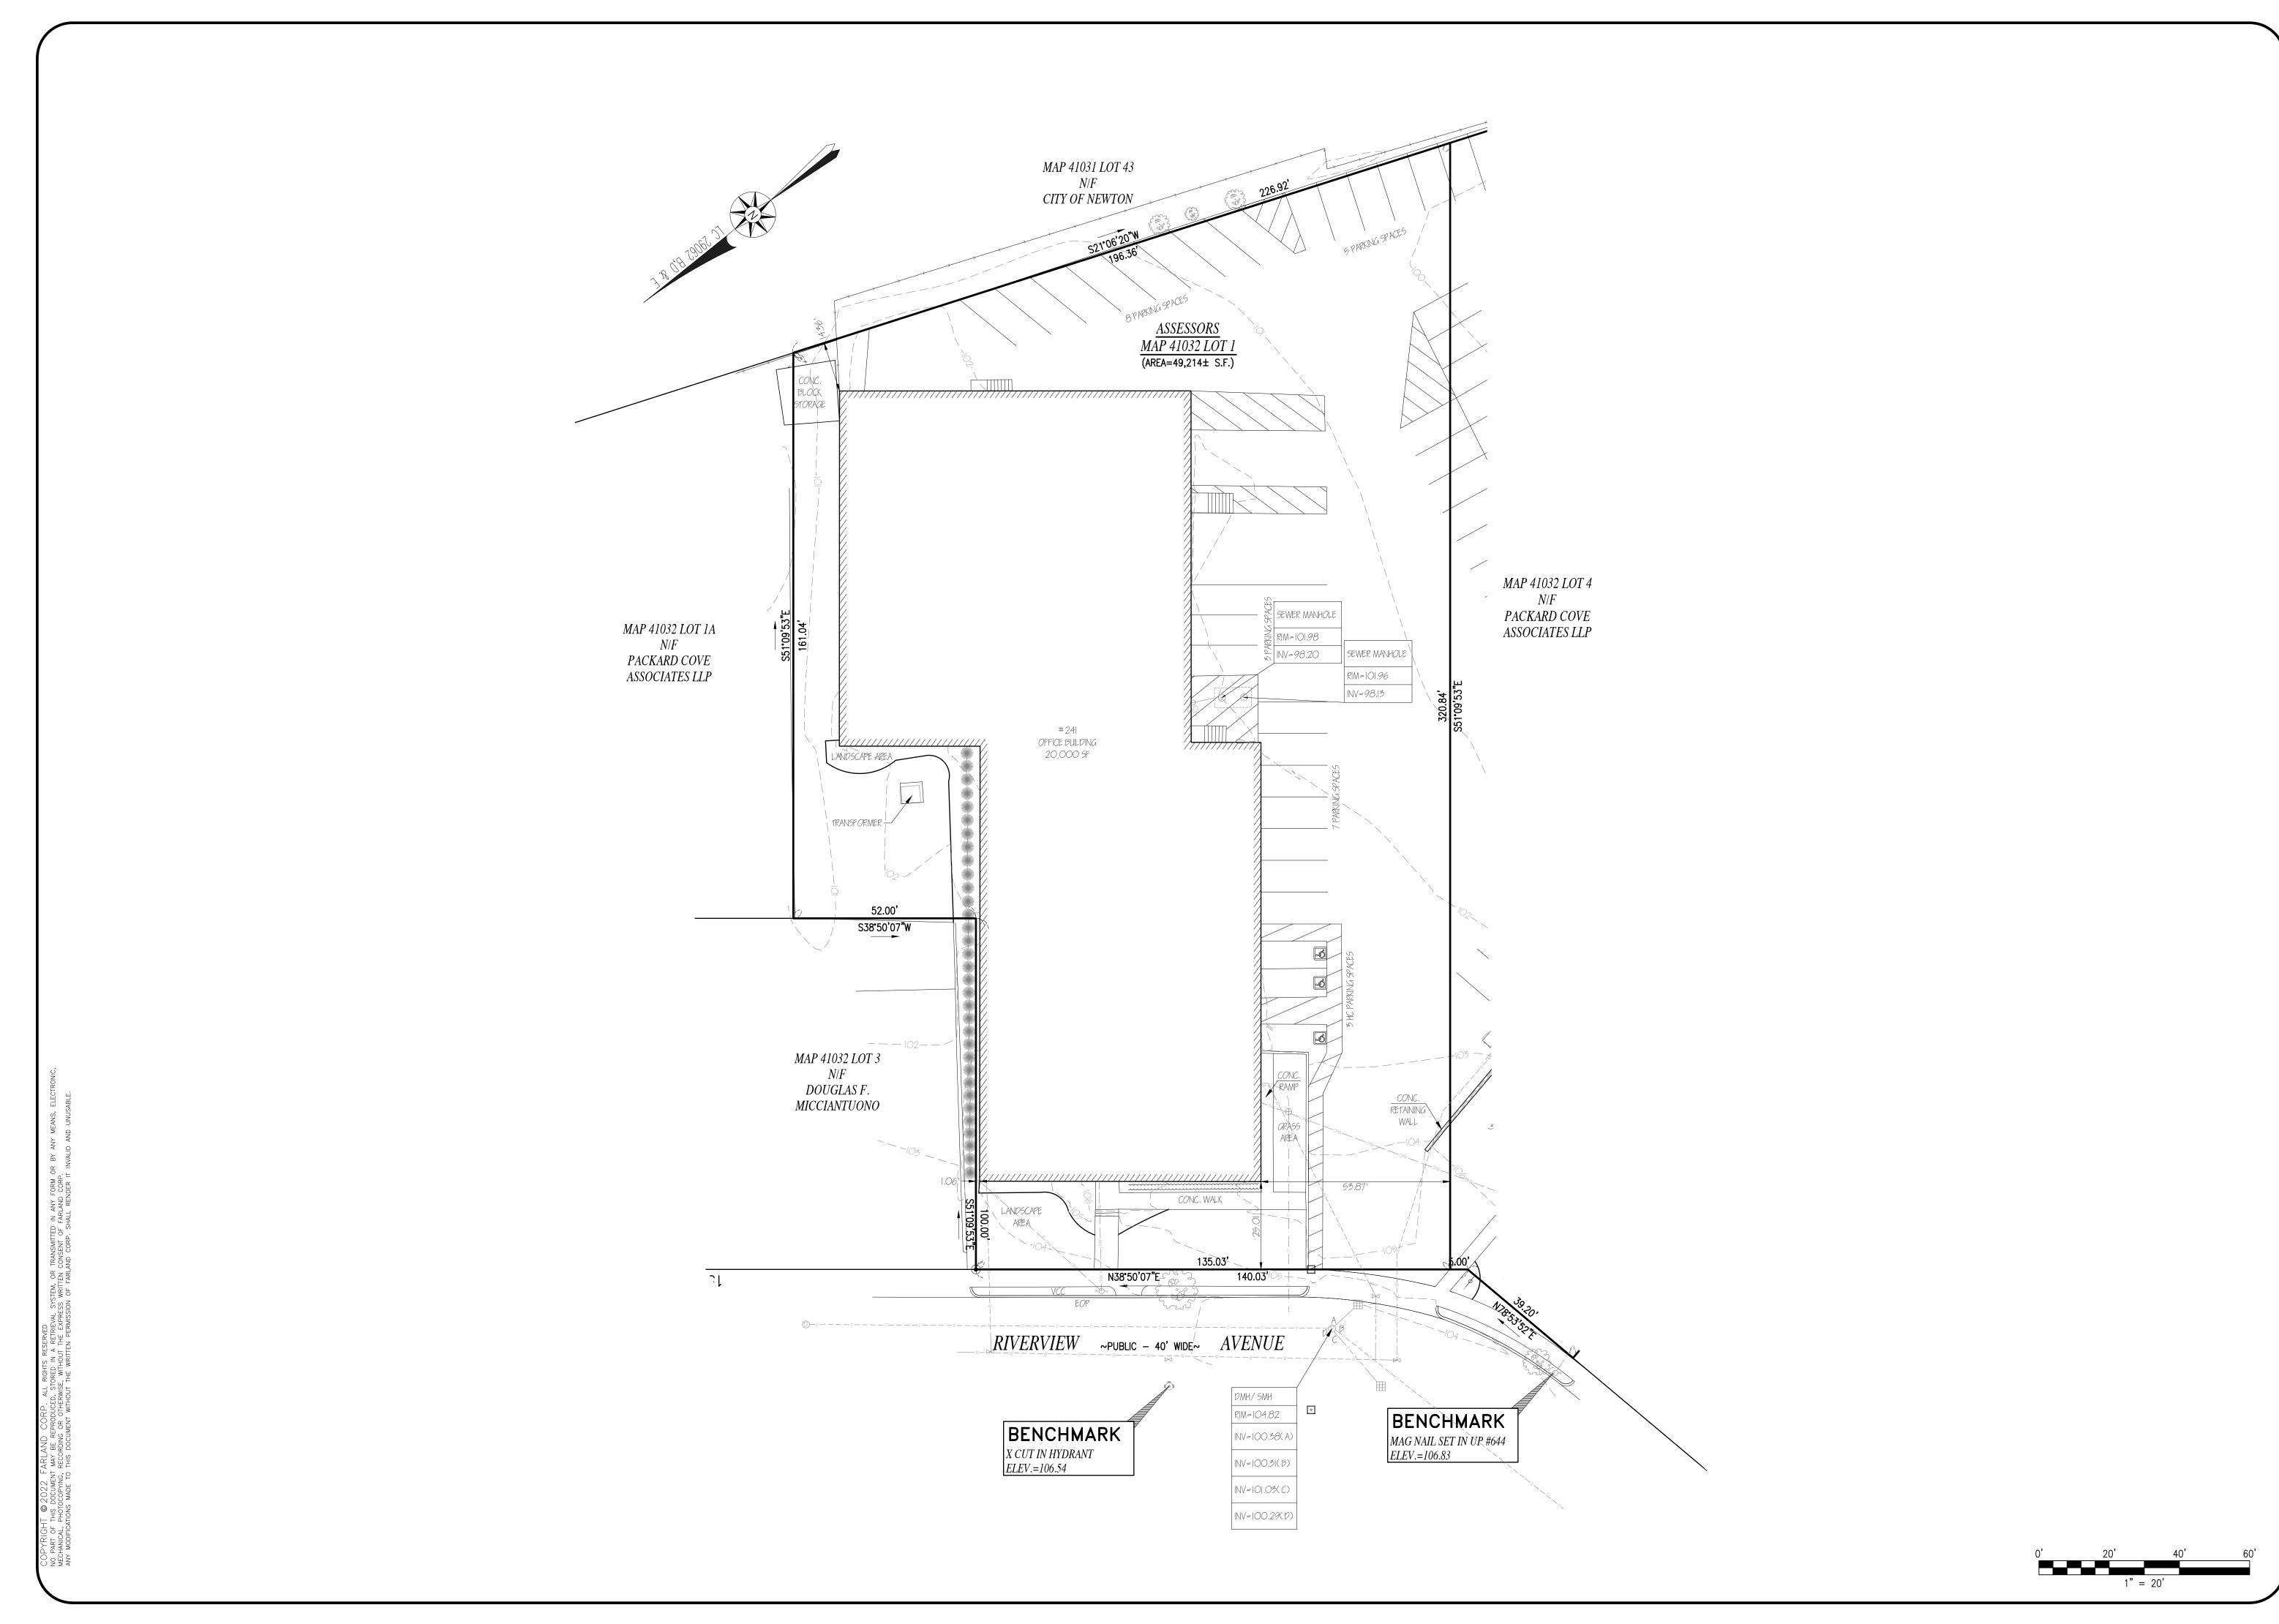

1 051722 PER CLIENT

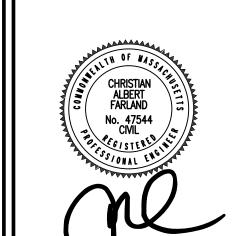



21 VENTURA DRIVE

DARTMOUTH, MA 02747 P.508.717.3479

ENGINEERING SITEWORK

LAND SURVEYING DEVELOPMENT

DRAWN BY: JKM DESIGNED BY: JKM


CHECKED BY: CAF

MAY 5, 2022 SCALE: N.T.S. JOB NO. 21-575

LATEST REVISION: 051722

EXISTING CONDITIONS

SHEET 3 OF 7

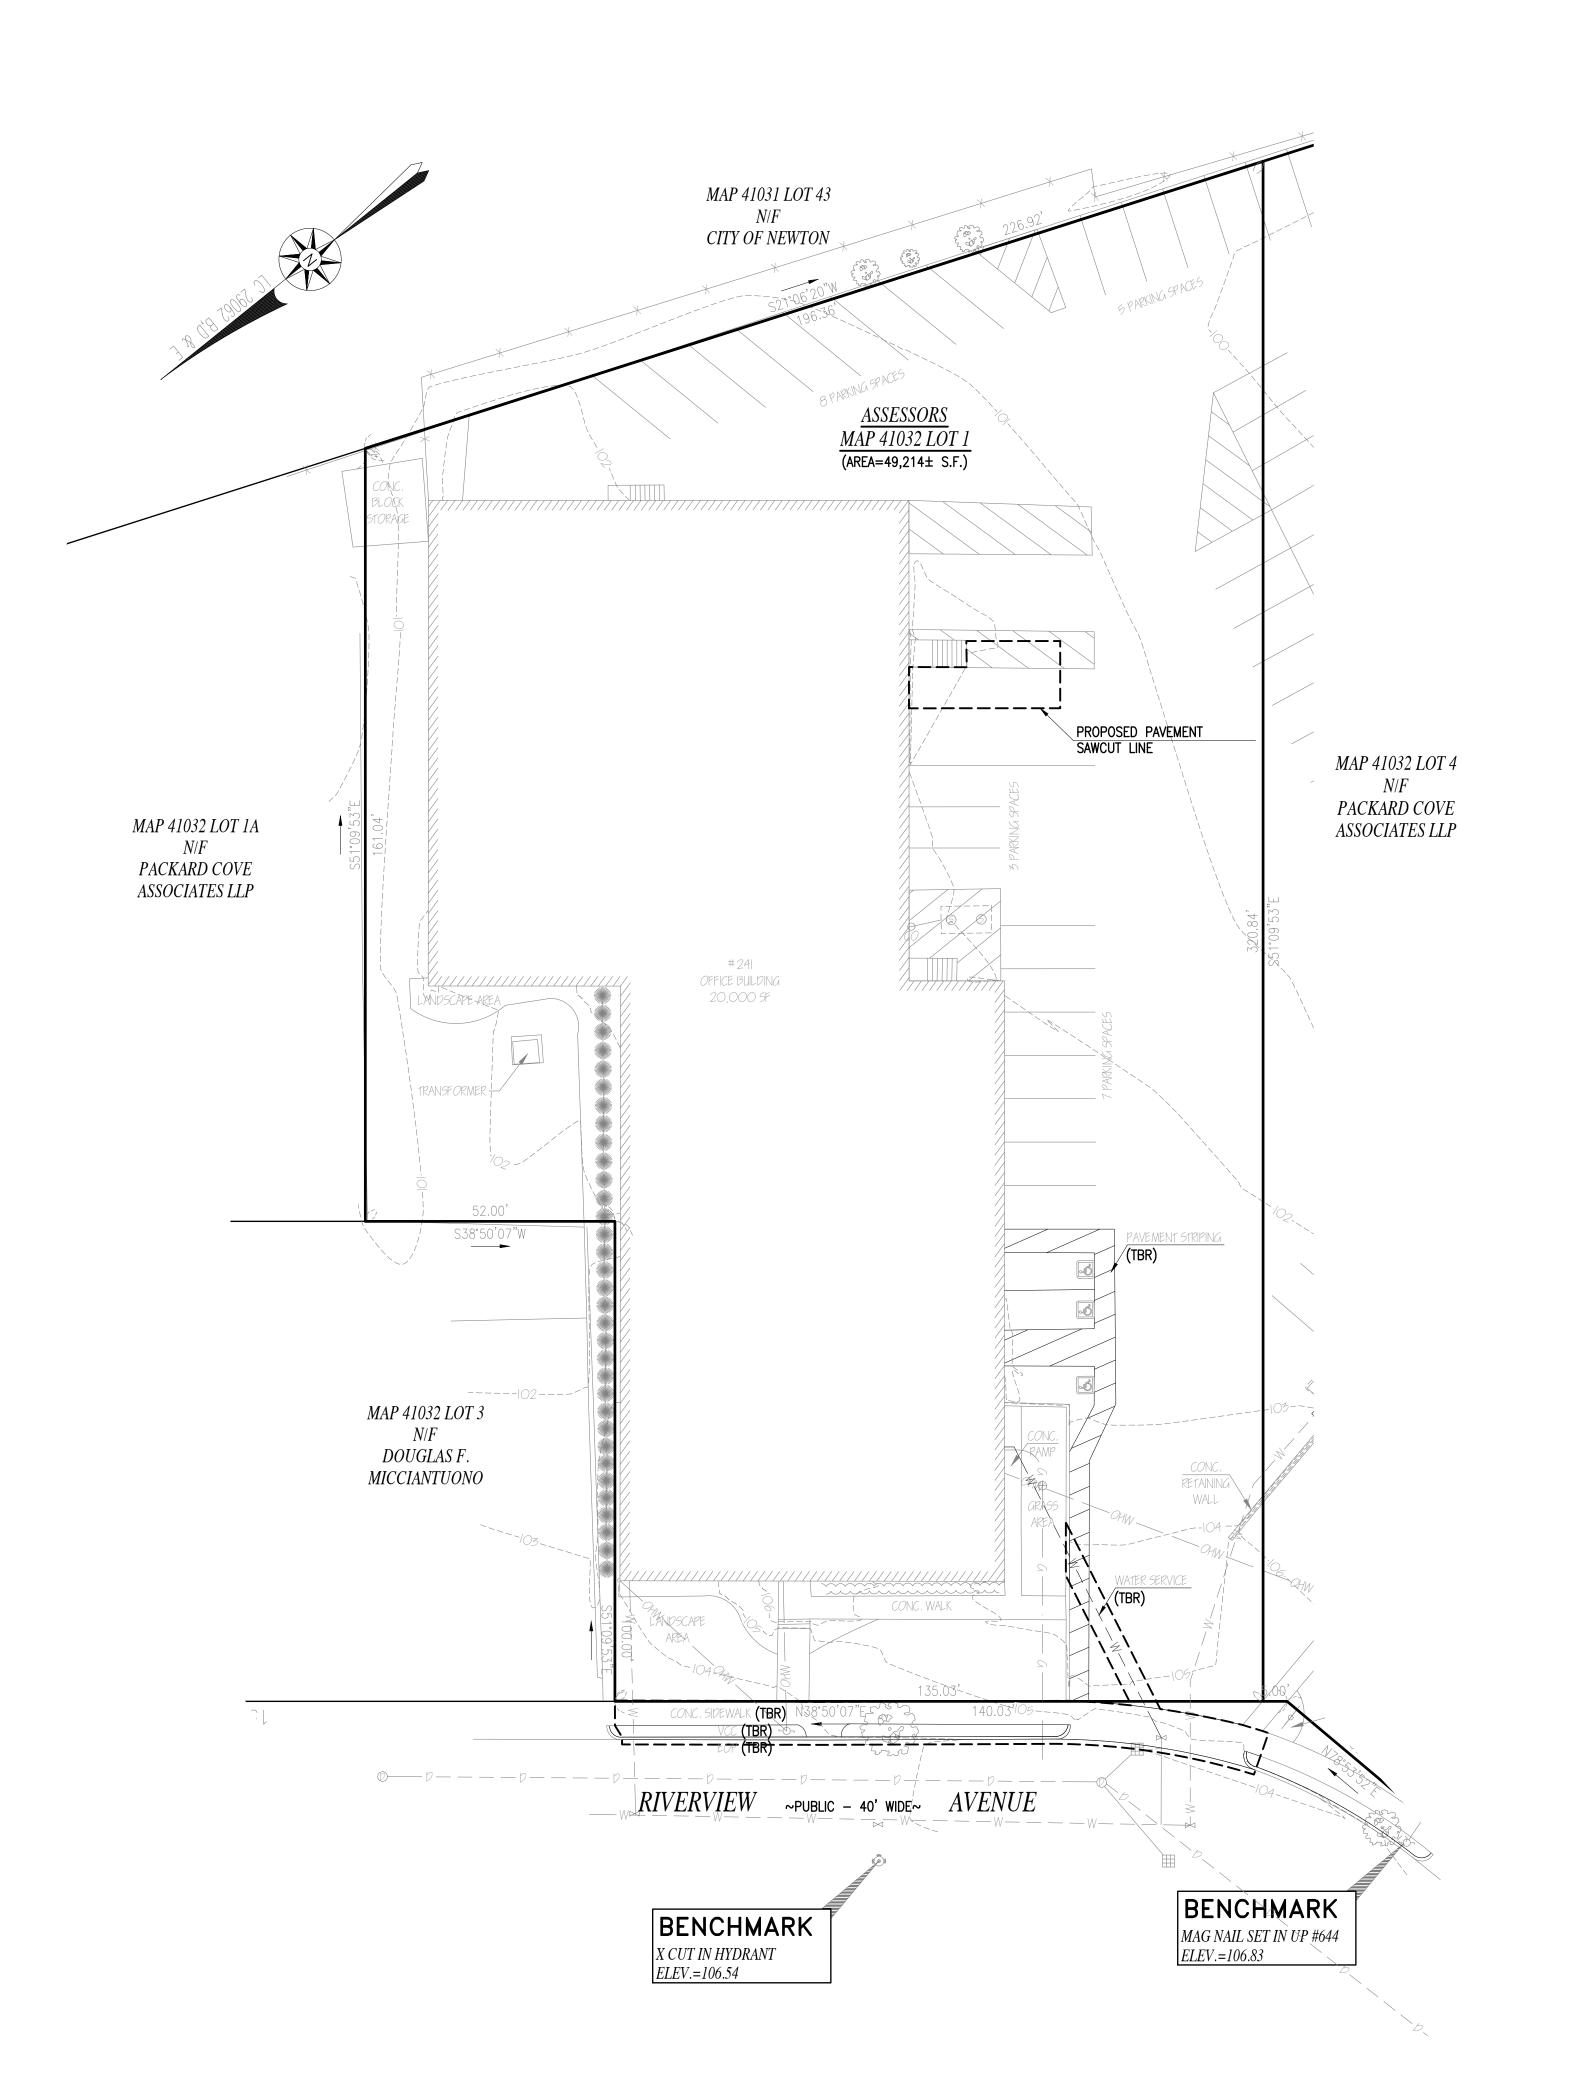

1 051722 PER CLIENT





21 VENTURA DRIVE DARTMOUTH, MA 02747 P.508.717.3479

ENGINEERING

SITEWORK LAND SURVEYING DEVELOPMENT


DRAWN BY: JKM DESIGNED BY: JKM

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MAY 5, 2022 SCALE: 1"= 20' JOB NO. 21-575 LATEST REVISION:

> 051722 DEMOLITION

SHEET 4 OF 7

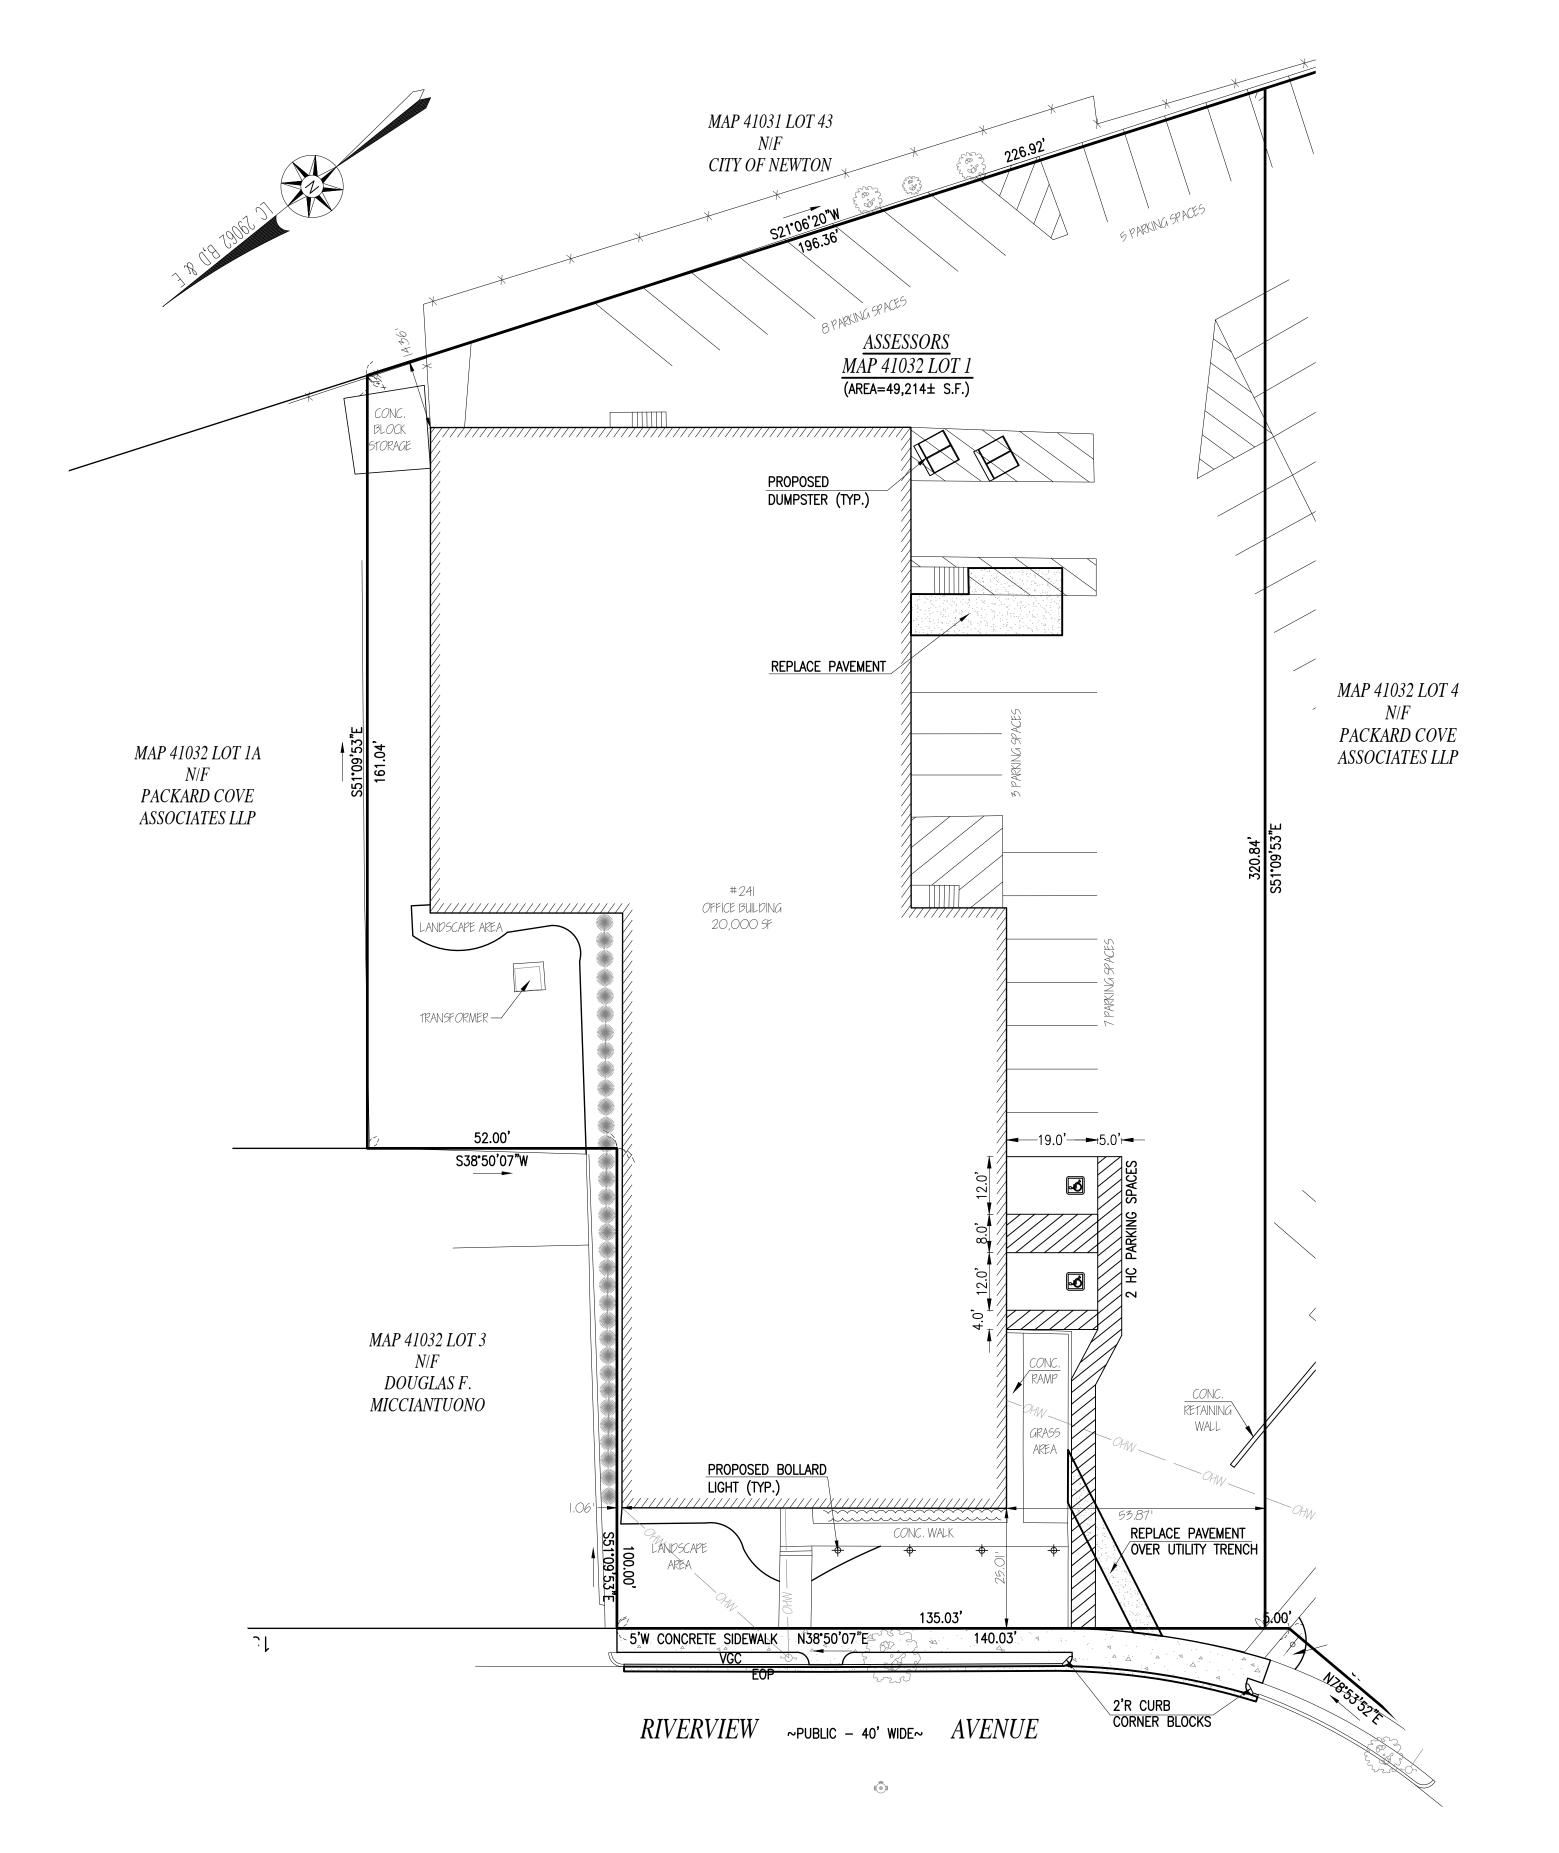

ZONING DATA —

2011110 DATA					
<u>DISTRICT:</u> MAN					
<u>DESCRIPTION</u>	<u>REQUIRED</u>	EXISTING	<u>PROVIDED</u>		
LOT AREA	10,000 S.F.	49,214 S.F.,	49,214 S.F.		
FRONT SETBACK	GREATER OF 15 FT OR ½ BUILDING HEIGHT OR AVERAGE	25.01 FT	25.01 FT		
SIDE SETBACK ABUTTING RESIDENTIAL OR PUBLIC USE DISTRICT	GREATER OF ½ BUILDING HEIGHT OR 20 FT	N/A FT	N/A FT		
SIDE SETBACK NOT ABUTTING RESIDENTIAL DISTRIC	½ BUILDING HEIGHT	1.06 FT	1.06 FT		
REAR SETBACK ABUTTING RESIDENTIAL OR PUBLIC USE DISTRICT	GREATER OF ½ BUILDING HEIGHT OR 20 FT	14.36 FT	14.36 FT		
REAR SETBACK NOT ABUTTING RESIDENTIAL OR PUBLIC USE DISTRICT	1 BUILDING HEIGHT	N/A FT	N/A FT		
BUILDING HEIGHT (MAXIMUM) 2 STORIES 3 STORIES	24 FT 36 FT	<24 FT	<24 FT		
BUILDING HEIGHT (STORIES) (MAXIMUM)	3		1		
FLOOR AREA RATIO (MAXIMUM) 2 STORIES	1.00	0.41+/-	0.41		
LOT COVERAGE (MAXIMUM)	NA %	87.2+/- %	87.20 %		

- PARKING & LOADING REQUIREMENTS -

PRINCIPAL USE: RESEARCH

REQUIREMENT	<u>REQURIED</u>	<u>PROVIDED</u>
1 SPACE PER 1,000 S.F. + 1 PER 4 EMPLOYEES	25 SPACES	25 SPACES
WHEN 26-50 TOTAL PARKING SPACES ARE PROVIDED, 2 MUST BE ACCESSIBLE SPACES. ONE IN EVERY EIGHT ACCESSIBLE SPACES, BUT NOT LESS THAN ONE, SHALL BE VAN ACCESSIBLE	2 ACCESSIBLE, 1 VAN ACCESSIBLE	2 ACCESSIBLE, 1 VAN ACCESSIBLE
ONE (1) LOADING SPACE FOR STRUCTURES OR LAND USES WITH 5.000-50.999 S.F. OF GROSS FLOOR AREA	1 LOADING SPACE	2 LOADING SPACES

0' 20' 40' 60

REVISIONS

1 051722 PER CLIENT

CHRISTIAN ALBERT FARLAND
No. 47544
CONL. CONL.



od Ventura Brive

21 VENTURA DRIVE DARTMOUTH, MA 02747 P.508.717.3479

ENGINEERINGSITEWORK

LAND SURVEYINGDEVELOPMENT

DRAWN BY: JKM

DESIGNED BY: JKM

CHECKED BY: CAF

SITE PLAN

1 RIVERVIEW AVENUE

SORS MAP 41032, LOT 1

RNDALE, MASSACHUSETTS

PREPARED FOR:

MAY 5, 2022

SCALE: 1"= 20'

JOB NO. 21-575

LATEST REVISION:
051722

SITE LAYOUT
SHEET 5 OF 7

40' 60' SIIE LAY

MAP 41031 LOT 43 N/F CITY OF NEWTON $\frac{ASSESSORS}{MAP\ 41032\ LOT\ 1}$ (AREA=49,214 \pm S.F.) PROPOSED 2,500 GALLON
TIGHT TANK
4" INV. IN=98.2 MAP 41032 LOT 4 N/F PACKARD COVE MAP 41032 LOT 1A ASSOCIATES LLP N/F PACKARD COVE ASSOCIATES LLP SEPTIC TANK / #241 OFFICE BUILDING 20,000 SF LANDSCAPE AREA S38*50'07"W MAP 41032 LOT 3 N/F DOUGLAS F. MICCIANTUONO _CONC. RETAINING\ WALL REPLACE EXISTING 37"
WATER SERVICE WITH
NEW 37" TYPE K
COPPER SERVICE N38°50'07"E RIVERVIEW ~PUBLIC ~ 40' WIDE~ AVENUE BENCHMARK
MAG NAIL SET IN UP #644
ELEV.=106.83 BENCHMARK
X CUT IN HYDRANT
ELEV.=106.54

REVISIONS

1 051722 PER CLIENT





21 VENTURA DRIVE

DARTMOUTH, MA 02747 P.508.717.3479

ENGINEERING SITEWORK

LAND SURVEYING DEVELOPMENT


DRAWN BY: JKM DESIGNED BY: JKM


CHECKED BY: CAF

MAY 5, 2022 SCALE: 1"= 20' JOB NO. 21-575 LATEST REVISION:

> 051722 UTILITIES


SHEET 6 OF 7

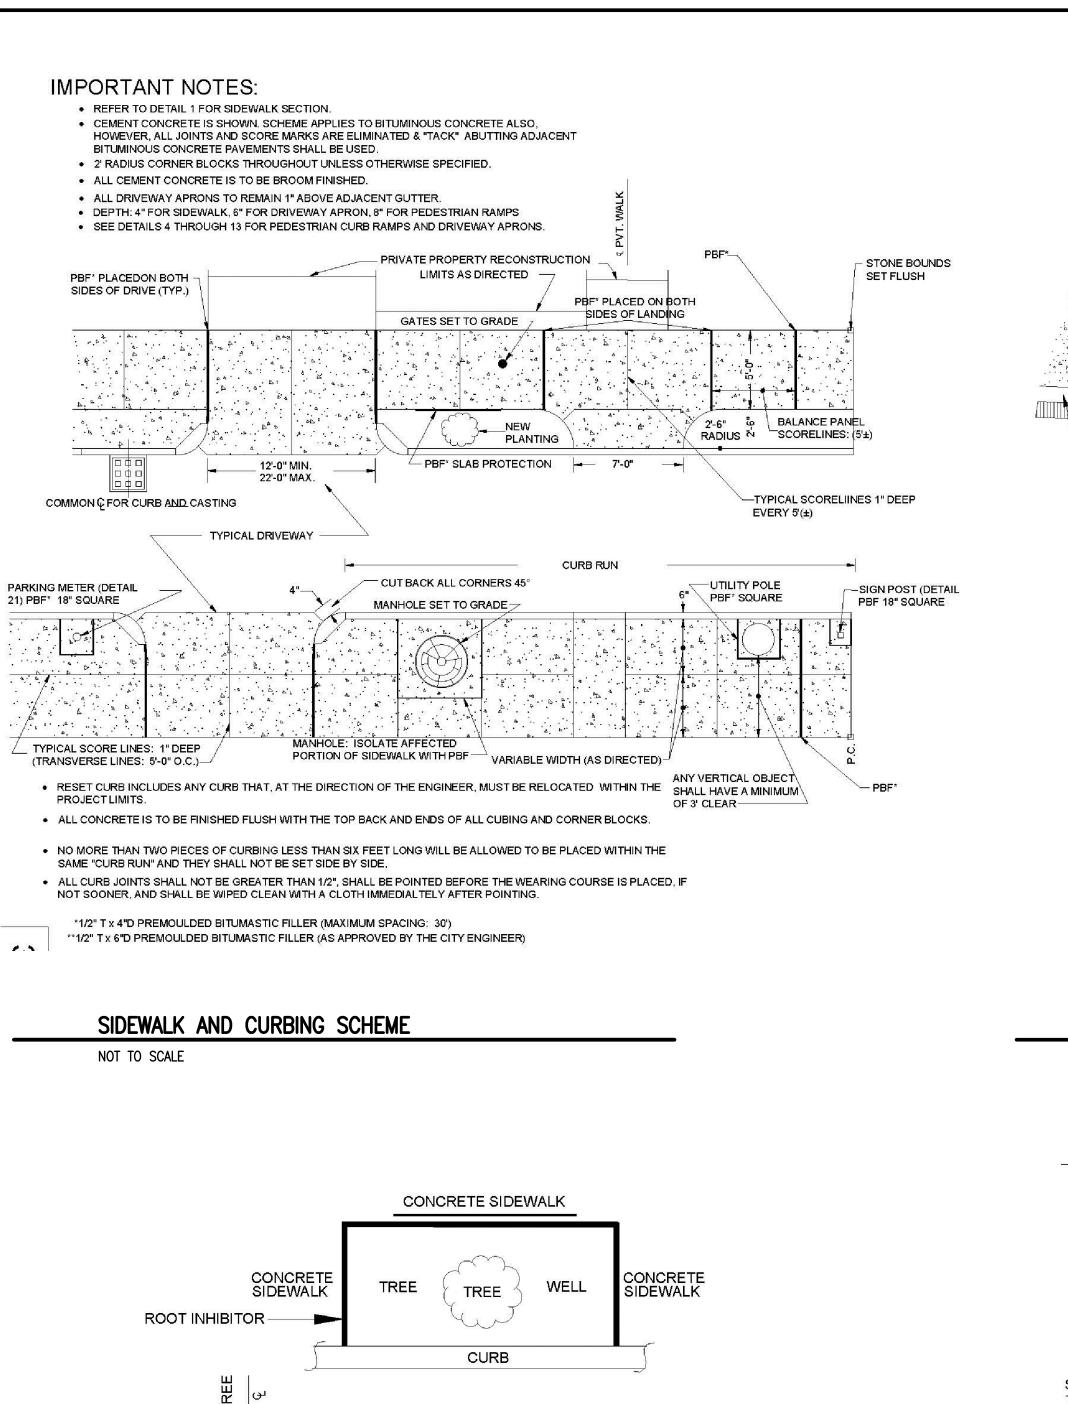

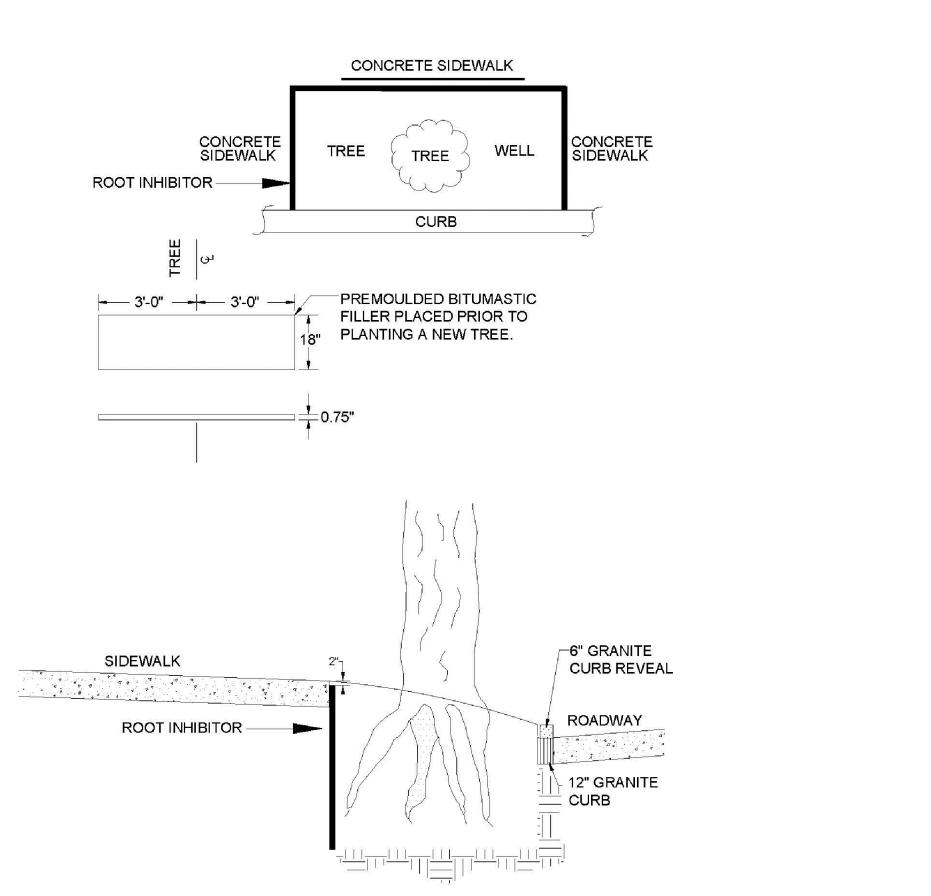

SIDEWALK SLAB PROTECTION

NOT TO SCALE

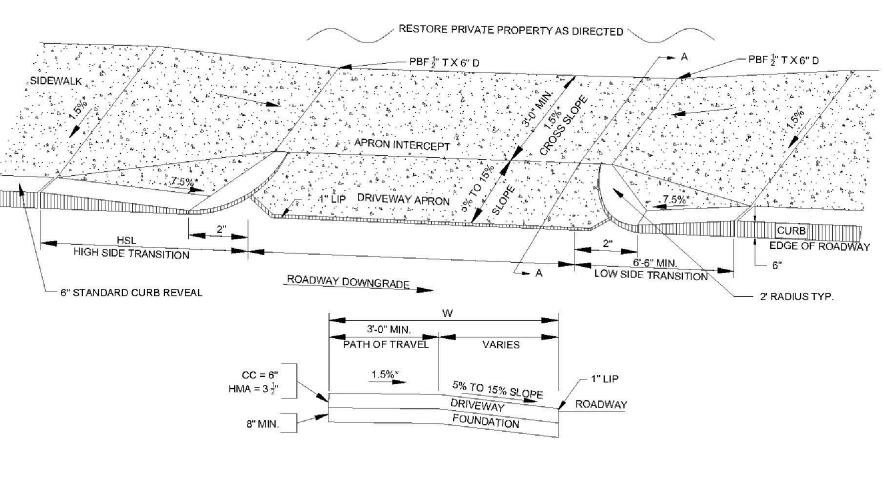

SECTION A-A

HSL = HIGH SIDE TRANSITION LENGTH
(SEE DETAIL 13)
W = SIDEWALK WIDTH
* = TOLERANCE FOR CONSTRUCTION + 0.5%
CC = CEMENT CONCRETE


HMA = HOT MIX ASPHALT

R = RADIUS

LEGEND:

SIDEWALK THROUGH DRIVEWAYS WITH CURB RETURNS

NOT TO SCALE

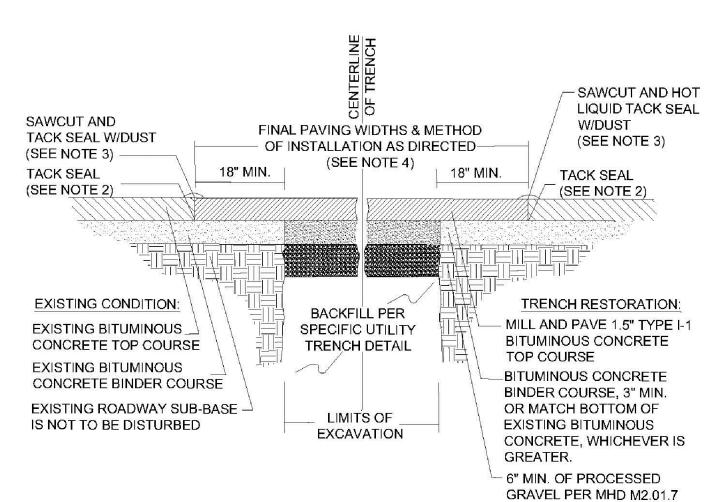

- 1. ALL INSTALLATION AND MATERIAL SPECIFICATIONS PER MASSDOT DEPARTMENT OF TRANSPORTATION STANDARD SPECIFICATIONS FOR HIGHWAYS AND BRIDGES, 2020 AS AMENDED.
- 2. ALL EXPOSED BITUMINOUS CONCRETE IS TO BE TACKED PER MASSDOT PRIOR TO NEW BITUMINOUS CONCRETE INSTALLATION.
- 3. ALL EXPOSED JOINTS ARE TO BE SEALED WITH HOT LIQUID TACK AND STONE DUST.
- 4. ANY TOP COURSE APPLIED AT A WIDTH OF 6' WIDE OR GREATER IS TO BE PLACED BY MACHINE/BOX SPREADER WHEN & AS DIRECTED BY THE CITY OF NEWTON.
- 5. SUPERPAVE FOR PAVEMENT

TYPICAL TRENCH REPAIR

NOT TO SCALE

CEMENT CONCRETE

STONE SUPPORT (TYP)

GRAVEL OR CRUSHED STONE SUPPORT (TYP)

GRAVEL BORROW (TYPE b)

CEMENT CONCRETE (SEE NOTE)

GRAVEL BORROW (TYPE b)

NOTES:
1. THIS PROCEDURE IS APPLICABLE

TOP PLACEMENT.

ONLY IF CURB IS TO BE SET AFTER BASE


COURSE IS IN PLACE PRIOR TO BINDER AND

THAT IS ACCEPTABLE UNDER SECTION M4
OF THE STANDARD SPECIFICATIONS MAY BE


USED. ALL TEST REQUIREMENTS ARE WAIVED. HOT MIX ASPHALT SHALL NOT BE USED AS A SUBSTITUTE.

ANY DESIGNATED CEMENT CONCRETE

GRANITE CURB IN EXISTING PAVEMENT

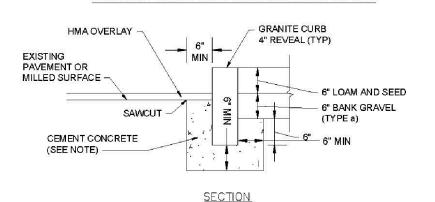


GRANITE CURB IN EXISTING PAVEMENT WITH OVERLAY

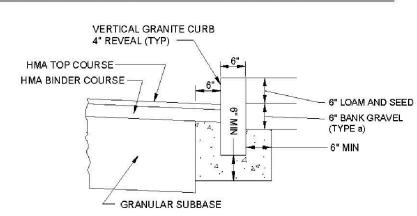

GRANITE CURB IN FULL DEPTH PAVEMENT

VERTICAL GRANITE CURB

NOT TO SCALE

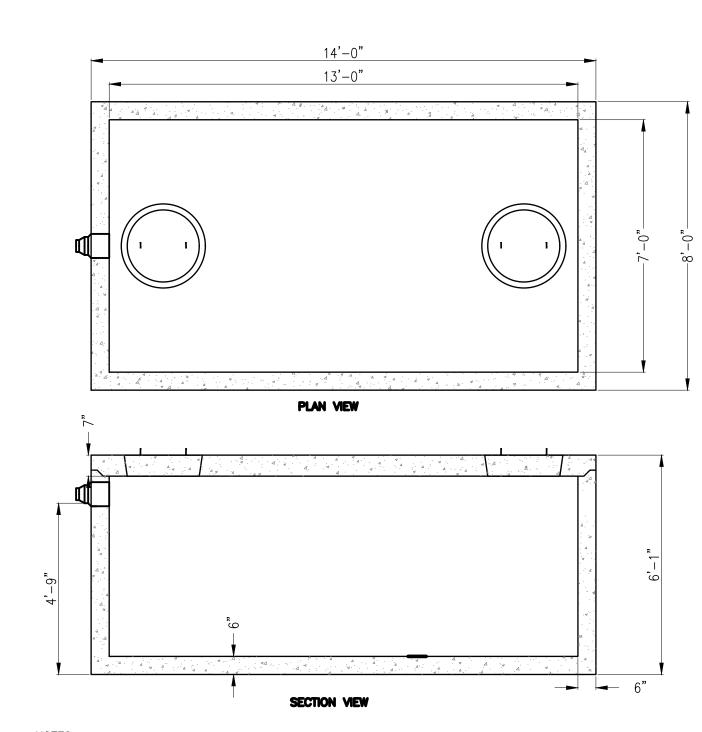


NOTES:

- CONSTRUCTION SHALL BE WATERTIGHT
 CONCRETE: 5,000 PSI MINIMUM AFTER 28 DAYS.
 DESIGNED FOR AASHTO HS-20 LOADING, 1 TO 5 FT COVER.
- 4. A MINIMUM 24" DIA. MANHOLE FRAME & COVER TO GRADE
 OVER THE INLET AND OUTLET SHALL BE PROVIDED

2,500 GAL. TIGHT TANK DETAIL

NOT TO SCALE

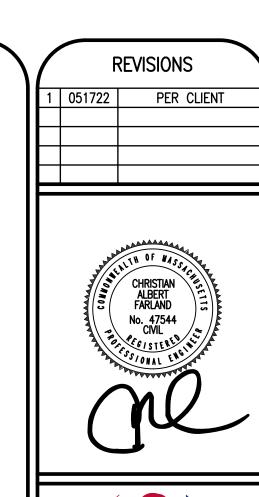



21 VENTURA DRIVE

DARTMOUTH, MA 02747 P.508.717.3479

ENGINEERINGSITEWORK

LAND SURVEYINGDEVELOPMENT

DRAWN BY: JKM

DESIGNED BY: JKM

CHECKED BY: CAF

RIVERVIEW AVENUE

ORS MAP 41032, LOT 1

NDALE, MASSACHUSETTS

ARCHITECTS

MAY 5, 2022

SCALE: N.T.S.

JOB NO. 21–575

LATEST REVISION:

DETAILS

051722

SHEET 7 OF 7