# CITY HALL PONDS MAINTENANCE DREDGING PROJECT

# NEWTON CENTRE, MASSACHUSETTS

September, 2020 Revised March, 2021 ISSUED FOR BIDDING OCTOBER 17, 2023

# DRAWING LIST:

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- S-1 EXISTING BRIDGE ABUTMENT CONDITIONS
- S-2 EXISTING ARCH BRIDGE ELEVATION AND SECTION
- S-3 BRIDGE ABUTMENT REPAIR DETAILS
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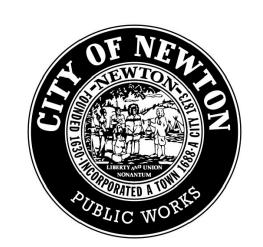


LOCUS PLAN
CITY HALL PONDS
NEWTON, MASSACHUSETTS
U.S.G.S. Newton Quad
1" = 1000'

CITY OF NEWTON
DEPARTMENT OF PUBLIC WORKS

RUTHANNE FULLER, MAYOR

JAMES McGONAGLE, COMMISSIONER OF PUBLIC WORKS



PREPARED FOR:

City of Newton Dept. of Public Works


1000 Commonwealth Avenue Newton Centre, MA 02459


DESIGNER:

GZA GeoEnvironmental, Inc. Engineers and Scientists 1350 Main Street, Suite 1400 Springfield, MA 01103 413-726-2100

DRAFT



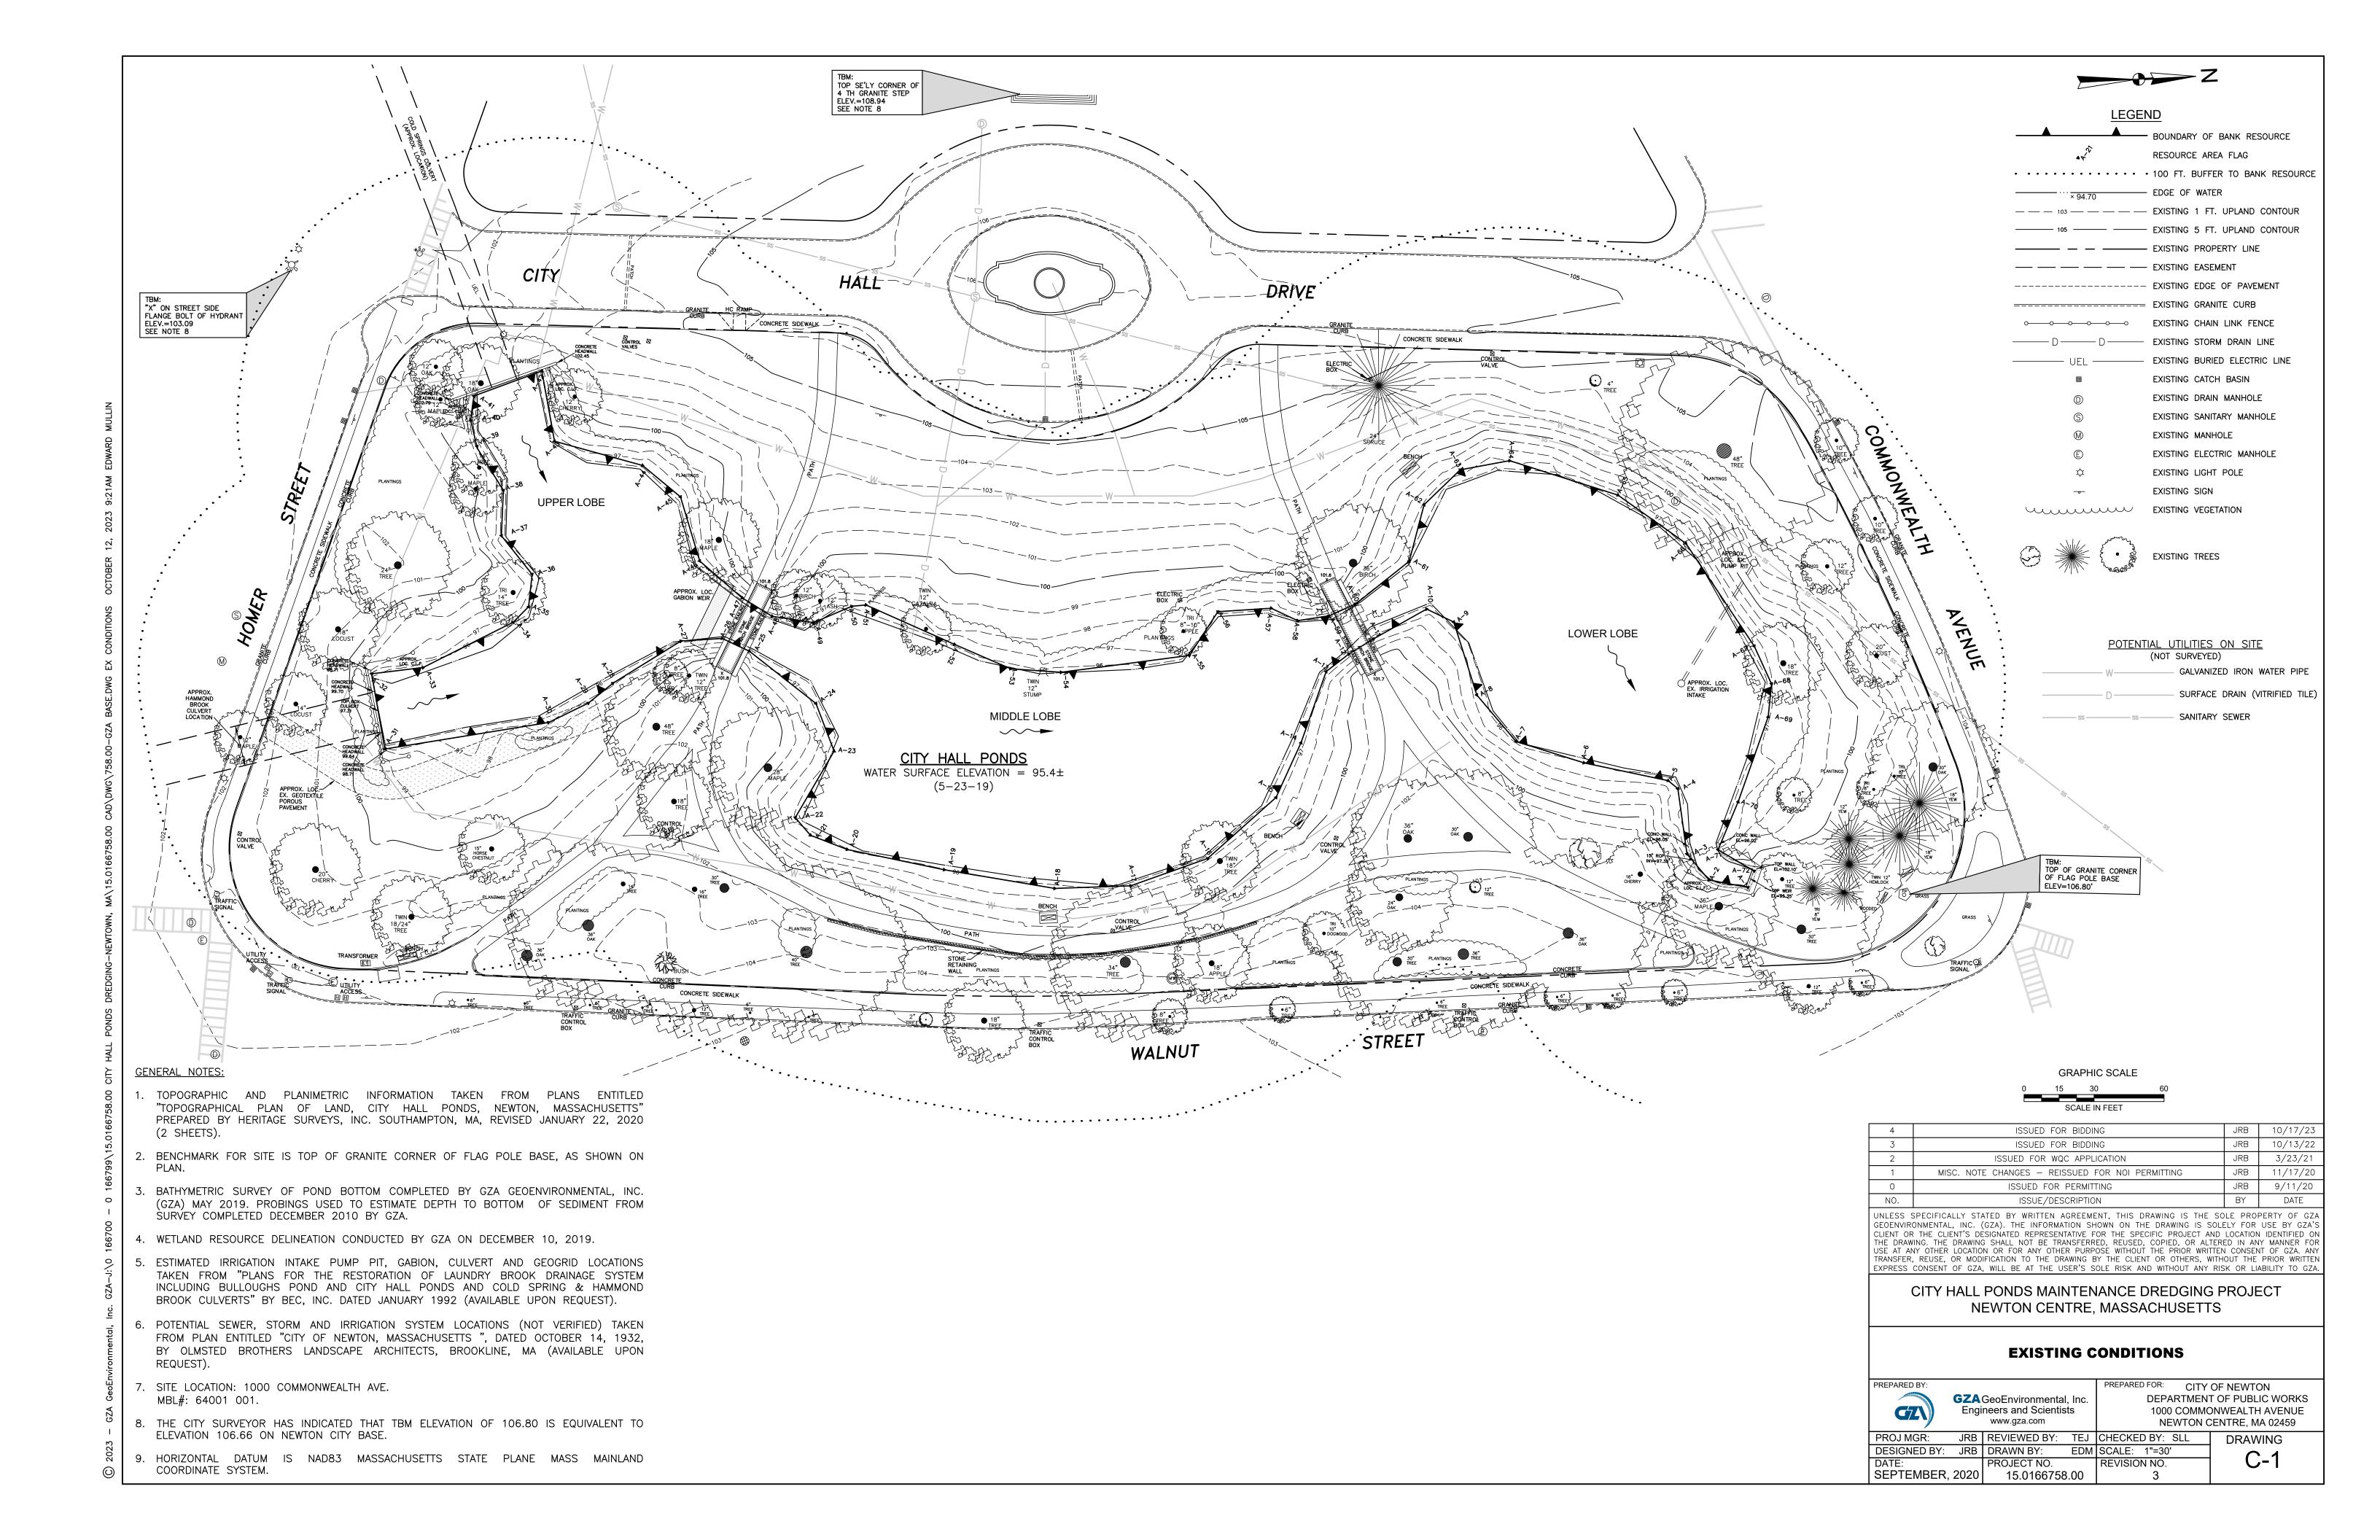

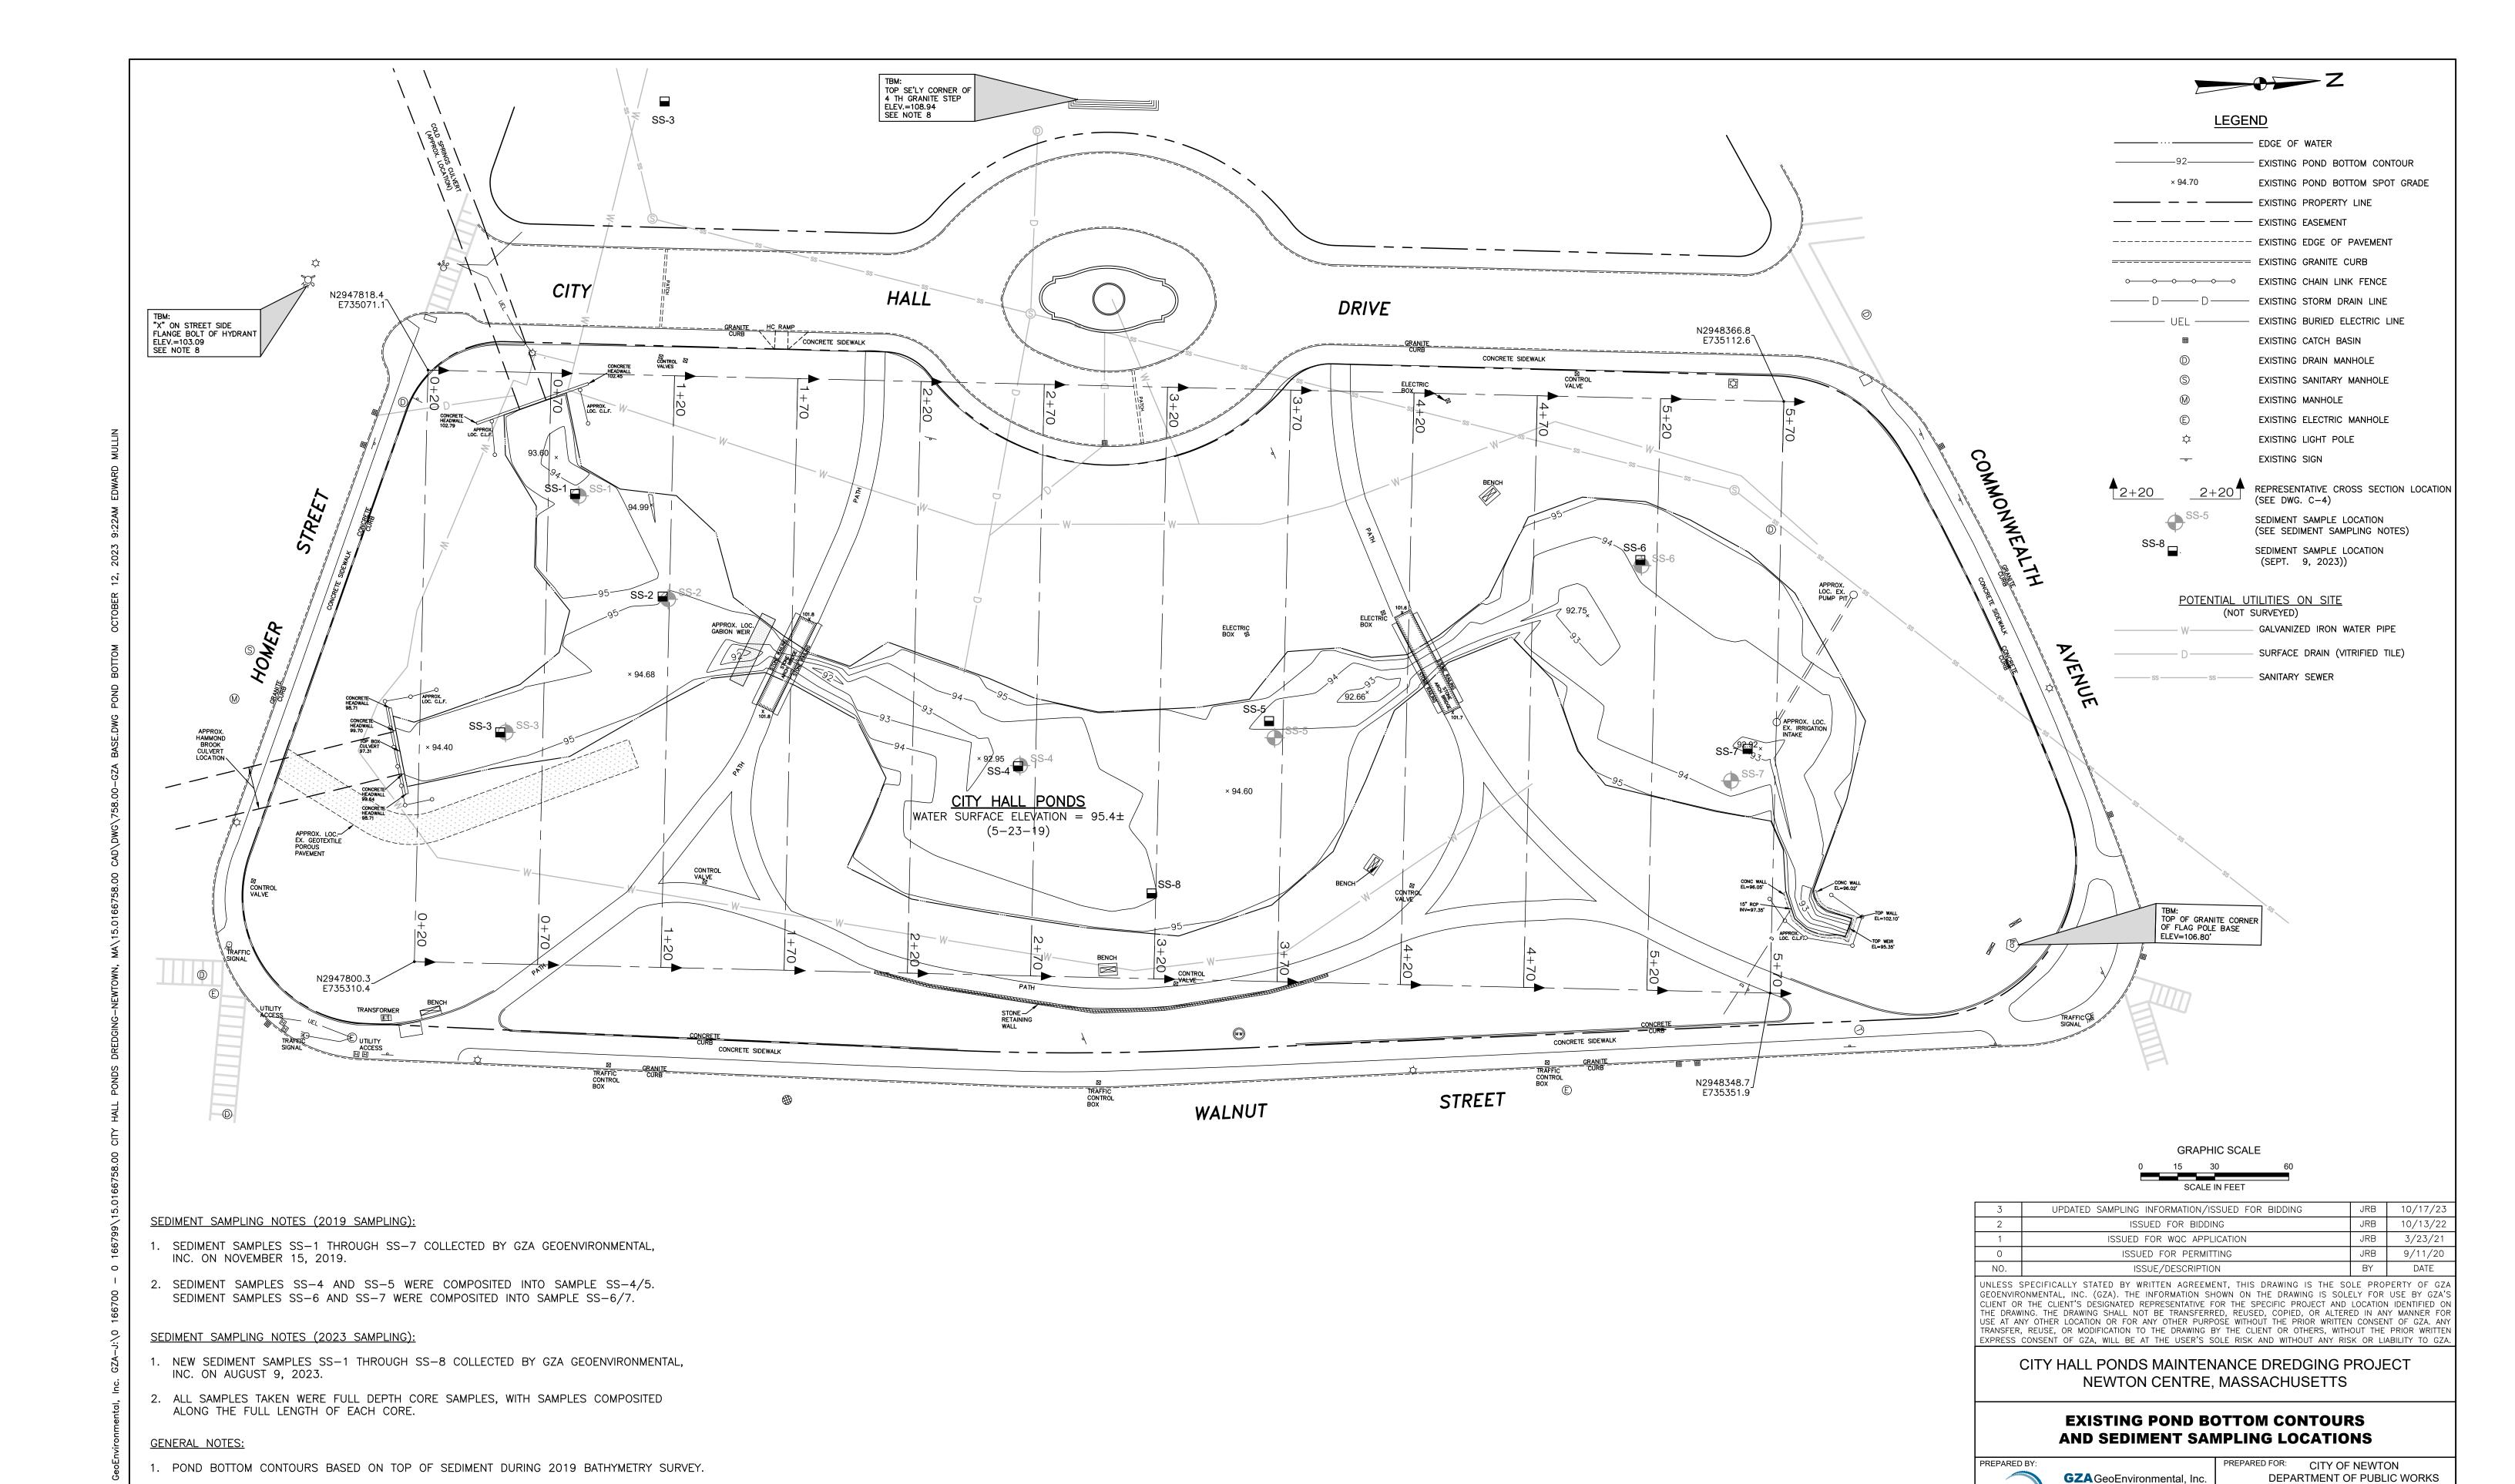

2. ADDITIONAL SEDIMENT INFILL MAY HAVE OCCURRED SINCE 2019.

Engineers and Scientists

www.gza.com

SEPTEMBER, 2020 15.0166758.00

DESIGNED BY: JRB | DRAWN BY: EDM | SCALE: 1"=30"


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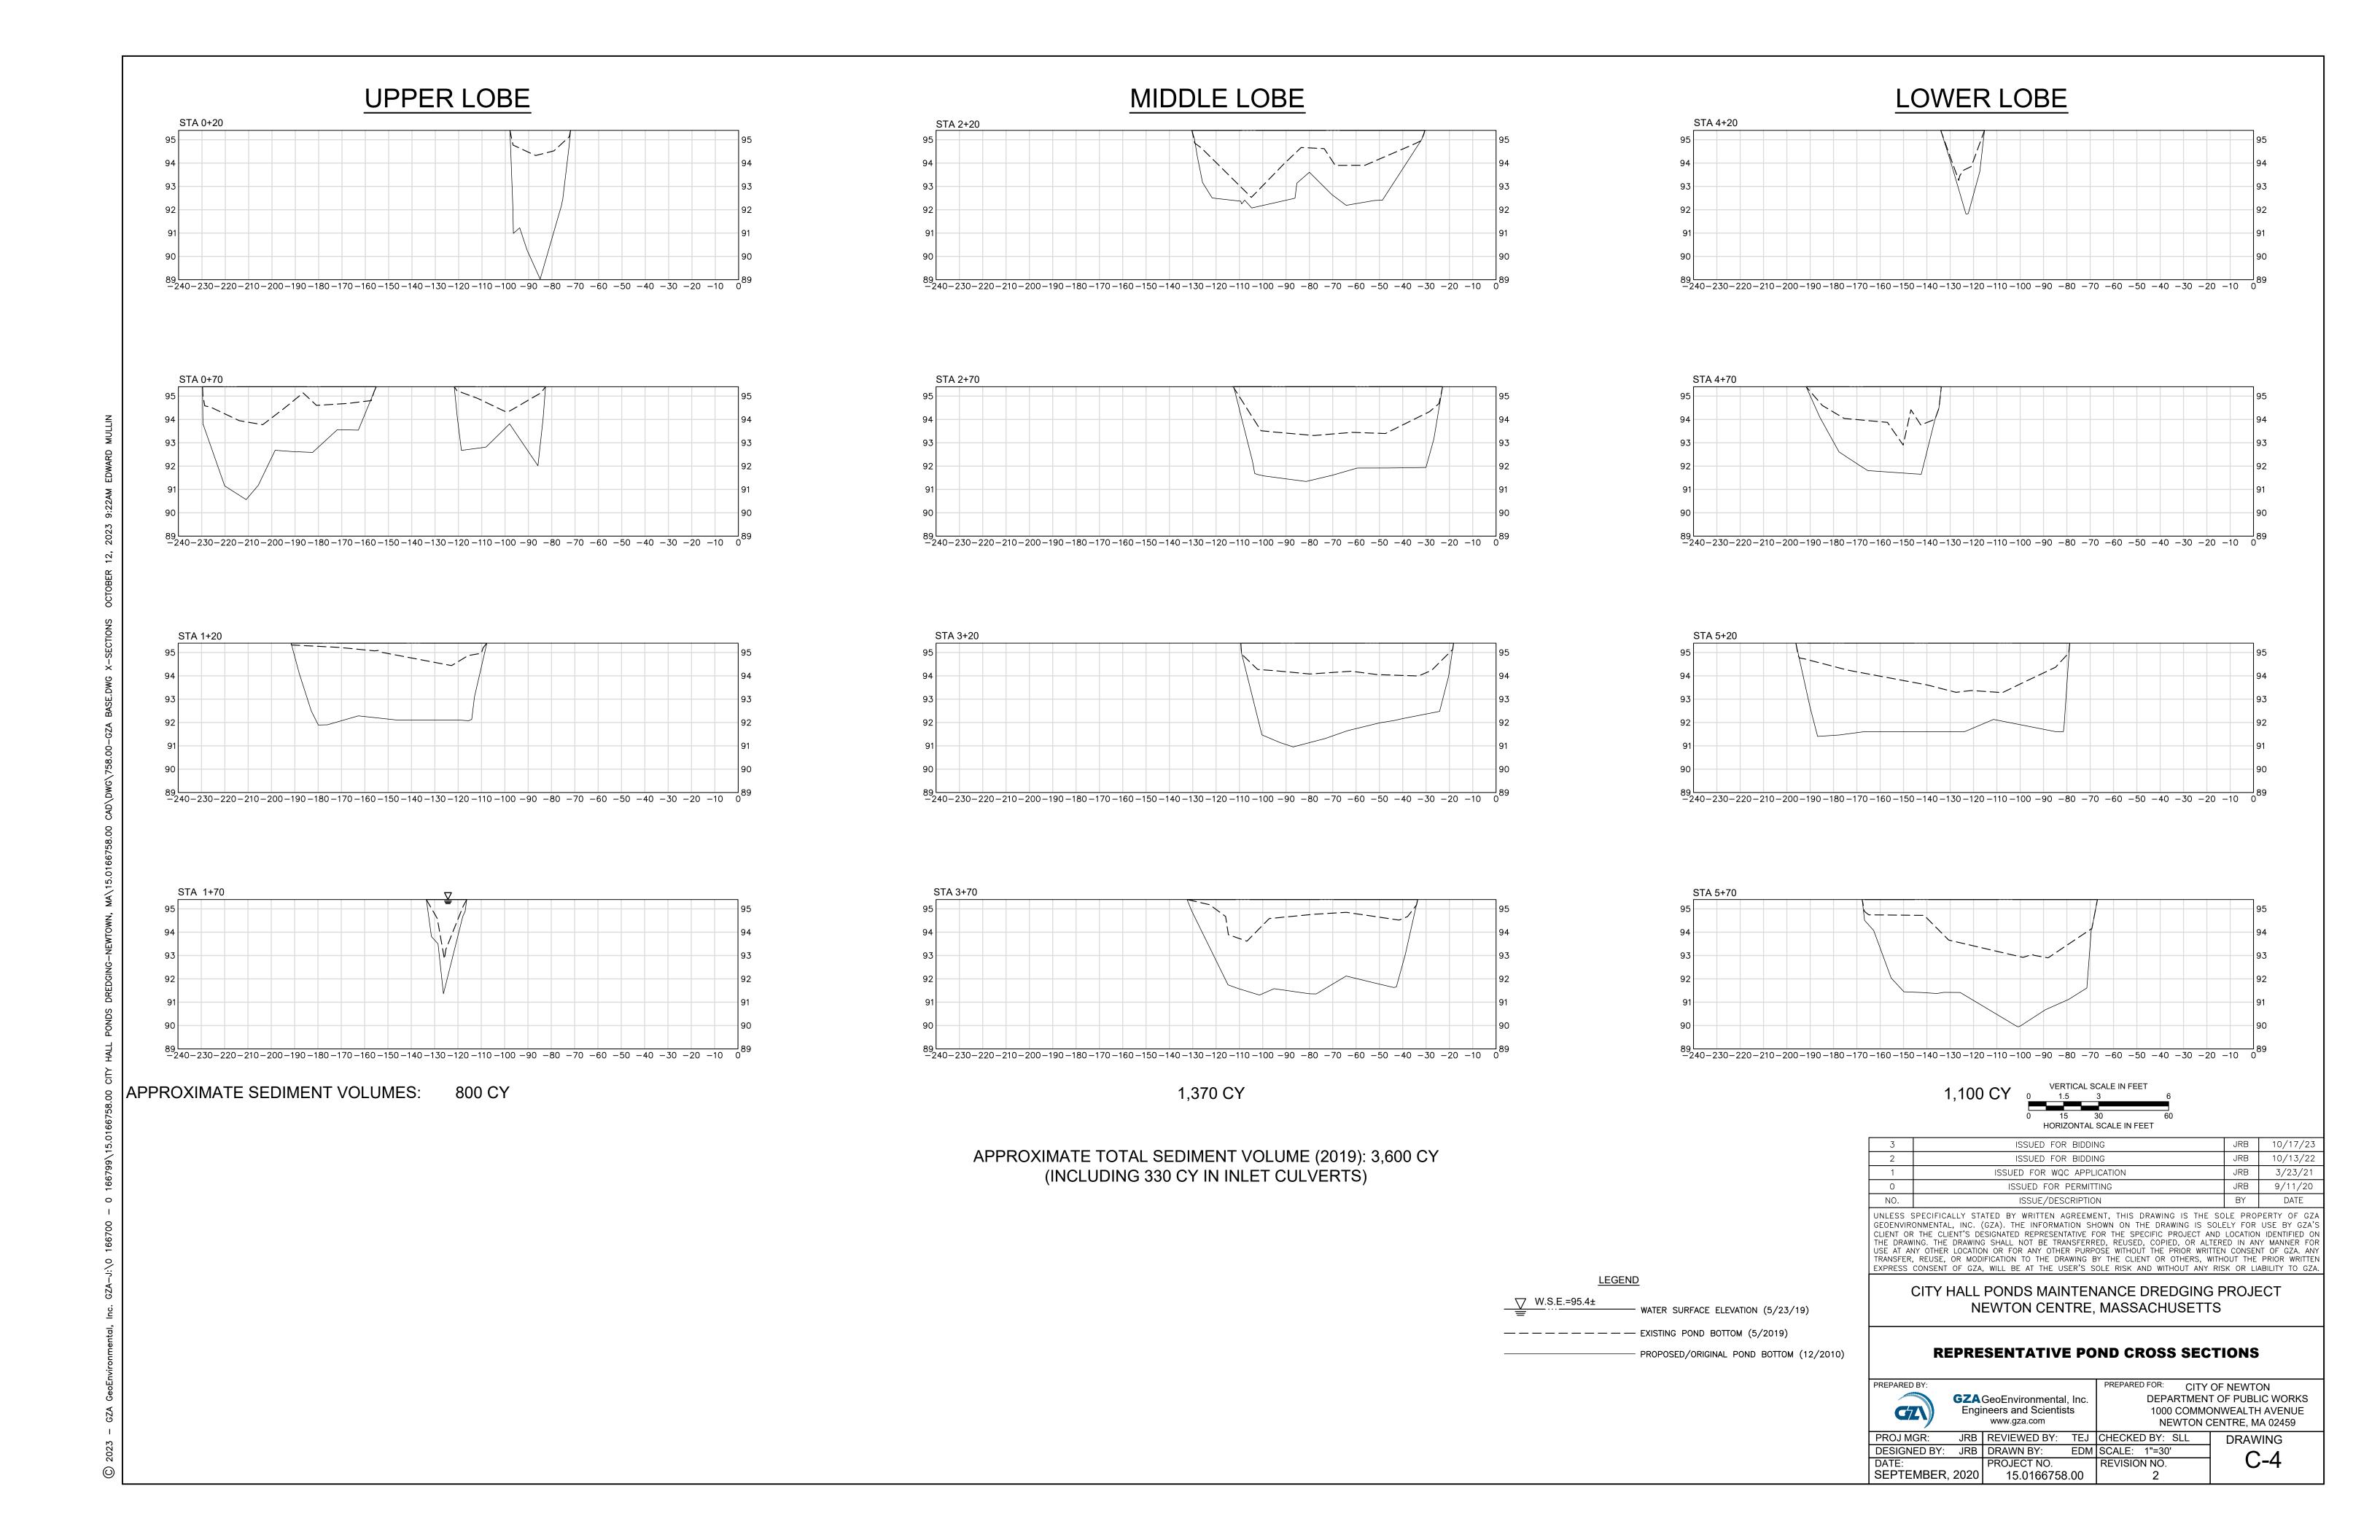
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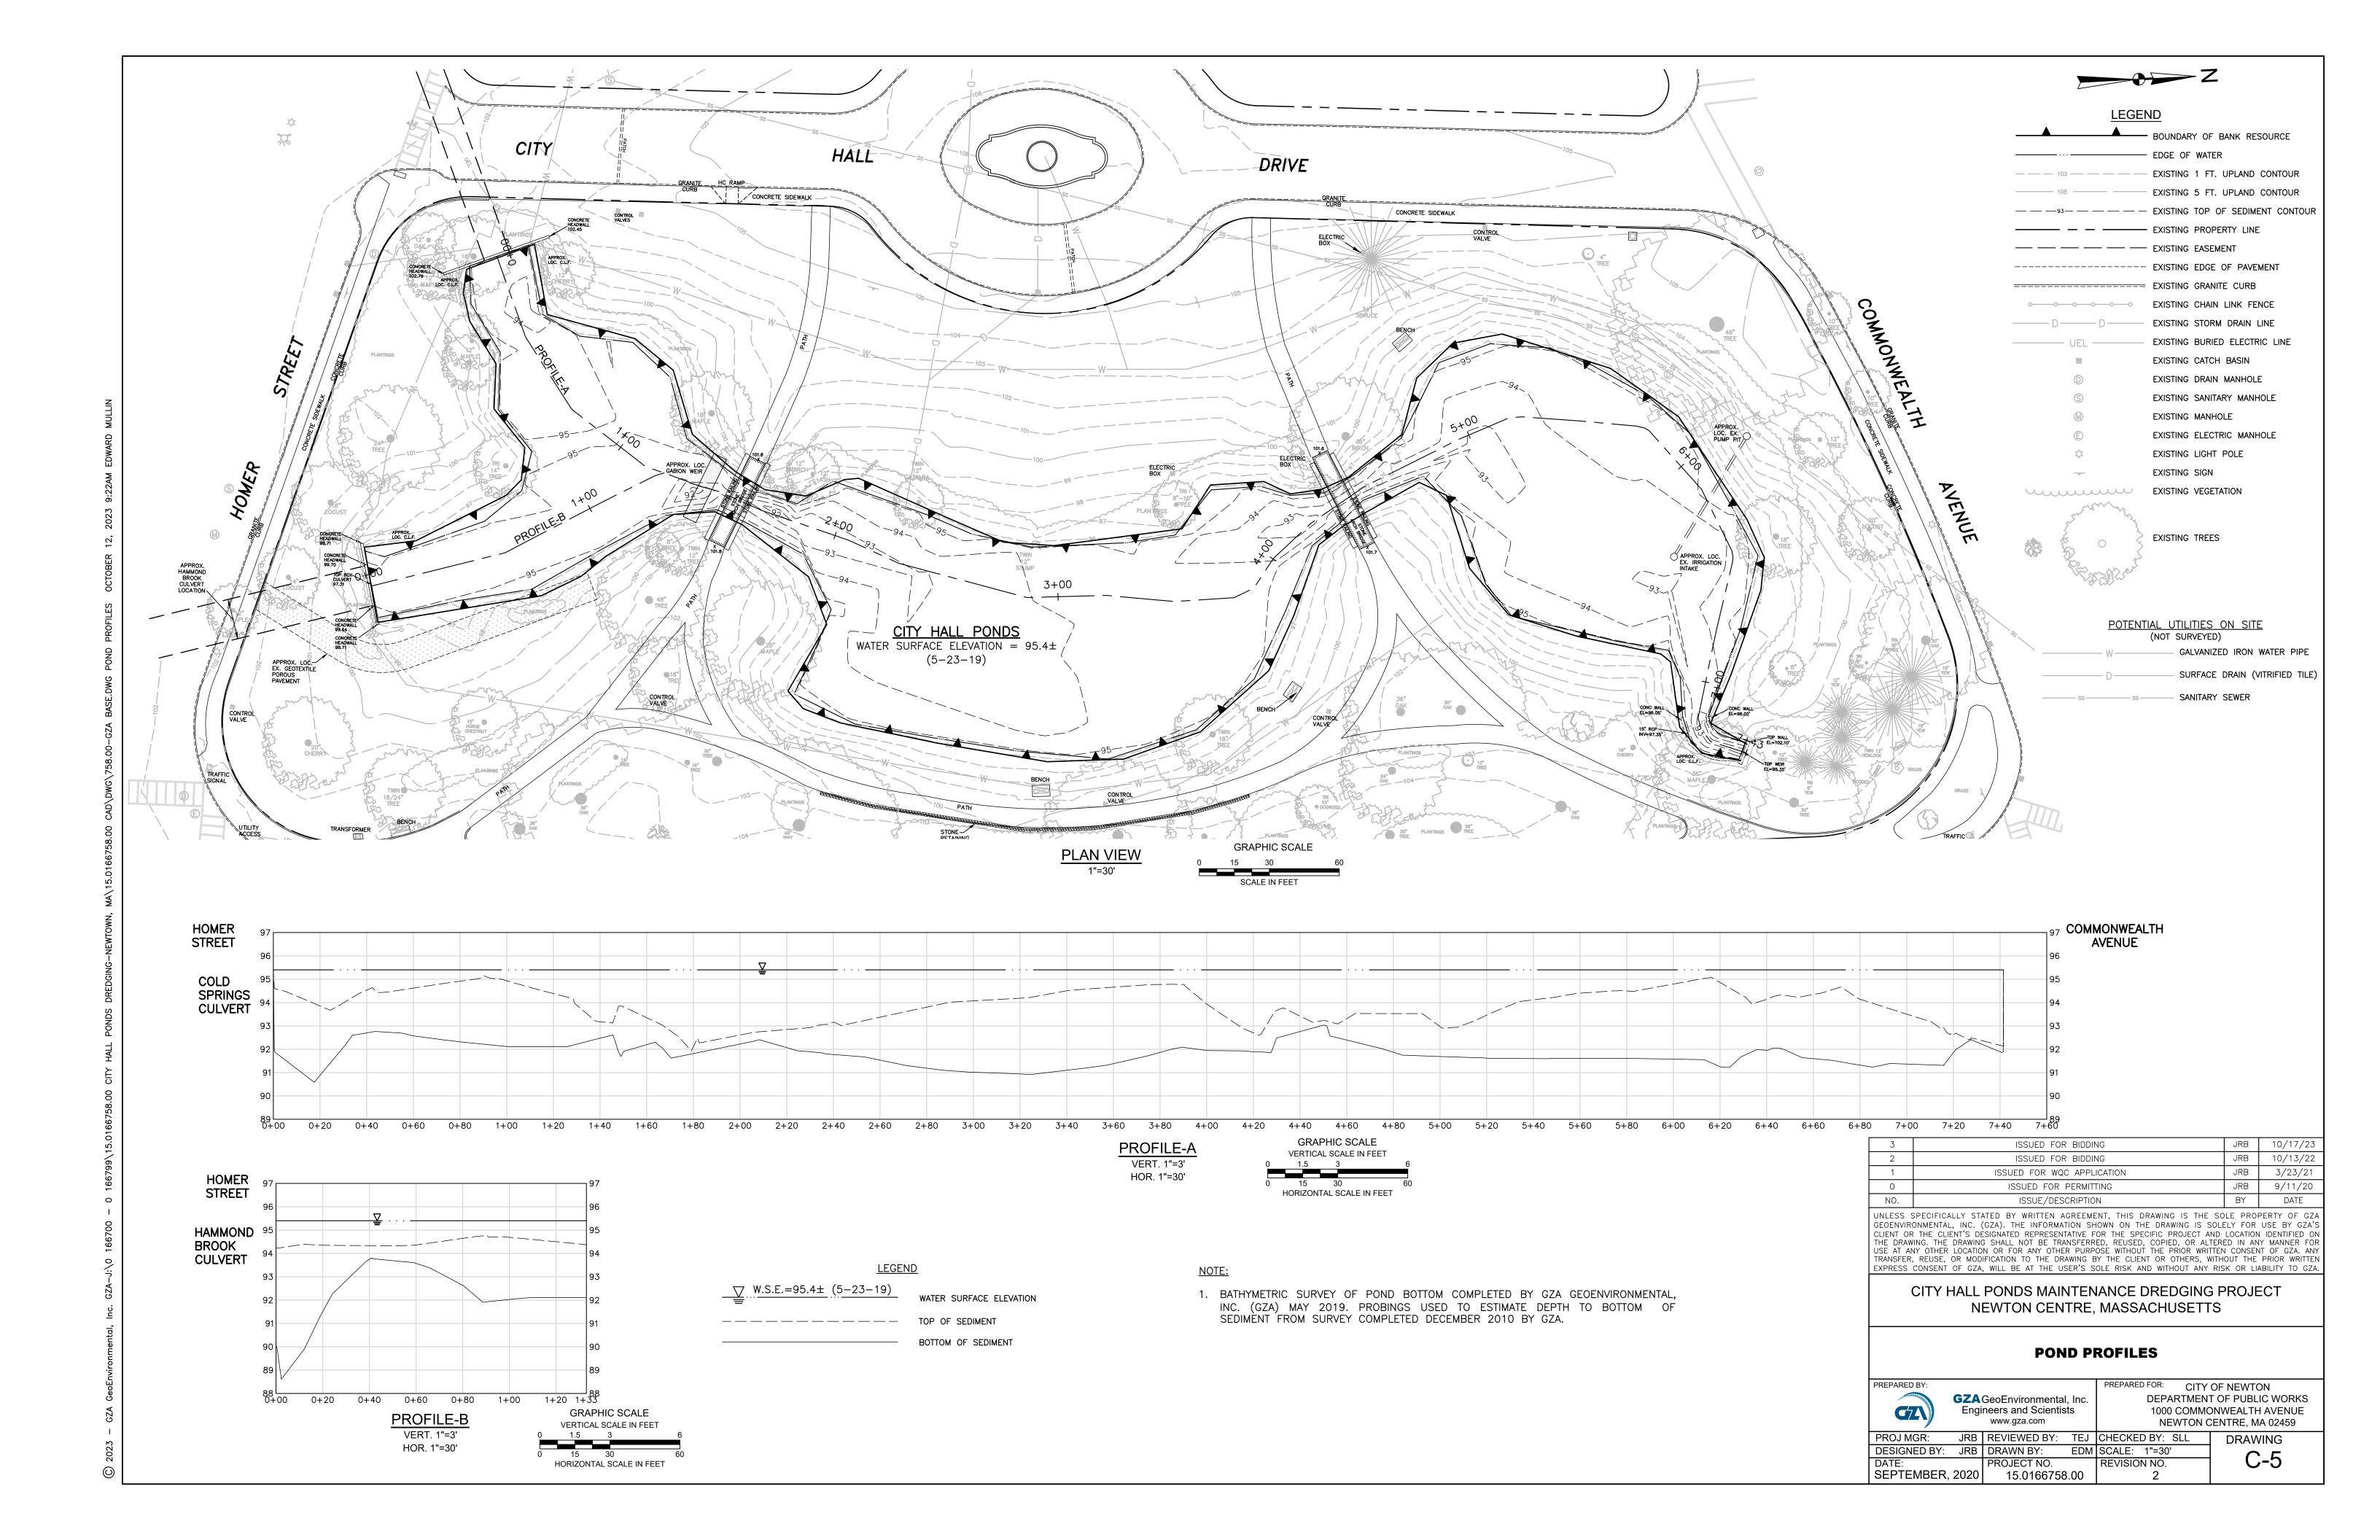
1000 COMMONWEALTH AVENUE


NEWTON CENTRE, MA 02459

C-2





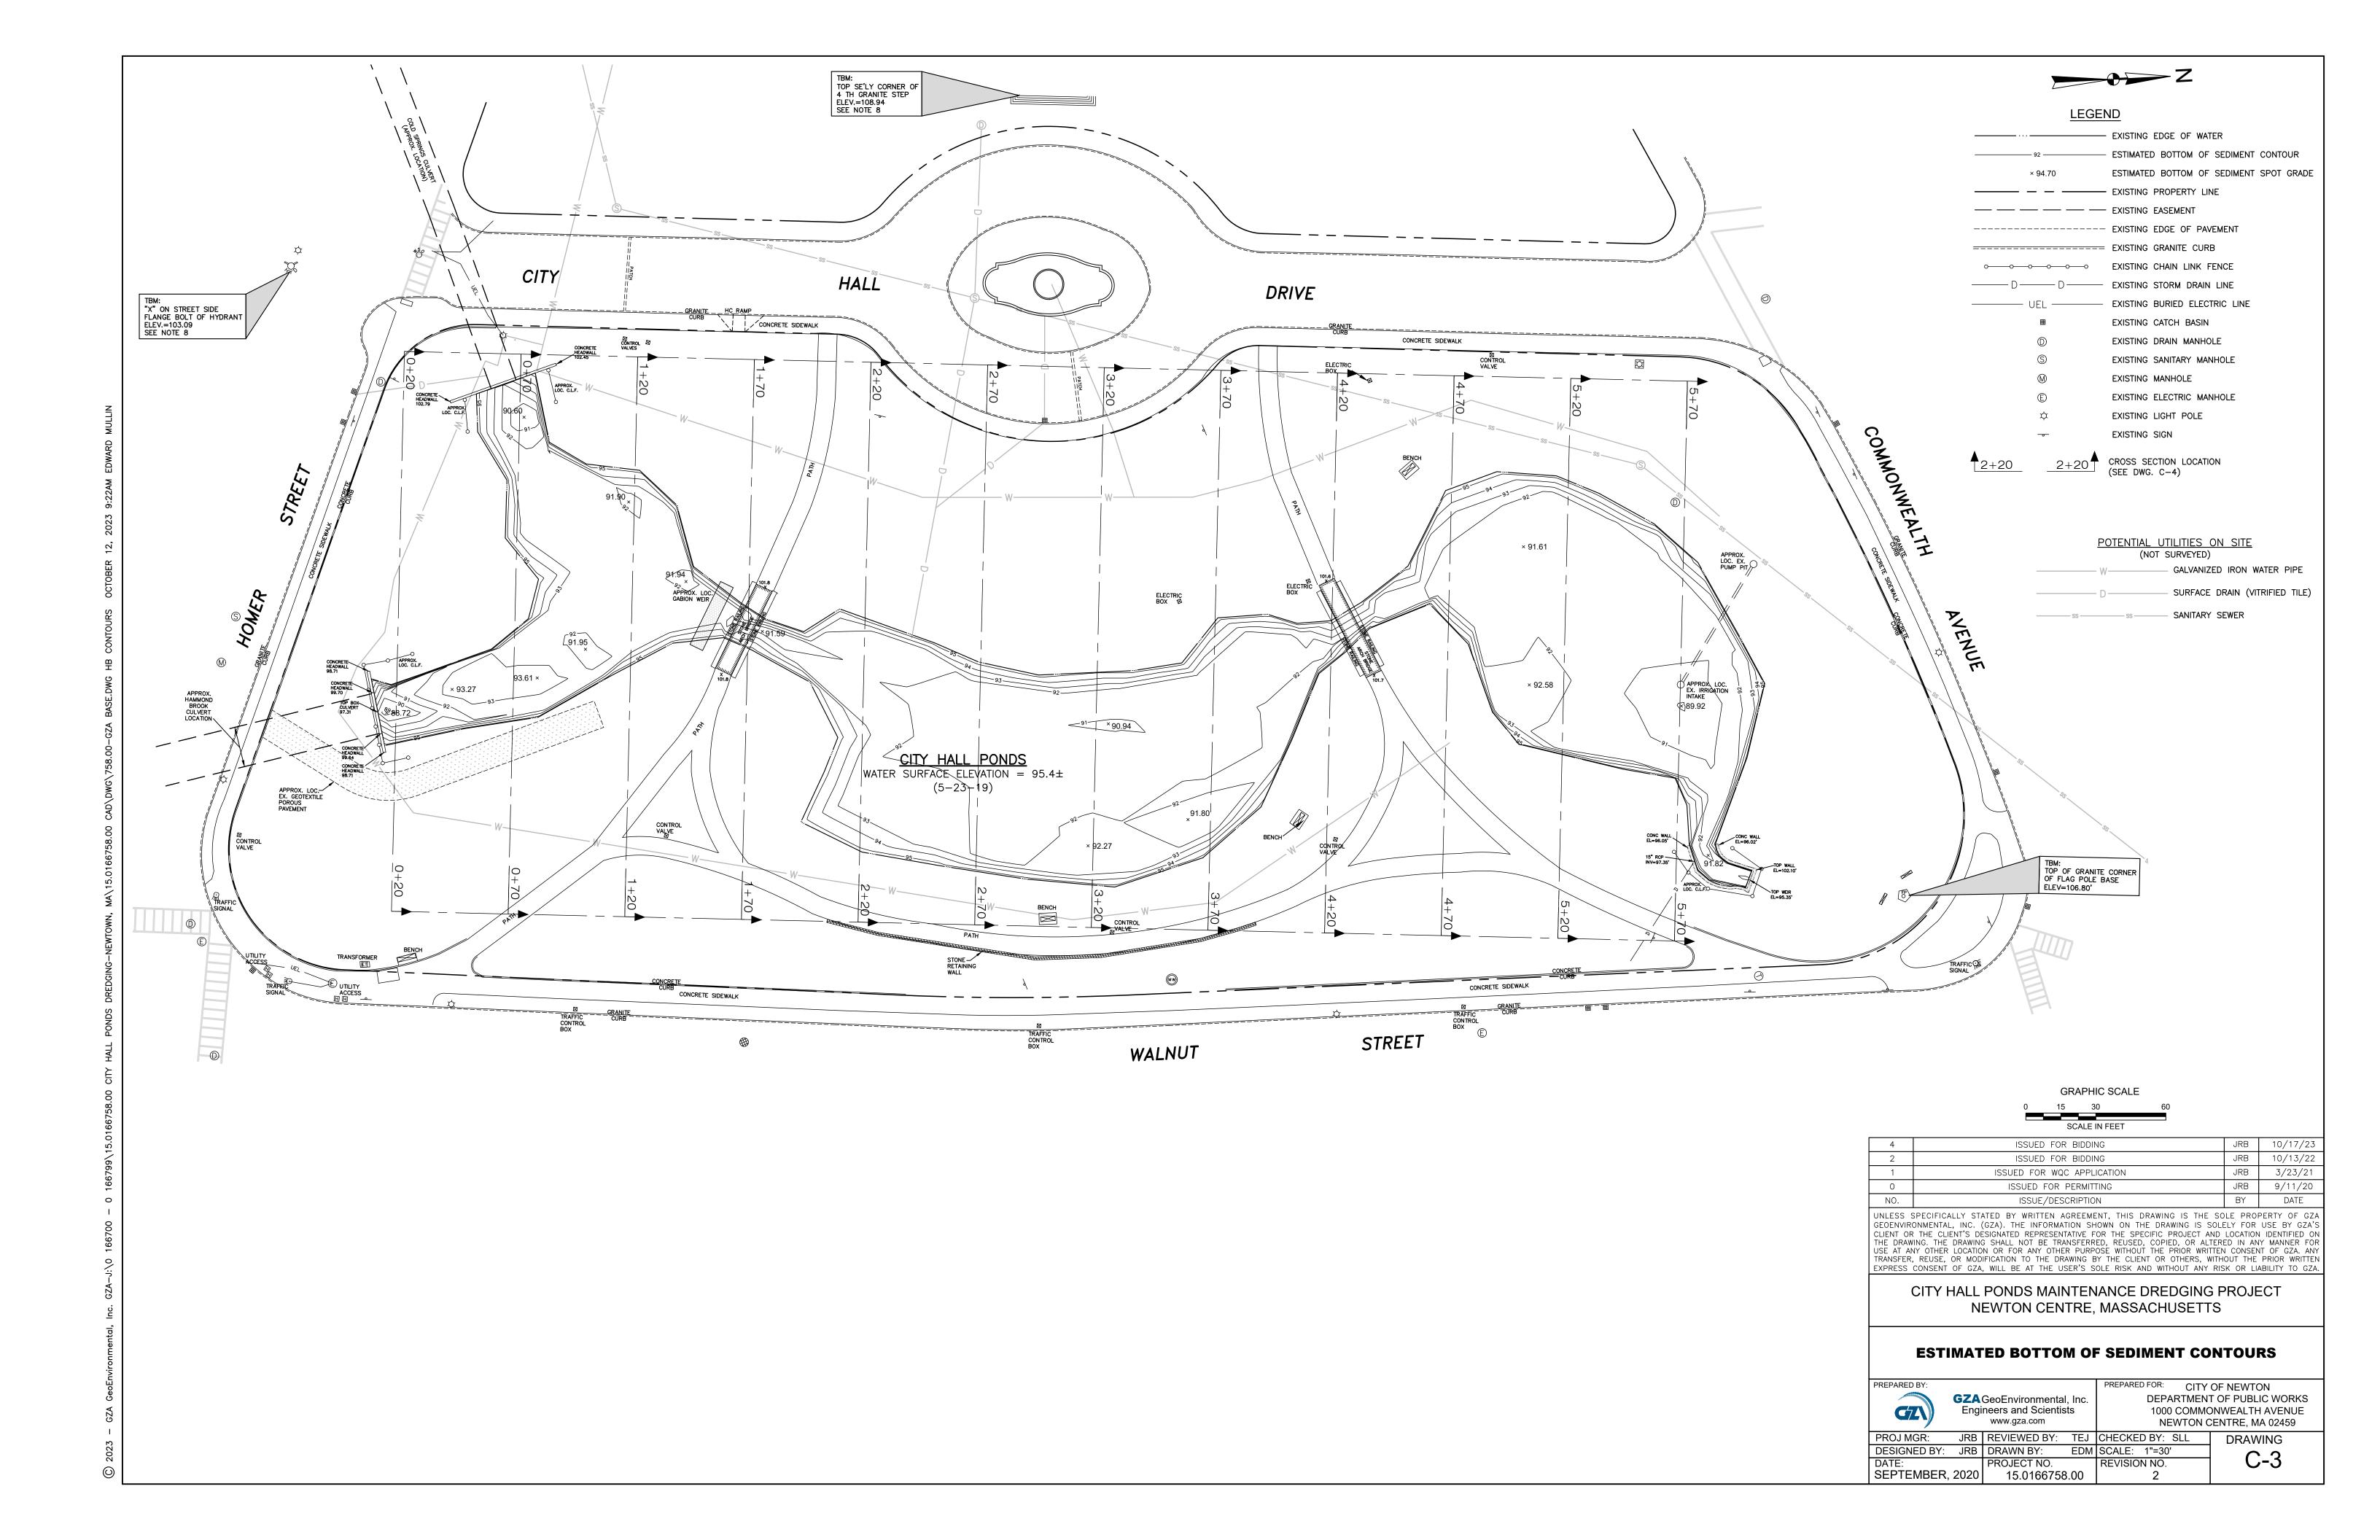

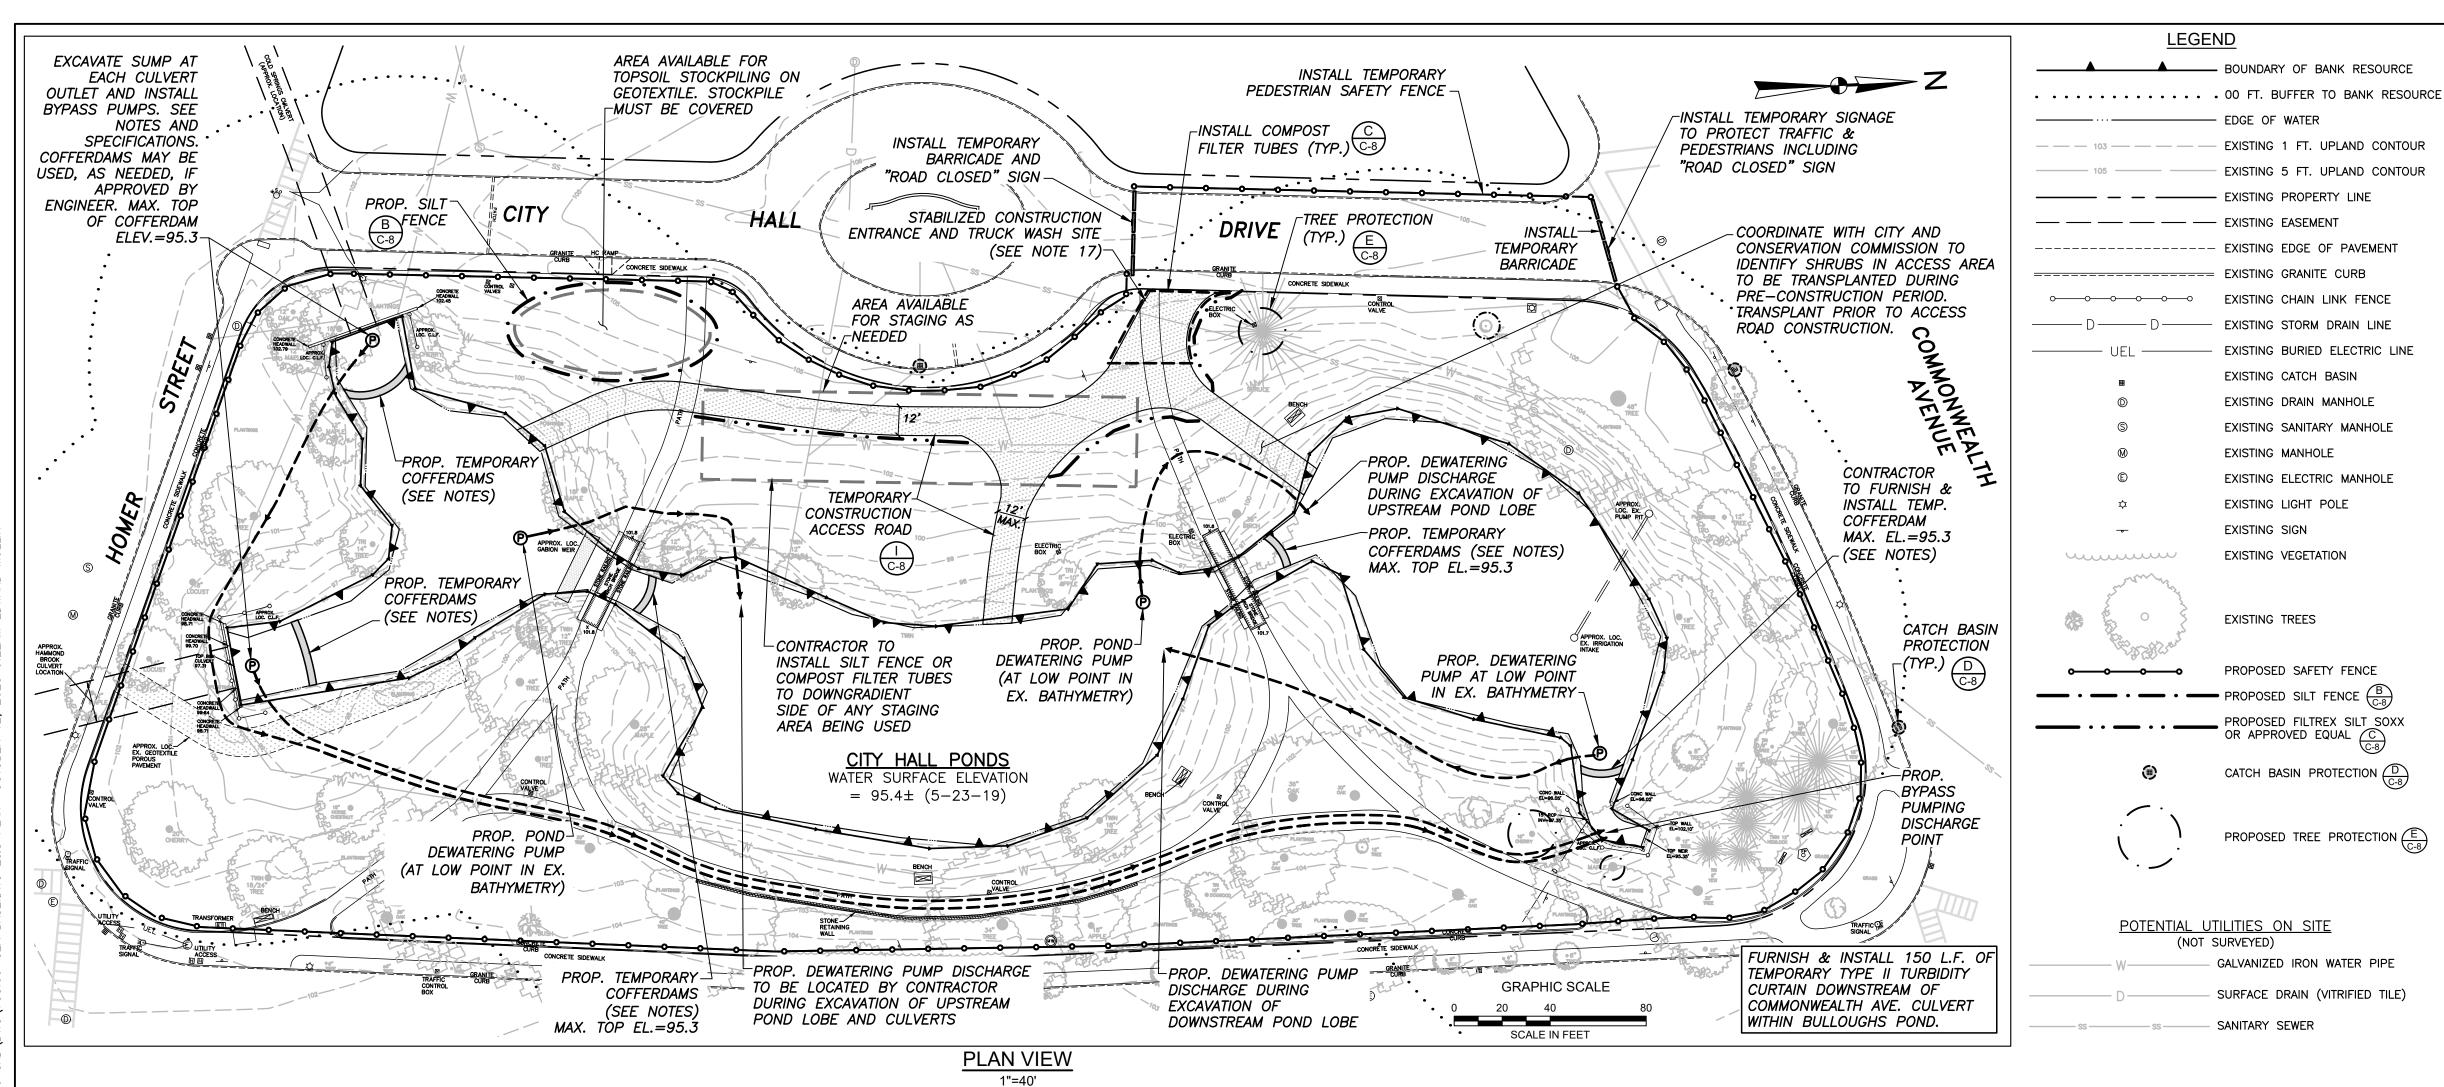

SEDIMENT AND EROSION CONTROL NOTES

SEDIMENT BASINS AND TRAPS, PERIMETER BERMS, SEDIMENT BARRIERS AND OTHER MEASURES INTENDED TO TRAP SEDIMENT (TURBIDITY CURTAIN) SHALL BE CONSTRUCTED AS A FIRST STEP IN ANY LAND DISTURBING ACTIVITY AND SHALL BE MADE FUNCTIONAL BEFORE UPSLOPE LAND DISTURBANCE TAKES PLACE.

- THE CONTRACTOR SHALL CONSTRUCT ALL EROSION AND SEDIMENT CONTROL MEASURES PER THE SEDIMENT AND EROSION CONTROL PLAN PRIOR TO BEGINNING ANY OTHER LAND DISTURBANCES, SHALL ENSURE THAT ALL RUNOFF FROM DISTURBED AREAS IS DIRECTED TO THE SEDIMENT CONTROL DEVICES, AND SHALL NOT REMOVE ANY EROSION OR SEDIMENT CONTROL MEASURES UNTIL THE AREAS DRAINING TO THEM ARE FINAL STABILIZED. THE CONTRACTOR SHALL INSPECT DAILY AND MAINTAIN CONTINUOUSLY IN EFFECTIVE OPERATING CONDITION ALL EROSION AND SEDIMENT CONTROL MEASURES UNTIL SUCH TIME AS THEY ARE REMOVED. CONDUCT INSPECTIONS AND REPORTING IN ACCORDANCE
- IMMEDIATELY UPON DISCOVERING UNFORESEEN CIRCUMSTANCES POSING THE POTENTIAL FOR ACCELERATED EROSION AND/OR SEDIMENT POLLUTION, THE CONTRACTOR SHALL IMPLEMENT APPROPRIATE BEST MANAGEMENT PRACTICES (BMPS) TO ELIMINATE THE POTENTIAL FOR ACCELERATED EROSION AND/OR SEDIMENT POLLUTION. THE CONTRACTOR SHALL INSTALL AND MAINTAIN, AT NO ADDITIONAL COST TO THE OWNER, ANY ADDITIONAL EROSION CONTROL MEASURES DEEMED NECESSARY FOR PERMIT COMPLIANCE BY THE CONTRACTOR, THE OWNER AND/OR THEIR REPRESENTATIVES, OR BY FEDERAL/STATE/LOCAL GOVERNMENT INSPECTORS.
- ALL EROSION CONTROL MEASURES SHALL BE CONSTRUCTED AND MAINTAINED IN ACCORDANCE WITH APPLICABLE PUBLISHED STANDARDS AND SPECIFICATIONS AND THE "MASSACHUSETTS EROSION AND SEDIMENT CONTROL GUIDELINES FOR URBAN AND SUBURBAN AREAS: A GUIDE FOR PLANNERS, DESIGNERS, AND MUNICIPAL OFFICIALS" (MA DEP. MAY 2003)
- A CONSTRUCTION ENTRANCE FOR THIS PROJECT IS MANDATORY TO PREVENT TRACKING OF SEDIMENT ONTO PUBLIC THOROUGHFARES. THE CONTRACTOR SHALL PROTECT ALL POINTS OF CONSTRUCTION INGRESS AND EGRESS TO PREVENT THE DEPOSITION OF MATERIALS ONTO TRAVERSED PUBLIC THOROUGHFARES. ALL MATERIALS DEPOSITED ONTO PUBLIC THOROUGHFARES SHALL BE REMOVED IMMEDIATELY
- ALL SEDIMENT BASINS, TRAP EMBANKMENTS, SWALES, PERIMETER DIKES, AND PERMANENT SLOPES STEEPER OR EQUAL TO 3:1 SHALL BE STABILIZED WITH LOAM AND SOD, OR OTHER APPROVED STABILIZATION MEASURES. COMMENCING IMMEDIATELY WHEN WORK IS COMPLETE AND COMPLETING THE WORK WITHIN 14 CALENDAR DAYS OF INITIATION OR 7 DAYS IF THE TOTAL AREA DISTURBED ONSITE IS MORE THAN 5 ACRES AT ANY TIME OR IF THE SITE HAS DISCHARGES TO SEDIMENT OR NUTRIENT IMPAIRED WATERS OR TO A TIER 2, 2.5, OR 3 WATER, AS DISCUSSED IN THE SWPPP. NO AREAS OUTSIDE OF THE PERIMETER SEDIMENT CONTROL BARRIER OR LIMIT OF WORK SHALL BE DISTURBED.
- THE CONTRACTOR SHALL APPLY LOAM AND SOD, OR OTHER APPROVED STABILIZATION MEASURES TO ALL UPLAND LAWN DISTURBED AREAS IMMEDIATELY UPON CESSATION OF ACTIVITY AND SHALL COMPLETE THE EFFORT WITHIN 14 CALENDAR DAYS AFTER STRIPPING AND GRADING ACTIVITIES HAVE CEASED ON THAT AREA, UNLESS SHORTER TIMELINES APPLY TO THE SITE DUE TO THE ITEMS INDICATED IN #6 ABOVE (LARGER AREAS OF DISTURBANCE, DISCHARGES TO IMPAIRED OR HIGH QUALITY WATERS, ETC.). MAINTENANCE SHALL BE PERFORMED AS NECESSARY TO ENSURE CONTINUED STABILIZATION.
- TEMPORARY STOCKPILES WHICH HAVE NOT BEEN USED FOR 14 CALENDAR DAYS, SHALL BE TEMPORARILY STABILIZED THROUGH THE APPLICATION OF SEED AND MULCH, OR OTHER APPROVED STABILIZATION MEASURES.
- ALL CATCH BASINS OR OTHER DRAIN INLETS WHICH MAY RECEIVE STORMWATER FROM DISTURBED AREAS SHALL BE PROVIDED WITH SUITABLE INLET PROTECTION CONSISTING OF AN OPEN-TOP FILTER FABRIC BAG THAT IS DESIGNED TO HANG UNDERNEATH A STORM GRATE TO FILTER SEDIMENT-LADEN STORMWATER.
- EFFLUENT FROM DEWATERING OPERATIONS SHALL BE DIRECTED TO FIBER MATS, NETTING, RIPRAP, OR NATURALLY OCCURRING COVER TO MINIMIZE EROSION FROM DISCHARGE VELOCITY DURING WORK IN ALL THREE POND LOBES. EFFLUENT FROM DEWATERING OPERATIONS BEING DISCHARGED TO AREAS WHICH HAVE ALREADY BEEN DREDGED SHALL BE PUMPED EITHER TO SEDIMENT TANKS, SEDIMENT BAGS, AND/OR SEDIMENT TRAPS FOR SEDIMENT REMOVAL PRIOR TO DISCHARGE. DEWATERING SHALL BE PERFORMED IN ACCORDANCE WITH THE "MASSACHUSETTS EROSION AND SEDIMENT CONTROL GUIDELINES FOR URBAN AND SUBURBAN AREAS: A GUIDE FOR PLANNERS, DESIGNERS, AND MUNICIPAL OFFICIALS" AND IN A MANNER THAT DOES NOT ADVERSELY AFFECT AREAS OUTSIDE OF THE LIMIT OF WORK.
- TEMPORARY SEDIMENT TRAP(S) SHALL BE CLEANED OUT AND RESTORED TO ORIGINAL DIMENSIONS WHEN SEDIMENT HAS ACCUMULATED TO A POINT ONE HALF (1/2) THE DEPTH BETWEEN THE OUTLET CREST AND THE BOTTOM OF THE TRAP. THE CONTRACTOR SHALL BE RESPONSIBLE FOR THE CONTROL OF DUST AND DIRT RISING AND SCATTERING IN THE AIR DURING CONSTRUCTION AND SHALL PROVIDE WATER

ALL WASTE MATERIALS GENERATED AT THE SITE SHALL BE IMMEDIATELY REMOVED AND DISPOSED OF OR STORED IN A SECURELY-COVERED CONTAINER IN ACCORDANCE WITH

- SPRINKLING, CALCIUM CHLORIDE, OR OTHER EFFECTIVE MEANS OF CONTROL.
- LOCAL AND STATE REGULATIONS. CONTAINER SHALL BE EMPTIED ON A REGULAR BASIS AND AS NECESSARY. NO CONSTRUCTION WASTE OR DEBRIS SHALL BE BURIED ONSITE. 14. FOR FINISHED GRADING, THE CONTRACTOR SHALL PROVIDE ADEQUATE GRADIENTS SO AS TO PREVENT WATER FROM STANDING ON THE SURFACE OF LAWNS MORE THAN 24 HOURS AFTER THE END OF A RAINFALL, EXCEPT IN DESIGNATED DRAINAGE COURSES AND SWALE FLOW AREAS WHICH MAY DRAIN AS LONG AS 48 HOURS AFTER THE END OF A
- RAINFALL, AND PROVIDE POSITIVE DRAINAGE AWAY FROM ALL BUILDING FOUNDATIONS OR OPENINGS. PRIOR TO REMOVAL OF SEDIMENT CONTROL MEASURES THE CONTRACTOR SHALL STABILIZE ALL CONTRIBUTORY DISTURBED LAWN AREAS USING LOAM AND SOD. AREAS BROUGHT TO FINISHED GRADE DURING THE GROWING SEASON SHALL BE PERMANENTLY STABILIZED IMMEDIATELY WITH EFFORTS COMPLETED WITHIN 14 CALENDAR DAYS OF ESTABLISHMENT UNLESS MORE STRINGENT STABILIZATION DEADLINES APPLY TO THE SITE, AS DISCUSSED IN THE SWPPP. WHEN PROPERTY IS BROUGHT TO FINISHED GRADE DURING THE MONTHS WHEN PERMANENT STABILIZATION IS FOUND TO BE IMPRACTICAL, AN APPROVED TEMPORARY SEED AND STRAW ANCHORED MULCH OR OTHER ACCEPTABLE MEANS SHALL BE APPLIED TO DISTURBED AREAS, WITH FINAL STABILIZATION WITH SOD IN SPRING.
- TEMPORARY SEDIMENT CONTROL DEVICES SHALL BE REMOVED WITHIN (30) CALENDAR DAYS FOLLOWING ESTABLISHMENT OF PERMANENT STABILIZATION IN ALL CONTRIBUTORY DRAINAGE AREAS. STORMWATER MANAGEMENT STRUCTURES USED TEMPORARILY FOR SEDIMENT CONTROL SHALL BE CLEANED AND CONVERTED TO THEIR PERMANENT CONFIGURATION WITHIN THIS TIME PERIOD AS WELL. ALL STORM DRAINAGE STRUCTURES, SUMPS, AND PIPES SHALL BE CLEANED OF ALL SEDIMENTS PRIOR TO FINAL PAYMENT.
- CONTRACTOR SHALL ESTABLISH "TRUCK WASH SITES" TO PROVIDE LOCATIONS FOR TRUCK TIRE RINSING TO PREVENT/REDUCE SEDIMENT TRACKING ONTO PAVED ROADWAYS. WASH SITES SHALL INCLUDE EFFECTIVE WHEEL WASHER SYSTEMS / RACKS AND SHALL USE PRESSURE-SPRAYED WATER TO REMOVE MUD. SOIL. AND ROCK FROM VEHICLES EXITING THE SITE. CONTRACTOR SHALL PROVIDE DESIGN, SETUP, MAINTENANCE, AND OPERATION OF RINSE STATIONS IN ACCORDANCE WITH THE PROJECT SWPPP, NPDES CGP, AND ALL OTHER PERMITS. NO SOAPS, DETERGENTS, OR SOLVENTS SHALL BE USED. DESIGN AND OPERATION OF WASH SITES SHALL ENSURE THAT DRAINAGE FROM THE WHEEL WASH AREAS LEADS TO A TRAP, SILT FENCE, OR OTHER BMP FOR SETTLING. IN ADDITION, STREET SWEEPING SHALL BE CONDUCTED AS NEEDED TO IMMEDIATELY REMOVE ANY SEDIMENT FROM ROADWAY SURFACES.

# PROPOSED POND DEWATERING METHODS AND SEQUENCE:

<u>STEP IA.</u> CONDUCT INITIAL DEWATERING OF CITY HALL PONDS BY INSTALLATION OF PUMP IN LOWER LOBE OF CITY HALL PONDS AND DECANTING CLEAN WATER FROM ABOVE LEVEL OF SEDIMENTS IN ALL THREE LOBES. TURBID WATER AND SEDIMENTS SHALL NOT BE DISCHARGED DOWNSTREAM DURING THIS PROCESS.

STEP IB. EXCAVATE SUMPS AT THE TWO CULVERT OUTLETS INTO THE POND. SUMPS SHALL BE LINED WITH GEOTEXTILE FABRIC AND WASHED STONE. CONSTRUCT COFFERDAMS AT THESE LOCATIONS, WITH MAXIMUM ELEVATION = 95.3 FT.

STEP 1C. INSTALL COFFERDAM AT DOWNSTREAM END OF POND, IN APPROXIMATE LOCATION SHOWN ON PLANS. ELEVATION OF COFFERDAM SHALL NOT EXCEED 95.3 FT. CONTRACTOR MAY SELECT COFFERDAM MATERIALS, TO BE ACCEPTED BY ENGINEER. INSTALL HAMMOND BROOK AND COLD SPRINGS CULVERT BYPASS PUMPS AND BEGIN PUMPING CLEAR WATER TO THE PROPOSED OUTLET POINT PRIOR TO THE POND OUTLET.

DURING A DRY WEATHER PERIOD. EXCAVATE SEDIMENTS FROM WITHIN THE HAMMOND BROOK AND COLD SPRINGS DURING THE PERIOD OF SEDIMENT EXCAVATION FROM EACH CULVERT. FLOWS FROM THAT CULVERT WILL BE REDIRECTED TO THE POND BASIN AREA RATHER THAN THE DOWNSTREAM DISCHARGE POINT, TO PREVENT MOBILIZATION OF SEDIMENTS DOWNSTREAM DURING CULVERT EXCAVATION. ONCE CULVERT CLEANING IS COMPLETED AND REVIEWED BY THE ENGINEER, BYPASS PUMPING MAY RESTART FROM THAT CULVERT.

STEP IIB. WITH BYPASS PUMPS AND DOWNSTREAM COFFERDAM IN PLACE, CONTRACTOR SHALL CONTINUE TO DEWATER THE POND LOBES AS NEEDED THROUGH THE CONSTRUCTION PERIOD BY INSTALLING POND DEWATERING PUMPS IN THE THREE LOBES AS EXCAVATION PROGRESSES. AS DESCRIBED IN THE FOLLOWING SUGGESTED SEQUENCE. DEWATERING PUMPS WITHIN THE POND SHALL BE SET IN SUMPS LINED WITH GEOTEXTILE FABRIC AND SURROUNDED BY WASHED STONE. SUMPS SHALL NOT BE DEEPER THAN THE HISTORICAL POND BOTTOM OR THE EXTENTS SHOWN ON THE PLANS, WHICHEVER IS ENCOUNTERED FIRST. ALL WORK WITHIN THE POND SHOULD PROGRESS FROM UPSTREAM TO DOWNSTREAM.

DURING THE PERIOD OF EXCAVATION OF SEDIMENTS FROM THE UPPER POND LOBE, DEWATERING PUMP DISCHARGES SHOULD BE DIRECTED TO THE NEXT DOWNSTREAM POND LOBE (THE MIDDLE LOBE) FOR SETTLING. TEMPORARY COFFERDAM MAY BE CONSTRUCTED NEAR THE MORE UPSTREAM PEDESTRIAN BRIDGE, IN A LOCATION SELECTED BY THE CONTRACTOR AND ACCEPTED BY THE ENGINEER.

DURING THE PERIOD OF EXCAVATION OF SEDIMENTS FROM THE MIDDLE POND LOBE, DEWATERING PUMP DISCHARGES SHOULD BE DIRECTED TO THE MOST DOWNSTREAM POND LOBE FOR SETTLING. TEMPORARY COFFERDAM MAY BE CONSTRUCTED NEAR THE MORE DOWNSTREAM PEDESTRIAN BRIDGE, IN A LOCATION SELECTED BY THE CONTRACTOR AND ACCEPTED BY THE ENGINEER.

STEP IIIC. DURING THE PERIOD OF EXCAVATION OF SEDIMENTS FROM THE MOST DOWNSTREAM POND LOBE, DEWATERING PUMP DISCHARGES SHOULD BE DIRECTED UPGRADIENT TO THE MIDDLE POND LOBE AND PROVIDED WITH SEDIMENT CONTROLS (DEWATERING BAG ETC) TO PREVENT SEDIMENT FROM ENTERING PREVIOUSLY DREDGED AREA.

STEP IVA. CONTINUE DEWATERING USING THE POND DEWATERING PUMPS AND BYPASS PUMPS THROUGHOUT THE PROJECT.

STEP IVB. DURING DRY WEATHER, INFLOW TO THE POND WILL BE BYPASSED BY THE TWO BYPASS PUMPS. OTHER INFLOW WILL COLLECT IN LOW LYING AREAS. THE CONTRACTOR SHALL OPERATE THE POND DEWATERING PUMPS AS NEEDED TO PUMP FLOWS TO OTHER POND LOBES. NO DEWATERING PUMP DISCHARGE DIRECTLY TO DOWNSTREAM AREAS WILL BE ALLOWED. NO TURBID DISCHARGES TO THE POND OUTLET AND DOWNSTREAM AREAS WILL BE ALLOWED. ALL DISCHARGE REQUIREMENTS OF PROJECT PERMITS MUST BE MET.

STEP IVC. DURING WET WEATHER, THE CONTRACTOR SHALL MINIMIZE THE RISE OF WATER WITHIN THE POND BY CONTINUING TO BYPASS PUMP AND BY USING THE DEWATERING PUMPS. IF INCOMING FLOW EXCEEDS THE CONTRACTOR'S CAPACITY TO PUMP OR TO TREAT DEWATERING DISCHARGES, CONTRACTOR SHALL REMOVE EQUIPMENT AND MACHINERY FROM THE POND AND ALLOW FLOW TO REFILL THE POND AND TO PASS OVER THE COFFERDAM AND DOWNSTREAM.

STEP IVD. ALL MATERIALS USED IN THE CONSTRUCTION OF COFFERDAMS SHALL BE REMOVED AT THE END OF THE PROJECT. ALL AREAS DISTURBED BY PUMPS, PIPELINES, ACCESS, AND OTHER MATERIALS/ACTIVITIES ASSOCIATED WITH CONTROL OF WATER SHALL BE RESTORED TO PRECONSTRUCTION CONDITION OR BETTER AT THE END OF THE PROJECT.

#### **STORMWATER PERMIT NOTES:**

LEGEND

BOUNDARY OF BANK RESOURCE

EXISTING 1 FT. UPLAND CONTOUR

EXISTING 5 FT. UPLAND CONTOUR

EXISTING CHAIN LINK FENCE

EXISTING STORM DRAIN LINE

EXISTING CATCH BASIN

EXISTING MANHOLE

EXISTING LIGHT POLE

EXISTING VEGETATION

PROPOSED SAFETY FENCE

PROPOSED SILT FENCE (C-8)

OR APPROVED EQUAL CC-8

GALVANIZED IRON WATER PIPE

SANITARY SEWER

SURFACE DRAIN (VITRIFIED TILE)

PROPOSED FILTREX SILT SOXX

CATCH BASIN PROTECTION  $\bigcirc$  C-8

EXISTING SIGN

EXISTING TREES

<u>POTENTIAL UTILITIES ON SITE</u>

(NOT SURVEYED)

EXISTING DRAIN MANHOLE

EXISTING SANITARY MANHOLE

EXISTING ELECTRIC MANHOLE

EXISTING BURIED ELECTRIC LINE

EDGE OF WATER

----- EXISTING PROPERTY LINE

— — EXISTING EASEMENT

- 1. THIS PROJECT IS REGULATED UNDER THE UNITED STATES ENVIRONMENTAL PROTECTION AGENCY'S (EPA'S) NATIONAL POLLUTANT DISCHARGE ELIMINATION SYSTEM (NPDES) GENERAL PERMIT FOR DISCHARGES FROM CONSTRUCTION OPERATORS OF SUCH CONSTRUCTION SITES MUST MEET THE REQUIREMENTS OF EPA'S CONSTRUCTION GENERAL PERMIT (CGP). PART OF THE CGP REQUIREMENTS IS THE PREPARATION OF A STORMWATER POLLUTION PREVENTION PLAN (SWPPP) FOR THE PROPOSED PROJECT. A SWPPP WILL BE PREPARED FOR THIS PROJECT AND WILL BE PROVIDED TO THE CONTRACTOR BY
- 2. UNDER THE CONTRACT FOR THE CONSTRUCTION OF THIS PROJECT, THE CONTRACTOR SHALL BE THE OWNER'S FULL AGENT IN THE IMPLEMENTATION AND MAINTENANCE OF THE SWPPP.
- 3. TO OBTAIN COVERAGE UNDER THE CONSTRUCTION GENERAL PERMIT (CGP), A COMPLETE AND ACCURATE NOTICE OF INTENT (NOI) SHALL BE PREPARED ONLINE USING THE NET SYSTEM AND SUBMITTED TO THE ENVIRONMENTAL PROTECTION AGENCY (EPA) BY THE OWNER, THE CONTRACTOR, AND ANY APPLICABLE
- 4. THE OWNER, CONTRACTOR, AND ALL APPLICABLE SUBCONTRACTORS ARE EQUALLY RESPONSIBLE FOR COMPLYING WITH THE TERMS OF THE CGP AND FOR THE EFFECTIVE IMPLEMENTATION OF THE SWPPP. EACH PARTY FILING A NOI WILL NEED TO ADD COMPANY CONTACT INFORMATION AND TO AMEND THE SWPPP AS SITE CONDITIONS WARRANT TO MEET REQUIRED PERMIT ELEMENTS. ALL PARTIES WILL ALSO NEED TO MAINTAIN THE SWPPP DOCUMENT, CONDUCT INSPECTIONS, UPGRADE AND MAINTAIN SEDIMENT AND EROSION CONTROLS AS NEEDED, AND MEET ALL PERMIT NOTICE OF INTENT (NOI) / NOTICE OF TERMINATION (NOT) REQUIREMENTS.
- 5. EACH CONTRACTOR AND SUBCONTRACTOR THAT HAS OPERATIONAL CONTROL OVER THE CONSTRUCTION PLANS AND/OR SPECIFICATIONS MUST SIGN THE CONTRACTOR'S CERTIFICATION FORM INCLUDED IN THE SWPPP
- IMPLEMENTATION OF THE SWPPP MUST BEGIN AT THE COMMENCEMENT OF CONSTRUCTION ACTIVITY AND MUST BE FULLY AND CONTINUALLY DOCUMENTED UNTIL FINAL STABILIZATION OF THE SITE IS COMPLETE AND A NOT IS FILED.
- 7. A SIGN MUST BE VISIBLY POSTED AT THE SITE WHICH PROVIDES NOTICE OF THE CGP, THE NPDES PERMIT ID(S), A CONTACT NAME AND PHONE NUMBER FOR OBTAINING ADDITIONAL INFORMATION, AND THE ONSITE LOCATION WHERE THE SWPPP IS STORED, AS WELL AS THE URL FOR THE SWPPP IF POSTED ONLINE. IN ADDITION, TWO STATEMENTS IDENTIFIED IN THE SWPPP REGARDING HOW TO OBTAIN MORE INFORMATION MUST BE POSTED IN THIS SIGNAGE
- 8. IT IS THE RESPONSIBILITY OF THE OWNER, CONTRACTOR AND ALL APPLICABLE SUBCONTRACTORS TO INDICATE CONSTRUCTION ACTIVITY SEQUENCING AND TIMING IN
- INSPECTION AND MAINTENANCE MUST BE PERFORMED REGULARLY FOR PERMIT COMPLIANCE, AND DOCUMENTATION OF INSPECTIONS AND MAINTENANCE MUST BE APPENDED TO THE SWPPP BY THE CONTRACTOR.
- WHENEVER THERE IS A CHANGE IN DESIGN, CONSTRUCTION OPERATION, OR MAINTENANCE AT THE CONSTRUCTION SITE THAT HAS, OR COULD HAVE, A SIGNIFICANT EFFECT ON THE DISCHARGE OF STORMWATER POLLUTANTS, THE SWPPP MUST BE AMENDED BY THE CONTRACTOR.
- 11. CONTRACTOR SHALL IDENTIFY THE LOCATIONS OF THE FOLLOWING ON THE SEDIMENT AND EROSION CONTROL (S&EC) PLANS AS WELL AS ANY OTHER REQUIRED PERMIT ELEMENTS NOT SHOWN ON THE PLANS AT THE TIME OF THEIR PREPARATION (SEE CGP PERMIT SECTION
  - CONCRETE TRUCK WASHOUT AREAS (SEE SWPPP)
  - PORTABLE SANITARY UNITS (TOILETS)
  - FUEL TANKS
  - LIMITS OF STAGING AREAS & SOIL DISTURBANCE AREAS
  - WASTE CONTAINER LOCATIONS (E.G., DUMPSTERS)
  - CHEMICAL, MATERIAL, EQUIPMENT, & VEHICLE STORAGE AREAS
  - SOIL STOCKPILES & CONTROLS.
- 12. IF ADDITIONAL CONTROLS OR BMPS ARE ADDED, THESE SHALL BE DEPICTED ON THE S&EC PLANS AND A DESCRIPTION ADDED TO THE SWPPP BY THE CONTRACTOR THESE NEW CONTROLS SHALL BE ADDED TO THE WEEKLY INSPECTIONS AS WELL CONTRACTOR SHALL IDENTIFY ON THE S&EC PLANS ALL AREAS THAT HAVE UNDERGONE FINAL STABILIZATION.
- 13. UPON FINAL STABILIZATION, A NOTICE OF TERMINATION (NOT) MUST BE ELECTRONICALLY PREPARED AND SUBMITTED TO THE EPA BY ALL PARTIES WHO COMPLETED A NOI USING THE ONLINE NET SYSTEM.

- 1. CONTRACTOR SHALL SUBMIT DETAILED DEWATERING PLAN, CONSTRUCTION SEQUENCE AND SHOP DRAWINGS AND NARRATIVE DESCRIPTION OF ALL COFFERDAMS FOR ACCEPTANCE BY THE ENGINEER AND CONSERVATION COMMISSION PRIOR TO INITIATING ANY WORK ONSITE. CONTRACTOR SHALL BE AWARE THAT THE POND HAS A 2.7± SQUARE MILE WATERSHED (ACCORDING TO CITY OF NEWTON GIS MAPPING -AVAILABLE UPON REQUEST) AND THAT FLOW THROUGH THE POND IS FLASHY IN NATURE DUE TO STORMWATER INPUTS. PUMPS WILL NEED TO BE SIZED BY THE CONTRACTOR TO HANDLE INFLOWS. FLOODING POTENTIAL EXISTS AND MUST BE CONSIDERED IN THE DEWATERING AND CONTROL OF WATER PLAN. CONTRACTOR SHALL BE RESPONSIBLE FOR CONTROL OF WATER FOR THE DURATION OF CONSTRUCTION. ALL DAMAGE CAUSED BY WATER FLOW AT THE SITE IS THE RESPONSIBILITY OF THE CONTRACTOR, AT NO ADDITIONAL COST TO THE OWNER
- 2. TEMPORARY COFFERDAMS TO BE INSTALLED BY CONTRACTOR. COFFERDAMS MAY BE CONSTRUCTED OF SUPER SACKS (OR EQUAL), EARTHEN MATERIALS, SANDBAGS, OR OTHER MATERIALS ACCEPTED BY THE ENGINEER AND CONSERVATION COMMISSION. MAX. ELEVATIONS=95.3. TEMPORARY COFFERDAMS MUST BE IN PLACE DURING EXCAVATION OF POND LOBES.

5	ISSUED FOR BIDDING	JRB	10/17/23
4	NOTE MODIFICATIONS, ISSUED FOR BIDDING	JRB	10/13/22
3	ISSUED FOR WQC APPLICATION	JRB	3/23/21
2	CONSTRUCTION ACCESS ROAD MODIFICATIONS	JRB	11/18/20
1	MISC. NOTE CHANGES - REISSUED FOR NOI PERMITTING	JRB	11/17/20
0	ISSUED FOR PERMITTING	JRB	9/11/20
NO.	ISSUE/DESCRIPTION	BY	DATE

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CITY HALL PONDS MAINTENANCE DREDGING PROJECT NEWTON CENTRE, MASSACHUSETTS

#### **EROSION AND SEDIMENT CONTROL** & CONTROL OF WATER PLAN



DESIGNED BY: JRB | DRAWN BY:


SEPTEMBER, 2020

PROJECT NO.

PREPARED FOR: CITY OF NEWTON DEPARTMENT OF PUBLIC WORKS 1000 COMMONWEALTH AVENUE NEWTON CENTRE, MA 02459

JRB | REVIEWED BY: TEJ | CHECKED BY: SLL EDM SCALE: 1"=40' REVISION NO. 15.0166758.00

DRAWING

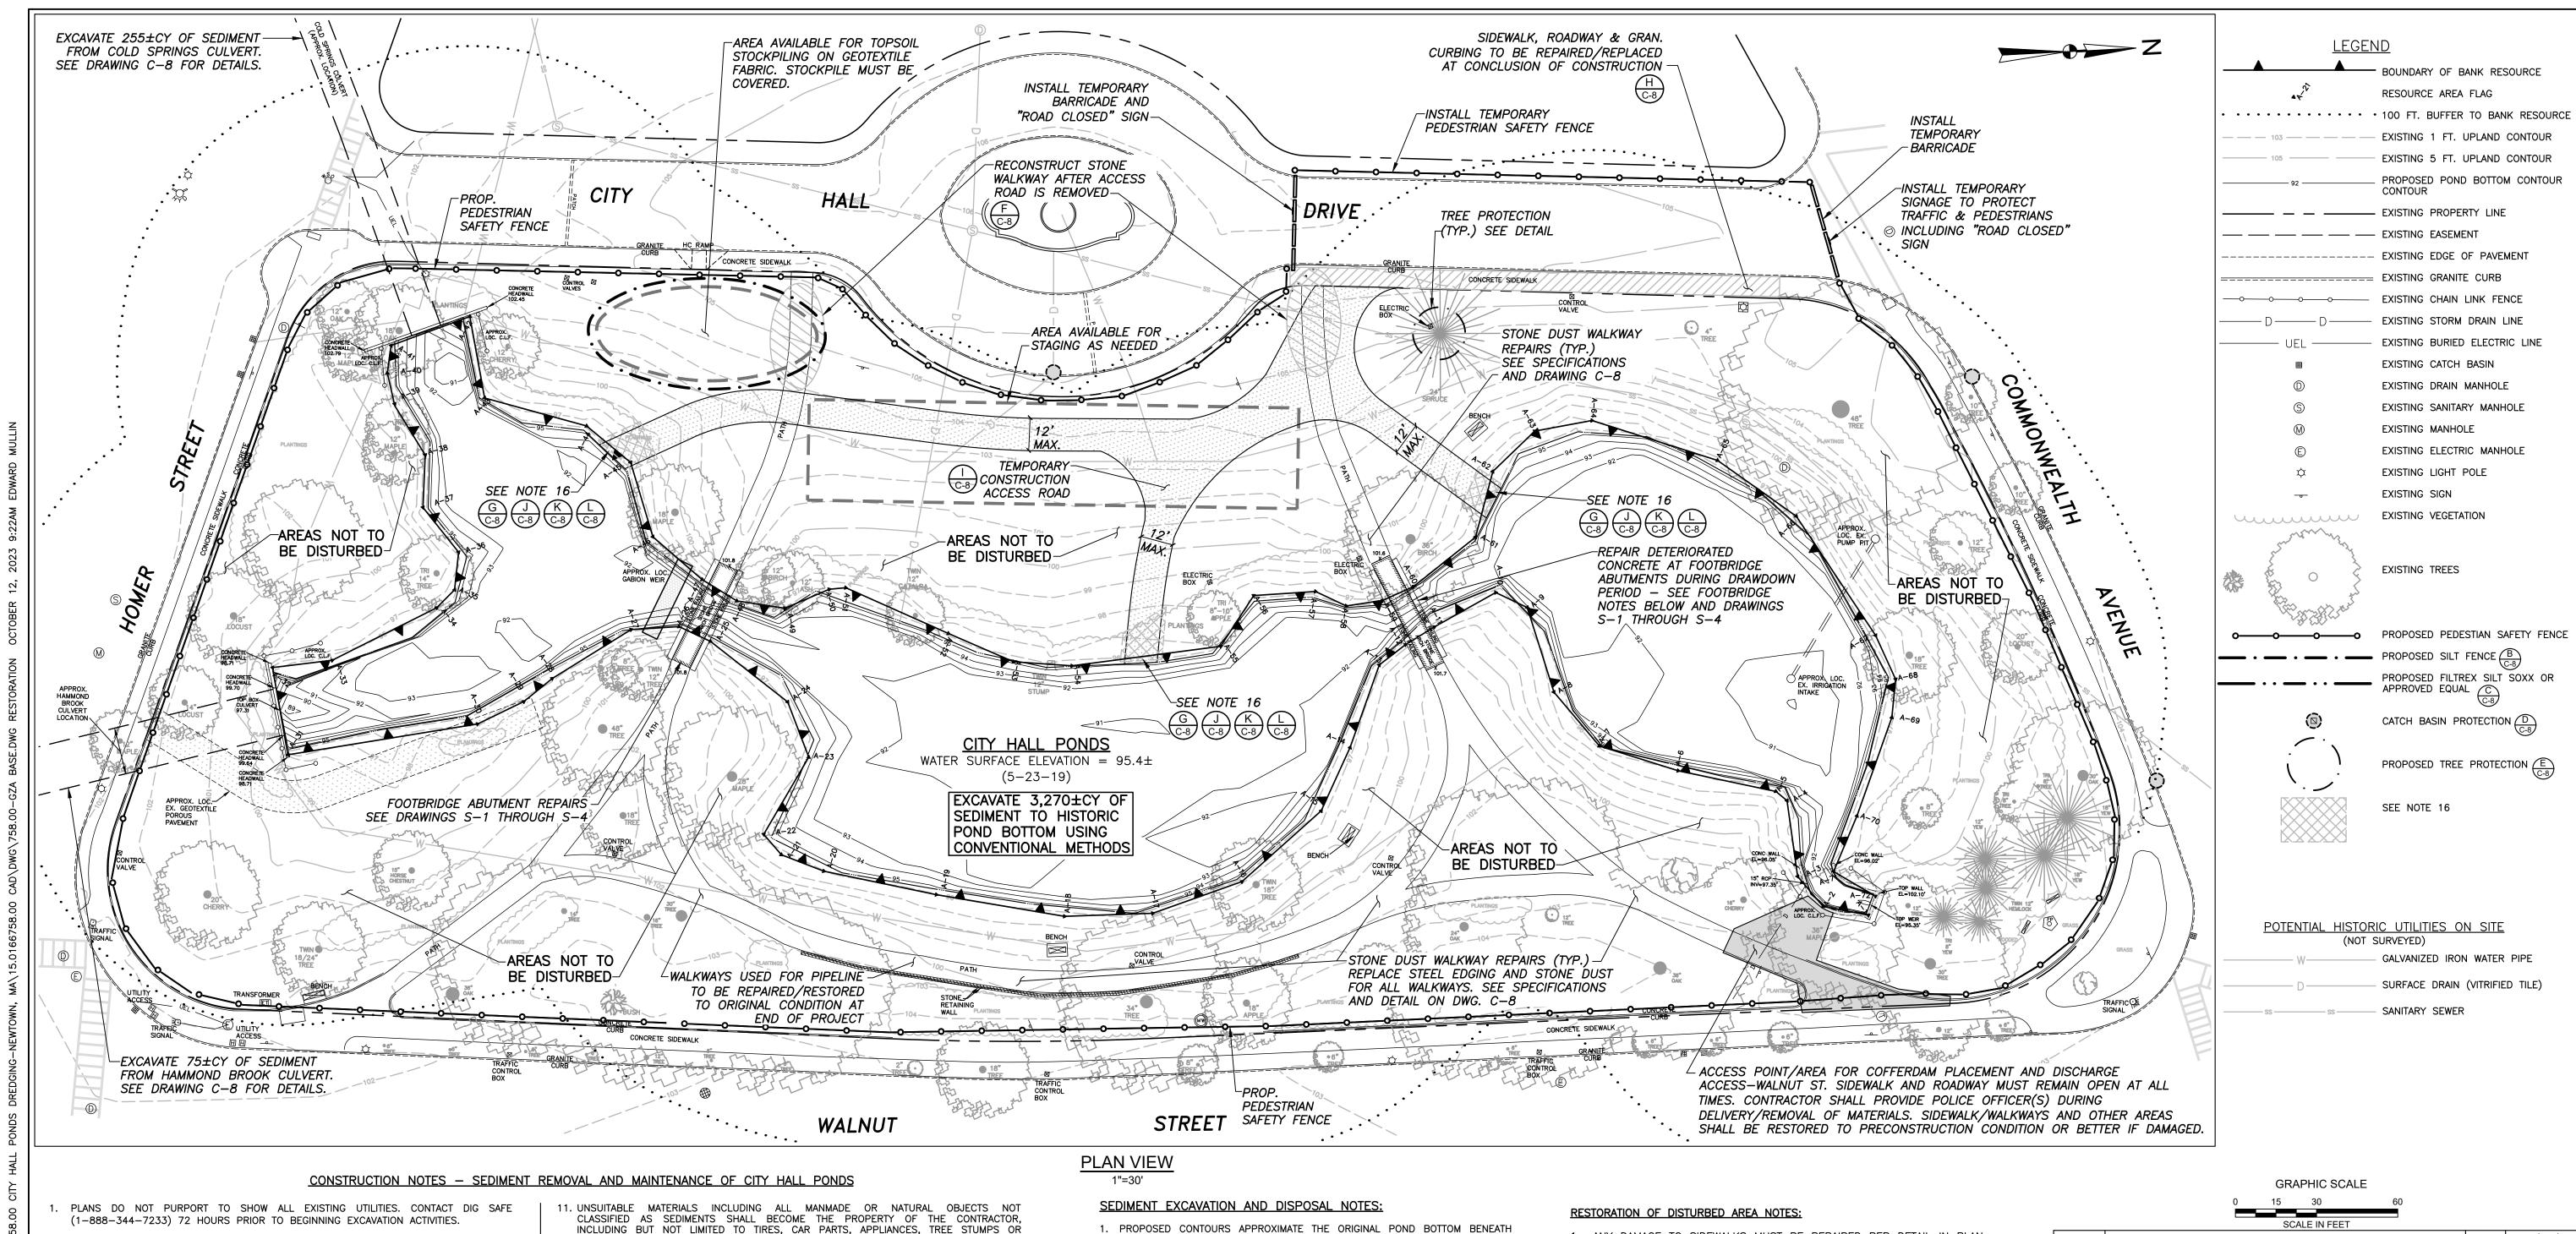

- ALL WORK SHALL COMPLY WITH ENVIRONMENTAL PERMITS ISSUED FOR THE PROJECT. CONTRACTOR SHALL PROVIDE AND ERECT REQUIRED SIGN FOR DISPLAYING DEP FILE
- 3. TREES AND PERMANENT STRUCTURES ARE TO BE PROTECTED. VEGETATION REMOVAL SHALL BE LIMITED ALONG POND BANKS AS PER ENVIRONMENTAL PERMITS AND PROJECT PLANS AND SPECIFICATIONS.
- 4. SITE ACCESS SHALL BE AS SHOWN ON THE PLANS AND DETAILED IN THE PROJECT SPECIFICATIONS. CONTRACTOR MAY MAKE MINOR ADJUSTMENTS TO LOCATION AND ALIGNMENT OF ACCESS DRIVE ONLY WITH ACCEPTANCE OF OWNER.
- 5. EXCAVATION SHALL CONFORM TO THE REQUIREMENTS OF THE SPECIFICATIONS.
- SEQUENCE OF EXCAVATION OPERATIONS SHALL INSURE THE EFFICIENT REMOVAL OF MATERIALS IN A TIMELY MANNER. SEQUENCE OF OPERATIONS MUST COMPLY WITH THE TERMS OF ANY ENVIRONMENTAL PERMITS ISSUED FOR THE PROJECT AND THE PROJECT
- NOTIFY THE ENGINEER IF ANY UTILITIES ARE DISCOVERED DURING THE DRAWDOWN OF THE POND OR EXCAVATION OPERATIONS. UTILITIES DETERMINED TO BE ABANDONED SHALL BE REMOVED WITHIN THE GRADES SHOWN IN THE PLANS AT THE ENGINEER'S DIRECTION. ACTIVE UTILITIES SHALL NOT BE DISTURBED UNLESS DIRECTED BY THE ENGINEER. IRRIGATION SYSTEM IS ACTIVE. CONTRACTOR SHALL PROTECT ALL UTILITIES THROUGHOUT COURSE OF PROJECT. CONTRACTOR SHALL BE RESPONSIBLE FOR REPAIR/REPLACEMENT OF ALL DAMAGED UTILITIES/IRRIGATION SYSTEMS AT NO ADDITIONAL EXPENSE TO OWNER.
- B. GABION WEIR IN POND MUST BE PROTECTED FROM DAMAGE DURING THE CONSTRUCTION PERIOD AND REPAIRED/RESET IF DAMAGE OR MOVEMENT OCCURS.
- . OVEREXCAVATION BEYOND THE AREA OF WORK AND CONTOURS INDICATED ON THE PLANS AND THE ELEVATIONS INDICATED ON THE CROSS SECTIONS WILL NOT BE PERMITTED OR PAID FOR BY THE OWNER. THE POND REPORTEDLY HAS A CLAY LINER. THE HISTORIC POND BOTTOM/LINER SHALL NOT BE DISTURBED DURING THE PROJECT.
- 10. BEDROCK IS NOT TO BE EXCAVATED IF ENCOUNTERED.

- LIMBS, VEGETATION, ETC. THESE MATERIALS MUST BE DISPOSED OF AT AN APPROPRIATE LOCATION OFFSITE CONSISTENT WITH ALL APPLICABLE LOCAL, STATE, AND FEDERAL REGULATIONS.
- 12. EQUIPMENT AND MATERIALS STORAGE SHALL BE CONFINED TO THE STAGING AREA. EXCAVATION EQUIPMENT MAY BE PARKED ON THE CONSTRUCTION ACCESS OUTSIDE OF THE POND DURING PERIODS OF INACTIVITY.
- 13. REFUELING OF EQUIPMENT MUST TAKE PLACE OUTSIDE OF THE POND AND THE 100 FT BUFFER TO RESOURCE AREAS. TEMPORARY FUEL STORAGE TANKS SHALL NOT BE PERMITTED AT THE PROJECT SITE. REFUELING ON SITE MAY ONLY OCCUR IN AREAS APPROVED BY THE OWNER.
- 14. THE POTENTIAL EXISTS FOR MAJOR FLOOD EVENTS DURING THE CONSTRUCTION PERIOD. THE CONTRACTOR SHALL NOT LEAVE EQUIPMENT IN THE POND AREA DURING PERIODS WHEN PERSONNEL ARE NOT ONSITE TO MOVE IT.
- 15. AT THE COMPLETION OF EXCAVATION OPERATIONS, THE CONTRACTOR SHALL REMOVE ALL EROSION CONTROL BARRIERS, GEOTEXTILE FABRICS, STONE, TIMBERS, AND OTHER MATERIALS USED FOR TEMPORARY ACCESS OR CONTROLS ON THE POND BOTTOM.
- 16. CONTRACTOR TO REMOVE AND RESET CHAIN LINK FENCE (IF PRESENT) AND BOULDERS AT THREE POND ACCESS POINTS. EACH OF THREE POND ACCESS POINTS SHALL INCLUDE VEGETATION REMOVAL ALONG NO MORE THAN 15 FT. OF BANK. TOPSOIL FROM ACCESS AREAS (HATCHED ON PLAN) SHALL BE STOCKPILED SEPARATELY AND RESET AT PROJECT END. RESTORATION OF AREAS SHALL COMMENCE WITHIN 14 DAYS OF THE END OF WORK WITHIN A POND LOBE AND ACCESS ROAD REMOVAL. 12" DIA. COMPOST FILTER TUBE EQUAL SHALL BE PLACED AROUND AREA UNTIL VEGETATION IS ESTABLISHED. SEE RESTORATION OF DISTURBED AREA NOTES ON THIS SHEET FOR ADDITIONAL RESTORATION INFORMATION.

- THE ACCUMULATED SEDIMENTS AS ESTIMATED BY PROBING DATA OBTAINED BY GZA GEOENVIRONMENTAL, INC. IN DECEMBER 2010.
- 2. SEDIMENT EXCAVATION SHALL PROCEED TO THE LINES AND GRADES AS INDICATED ON THESE PLANS AND CROSS SECTIONS OR TO THE FIRM CLAY BOTTOM APPROVED BY THE ENGINEER, WHICHEVER IS FIRST ATTAINED.
- 3. OVEREXCAVATION BEYOND THE LINES AND GRADES AS INDICATED ON THESE PLANS AN DISTURBANCE OF THE CLAY ORIGINAL POND BOTTOM WILL NOT BE PERMITTED OR PAID FOR BY THE OWNER.
- 4. DREDGED SLOPES SHALL HAVE A MAXIMUM STEEPNESS OF 3 HORIZONTAL TO 1 VERTICAL (3H:1V).
- 5. SEDIMENTS SHALL BE TRANSPORTED BY THE CONTRACTOR FOR REUSE/DISPOSAL OFF SITE. SEE SPECIFICATIONS FOR DETAILS.

# FOOTBRIDGE REPAIR NOTES - SEE DRAWINGS S-1 THROUGH S-4:

- 1. ALL FOOTBRIDGE REPAIR WORK SHALL BE CONDUCTED IN DRY WEATHER CONDITIONS, WITH THE POND DRAWN DOWN IN THE AREA OF THE WORK.
- 2. THE STONE FACES OF THE FOOTBRIDGE SHALL BE PROTECTED FROM THE REPAIR ACTIVITIES. ANY DAMAGE SHALL BE REPAIRED IN COORDINATION WITH APPLICABLE HISTORICAL REPAIR CONSULTANTS.
- 3. REPAIR WORK SHALL BE LIMITED TO AREAS OF DETERIORATED CONCRETE AT THE NORMAL WATER LINE AND SHALL BE CONDUCTED PER PROJECT DRAWINGS AND SPECIFICATIONS.
- 4. IN GENERAL, REPAIR WORK WILL CONSIST OF REMOVING DETERIORATED CONCRETE IN THE AREA OF THE NORMAL WATER LINE, PREPARATION OF THE SUBSTRATE, FORMING AND POURING CONCRETE REPAIRS, AND RUBBING AND FINISHING THE FORMED CONCRETE SURFACES.
- 5. IF WORK IS CONDUCTED IN COLD WEATHER, HEATED ENCLOSURES WILL BE NEEDED PER DRAWINGS AND SPECIFICATIONS.

- ANY DAMAGE TO SIDEWALKS MUST BE REPAIRED PER DETAIL IN PLAN
- 2. EXISTING WALKWAYS TO BE RESTORED TO ORIGINAL CONDITION OR BETTER AFTER TEMPORARY ACCESS ROUTES HAVE BEEN REMOVED.
- 3. CONTRACTOR TO REMOVE ALL STONE AND FILTER FABRIC FROM TEMPORARY ACCESS AREAS AT END OF CONSTRUCTION.
- 4. DISTURBED AREAS WHICH WERE TURF GRASS PRIOR TO CONSTRUCTION SHALL BE RESTORED TO PRECONSTRUCTION GRADES WITH ORDINARY BORROW, DRESSED WITH 6 INCHES OF TOPSOIL AND SODDED.
- 5. DISTURBED AREAS WHICH WERE VEGETATED BUFFER AREAS ADJACENT TO THE POND (SHOWN IN HATCHING ON THIS SHEET) SHALL BE RESTORED TO PRECONSTRUCTION SUBGRADES WITH ORDINARY BORROW, DRESSED WITH 6 INCHES OF TOPSOIL SET ASIDE FROM THE BANK AREA AT THE START OF CONSTRUCTION, AND PLANTED WITH SHRUBS PER DETAILS ON DRAWING C-8, WITH AREAS ADJACENT TO SHRUBS SEEDED PER DETAIL ON DRAWING C-8.

# OPERATION & MAINTENANCE (O&M) NOTES:

POST CONSTRUCTION, THE CITY OF NEWTON DEPARTMENT OF PUBLIC WORKS WILL OPERATE & MAINTAIN THE POND IN ACCORDANCE WITH THE O&M PLAN DEVELOPED FOR THE SITE.

ISSUED FOR BIDDING JRB | 10/17/23 NOTE MODIFICATIONS, ISSUED FOR BIDDING 10/13/22 3/23/21 ISSUED FOR WOC APPLICATION JRB I 11/18/20 CONSTRUCTION ACCESS ROAD MODIFICATIONS MISC. NOTE CHANGES - REISSUED FOR NOI PERMITTING 11/17/20 ISSUED FOR PERMITTING JRB | 9/11/20 DATE ISSUE/DESCRIPTION

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# CITY HALL PONDS MAINTENANCE DREDGING PROJECT NEWTON CENTRE, MASSACHUSETTS

# **POND RESTORATION PLAN**



SEPTEMBER, 2020

**GZA**GeoEnvironmental, Inc. Engineers and Scientists www.gza.com

ROJECT NO.


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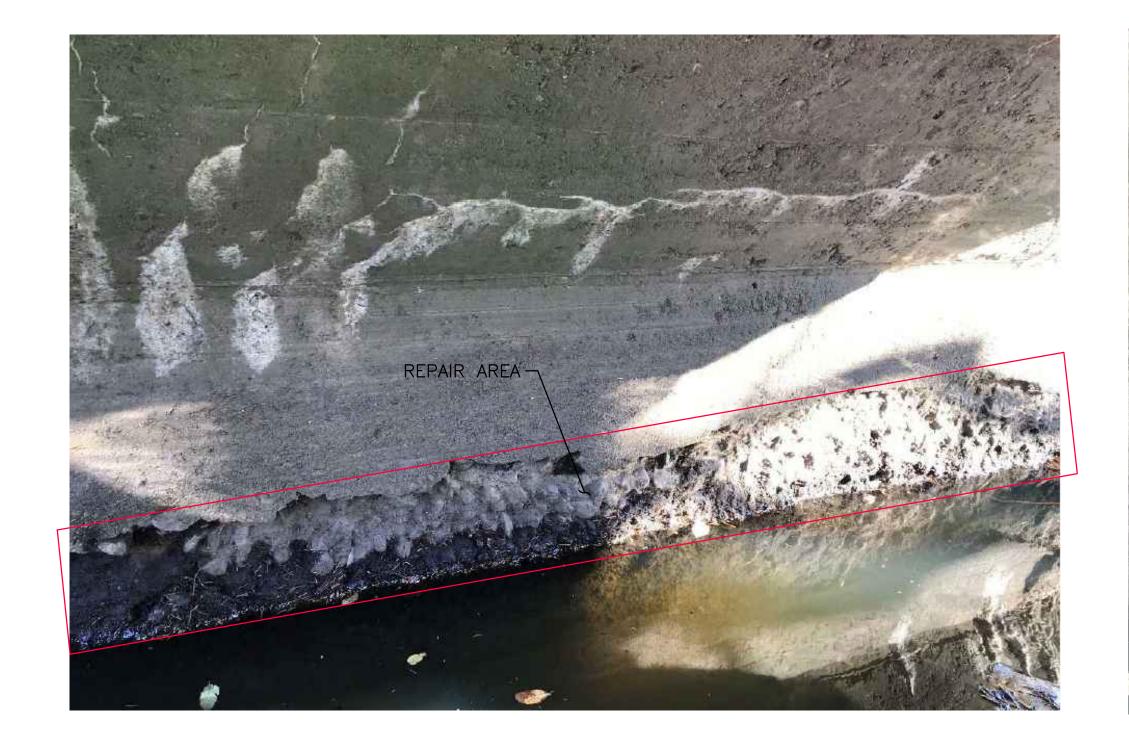
DESIGNED BY: JRB | DRAWN BY:

DEPARTMENT OF PUBLIC WORKS 1000 COMMONWEALTH AVENUE NEWTON CENTRE, MA 02459 JRB | REVIEWED BY: TEJ | CHECKED BY: SLL DRAWING EDM SCALE: 1"=30'

CITY OF NEWTON

REVISION NO.



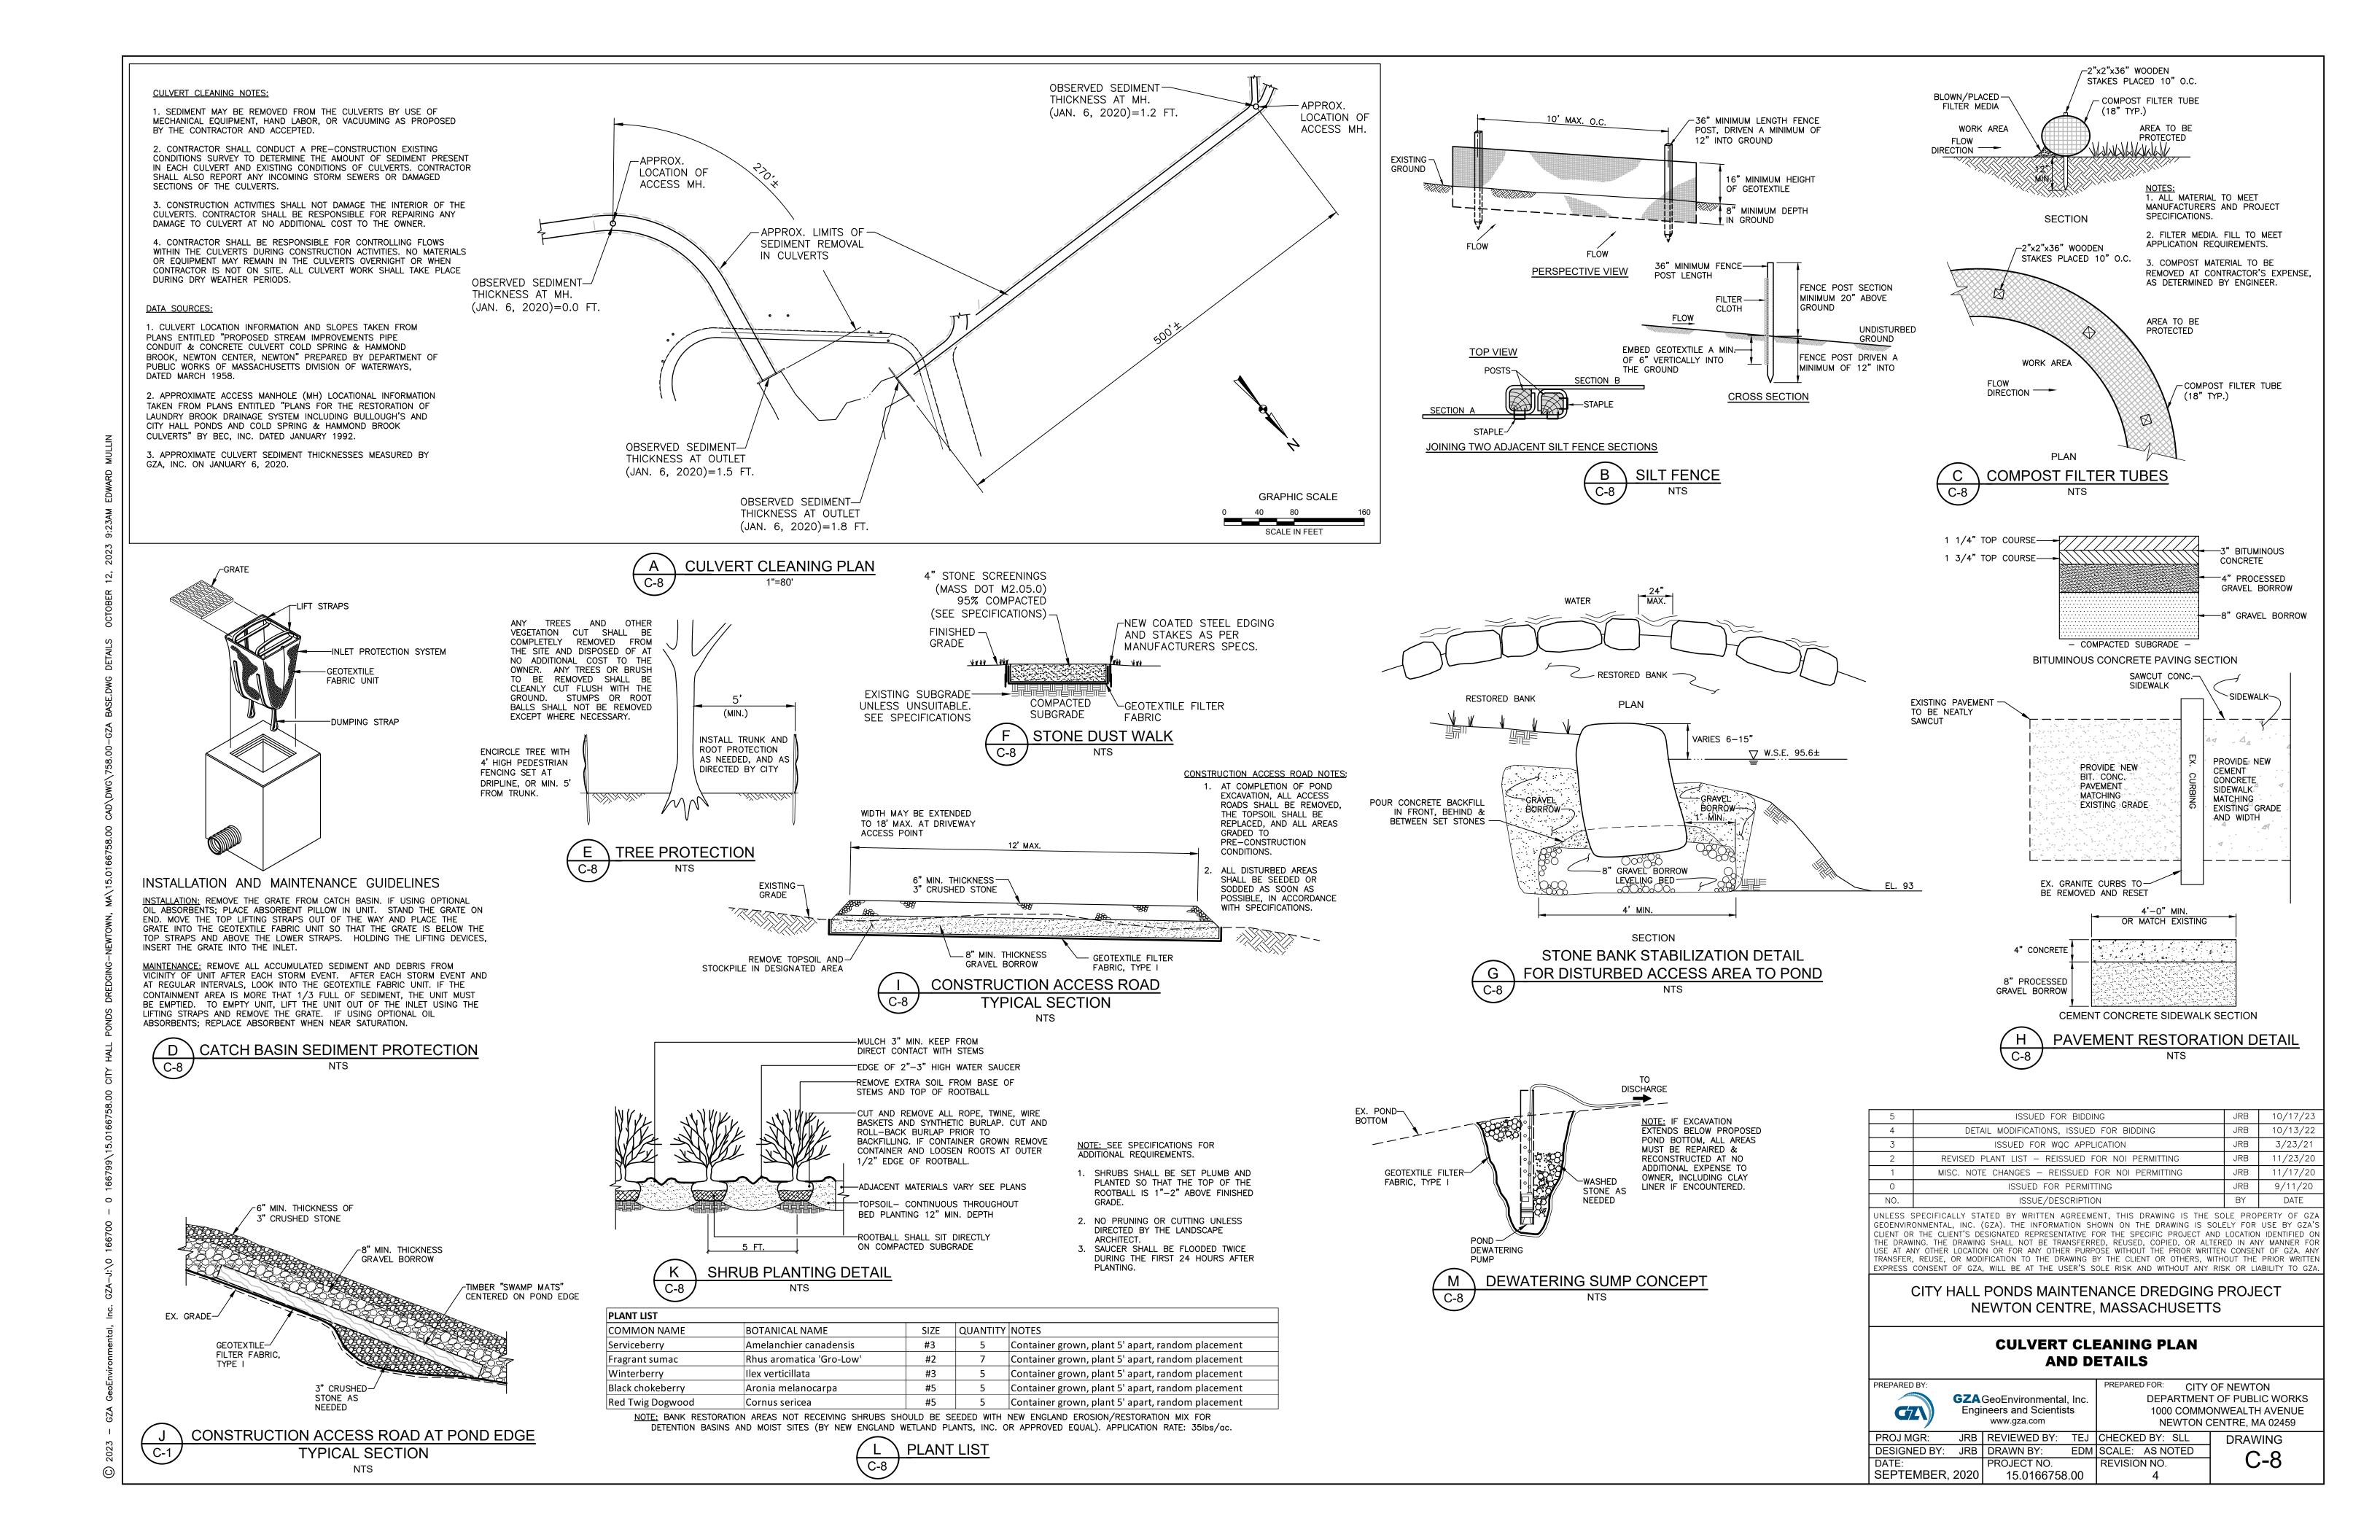


<u>DOWNSTREAM BRIDGE - EAST ABUTMENT</u>



<u>DOWNSTREAM BRIDGE - WEST ABUTMENT</u>



<u>UPSTREAM BRIDGE - EAST ABUTMENT</u>

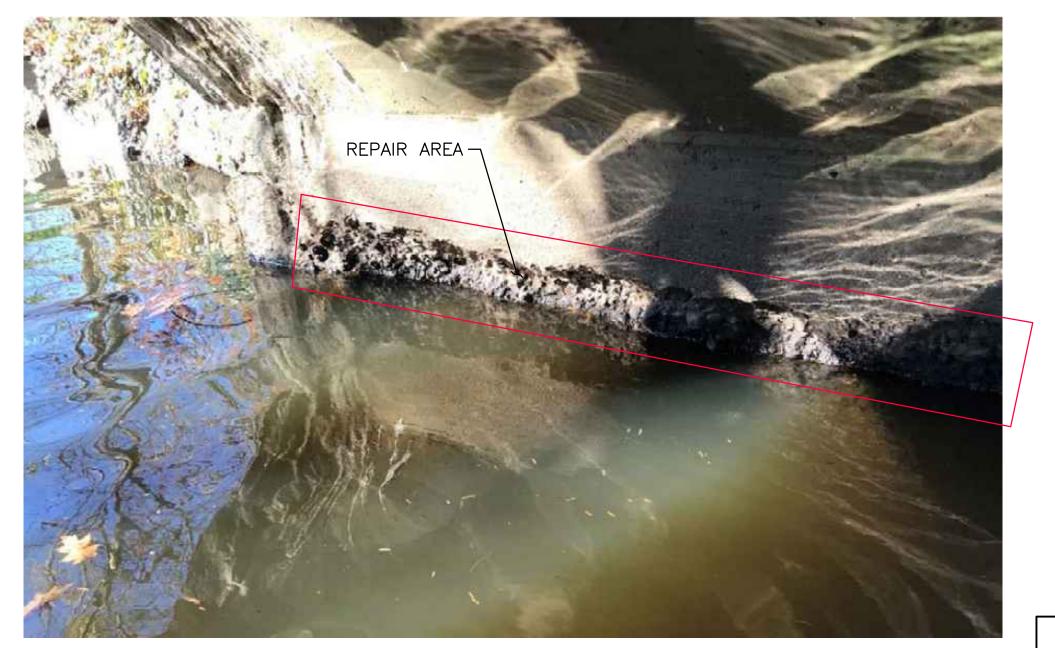

UPSTREAM BRIDGE — WEST ABUTMENT


3	ISSUED FOR BIDDING	PDZ	10/17/23
2	ISSUED FOR BIDDING	PDZ	10/13/22
1	CITY OF NEWTON REVIEW	BDW	9/14/22

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ISSUE/DESCRIPTION

CITY HALL PONDS MAINTENANCE DREDGING PROJECT NEWTON CENTRE, MASSACHUSETTS



# **BRIDGE ABUTMENT REPAIR DETAILS**

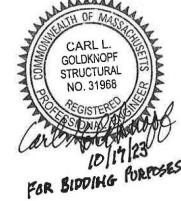JPT 1-15			
IRAL S	PREPARED BY:		
968	GZN		eoEnvironmer eers and Scier www.gza.com
9 100	PROJ MGR:	JRB	REVIEWED B
17160	DESIGNED BY:	PD7	DRAWN RV:


NOTE: EAST AND WEST ABUTMENTS ON BOTH THE DOWNSTREAM AND UPSTREAM BRIDGE ARE TO BE REPAIRED.

PREPARED FOR: CITY OF NEWTON

PDZ SCALE: AS NOTED REVISION NO. PROJECT NO. SEPTEMBER, 2022 15.0166758.00

DEPARTMENT OF PUBLIC WORKS 1000 COMMONWEALTH AVENUE NEWTON CENTRE, MA 02459 BY: JAA CHECKED BY: CLG DRAWING S-1

JRB 9/11/20

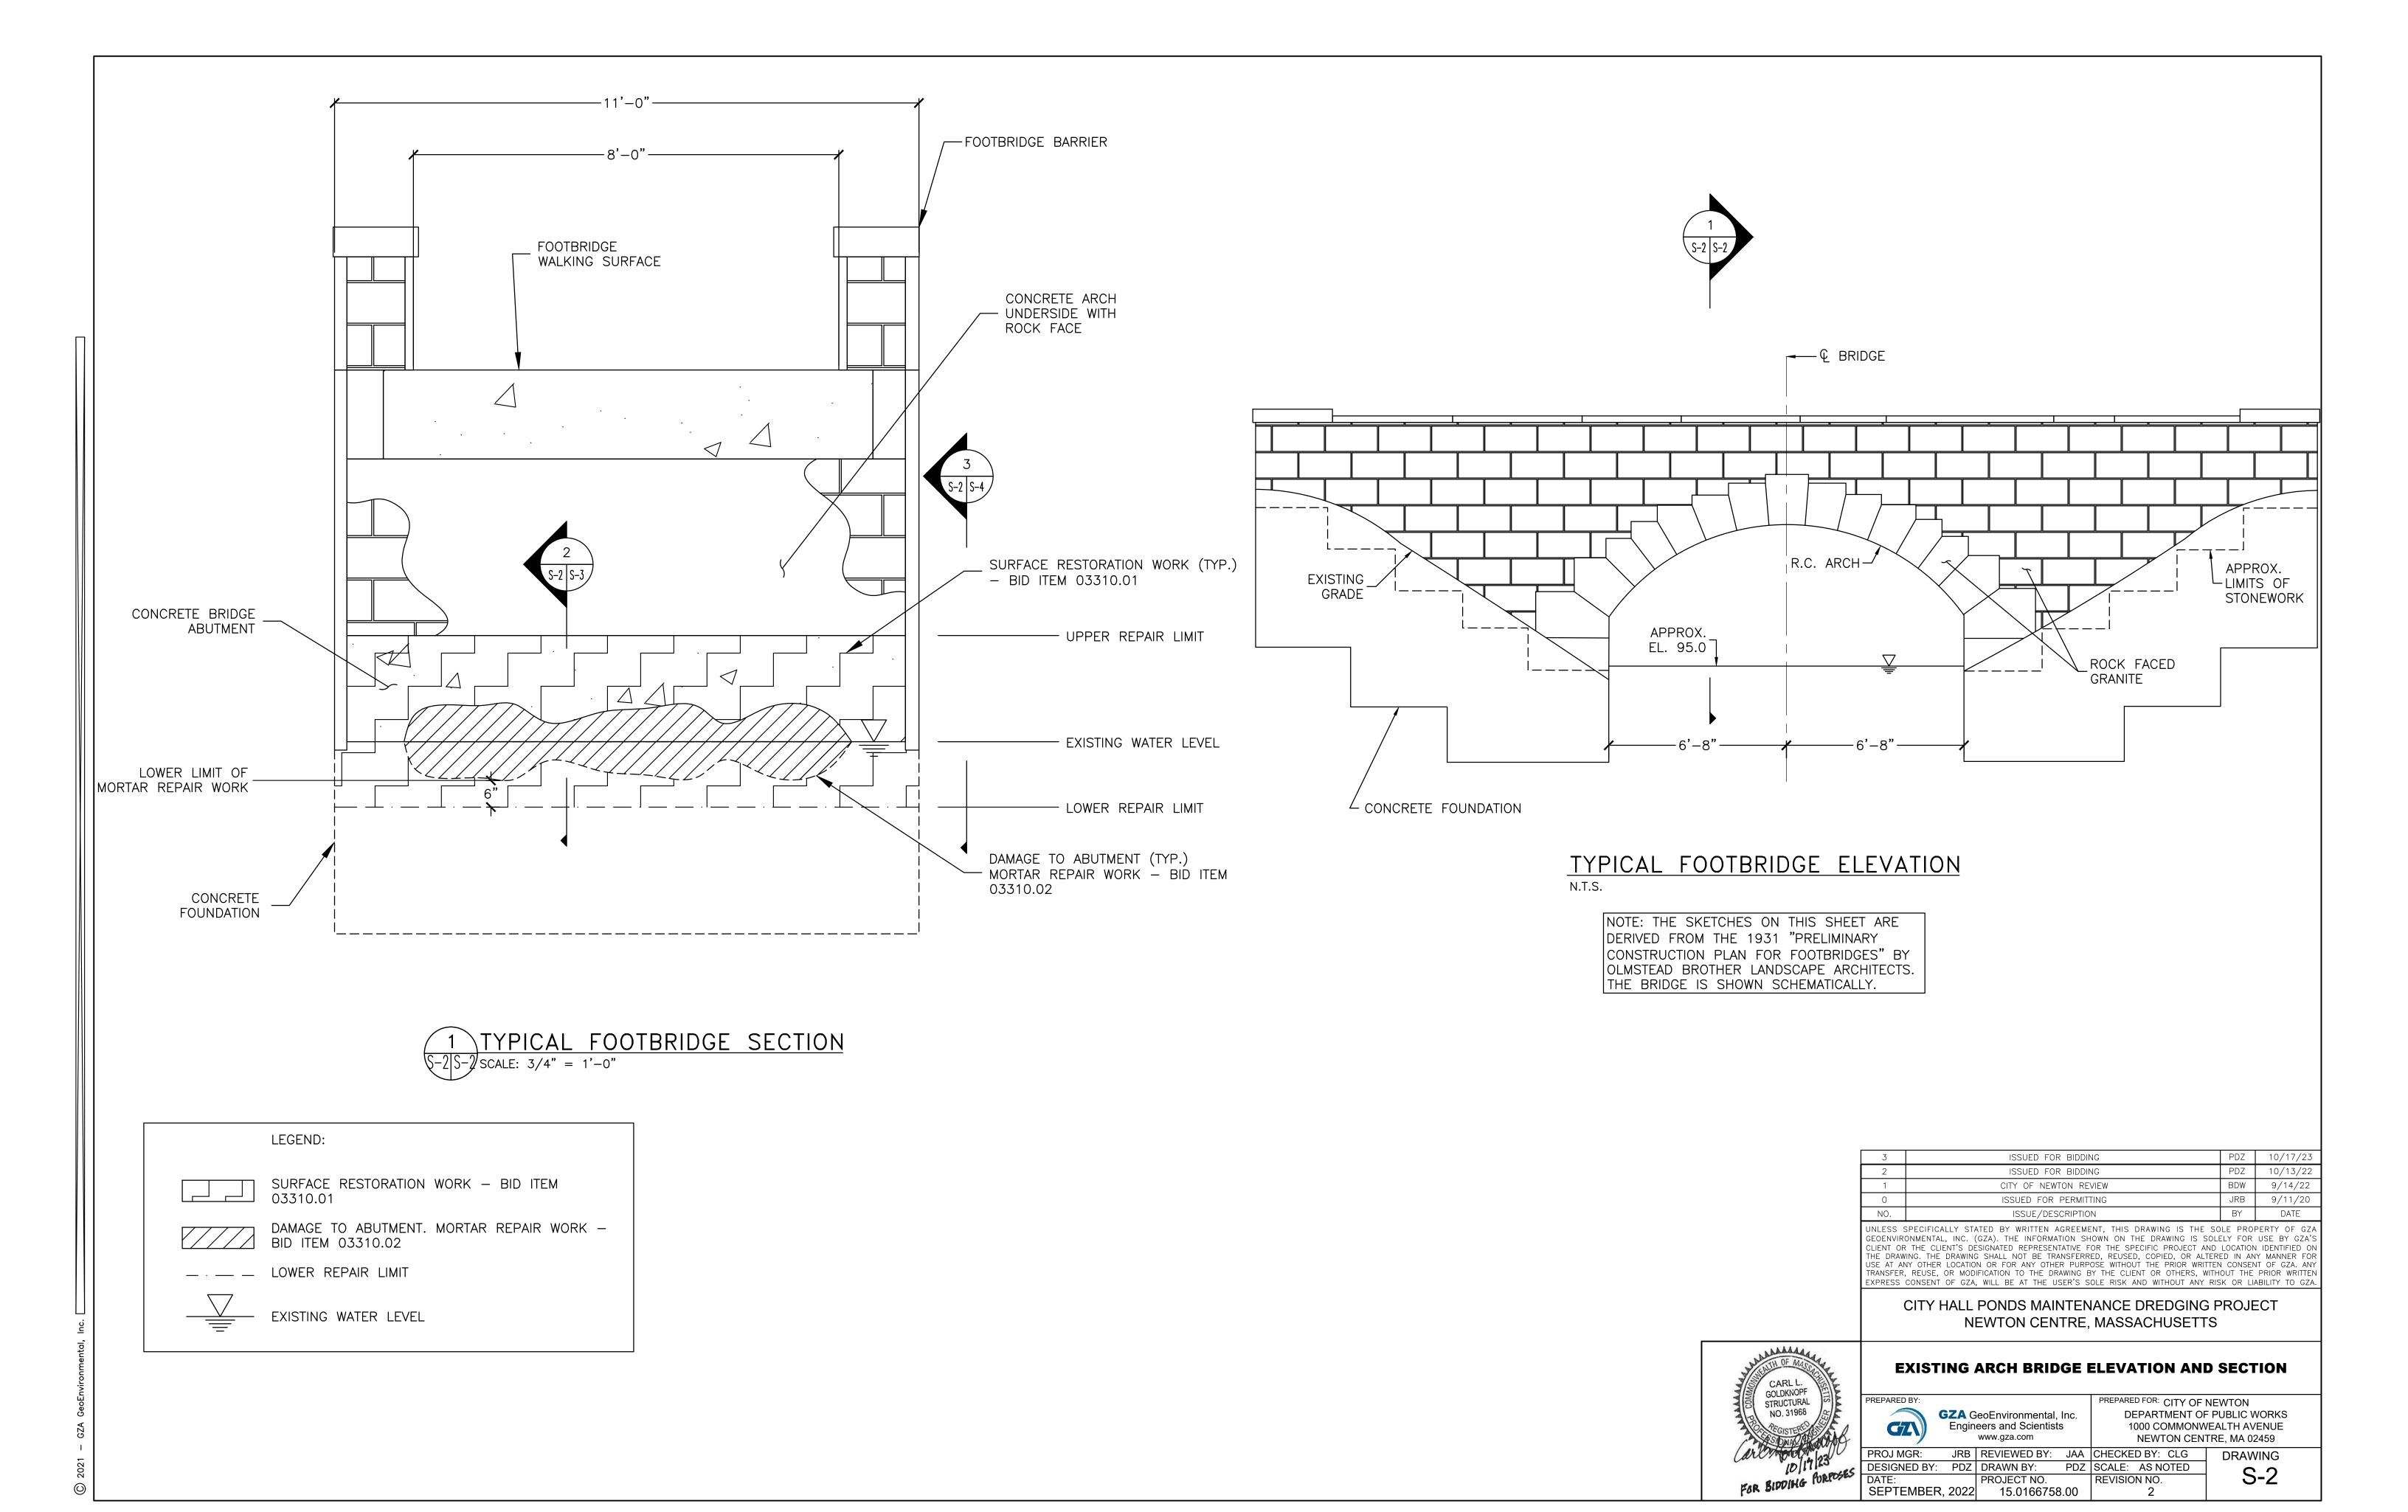

2A TYPICAL ABUTMENT REPAIR SECTION — STEP 1 & 2 S2 S3 N.T.S.

# STEP 1: PREPARATION


- LOWER WATER LEVEL BELOW THE DEPTH OF THE DETERIORATED CONCRETE TO BE REPAIRED.
- REMOVE ALL DETERIORATED CONCRETE, DIRT, OIL, GREASE, AND OTHER BOND-INHIBITING MATERIALS FROM THE AREA TO BE REPAIRED.
- PREPARATION WORK SHALL BE DONE BY HIGH PRESSURE WATER BLAST, SCABBLER OR OTHER
   APPROPRIATE MECHANICAL MEANS TO OBTAIN AN EXPOSED AGGREGATE SURFACE PROFILE OF ±1/16".
   TO ENSURE OPTIMUM REPAIR RESULTS, THE EFFECTIVENESS OF DECONTAMINATION AND
- PREPARATION SHOULD BE ASSESSED BY A PULL-OFF TEST.


   SAW CUTTING OF EDGES IS PREFERRED AND A DOVETAIL IS RECOMMENDED.
- SUBSTRATE SHOULD BE SATURATED SURFACE DRY (SSD) WITH CLEAN WATER PRIOR TO APPLICATION. NO STANDING WATER SHOULD REMAIN DURING APPLICATION.
- REPAIR AREA SHALL NOT BE LESS THAN 1 IN DEPTH.

# STEP 2: PRIMING

- REINFORCING STEEL: STEEL REINFORCEMENT SHOULD BE THOROUGHLY PREPARED BY MECHANICAL CLEANING TO REMOVE ALL TRACES OF RUST. WHERE CORROSION HAS OCCURRED DUE TO THE PRESENCE OF CHLORIDES, THE STEEL SHOULD BE HIGH PRESSURE WASHED WITH CLEAN WATER AFTER MECHANICAL CLEANING. FOR PRIMING OF REINFORCING STEEL USE SIKA ARMATEC 110 EPOCEM (OR APPROVED EQUIVALENT).
- CONCRETE SUBSTRATE:
- PRIME THE PREPARED SUBSTRATE WITH A BRUSH OR SPRAYED APPLIED COAT OF SIKA ARMATEC 110 EPOCEM (OR APPROVED EQUIVALENT)
- •• ALTERNATELY, A SCRUB COAT OF SIKATOP—123 PLUS (OR APPROVED EQUIVALENT) CAN BE APPLIED PRIOR TO PLACEMENT OF THE MORTAR. THE REPAIR MORTAR HAS TO BE APPLIED INTO THE WET SCRUB COAT BEFORE IT DRIES.

NOTE: THE TYPICAL CONCRETE ABUTMENT REPAIR PROCEDURE, AS OUTLINED BELOW, APPLIES ONLY TO THE USE OF SIKATOP—123 PLUS REPAIR MORTAR. EQUIVALENT REPAIR MORTAR MAY BE USED IF APPROVED BY THE ENGINEER RESPONSIBLE FOR THIS REPAIR PROCEDURE. NOTE THAT THE USE OF AN ALTERNATE MORTAR MATERIAL MAY ALTER THE INSTALLATION PROCEDURE.

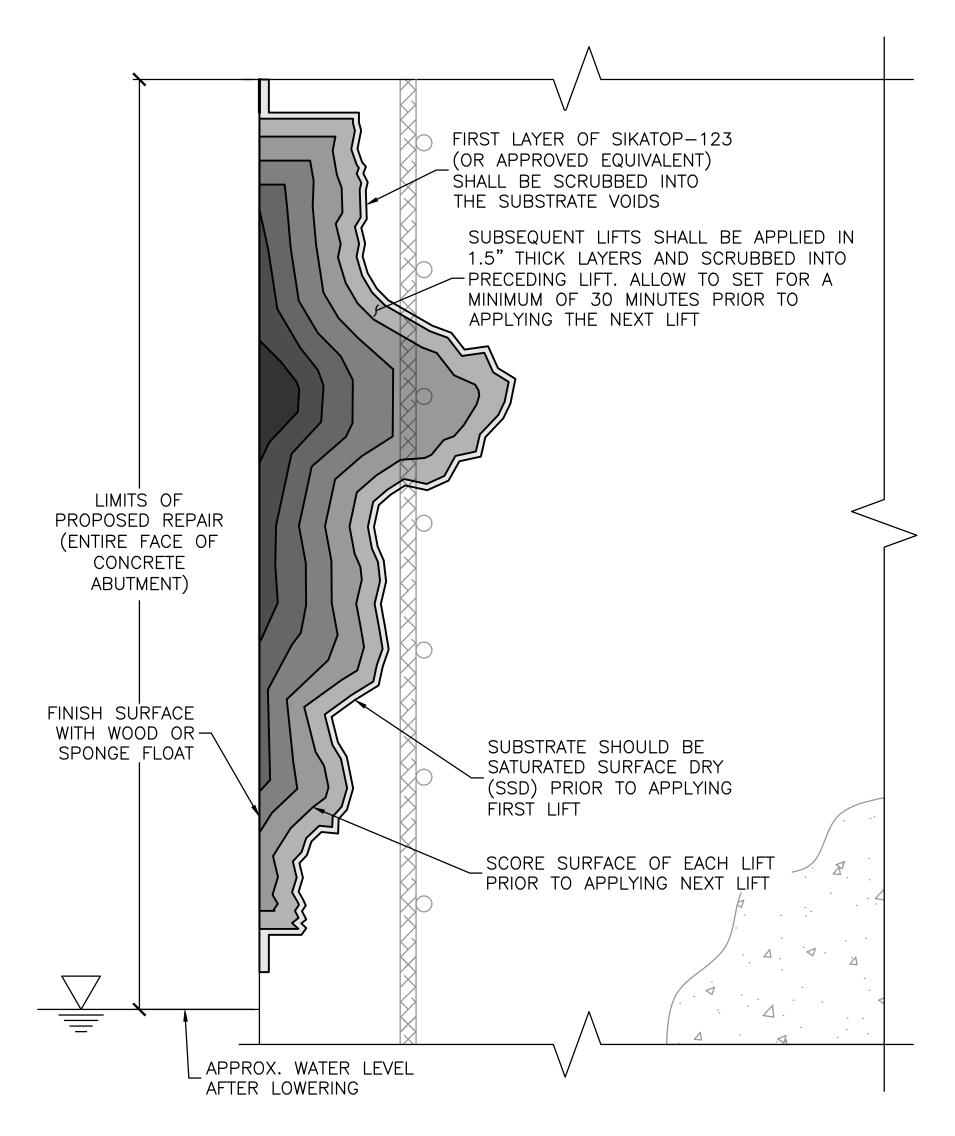

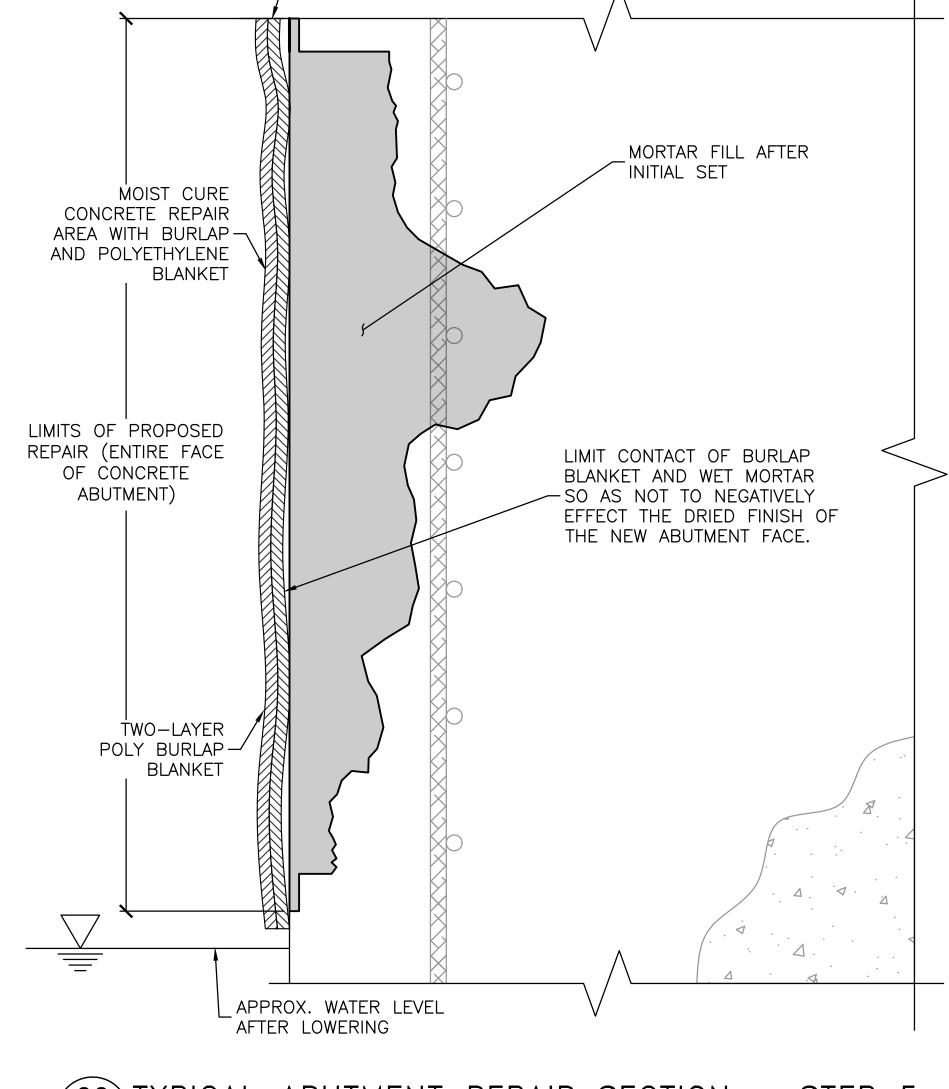

CONNECTION OF POLYETHYLENE BURLAP

TO ABUTMENT BY CONTRACTOR

# 2B TYPICAL ABUTMENT REPAIR SECTION - STEP 3 & 4 S2|S3| N.T.S.

# STEP 3: MIXING

• MIX THE SIKATOP-123 PLUS (OR APPROVED EQUIVALENT) COMPONENTS ACCORDING TO THE MANUFACTURER'S RECOMMENDATIONS.

# STEP 4: APPLICATION

- SIKATOP-123 PLUS (OR APPROVED EQUIVALENT) MUST BE SCRUBBED INTO THE SUBSTRATE, FILLING ALL PORES AND VOIDS.
- FORCE MATERIAL AGAINST THE EDGE OF REPAIR, WORKING TOWARD THE CENTER.
- AFTER FILLING REPAIR, CONSOLIDATE, THEN SCREED.
- WHERE MULTIPLE LIFTS ARE REQUIRED, SCORE TOP OF SURFACE OF EACH LIFT TO PRODUCE A ROUGHENED SURFACE FOR NEXT LIFT.
- ALLOW PRECEDING LIFT TO REACH INITIAL SET, 30 MINUTES MINIMUM, BEFORE APPLYING FRESH MATERIAL.
- SUBSTRATE SHOULD BE SATURATED SURFACE DRY (SSD) WITH CLEAN WATER PRIOR TO APPLICATION. NO STANDING WATER SHOULD REMAIN DURING APPLICATION.
- SCRUB FRESH MORTAR INTO PRECEDING LIFT.
- ALLOW MORTAR OR CONCRETE TO SET TO DESIRED STIFFNESS, THEN FINISH WITH WOOD OR SPONGE FLOAT FOR A SMOOTH SURFACE.

NOTE: SIKATOP-123 PLUS MUST BE APPLIED AT A MIN. AMBIENT AIR TEMPERATURE OF 45°F. TO ACHIEVE THIS CONDITION A HEATED ENCLOSURE MAY NEED TO BE PROVIDED TO REACH THE DESIRED TEMPERATURE.

# 2C TYPICAL ABUTMENT REPAIR SECTION — STEP 5 S2|S3 N.T.S.


# STEP 5: CURING

- AS PER ACI RECOMMENDATIONS FOR PORTLAND CEMENT CONCRETE, CURING IS REQUIRED
   MOIST CURE WITH WET BURLAP AND POLYETHYLENE, A FINE MIST OF WATER OR WATER
- BASED COMPATIBLE CURING COMPOUND (ASTM C-309).
   MOIST CURING SHOULD COMMENCE IMMEDIATELY AFTER FINISHING. PROTECT FRESHLY APPLIED MORTAR FROM DIRECT SUNLIGHT, WIND, WATER AND FROST.

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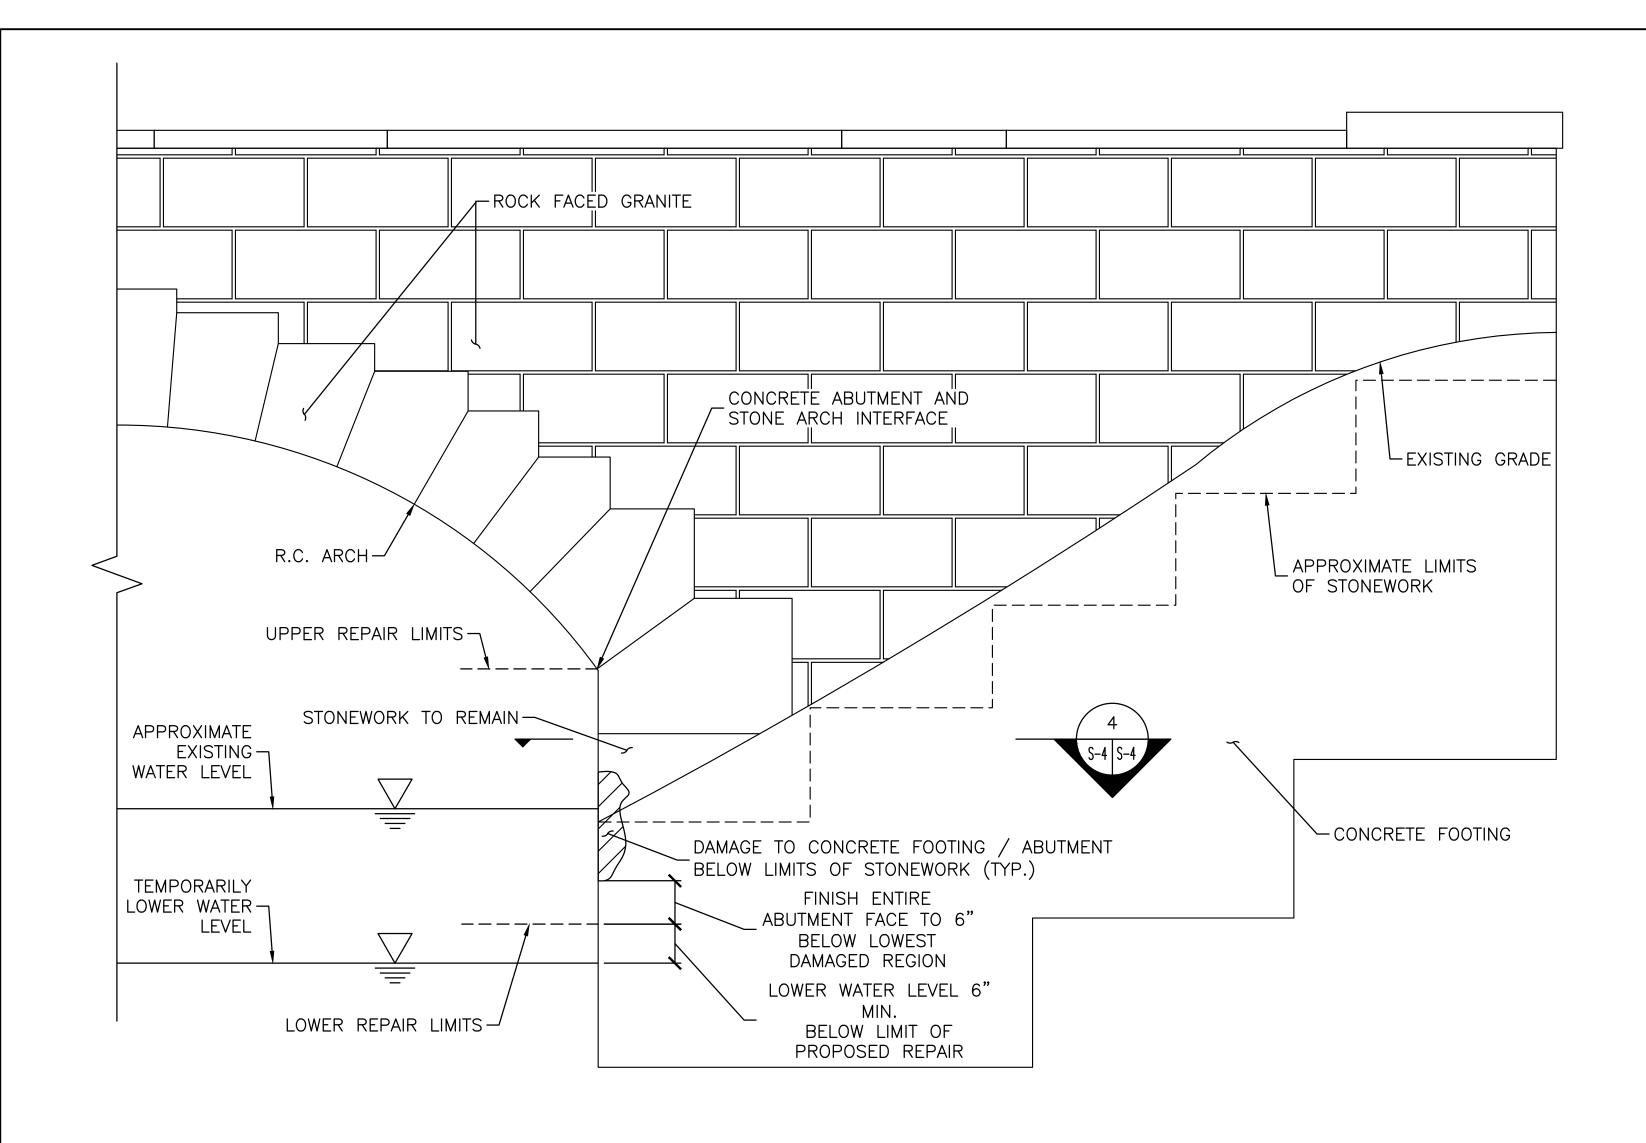
# **BRIDGE ABUTMENT REPAIR DETAILS**

GZA GeoEnvironmental, Inc.
Engineers and Scientists
www.gza.com

PREPARED FOR: CITY OF NEWTON
DEPARTMENT OF PUBLIC WORKS
1000 COMMONWEALTH AVENUE
NEWTON CENTRE, MA 02459
PROJ MGR:
JRB REVIEWED BY: JAA CHECKED BY: CLG DRAWING

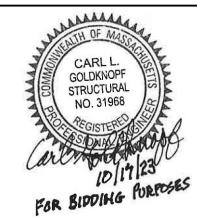DESIGNED BY: PDZ DRAWN BY: PDZ SCALE: AS NOTED
DATE: PROJECT NO. REVISION NO.
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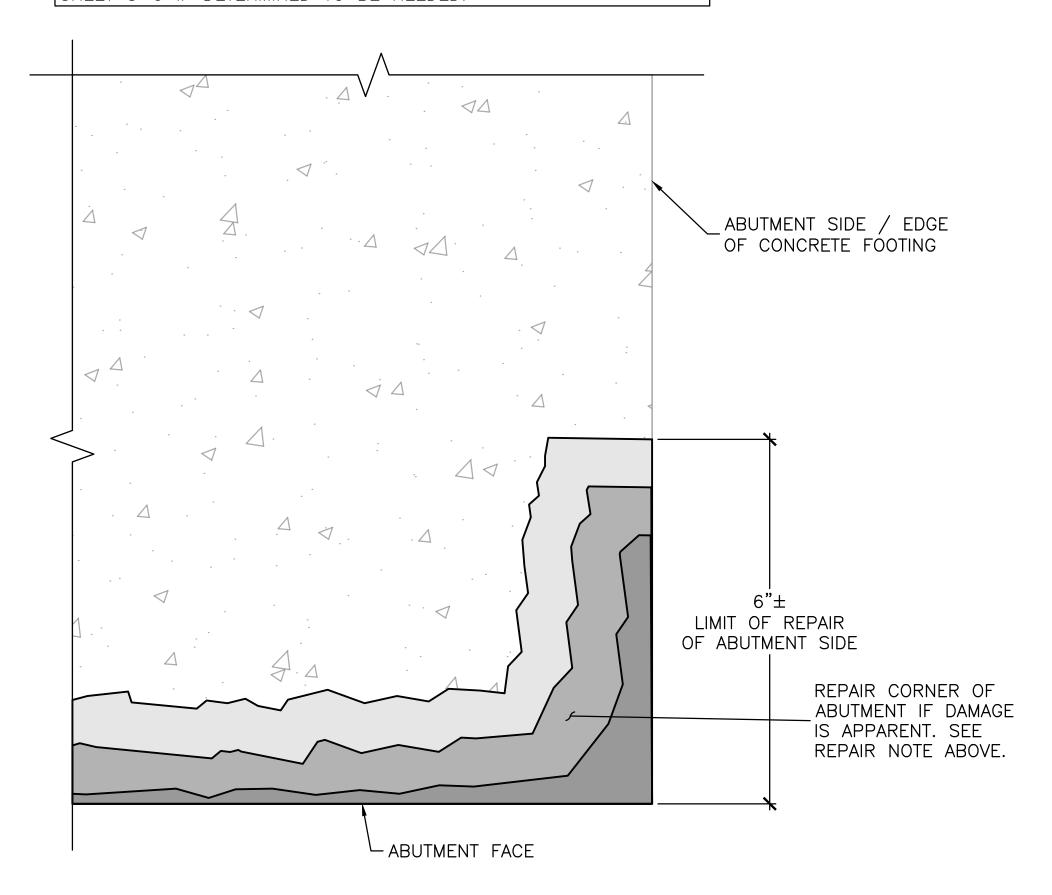
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TYPICAL ABUTMENT / FOOTING REPAIR ELEVATION
S2|S4) N.T.S.

#### REPAIR NOTES:

IN ADDITION TO THE DAMAGE TO THE ABUTMENT FACE, THERE MAY BE DAMAGE TO THE CORNER AND SIDE OF THE ABUTMENT OR THE CONCRETE FOOTING BELOW THE LIMITS OF STONEWORK, AS SHOWN IN THIS PLAN VIEW. ONCE THE WATER LEVEL HAS BEEN DROPPED TO THE APPROPRIATE LEVEL, GZA WILL DETERMINE REPAIR EXTENT OF CORNER AND SIDE OF ABUTMENT. THESE AREAS SHALL BE REPAIRED USING SIKATOP—123 PLUS REPAIR MORTAR (OR APPROVED EQUIVALENT) FOLLOWING A SIMILAR PROCEDURE TO THAT SHOWN ON SHEET S—3 IF DETERMINED TO BE NEEDED.




4 TYPICAL ABUTMENT / FOOTING CORNER REPAIR S-4 S-4 N.T.S.

3	ISSUED FOR BIDDING	PDZ	10/17/23
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CITY HALL PONDS MAINTENANCE DREDGING PROJECT NEWTON CENTRE, MASSACHUSETTS



# ARCH BRIDGE ABUTMENT / FOOTING REPAIR ELEVATION
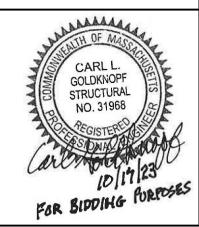
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	<b>GZA</b> GeoEnvironmental, Inc. Engineers and Scientists		DEPARTMENT OF PUBLIC WORKS		
GZ\)			1000 COMMONWEALTH AVENUE		
		www.gza.com		NEWTON CEN	TRE, MA 02459
ROJ MGR:	JRB	REVIEWED BY:	JAA	CHECKED BY: CLG	DRAWING

PROJ MGR: JRB REVIEWED BY: JAA CHECKED BY: CLG
DESIGNED BY: PDZ DRAWN BY: PDZ SCALE: AS NOTED

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DRAWING S-4

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