

CITY OF NEWTON, MASSACHUSETTS

**BURR ELEMENTARY SCHOOL  
FIELD IMPROVEMENTS**



**MAYOR**

RUTHANNE FULLER  
CITY OF NEWTON, MASSACHUSETTS

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NICOLE BANKS  
PARKS, RECREATION AND CULTURE DEPARTMENT

**DIRECTOR OF PARKS & OPEN SPACE**

LUIS PEREZ DEMORIZI  
PARKS, RECREATION AND CULTURE DEPARTMENT



BURR ELEMENTARY SCHOOL  
171 PINE STREET  
NEWTON, MA



APPROXIMATE PROJECT LIMITS

**SHEET INDEX**

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ISSUED FOR BID

MAY 2024

LOCATION PLAN  
NTS



**BOSTON, MASSACHUSETTS**

*Water*

*Environment*

*Transportation*

*Energy*

*Facilities*



**SURVEY NOTES**

1. SURVEY WAS PREPARED BY DAWOOD, 325 WOOD ROAD, SUITE 109, BRAINTREE, MA 02184, ON MAY 6, 2022.

2. COORDINATES, IN U.S. SURVEY FEET, ARE REFERENCED TO THE NORTH AMERICAN DATUM OF 1983, (2011), Epoch 2010.00, BASED ON THE KeyNet GPS VIRTUAL REFERENCE SYSTEM (VRS).

3. ELEVATIONS, IN U.S. SURVEY FEET, ARE REFERENCED TO THE ON NORTH AMERICAN DATUM OF 1988 (NAVD 88) BASED ON THE KeyNet GPS VIRTUAL REFERENCE SYSTEM (VRS) NETWORK.

4. SUBSURFACE UTILITY LINES AND FEATURES, AS SHOWN HEREON, WERE COMPILED FROM FIELD EVIDENCE AND/OR AVAILABLE RECORD INFORMATION (SEE REFERENCES), AND THEIR LOCATIONS ARE ONLY APPROXIMATE. ACTUAL LOCATIONS MUST BE DETERMINED IN THE FIELD.

DAWOOD ASSUMES NO RESPONSIBILITY FOR DAMAGES INCURRED AS A RESULT OF UTILITIES OMITTED OR INACCURATELY SHOWN.

BEFORE DESIGNING FUTURE CONNECTIONS, THE APPROPRIATE UTILITIES MUST BE CONSULTED.

BEFORE CONSTRUCTION, ALL UTILITIES, PUBLIC AND PRIVATE, MUST BE NOTIFIED (SEE MASSACHUSETTS GENERAL LAWS, CHAPTER 82 SECTION 40). CALL "DIG SAFE" 1-888-DIG-SAFE. (888-344-7233).

5. PROPERTY LINES SHOWN ARE FROM THE CITY OF NEWTON ASSESSOR'S GIS DATA AND ARE APPROXIMATE ONLY.

**SITE/CIVIL ABBREVIATIONS:**

SYMBOL	DESCRIPTION
TC	TOP OF CURB
BC	BOTTOM OF CURB
BW	BOTTOM OF WALL
TW	TOP OF WALL
CB	CATCH BASIN
CLF	CHAIN LINK FENCE
CS	CRUSHED STONE
D-PVC	POLYVINYL CHLORIDE DRAIN
DMH	DRAIN MANHOLE
FES	FLARED END SECTION
MH	MANHOLE
TS	TOP OF STEP/SLAB
BS	BOTTOM OF STEP
RCP	REINFORCED CONCRETE PIPE
MJ	MECHANICAL JOINT
DI	DUCTILE IRON
FFE	FINISHED FLOOR ELEVATION
DN	DOWN
VGC	VERTICAL GRANITE CURB
UP	UTILITY POLE
PVC	POLYVINYL CHLORIDE
INV. EL.	INVERT ELEVATION
S	SLOPE
GV	GATE VALVE
EFF	EFFLUENT
PT	PRESSURE TREATED

**GENERAL NOTES:**

- CONTRACTOR SHALL BE RESPONSIBLE FOR SITE SECURITY THROUGHOUT THE DURATION OF THE CONTRACT AS DIRECTED BY THE ENGINEER OR OWNER TO CONTROL VEHICLE AND PEDESTRIAN ACCESS.
- CONTRACTOR SHALL COORDINATE WORK AND SITE ACCESS TIMES TO MINIMIZE CONFLICTS WITH SCHOOL. SEE SPECIFICATIONS.
- CONTRACTOR SHALL COMPLY WITH ALL ASPECTS OF 220 CMR 99.00 (DIG SAFE LAW) AND MASSACHUSETTS CHAPTER 82 SECTION 40. CONTRACTOR SHALL NOTIFY ALL UTILITY OWNERS IN WRITING AND CALL DIGSAFE AT "811", 72 HOURS PRIOR TO BEGINNING CONSTRUCTION ACTIVITIES.
- WATER, SEWER AND DRAINS ARE TO BE COORDINATED WITH DPW UTILITIES.
- CONTRACTOR SHALL INSTALL ALL REQUIRED EROSION AND SEDIMENTATION CONTROL MEASURES, PRIOR TO UNDERTAKING SITE DEMOLITION AND REMOVALS.
- CONTRACTOR SHALL IDENTIFY AND PROTECT ALL ON-SITE STRUCTURES IDENTIFIED ON THE DRAWINGS TO BE RETAINED AND PROTECTED THROUGHOUT THE DURATION OF THE CONTRACT.
- NO WORK SHALL OCCUR OUTSIDE THE LIMIT OF WORK WITHOUT PRIOR APPROVAL BY THE ENGINEER OR OWNER. DAMAGE TO ANY SITE FEATURES TO BE RETAINED SHALL BE REPAIRED BY THE CONTRACTOR AT NO ADDITIONAL COST TO THE OWNER IN A MANNER APPROVED BY THE ENGINEER AND OWNER.
- PRIOR TO START OF CONSTRUCTION, CONTRACTOR SHALL HAND EXCAVATE TEST PIT TO CONFIRM LOCATIONS OF ALL SUBSURFACE UTILITIES TO BE MAINTAINED IN AREA OF WORK. DAMAGE CAUSED BY CONTRACTOR'S OPERATIONS SHALL BE REPAIRED AT NO ADDITIONAL COST TO THE OWNER.
- CONTRACTOR SHALL INSTALL AND MAINTAIN A TEMPORARY 6-FT HIGH CHAIN LINK FENCE TO SECURE HIS/HER WORK FOR THE DURATION OF THE PROJECT. AT NO POINT DURING CONSTRUCTION OF THE PROJECT SHALL THE SITE BE LEFT ACCESSIBLE TO THE PUBLIC. KEYS/ COMBINATION FOR THE LOCK USED AT CONSTRUCTION GATES SHALL BE PROVIDED TO THE OWNER AND THE ENGINEER FOR EMERGENCY ACCESS AND PUBLIC SAFETY OFFICIALS IF REQUESTED.
- ALL AREAS WITHIN LIMIT OF WORK BUT OUTSIDE OF AREAS SPECIFICALLY CALLED OUT FOR REMOVAL AND DISPOSAL, SHALL BE COORDINATED WITH OTHER SHEETS FOR LIMITS OF DISTURBANCE REMOVE AND DISPOSE OF SOIL AND OTHER EXISTING FEATURES TO DEPTHS AS REQUIRED FOR CONSTRUCTION. REMOVE AND DISPOSE OF SOIL AND OTHER EXISTING FEATURES TO DEPTHS AS REQUIRED FOR CONSTRUCTION.
- THE CONTRACTOR SHALL PREPARE AN EROSION AND SEDIMENT CONTROL PLAN AND STORMWATER POLLUTION PREVENTION PLAN (SWPPP) AS SPECIFIED TO PROTECT THE SITES FROM EROSION AND PREVENT THE MOVEMENT OF SEDIMENT AND DEBRIS.
- STRIP EXISTING VEGETATION AND 6" LAYER TOPSOIL UNLESS OTHERWISE SHOWN TO BE PROTECTED WITHIN LIMIT OF DISTURBANCE. GRIND ANY STUMPS TO A MINIMUM OF ONE FOOT BELOW FINISH GRADE AND BACKFILL IN COMPACTED LAYERS AS SPECIFIED.
- FOR LAYOUT PURPOSES AND TO ESTABLISH THE COORDINATE SYSTEM SEE SURVEY NOTES.
- CONTRACTOR SHALL VERIFY ALL SURVEY INFORMATION.
- CONTRACTOR SHALL BE RESPONSIBLE TO IDENTIFY AND PROTECT ALL ON-SITE STRUCTURES AND VEGETATION TO BE RETAINED ON THE SITE THROUGHOUT THE CONSTRUCTION PROJECT.
- CONTRACTOR SHALL MAINTAIN VEHICULAR ACCESS AND ALL UTILITY SERVICES TO THE EXISTING TREATMENT PLANT AND ASSOCIATED FACILITIES THROUGHOUT THE DURATION OF THE CONTRACT, UNLESS OTHERWISE SPECIFIED.
- LOCATIONS OF BURIED UTILITIES, VAULTS AND CONCRETE PADS ARE APPROXIMATE ONLY. FINAL LOCATIONS SHALL BE DETERMINED IN THE FIELD AFTER STAKING BY THE CONTRACTOR BASED ON ACTUAL SITE CONDITIONS AS APPROVED BY THE ENGINEER.
- ALL DISTURBED AREAS NOT COVERED WITH PAVEMENT, PADS, CURB, MULCH, RIPRAP, PLANTINGS, CRUSHED STONE OR STRUCTURES SHALL RECEIVE 6" LAYER OF LOAM AND SEED AS SPECIFIED, UNLESS NOTED OTHERWISE.
- BUILDING DIMENSIONS ARE TO COLUMN LINE INTERSECTION OR OUTSIDE FACE OF WALL AS SHOWN ON THE DRAWINGS. DIMENSIONS TO CONCRETE PADS ARE TO EDGE OF PAD.
- ALL ITEMS TO BE REMOVED, UNLESS OTHERWISE INDICATED ON THE DRAWINGS, SHALL BE DISPOSED OFF SITE IN A LEGAL MANNER.
- ITEMS SLATED FOR RE-USE SHALL BE STORED IN A CLEAN, DRY PLACE, PRIOR TO RELOCATION ON SITE.

**EROSION AND SEDIMENTATION CONTROL NOTES:**

- THE CONTRACTOR SHALL PROVIDE SEDIMENTATION AND EROSION CONTROL SYSTEMS AS SHOWN ON THE DRAWINGS IN ADDITION TO WHATEVER OTHER MEASURES MAY BE NECESSARY TO PREVENT SEDIMENTATION DUE TO THEIR OPERATIONS FROM BEING TRANSPORTED TO DOWNSTREAM PIPES, CHANNELS, WETLANDS AND WATER COURSES.
- THE CONTRACTOR WILL BE RESPONSIBLE FOR MAINTAINING THE SEDIMENTATION AND EROSION CONTROL SYSTEMS FOR THE DURATION OF THE CONTRACT. THIS MAINTENANCE INCLUDES CLEANING AND/OR REPLACING SYSTEMS THAT HAVE BECOME CLOGGED AND ARE NO LONGER FUNCTIONAL AS DETERMINED BY THE ENGINEER.
- ALL WORK SHALL CONFORM TO MASSACHUSETTS D.E.P. GUIDELINES FOR EROSION AND SEDIMENTATION CONTROL, LATEST EDITION.
- SCHEDULES FOR GRADING, LOAMING AND SEEDING SHALL BE SUBMITTED TO THE ENGINEER FOR APPROVAL PRIOR TO START OF WORK.
- THE LOCATION OF STOCKPILED MATERIALS SHALL BE IN AREAS APPROVED BY THE ENGINEER. VERIFICATION OF THE PROPER LOCATION AND INSTALLATION OF THE SILTATION CONTROL DEVICES MUST BE MADE BY THE ENGINEER PRIOR TO COMMENCEMENT OF ANY SITE WORK.
- CONTRACTOR SHALL INSPECT AFTER EACH STORM EVENT AND REPAIR AS NECESSARY ALL EROSION CONTROL MEASURES TO INSURE INTEGRITY OF EROSION CONTROL PROGRAM. MAINTENANCE SHALL INCLUDE CLEANING AND/OR REPLACEMENT OF SYSTEMS THAT ARE NO LONGER FUNCTIONAL AS DETERMINED BY THE ENGINEER.
- CONTRACTOR SHALL BE RESPONSIBLE FOR REMOVAL AND SATISFACTORY DISPOSAL OF ALL TEMPORARY EROSION CONTROL STRUCTURES UPON COMPLETION OF ALL WORK AND SOIL STABILIZATION AS DIRECTED BY THE ENGINEER.
- DUE TO CONSTRUCTION ACTIVITIES, CONTRACTOR MAY BE REQUIRED TO ADJUST LOCATIONS AND ELEVATIONS OF EROSION AND SEDIMENTATION CONTROLS AS APPROVED BY THE ENGINEER.
- PERIMETER CONTROLS SHALL BE INSTALLED PRIOR TO EARTH MOVING OPERATIONS.
- TEMPORARY WATER DIVERSIONS (SWALES, BASINS, ETC) MUST BE USED AS NECESSARY UNTIL AREAS ARE STABILIZED.
- DRAINAGE SWALES SHALL BE INSTALLED EARLY ON IN THE CONSTRUCTION SEQUENCE (BEFORE ROUGH GRADING THE SITE).
- ALL DITCHES AND SWALES SHALL BE STABILIZED PRIOR TO DIRECTING RUNOFF TO THEM.
- ALL PAVED AREAS SHALL BE STABILIZED WITHIN 72 HOURS OF ACHIEVING FINAL GRADE.
- ALL CUT AND FILL SLOPES SHALL BE SEEDED/LOAMED WITHIN 72 HOURS OF ACHIEVING FINISHED GRADE.
- ALL EROSION CONTROLS SHALL BE INSPECTED WEEKLY AND AFTER EVERY HALF-INCH OF RAINFALL.
- THE SMALLEST PRACTICAL AREA SHALL BE DISTURBED DURING CONSTRUCTION, BUT IN NO CASE SHALL EXCEED 5 ACRES AT ANY ONE TIME BEFORE DISTURBED AREAS ARE STABILIZED.
- AN AREA SHALL BE CONSIDERED STABLE IF ONE OF THE FOLLOWING HAS OCCURRED:
  - BASE COURSE GRAVELS HAVE BEEN INSTALLED IN AREAS TO BE PAVED;
  - A MINIMUM OF 85 PERCENT VEGETATED GROWTH HAS BEEN ESTABLISHED;
  - A MINIMUM OF 3 INCHES OF NON-EROSIVE MATERIAL SUCH AS STONE OR RIPRAP HAS BEEN INSTALLED;
  - OR EROSION CONTROL BLANKETS HAVE BEEN PROPERLY INSTALLED.
- ALL AREAS SHALL BE STABILIZED WITHIN 45 DAYS OF INITIAL DISTURBANCE.
- CONTRACTOR SHALL PROVIDE TEMPORARY SEEDING AS SPECIFIED.
- ALL PROPOSED VEGETATED AREAS THAT DO NOT EXHIBIT A MINIMUM OF 85 PERCENT VEGETATIVE GROWTH BY OCTOBER 15, OR WHICH ARE DISTURBED AFTER OCTOBER 15, SHALL BE STABILIZED BY SEEDING AND INSTALLING EROSION CONTROL BLANKETS ON SLOPES GREATER THAN AND EQUAL TO 3H (HORIZONTAL) : 1V (VERTICAL); AND PLACING 3 TO 4 TONS OF MULCH PER ACRE, SECURED WITH ANCHORED NETTING, ELSEWHERE, THE INSTALLATION OF EROSION CONTROL BLANKETS OR MULCH AND NETTING SHALL NOT OCCUR OVER ACCUMULATED SNOW OR ON FROZEN GROUND AND SHALL BE COMPLETED IN ADVANCE OF THAW OR SPRING MELT EVENTS.
- ALL SWALES THAT DO NOT EXHIBIT A MINIMUM OF 85 PERCENT VEGETATED GROWTH BY OCTOBER 15, OR WHICH ARE DISTURBED AFTER OCTOBER 15, SHALL BE STABILIZED TEMPORARILY WITH STONE OR EROSION CONTROL BLANKETS APPROPRIATE FOR THE DESIGN FLOW CONDITIONS.
- CATCH BASIN FILTER TO BE APPLIED TO ALL NEW CATCH BASINS UNTIL THE COMPLETION OF CONSTRUCTION.

**PLANTING NOTES:**

- TRANSPLANTED TREES MAY BE PERFORMED BY ROOT BALL, CONTAINER, OR BAREROOT PER THE DIRECTION FROM THE NEWTON TREE WARDEN.

**SURVEY SYMBOLS**

	BUSH		LIGHTPOLE
	CATCHBASIN		LIGHTPOLE WITH CONCRETE BASE
	DRAIN MANHOLE		SEWER MANHOLE
	DECIDUOUS TREE		SIGN
	EVERGREEN TREE		x101.00 SPOT ELEVATION
	FOUND MONUMENT (TYPE)		TRAFFIC SIGNAL
	GAS GATE		TRAVERSE POINT
	GUARD POST		UTILITY POLE
	HANDICAPPED PARKING		WATER GATE
	HYDRANT		

**SURVEY LINEWORK**

	CHAIN LINK FENCE
	VINYL FENCE
	CURB WITH TOP AND BOTTOM ELEVATIONS
	MAJOR CONTOUR
	MINOR CONTOUR
	OVERHEAD STRUCTURE
	RETAINING WALL
	ROW FROM GIS
	TREELINE

**SURVEY ABBREVIATIONS**

BIT	BITUMINOUS	HH	HANDHOLE
CB	CATCHBASIN	MAG.	MAGNETIC
CC	CONCRETE CURB	MH	MANHOLE
CLF	CHAIN LINK FENCE	N	NORTHING
CRW	CONCRETE RETAINING WALL	N/F	NOW OR FORMERLY
DMH	DRAIN MANHOLE	PID	PARCEL IDENTIFICATION NUMBER
DWS	DETECTABLE WARNING SURFACE	PL	PLANTER
E	EASTING	R	RIM
ELEC.	ELECTRIC	SB	STONE BOUND
ELEV	ELEVATION	SMH	SEWER MANHOLE
EOP	EDGE OF PAVEMENT	STK	STOCKADE
EPLP	ESCUTCHEON PIN LEAD	SWLL	SINGLE WHITE LANE LINE
FND	FOUND	TRCAN	TRASH CAN
GC	GRANITE CURB	UP	UTILITY POLE
GP	GUARD POST	VNF	VINYL FENCE
HCP	HANDICAP	W/	WITH
		WG	WATER GATE

**GRADING NOTES:**

- CONTRACTOR IS RESPONSIBLE FOR CONFIRMING GRADES AND LOCATION OF UTILITIES. MAJOR DISCREPANCIES ARE TO BE BROUGHT TO THE ATTENTION OF THE ENGINEER.
- TO ESTABLISH PROPER GRADES, CONTRACTOR SHALL BE RESPONSIBLE FOR INSTALLATION AND MAINTENANCE OF GRADE STAKES. THE NUMBER AND LOCATION SHALL BE DETERMINED IN THE FIELD AND APPROVED BY THE ENGINEER.
- ALL AREAS DISTURBED BY CONTRACTOR'S OPERATIONS SHALL BE REPAIRED AT THE CONTRACTOR'S EXPENSE IN A MANNER APPROVED BY THE ENGINEER.
- PATHWAY'S MAXIMUM LONGITUDINAL SLOPE SHALL BE 5% AND MAXIMUM CROSS SLOPE SHALL BE 2%.

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DESIGNED BY: M. DODSON  
 DRAWN BY: M. CARLSON  
 SHEET CHK'D BY: S. LANDGREN  
 CROSS CHK'D BY: M. DODSON  
 APPROVED BY: M. DODSON  
 DATE: MAY 2024




CITY OF NEWTON, MASSACHUSETTS  
**BURR ELEMENTARY SCHOOL  
 FIELD IMPROVEMENTS**

**LEGEND, ABBREVIATIONS, AND NOTES**


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SHEET NO.  
**G-1**

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REV. NO.	DATE	DRWN	CHKD	REMARKS

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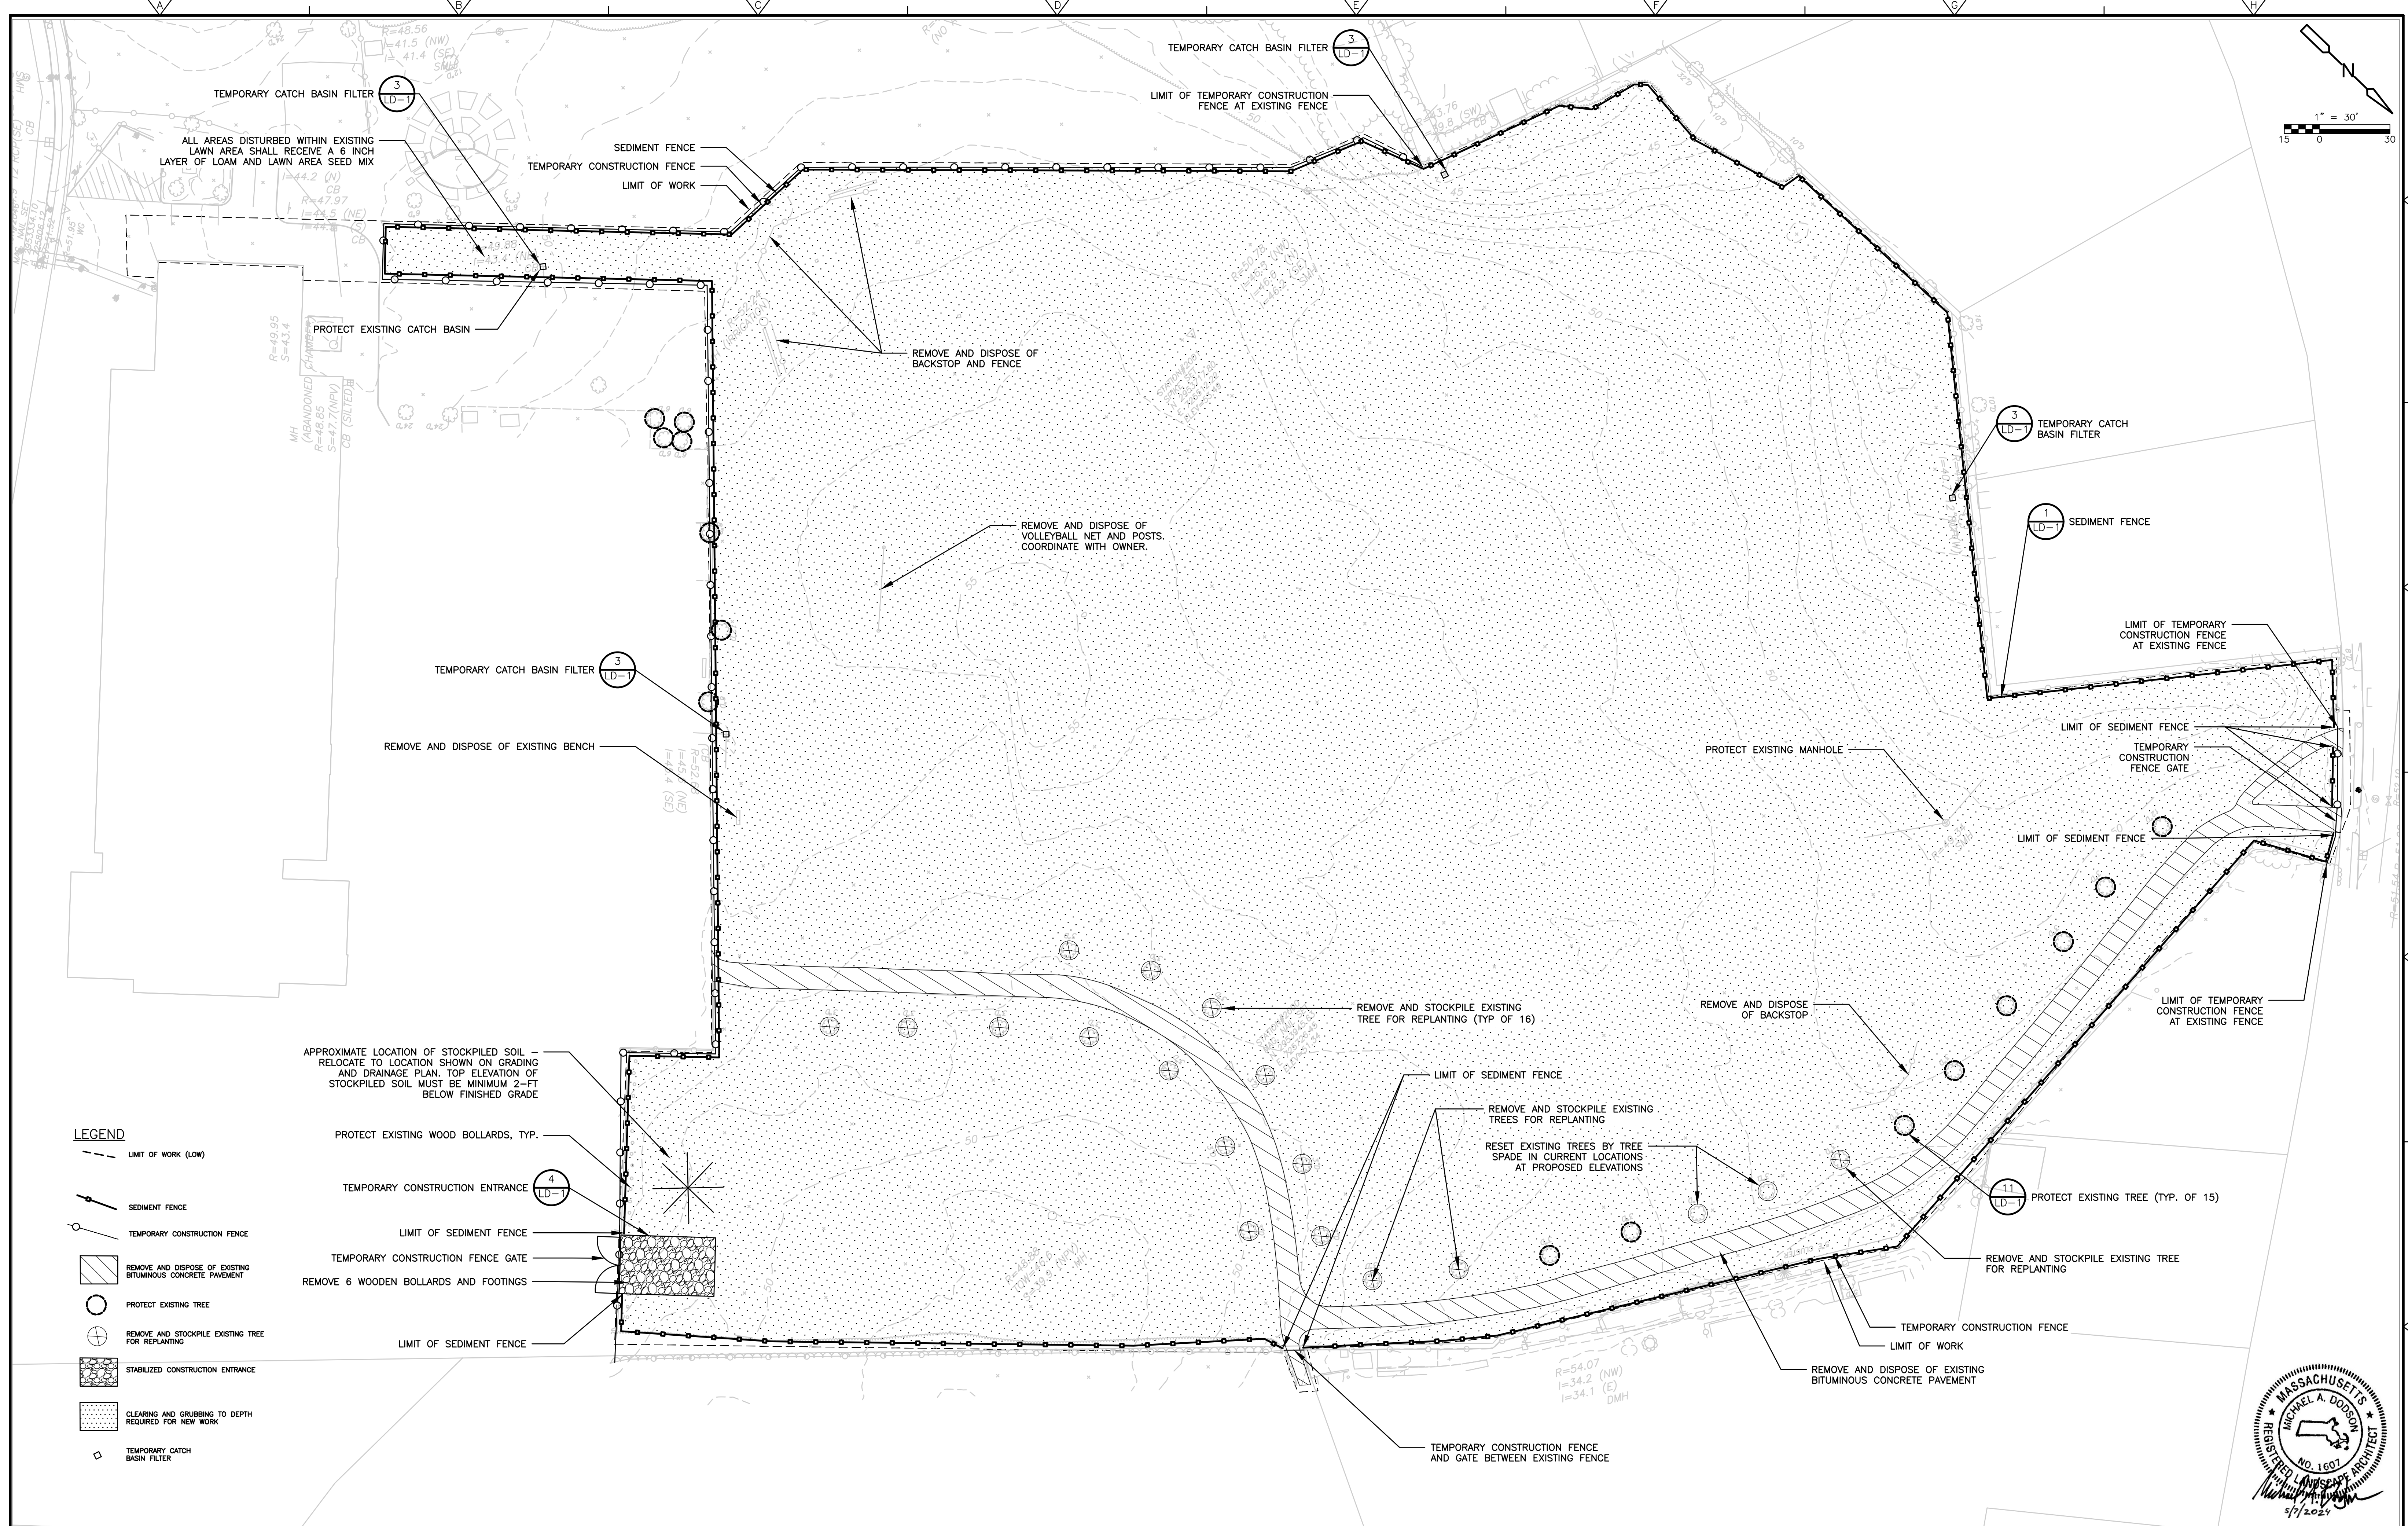
CITY OF NEWTON, MASSACHUSETTS  
**BURR ELEMENTARY SCHOOL**  
 FIELD IMPROVEMENTS

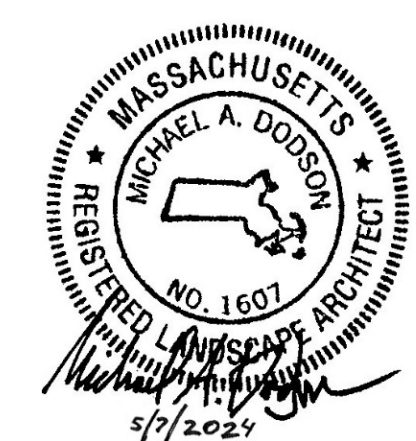EXISTING CONDITIONS PLAN

PROJECT NO. 0865-272529  
 FILE NAME: C0001EXPL  
 SHEET NO. EX-1  
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**LEGEND**

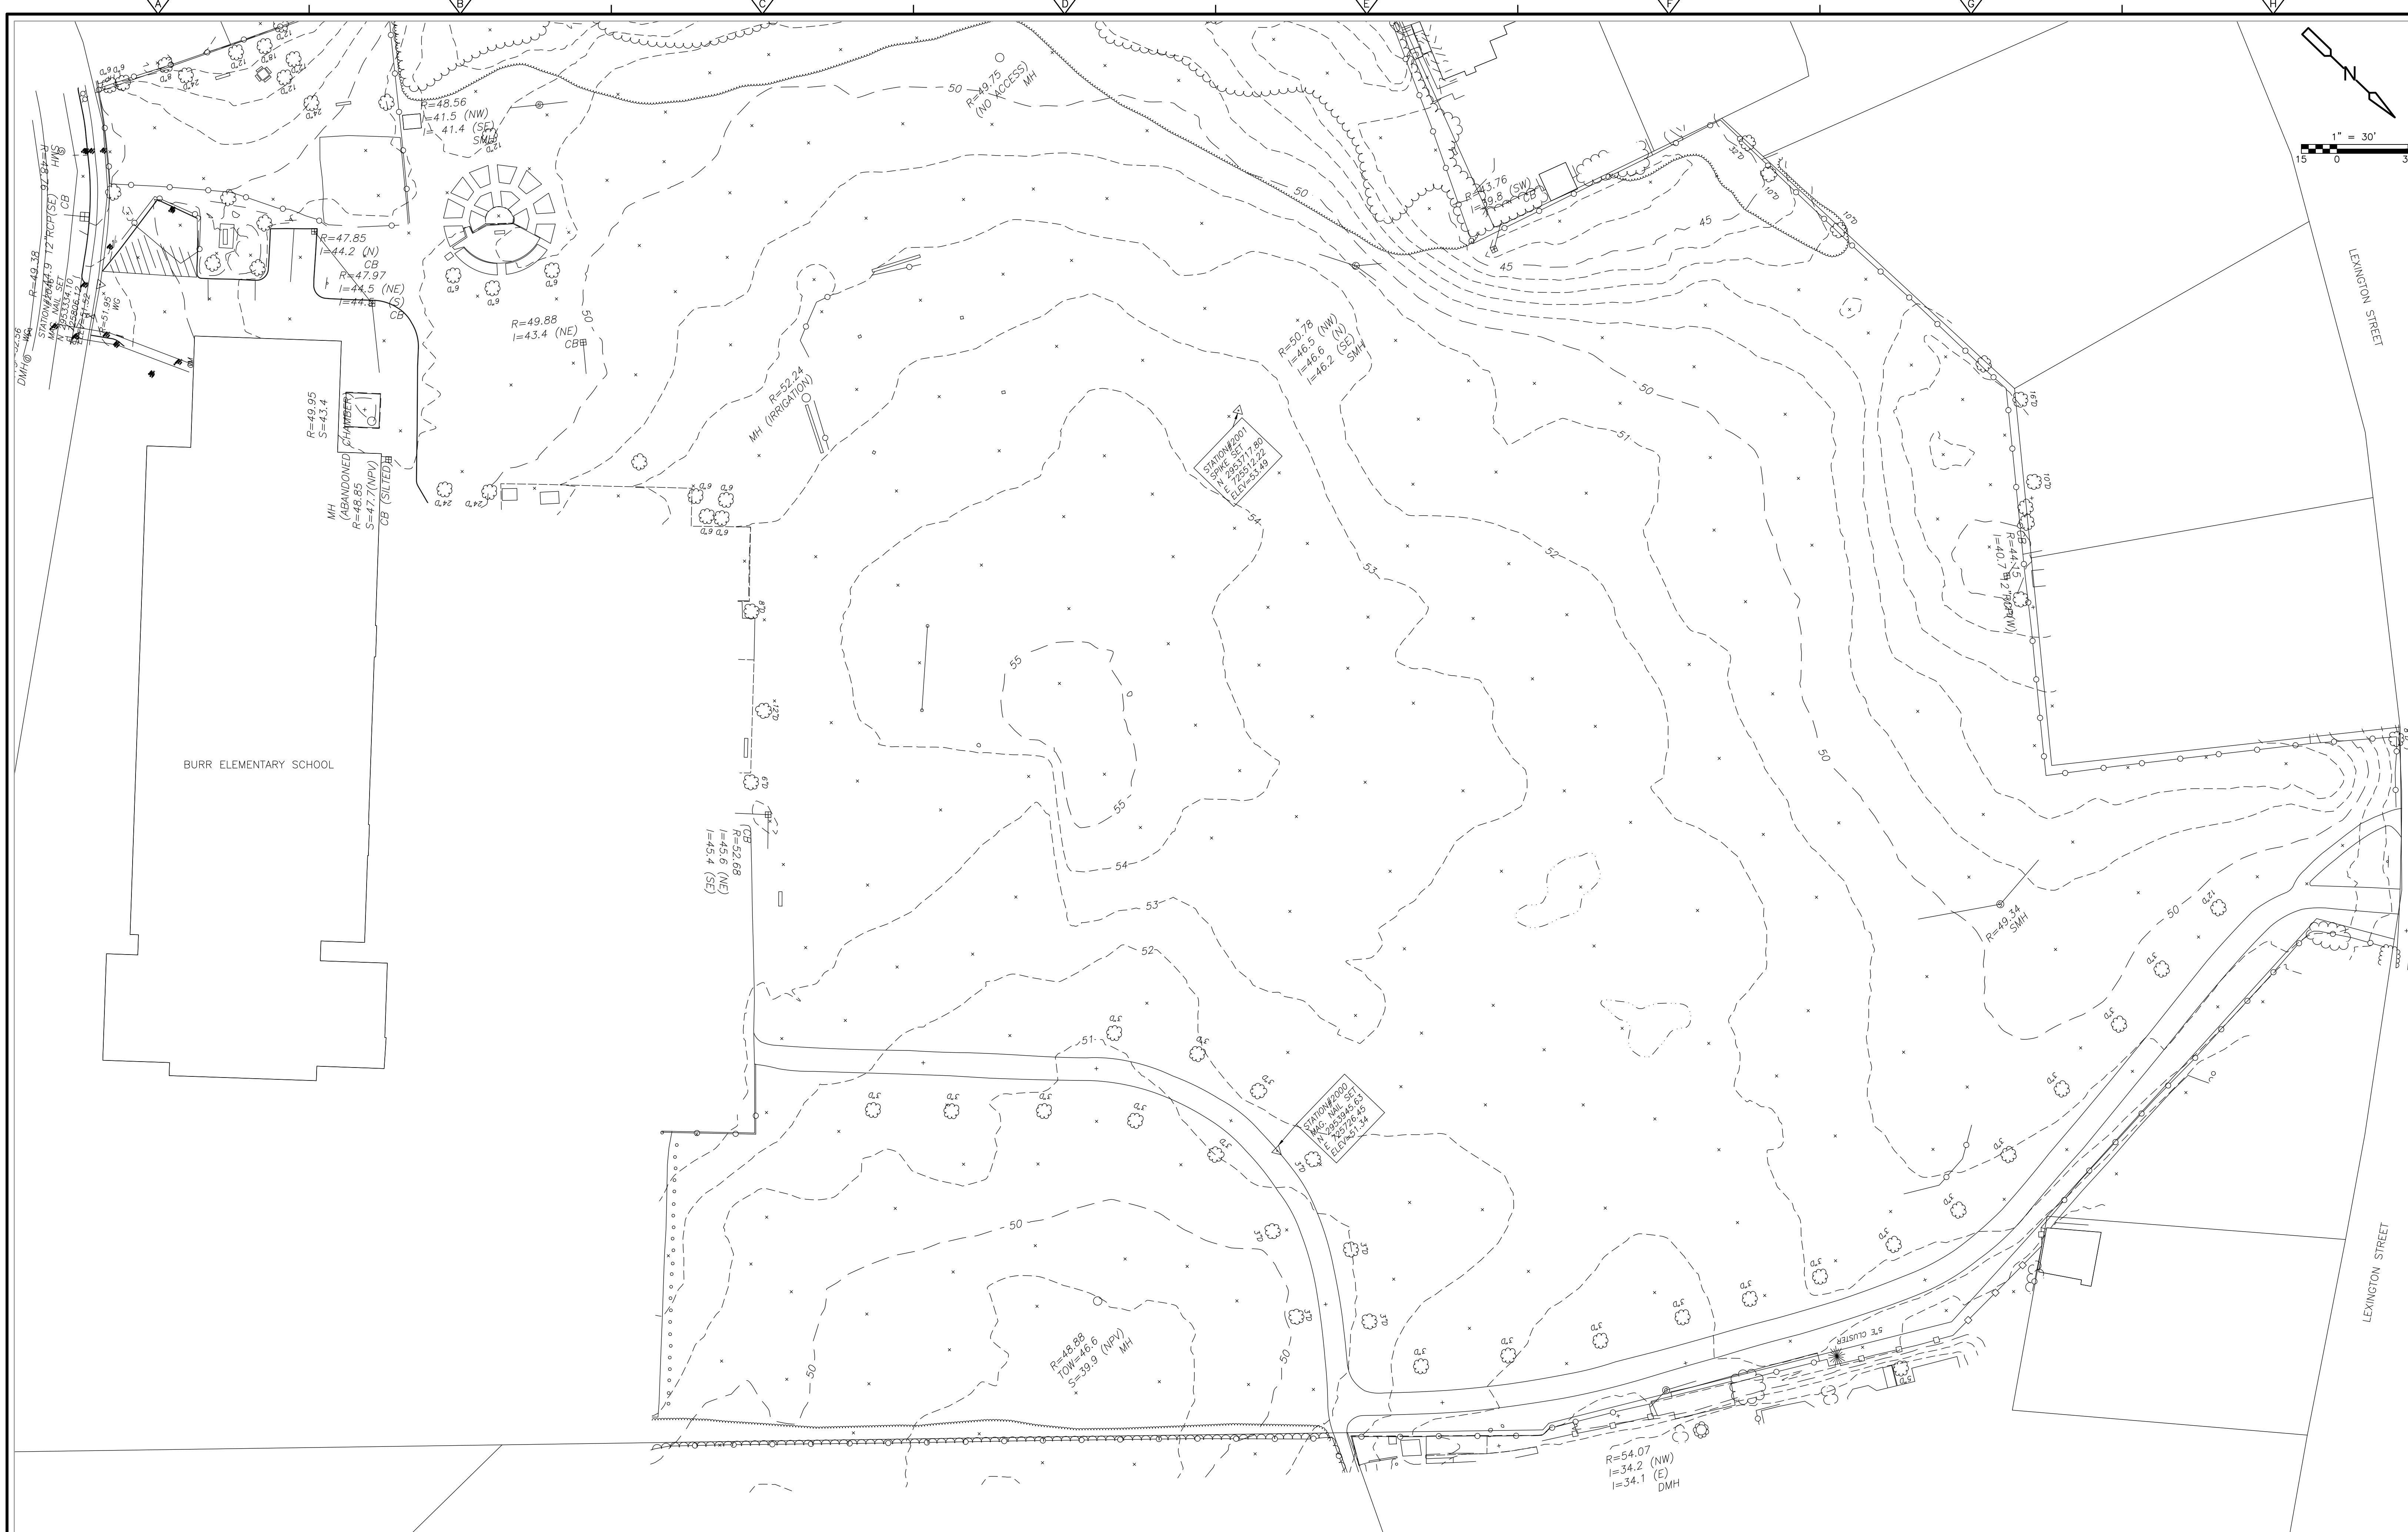- LIMIT OF WORK (LOW)
- SEDIMENT FENCE
- TEMPORARY CONSTRUCTION FENCE
- REMOVE AND DISPOSE OF EXISTING BITUMINOUS CONCRETE PAVEMENT
- PROTECT EXISTING TREE
- REMOVE AND STOCKPILE EXISTING TREE FOR REPLANTING
- STABILIZED CONSTRUCTION ENTRANCE
- CLEARING AND GRUBBING TO DEPTH REQUIRED FOR NEW WORK
- TEMPORARY CATCH BASIN FILTER

APPROXIMATE LOCATION OF STOCKPILED SOIL — RELOCATE TO LOCATION SHOWN ON GRADING AND DRAINAGE PLAN. TOP ELEVATION OF STOCKPILED SOIL MUST BE MINIMUM 2-FT BELOW FINISHED GRADE

- PROTECT EXISTING WOOD BOLLARDS, TYP.
- TEMPORARY CONSTRUCTION ENTRANCE
- LIMIT OF SEDIMENT FENCE
- TEMPORARY CONSTRUCTION FENCE GATE
- REMOVE 6 WOODEN BOLLARDS AND FOOTINGS
- LIMIT OF SEDIMENT FENCE

REV. NO.	DATE	DRWN	CHKD	REMARKS


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 DATE: MAY 2024

**CDM Smith**  
 75 State Street  
 Boston, MA 02109  
 Tel: (617) 452-6000

CITY OF NEWTON, MASSACHUSETTS  
**BURR ELEMENTARY SCHOOL  
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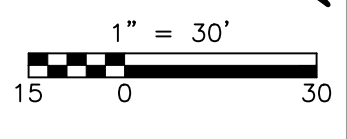
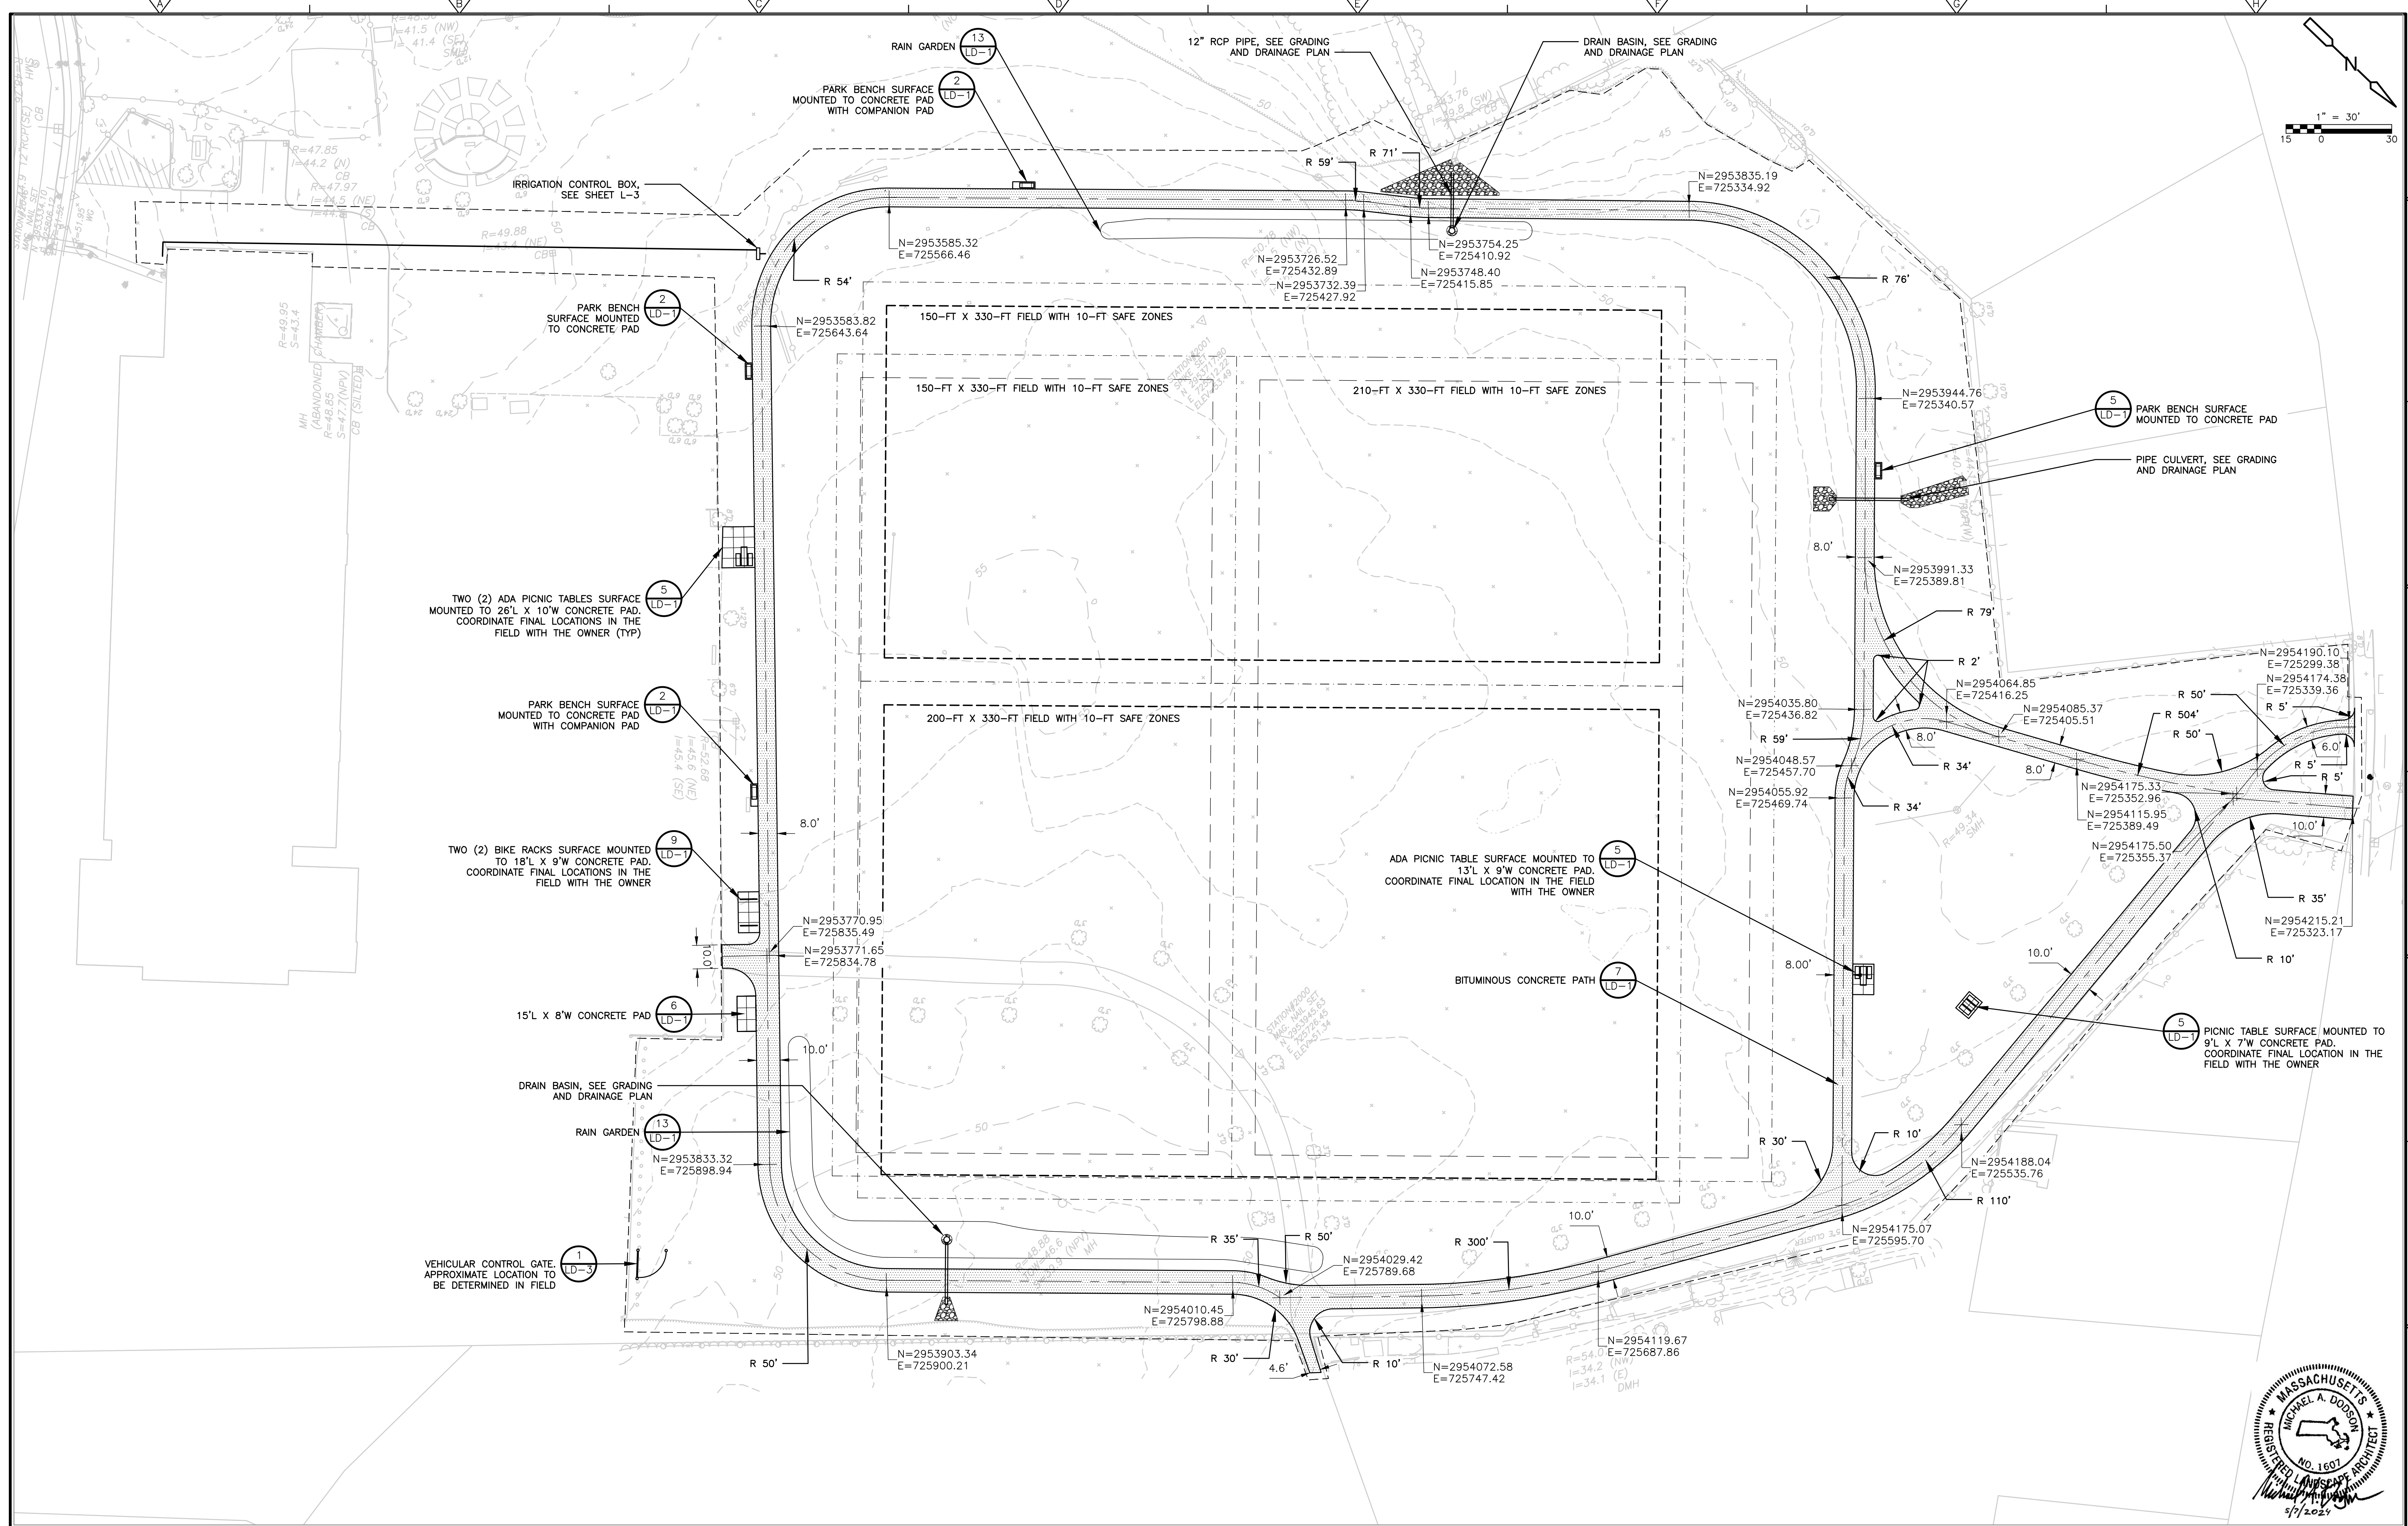
**DEMOLITION AND REMOVALS  
 AND SEDIMENTATION CONTROLS PLAN**

PROJECT NO. 0865-272529  
 FILE NAME: C0001DMPL  
 SHEET NO.  
**L-1**  
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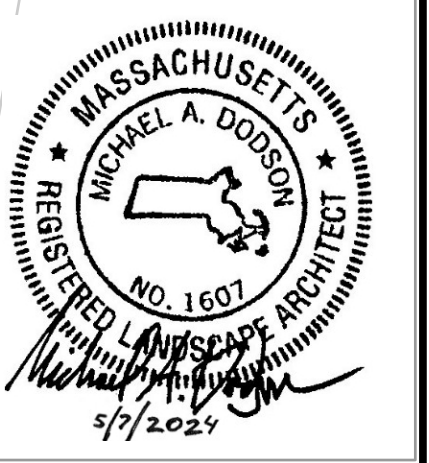
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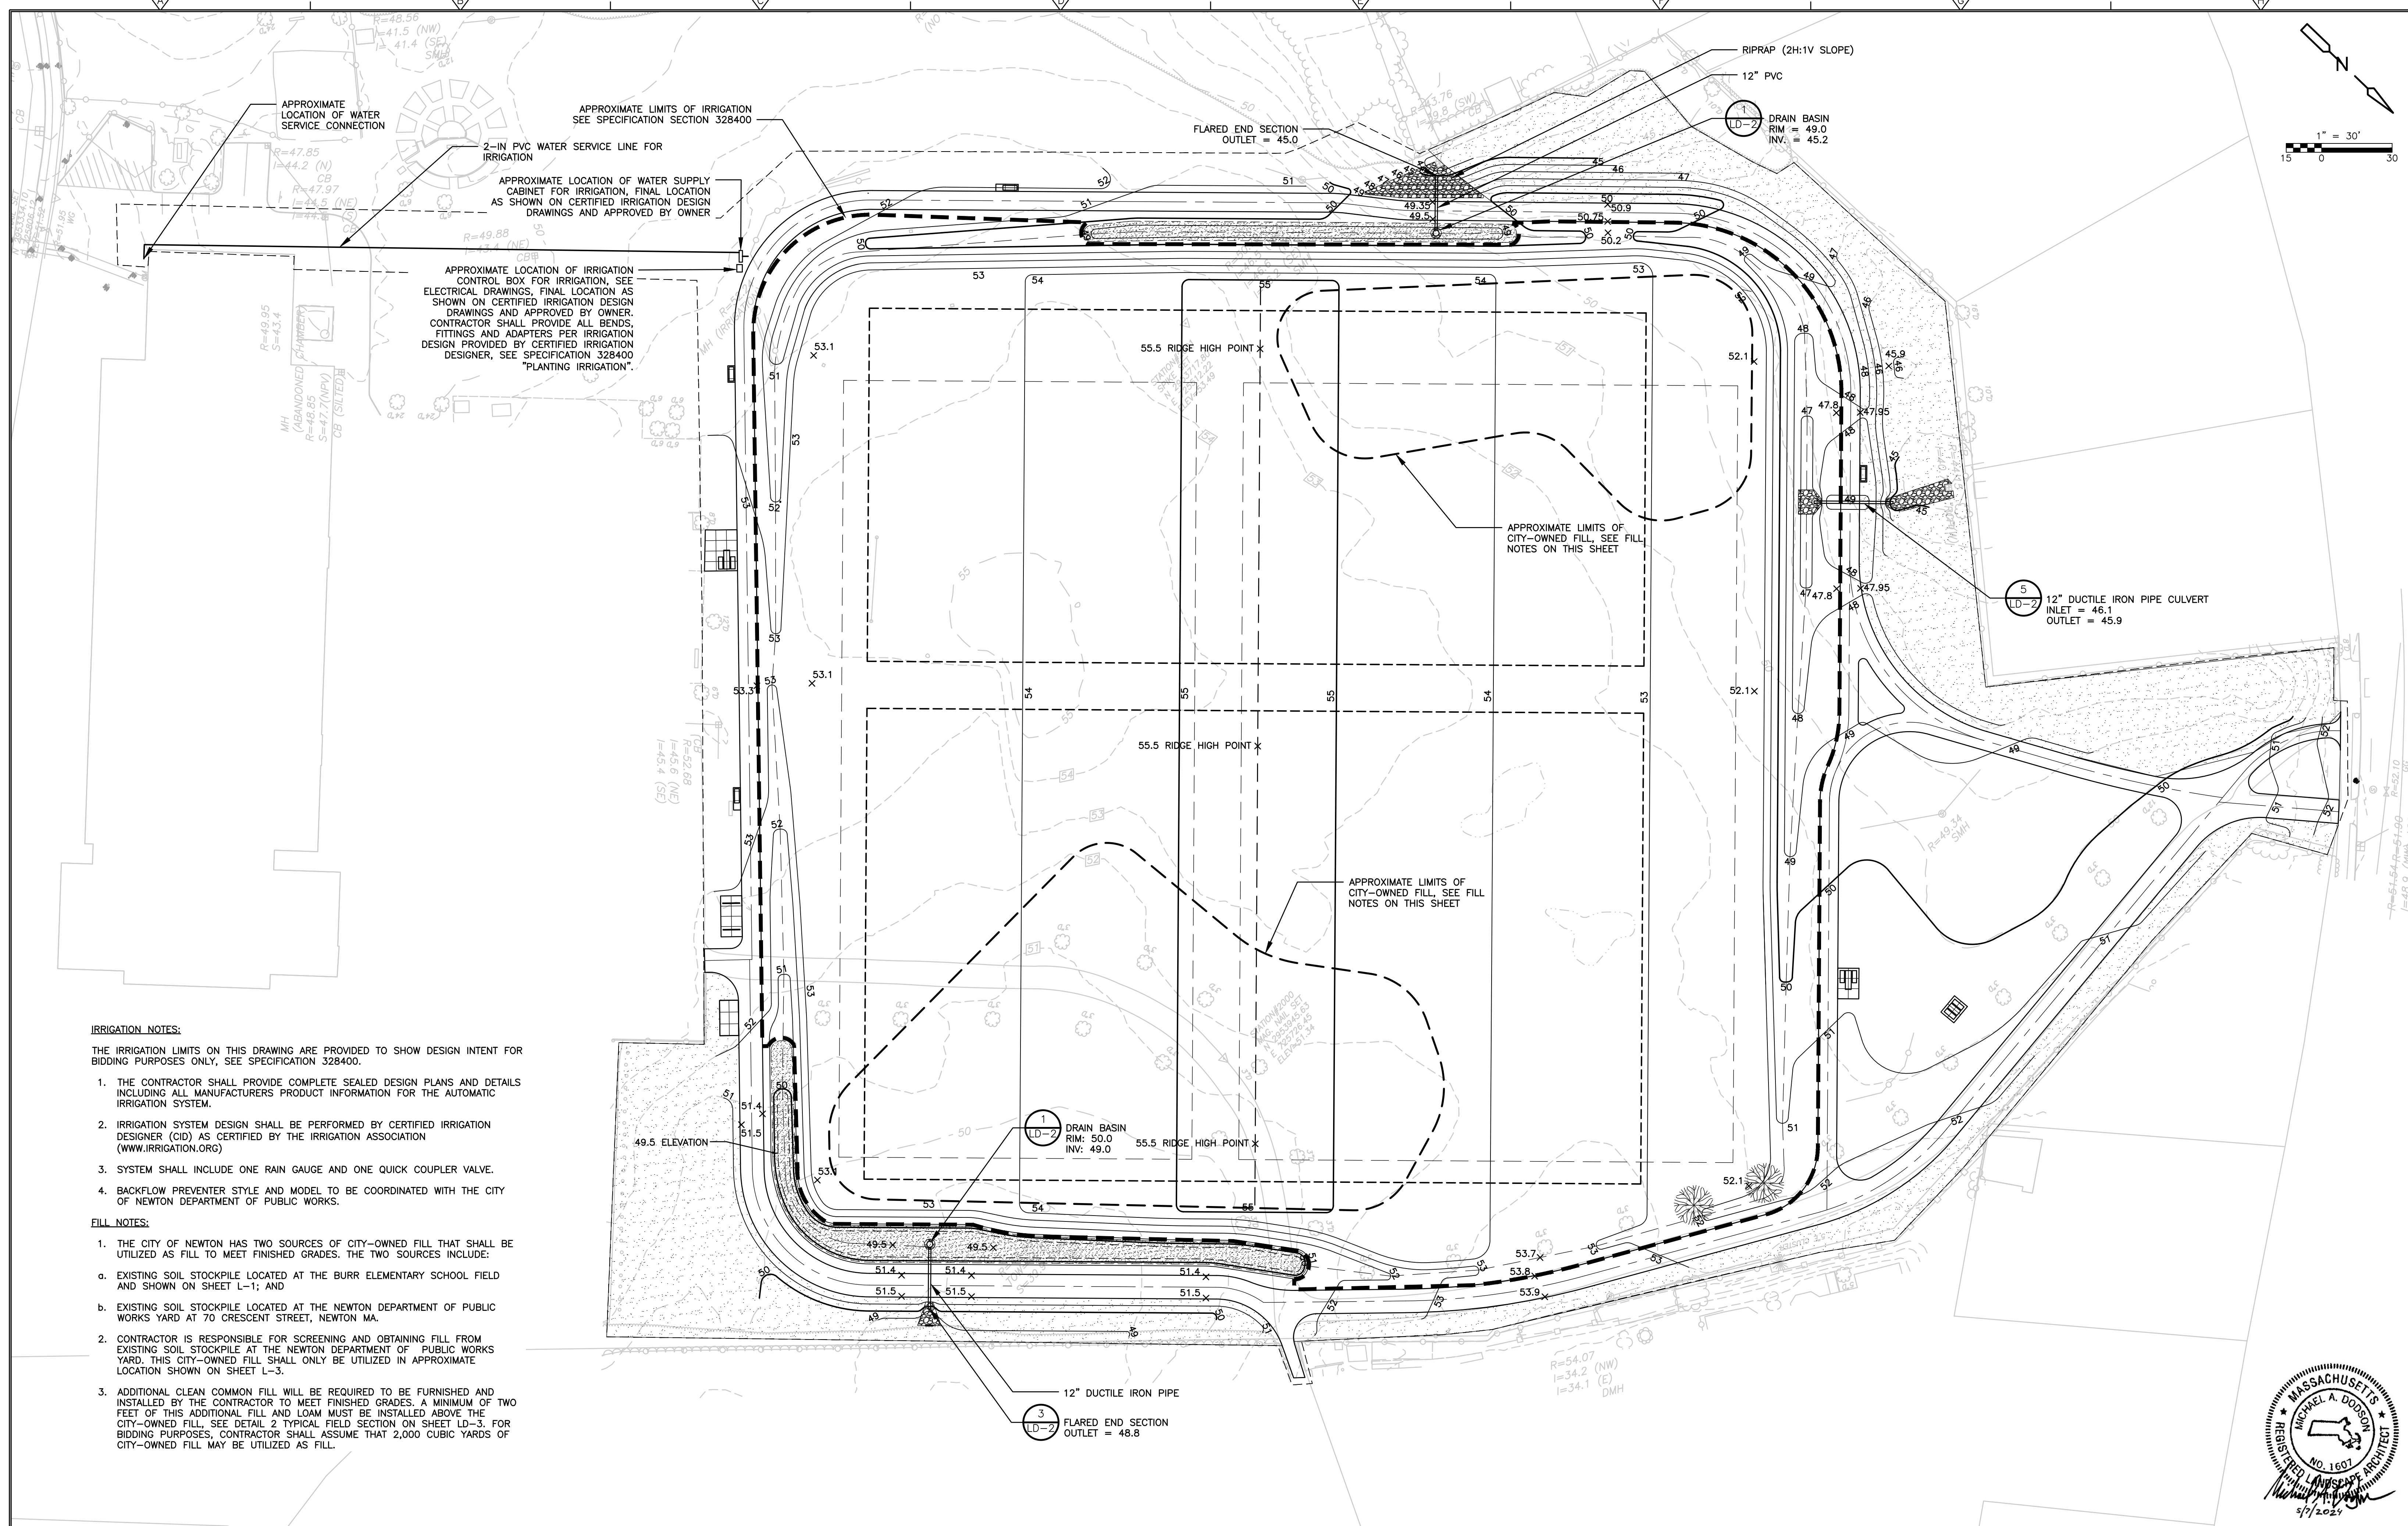
LAYOUT AND MATERIALS PLAN

PROJECT NO. 0865-272529  
 FILE NAME: C0003LMPL  
 SHEET NO. L-2  
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**IRRIGATION NOTES:**

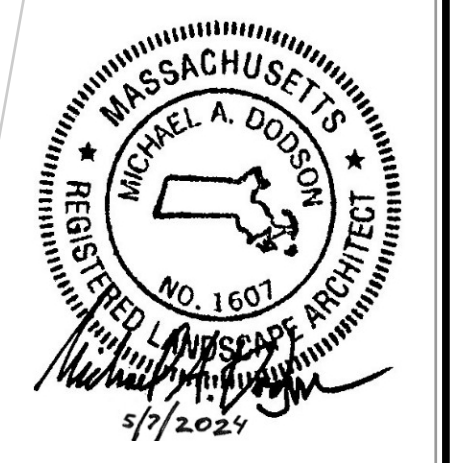THE IRRIGATION LIMITS ON THIS DRAWING ARE PROVIDED TO SHOW DESIGN INTENT FOR BIDDING PURPOSES ONLY, SEE SPECIFICATION 328400.

1. THE CONTRACTOR SHALL PROVIDE COMPLETE SEALED DESIGN PLANS AND DETAILS INCLUDING ALL MANUFACTURERS PRODUCT INFORMATION FOR THE AUTOMATIC IRRIGATION SYSTEM.
2. IRRIGATION SYSTEM DESIGN SHALL BE PERFORMED BY CERTIFIED IRRIGATION DESIGNER (CID) AS CERTIFIED BY THE IRRIGATION ASSOCIATION (WWW.IRRIGATION.ORG)
3. SYSTEM SHALL INCLUDE ONE RAIN GAUGE AND ONE QUICK COUPLER VALVE.
4. BACKFLOW PREVENTER STYLE AND MODEL TO BE COORDINATED WITH THE CITY OF NEWTON DEPARTMENT OF PUBLIC WORKS.

**FILL NOTES:**

1. THE CITY OF NEWTON HAS TWO SOURCES OF CITY-OWNED FILL THAT SHALL BE UTILIZED AS FILL TO MEET FINISHED GRADES. THE TWO SOURCES INCLUDE:
  - a. EXISTING SOIL STOCKPILE LOCATED AT THE BURR ELEMENTARY SCHOOL FIELD AND SHOWN ON SHEET L-1; AND
  - b. EXISTING SOIL STOCKPILE LOCATED AT THE NEWTON DEPARTMENT OF PUBLIC WORKS YARD AT 70 CRESCENT STREET, NEWTON MA.
2. CONTRACTOR IS RESPONSIBLE FOR SCREENING AND OBTAINING FILL FROM EXISTING SOIL STOCKPILE AT THE NEWTON DEPARTMENT OF PUBLIC WORKS YARD. THIS CITY-OWNED FILL SHALL ONLY BE UTILIZED IN APPROXIMATE LOCATION SHOWN ON SHEET L-3.
3. ADDITIONAL CLEAN COMMON FILL WILL BE REQUIRED TO BE FURNISHED AND INSTALLED BY THE CONTRACTOR TO MEET FINISHED GRADES. A MINIMUM OF TWO FEET OF THIS ADDITIONAL FILL AND LOAM MUST BE INSTALLED ABOVE THE CITY-OWNED FILL, SEE DETAIL 2 TYPICAL FIELD SECTION ON SHEET LD-3. FOR BIDDING PURPOSES, CONTRACTOR SHALL ASSUME THAT 2,000 CUBIC YARDS OF CITY-OWNED FILL MAY BE UTILIZED AS FILL.

REV. NO.	DATE	DRWN	CHKD	REMARKS

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 DRAWN BY: M. CARLSON  
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**CDM Smith**  
 75 State Street  
 Boston, MA 02109  
 Tel: (617) 452-6000

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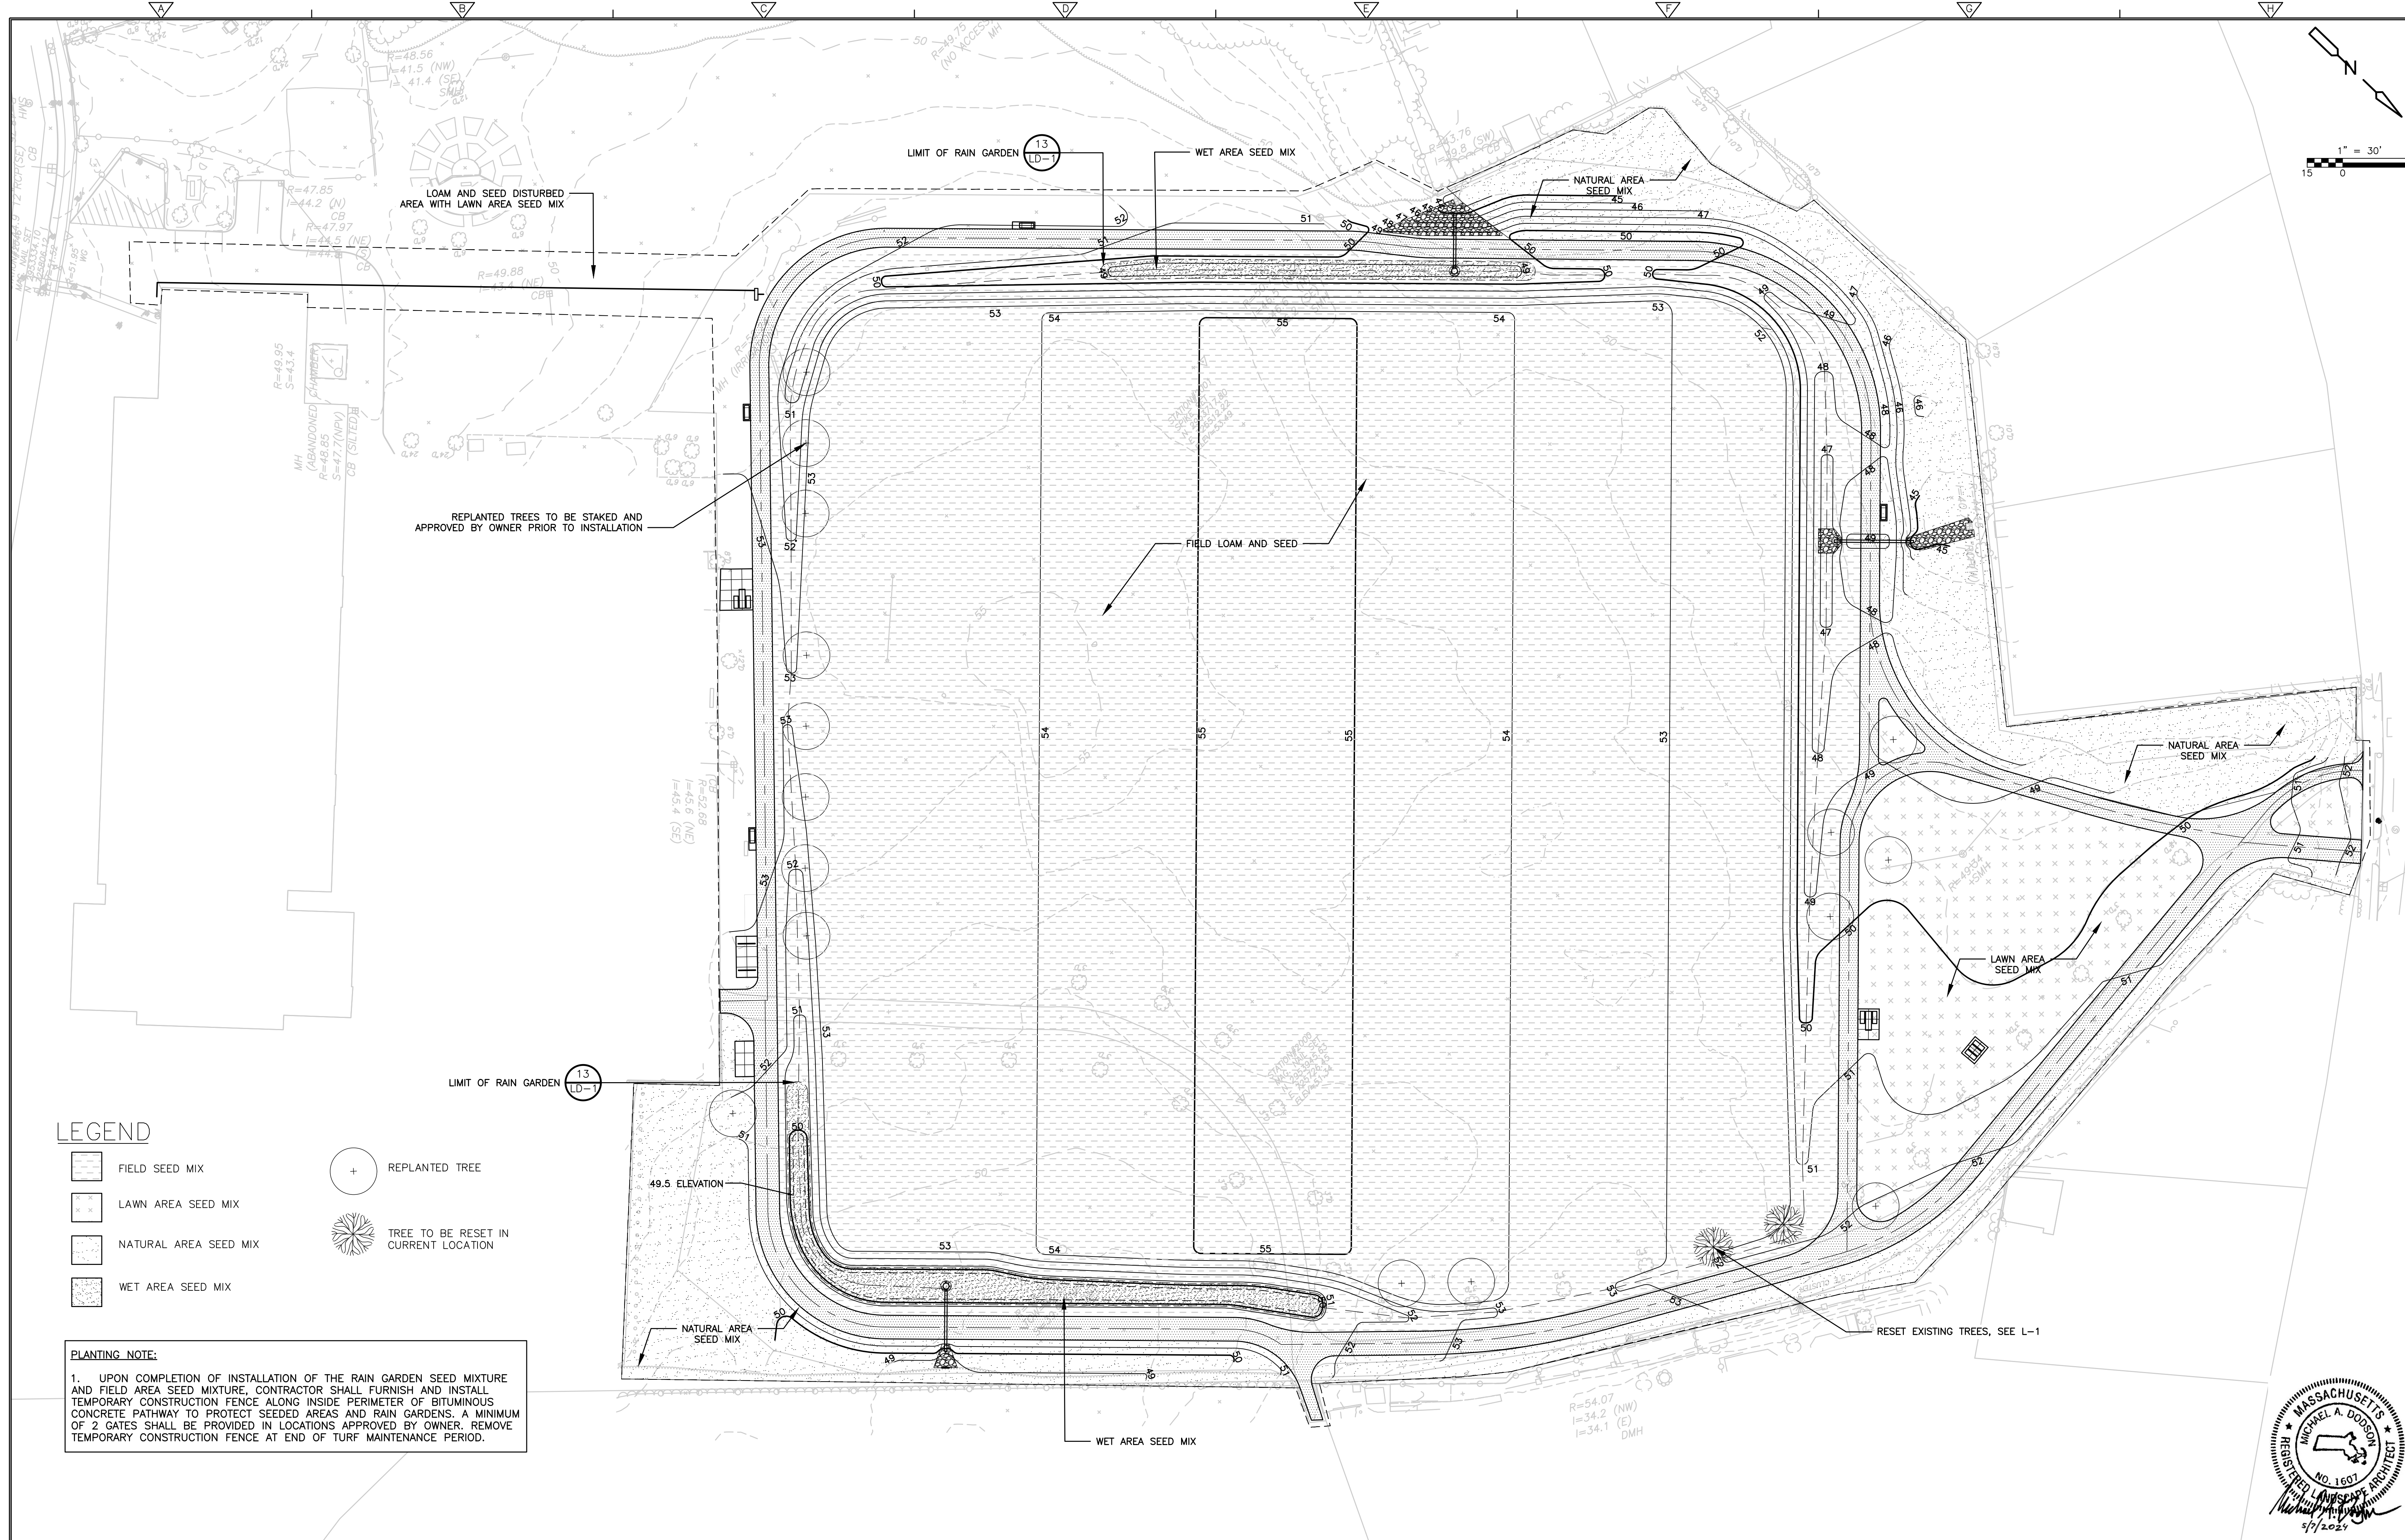
**GRADING, DRAINAGE AND IRRIGATION PLAN**

PROJECT NO. 0865-272529  
 FILE NAME: C0004GDPL  
 SHEET NO.  
**L-3**  
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



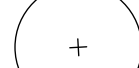





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**LEGEND**

-  FIELD SEED MIX
-  LAWN AREA SEED MIX
-  NATURAL AREA SEED MIX
-  WET AREA SEED MIX
-  REPLANTED TREE
-  TREE TO BE RESET IN CURRENT LOCATION

**PLANTING NOTE:**  
 1. UPON COMPLETION OF INSTALLATION OF THE RAIN GARDEN SEED MIXTURE AND FIELD AREA SEED MIXTURE, CONTRACTOR SHALL FURNISH AND INSTALL TEMPORARY CONSTRUCTION FENCE ALONG INSIDE PERIMETER OF BITUMINOUS CONCRETE PATHWAY TO PROTECT SEEDED AREAS AND RAIN GARDENS. A MINIMUM OF 2 GATES SHALL BE PROVIDED IN LOCATIONS APPROVED BY OWNER. REMOVE TEMPORARY CONSTRUCTION FENCE AT END OF TURF MAINTENANCE PERIOD.

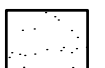REV. NO.	DATE	DRWN	CHKD	REMARKS


DESIGNED BY: M. DODSON  
 DRAWN BY: M. CARLSON  
 SHEET CHK'D BY: S. LANDGREN  
 CROSS CHK'D BY: M. DODSON  
 APPROVED BY: M. DODSON  
 DATE: MAY 2024




CITY OF NEWTON, MASSACHUSETTS  
 BURR ELEMENTARY SCHOOL  
 FIELD IMPROVEMENTS

PLANTING PLAN  
 SHEET NO. L-4


PROJECT NO. 0865-272529  
 FILE NAME: C0005PLPL  
 SHEET NO. L-4  
 ISSUED FOR BID

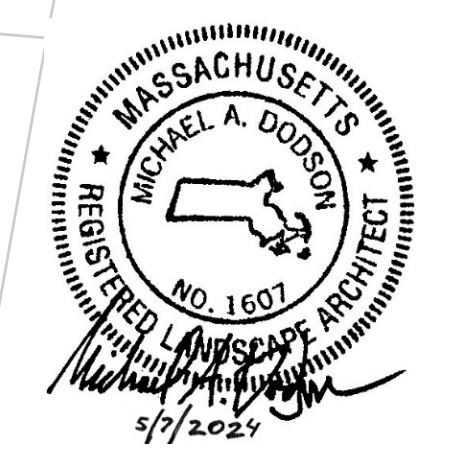

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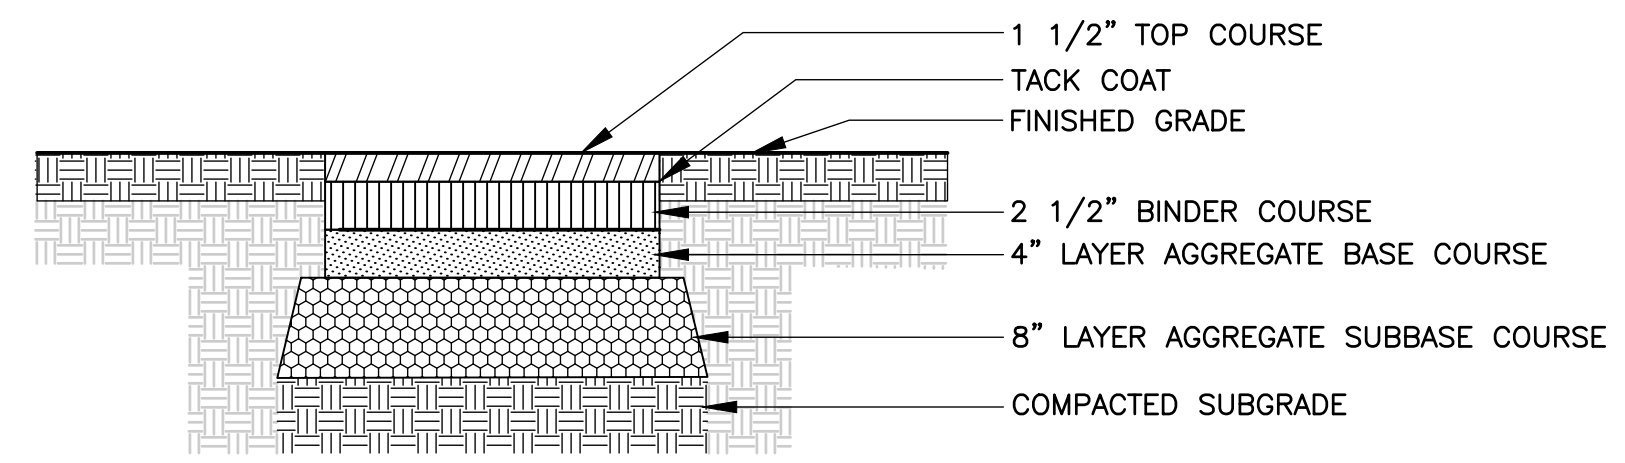


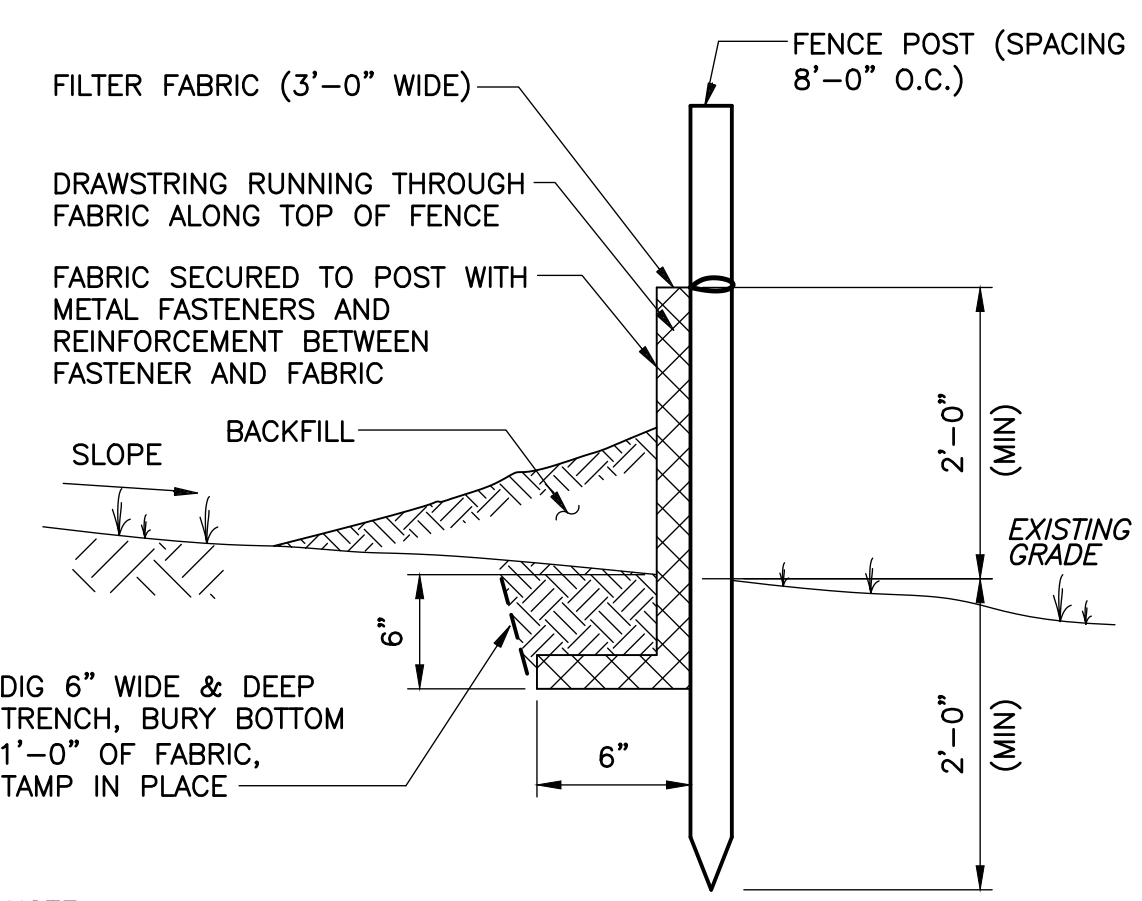**SEDIMENT FENCE**  
DETAIL 1  
NOT TO SCALE LD-1

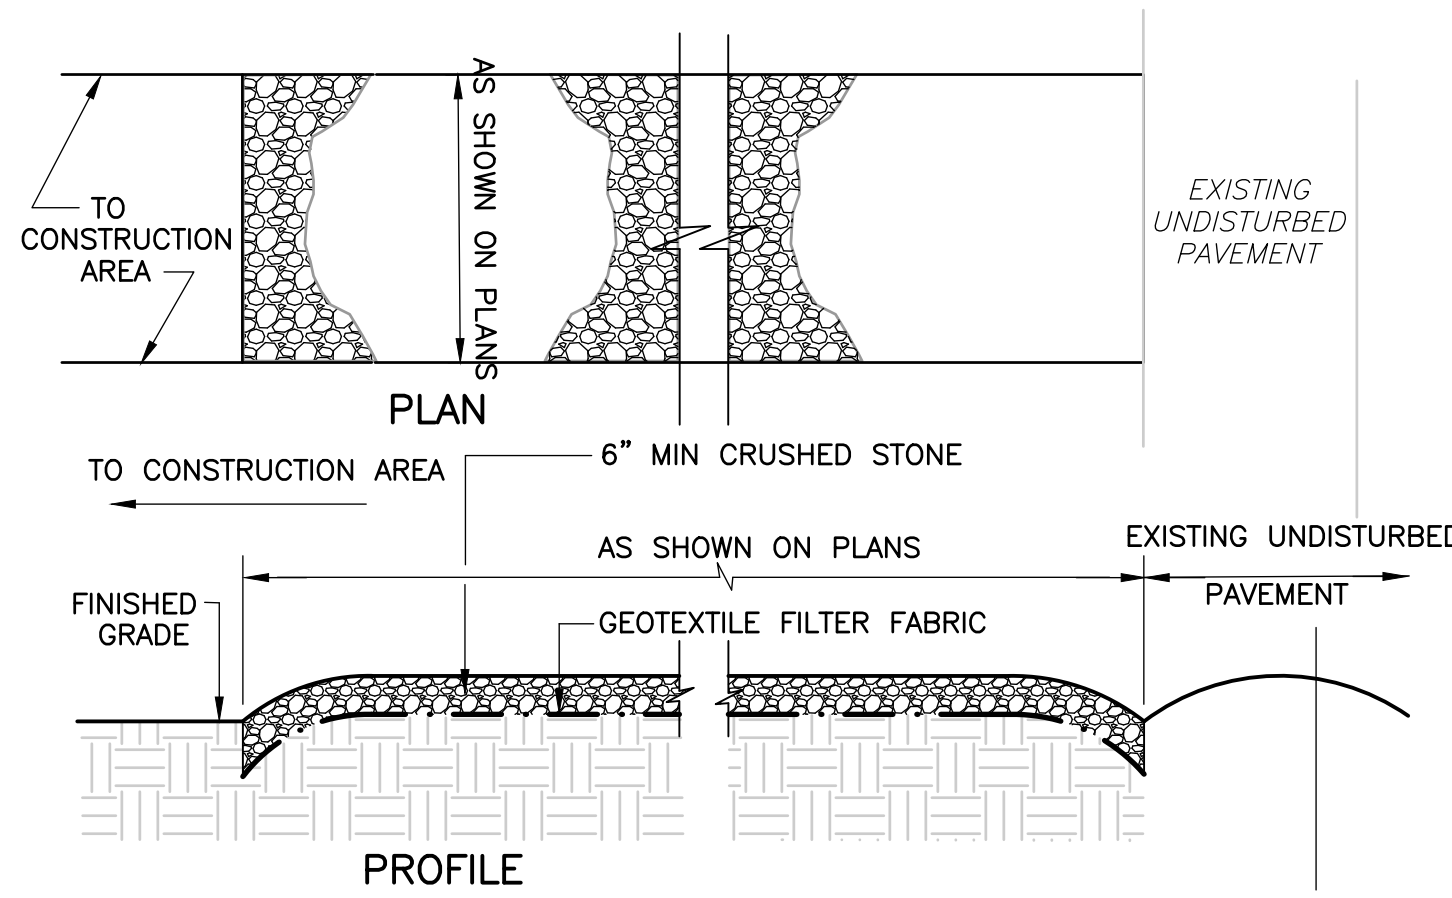


- NOTES:**
1. PROVIDE APPROPRIATE TRANSITION BETWEEN STABILIZED CONSTRUCTION ENTRANCE AND UNDISTURBED PAVEMENT.
  2. THE ENTRANCE SHALL BE MAINTAINED IN A CONDITION WHICH WILL PREVENT TRACKING OR FLOWING OF SEDIMENT ONTO UNDISTURBED PAVEMENT. THIS MAY REQUIRE PERIODIC TOP DRESSING WITH ADDITIONAL STONE OR ADDING STONE TO THE LENGTH OF THE ENTRANCE.
  3. REPAIR AND CLEANOUT MEASURES USED TO TRAP SEDIMENT.
  4. ALL SEDIMENT SPILLED, DROPPED, WASHED, OR TRACKED ONTO UNDISTURBED PAVEMENT SHALL BE REMOVED AS DIRECTED BY THE ENGINEER.

**STABILIZED CONSTRUCTION ENTRANCE**  
DETAIL 4  
NOT TO SCALE LD-1




- 1.) BASE COURSE SHALL EXTEND 3" MIN. BEYOND EDGE OF PAVEMENT
- 2.) DETAIL APPLIES TO ALL BITUMINOUS CONCRETE PAVEMENT SURFACES AND WALKS

**BITUMINOUS CONCRETE PAVEMENT**  
DETAIL 7  
NOT TO SCALE LD-1

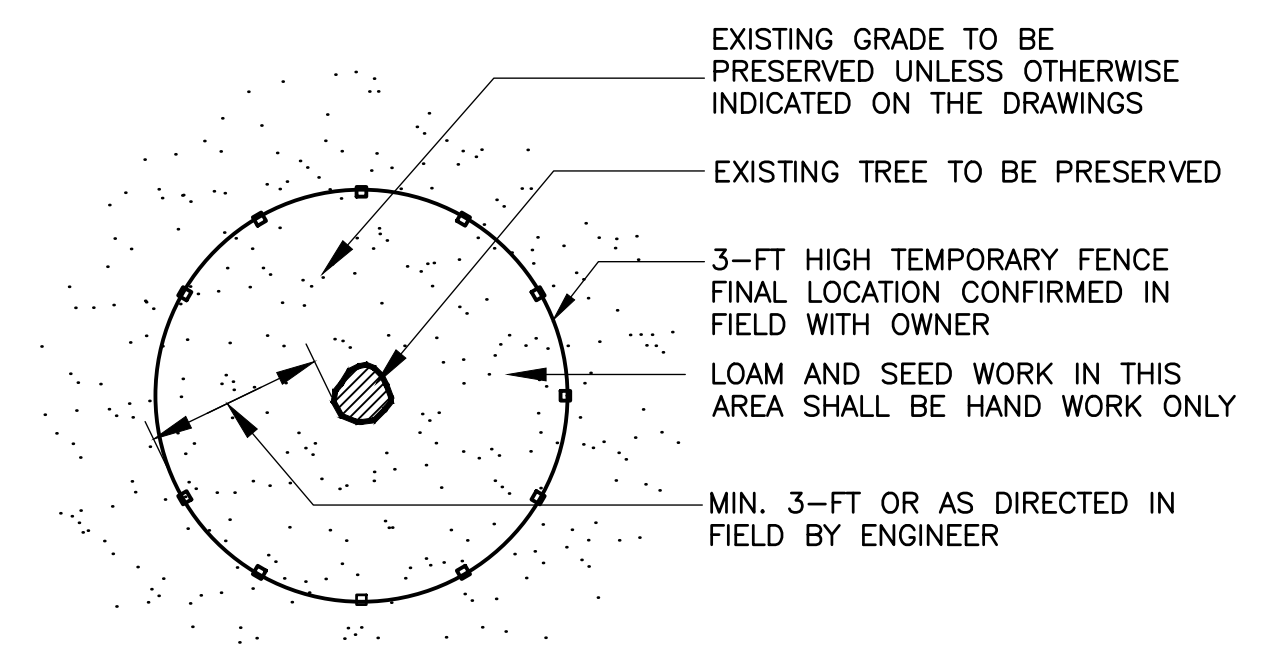


- NOTES:**
1. FENCING SHALL BE INSTALLED AROUND PERIMETER OF EXISTING TREE TO BE PROTECTED AS SHOWN ON PLANS.
  2. FENCING SHALL REMAIN IN PLACE AND BE MAINTAINED THROUGHOUT CONSTRUCTION AND THEN REMOVED COMPLETELY AS DIRECTED BY OWNER TO COMPLETE LOAMING AND SEEDING ACTIVITIES.

**TREE PROTECTION**  
DETAIL 11  
NOT TO SCALE LD-1

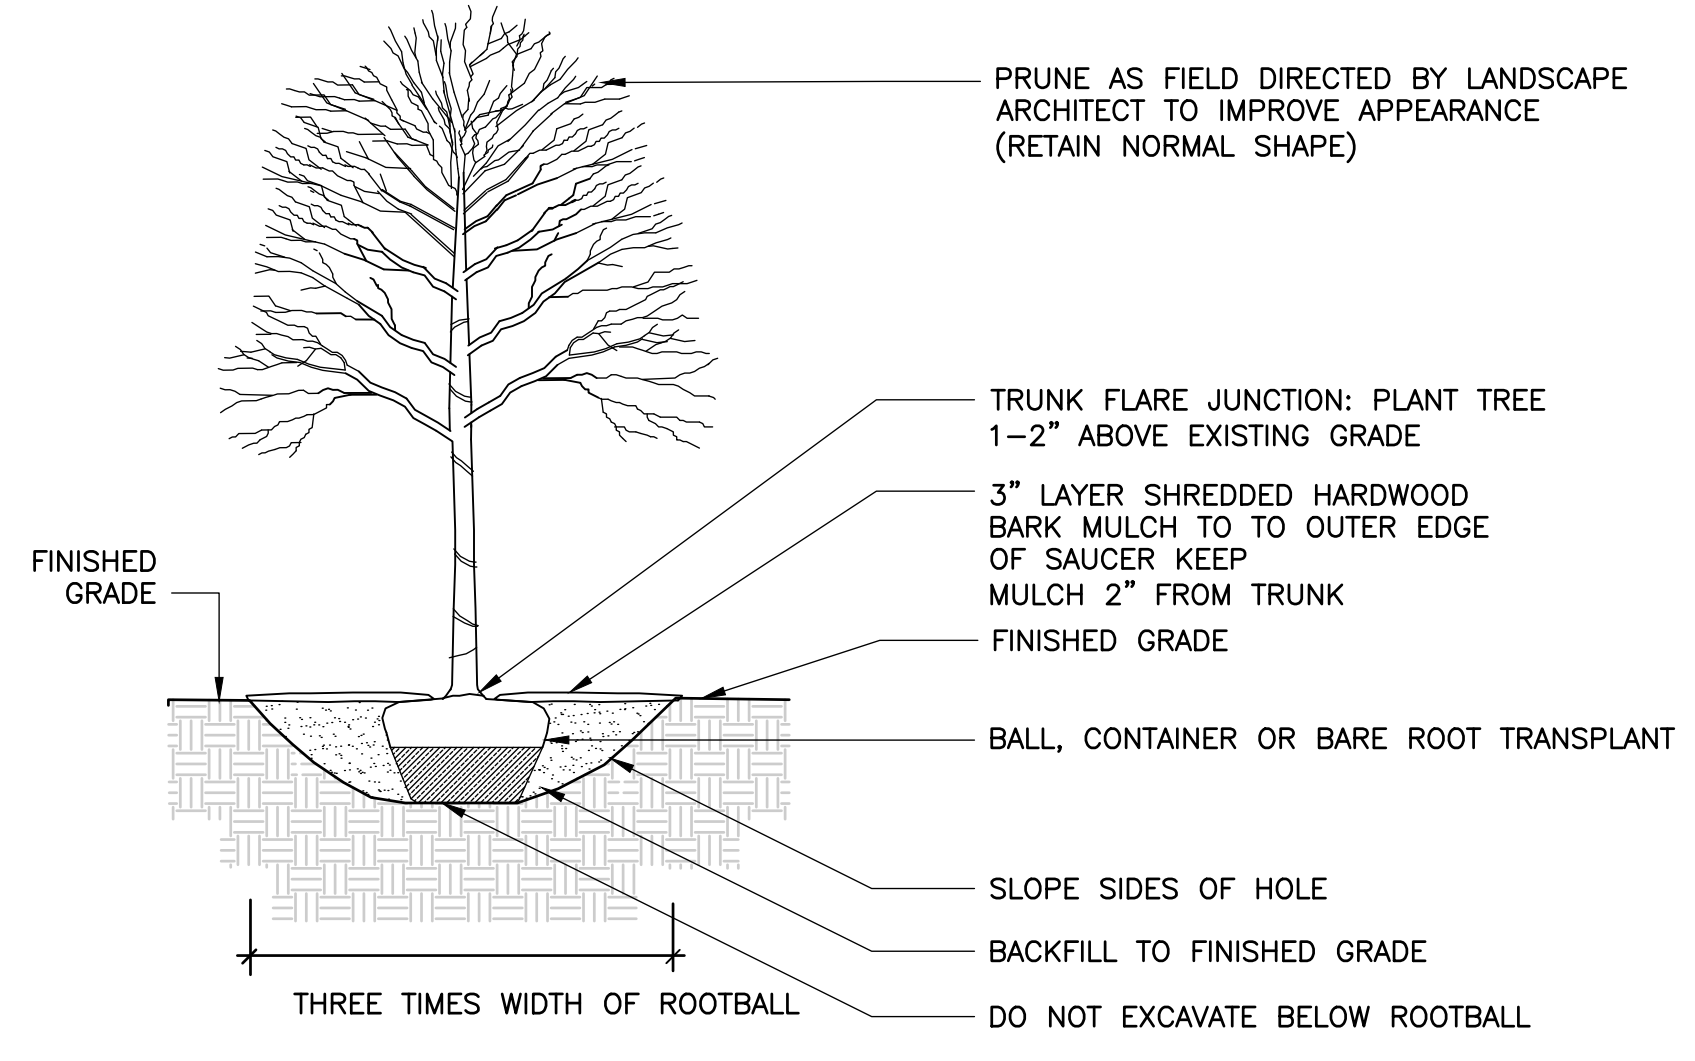


**REPLANTED DECIDUOUS TREE PLANTING**  
DETAIL 8  
NOT TO SCALE LD-1

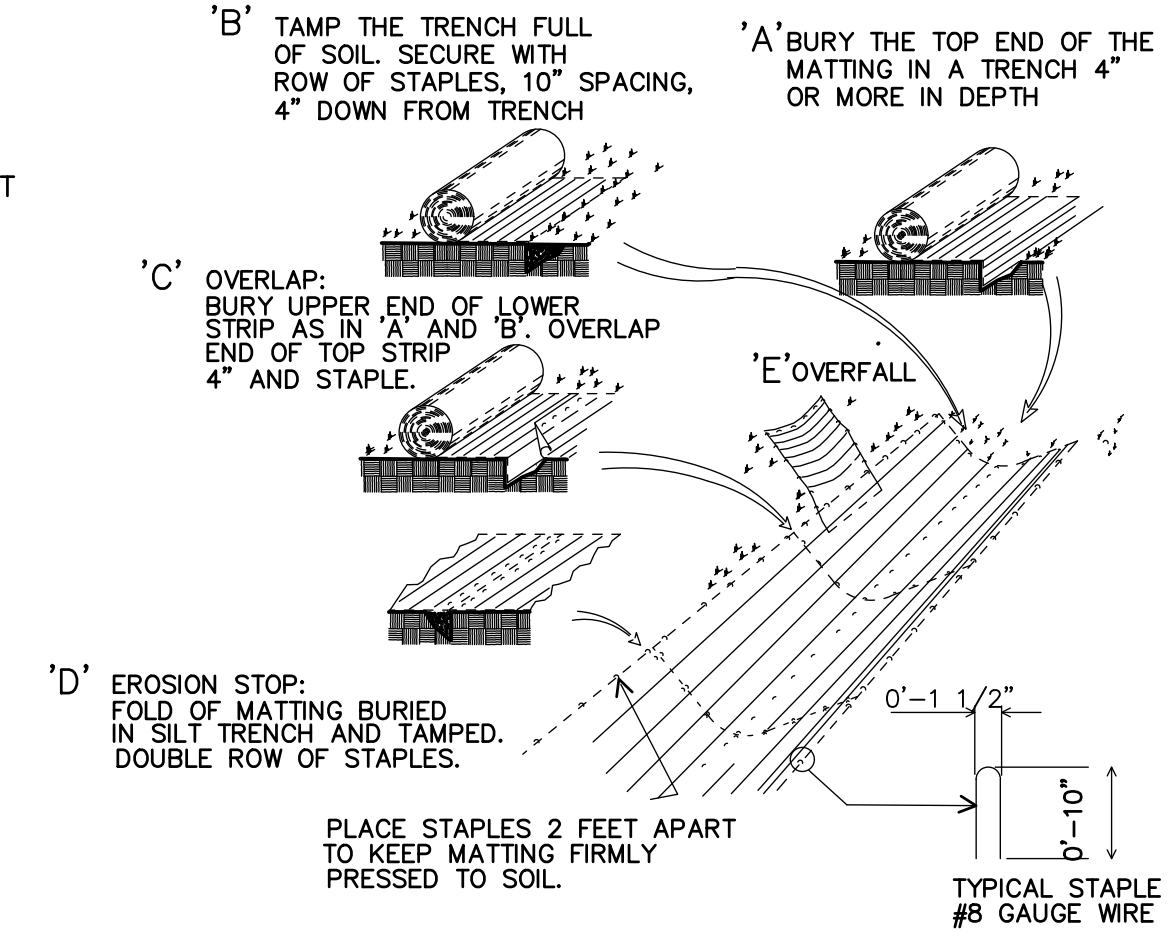


- NOTE:**
- 1.) APPLY ON ALL NEW SLOPES 3(H):1(V) OR GREATER


**EROSION CONTROL BLANKET**  
DETAIL 12  
NOT TO SCALE LD-1

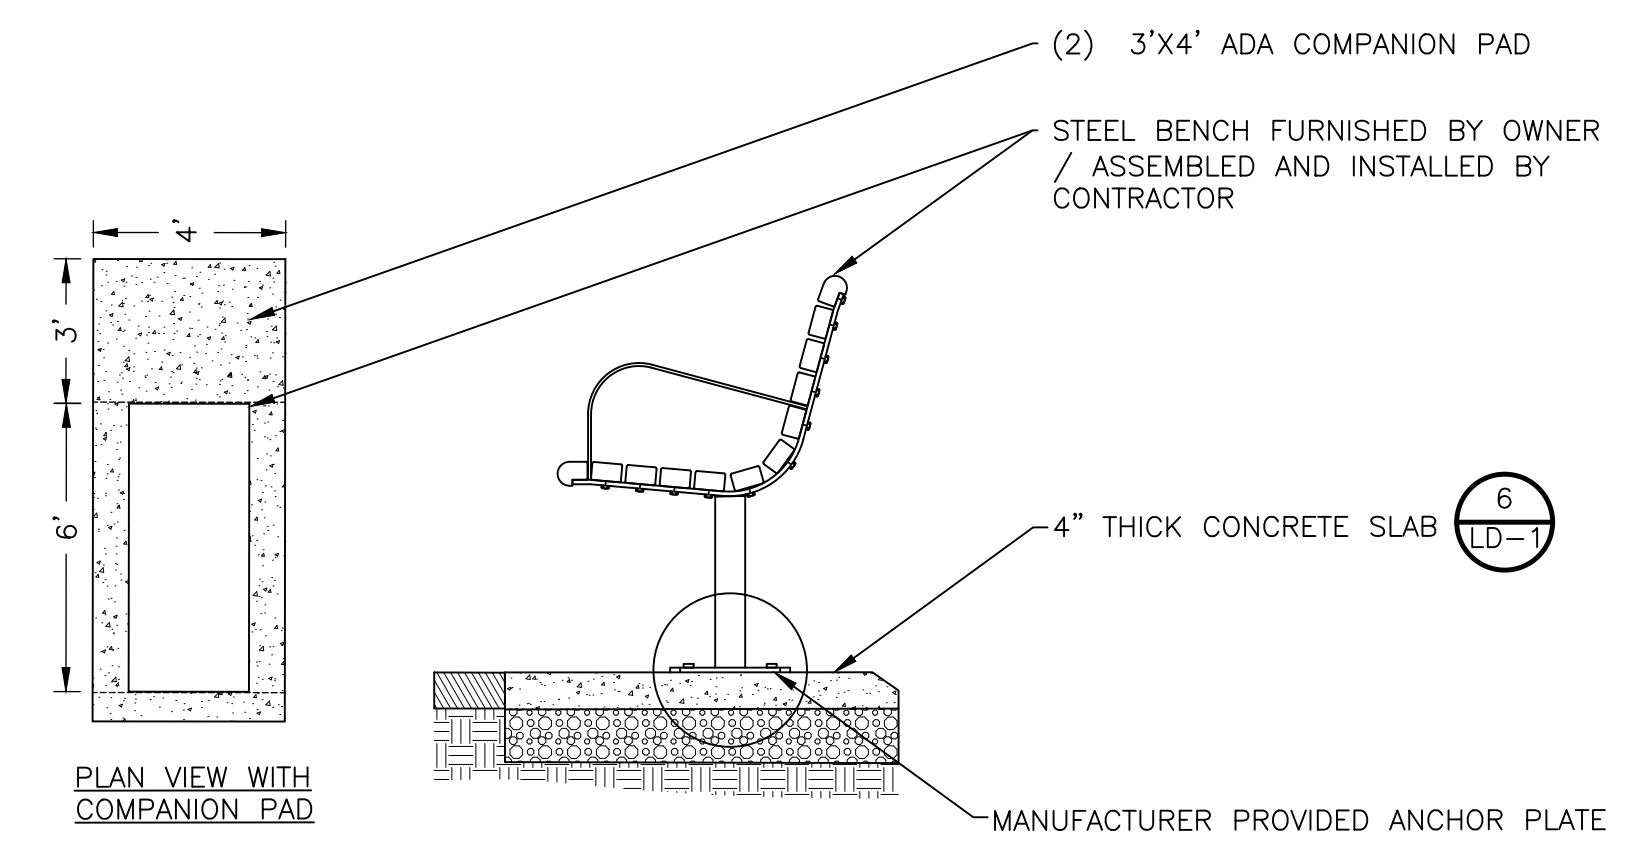


**PARK BENCH AND CONCRETE PAD**  
DETAIL 2  
NOT TO SCALE LD-1

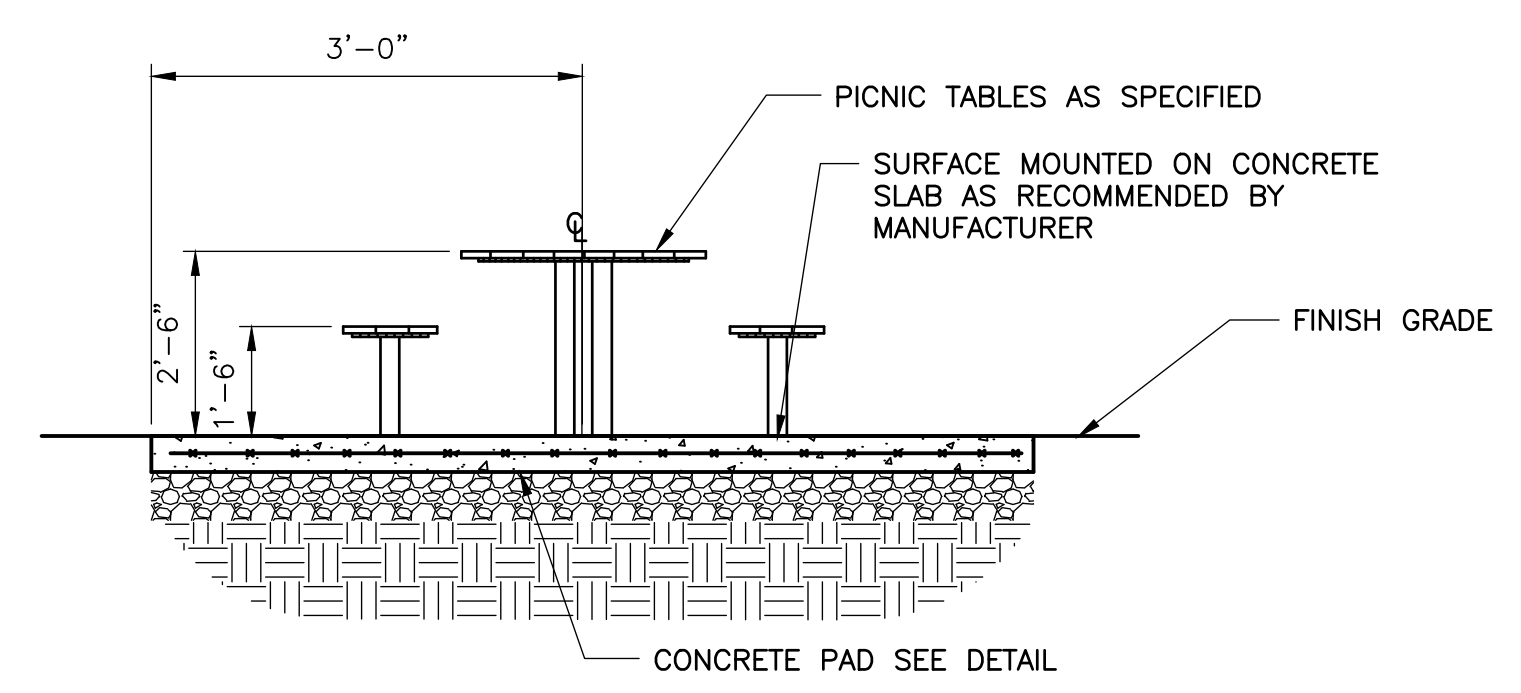


**PICNIC TABLE ON CONCRETE PAD**  
DETAIL 5  
NOT TO SCALE LD-1

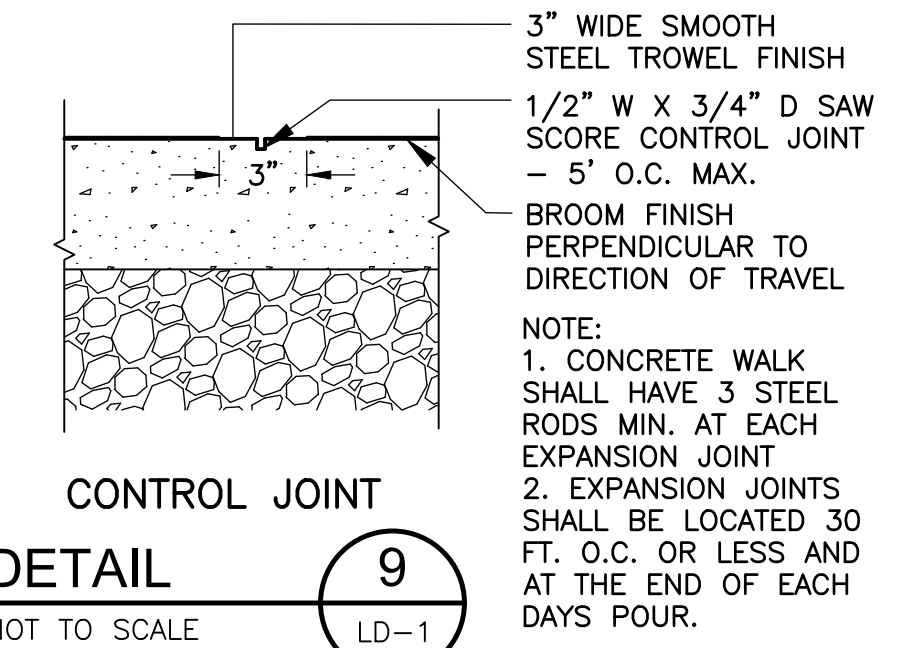


**CONTROL JOINT**  
DETAIL 9  
NOT TO SCALE LD-1

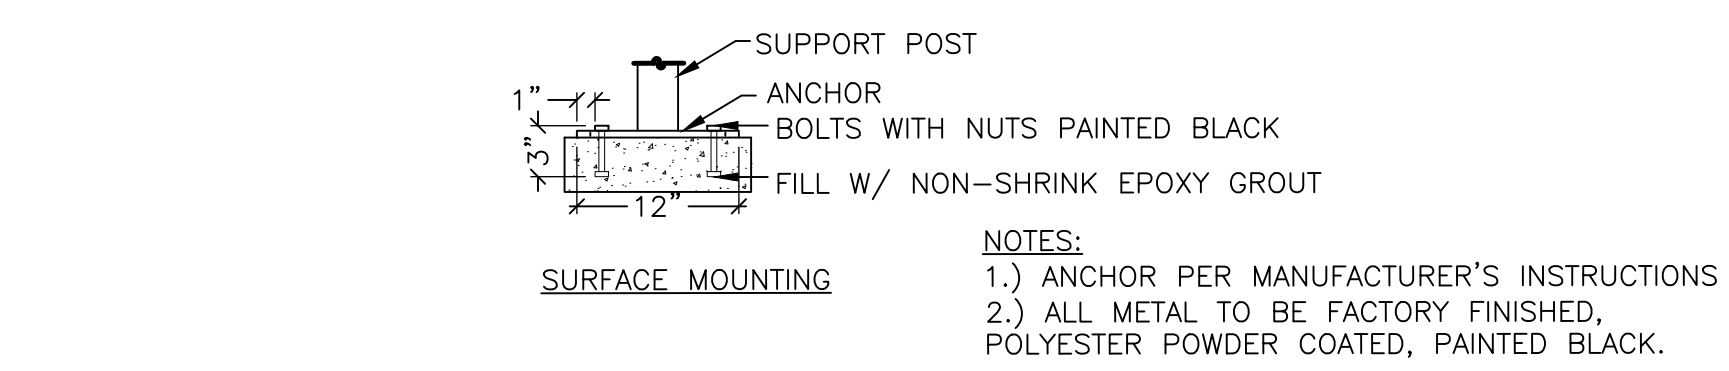


**TEMPORARY CATCH BASIN FILTER**  
DETAIL 3  
NOT TO SCALE LD-1

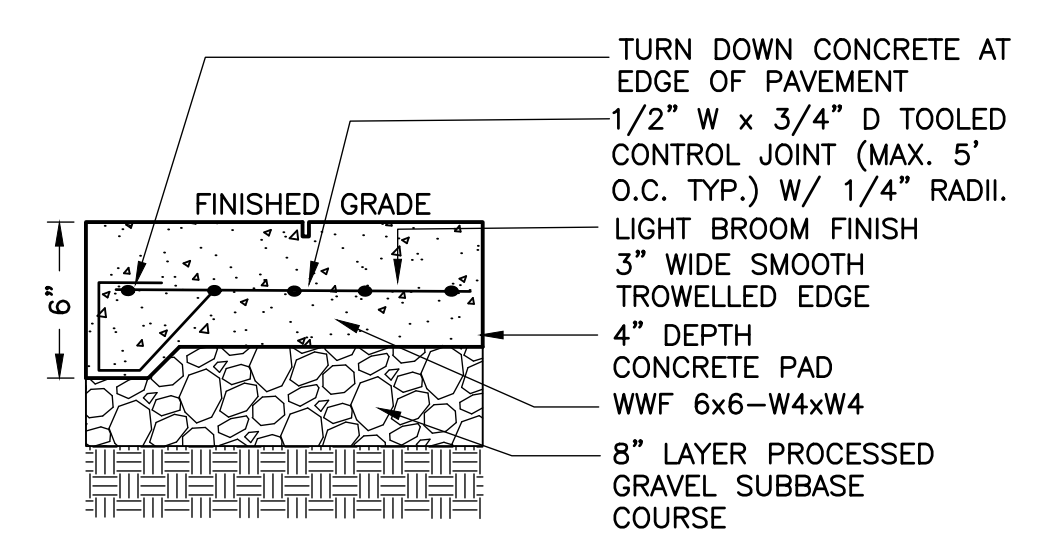


**CONCRETE PAD**  
DETAIL 6  
NOT TO SCALE LD-1

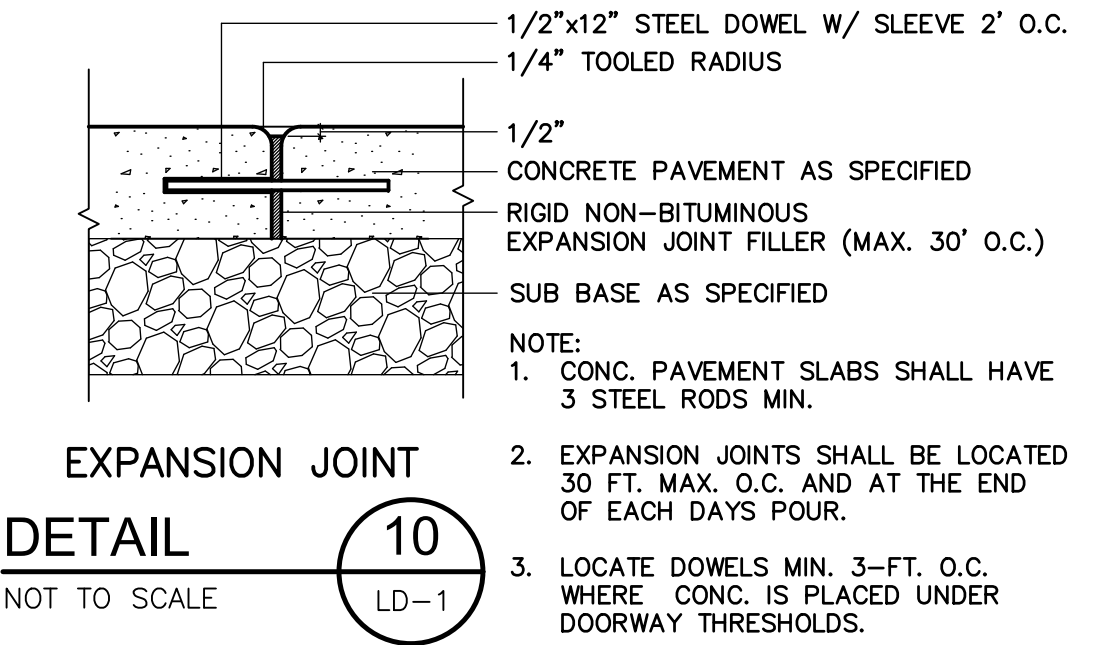

**EXPANSION JOINT**  
DETAIL 10  
NOT TO SCALE LD-1

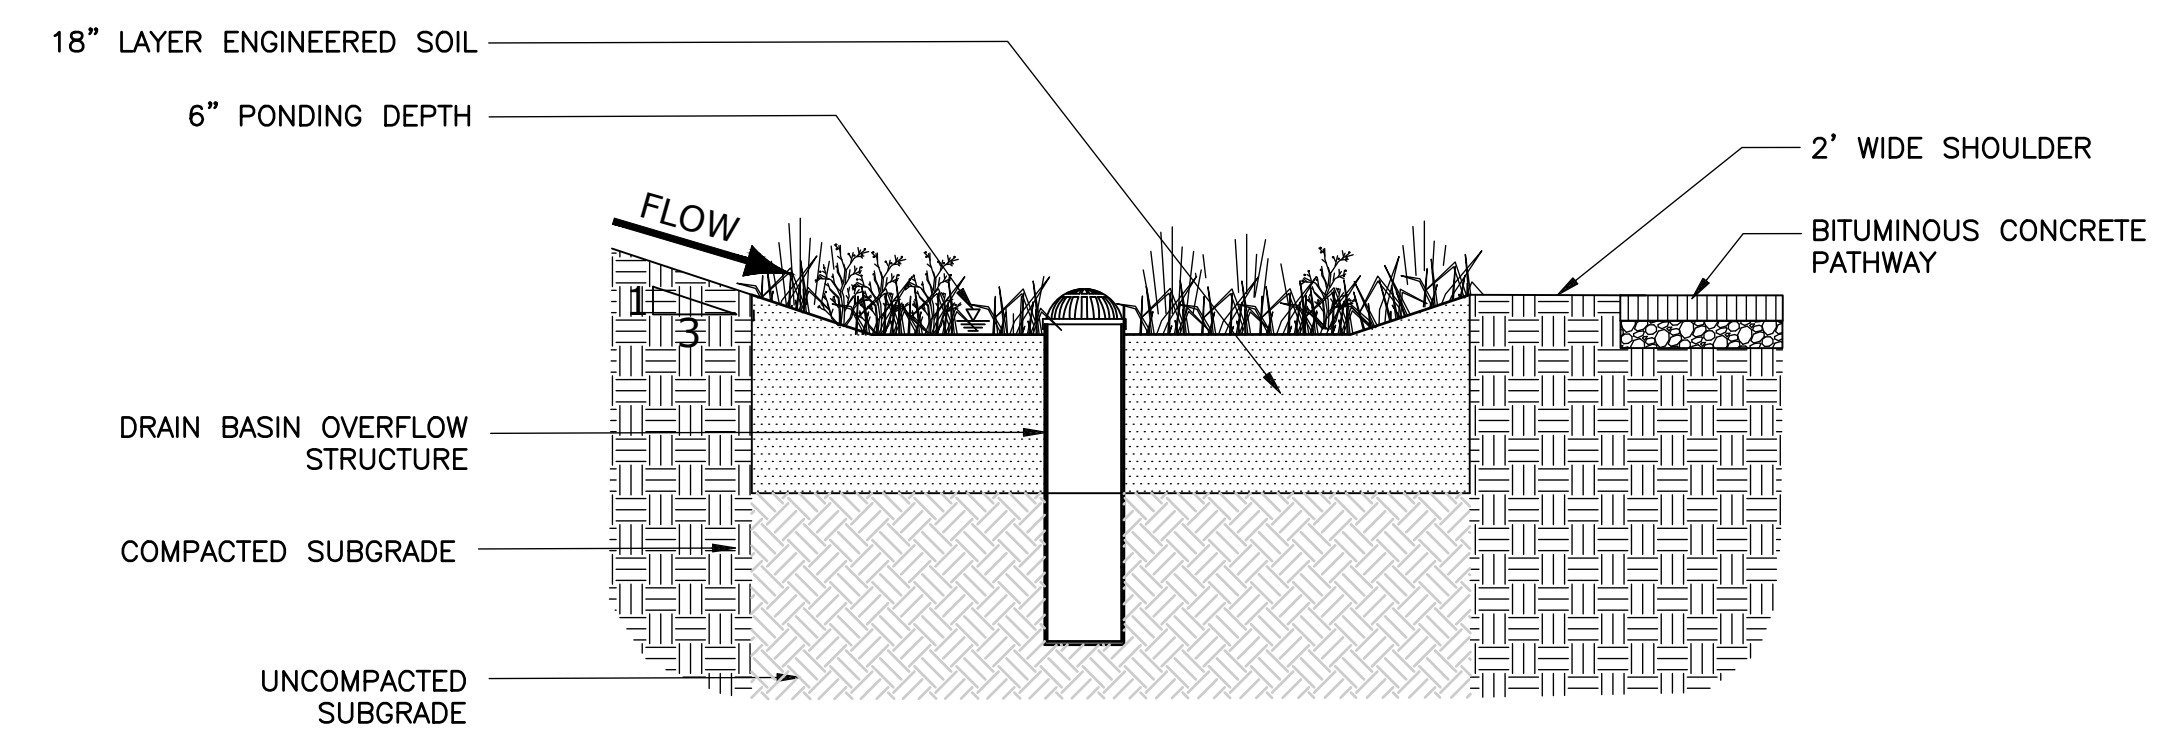

**RAIN GARDEN**  
DETAIL 13  
NOT TO SCALE LD-1

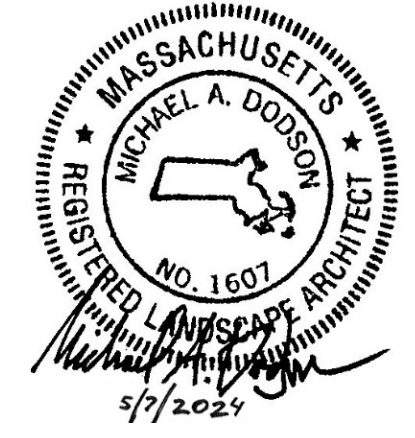

REV. NO.	DATE	DRWN	CHKD	REMARKS

DESIGNED BY: M. DODSON  
 DRAWN BY: M. CARLSON  
 SHEET CHK'D BY: S. LANDGREN  
 CROSS CHK'D BY: M. DODSON  
 APPROVED BY: M. DODSON  
 DATE: MAY 2024




CITY OF NEWTON, MASSACHUSETTS  
**BURR ELEMENTARY SCHOOL**  
**FIELD IMPROVEMENTS**

CIVIL DETAILS I


PROJECT NO. 0865-272529  
 FILE NAME: C00001  
 SHEET NO. LD-1  
 ISSUED FOR BID



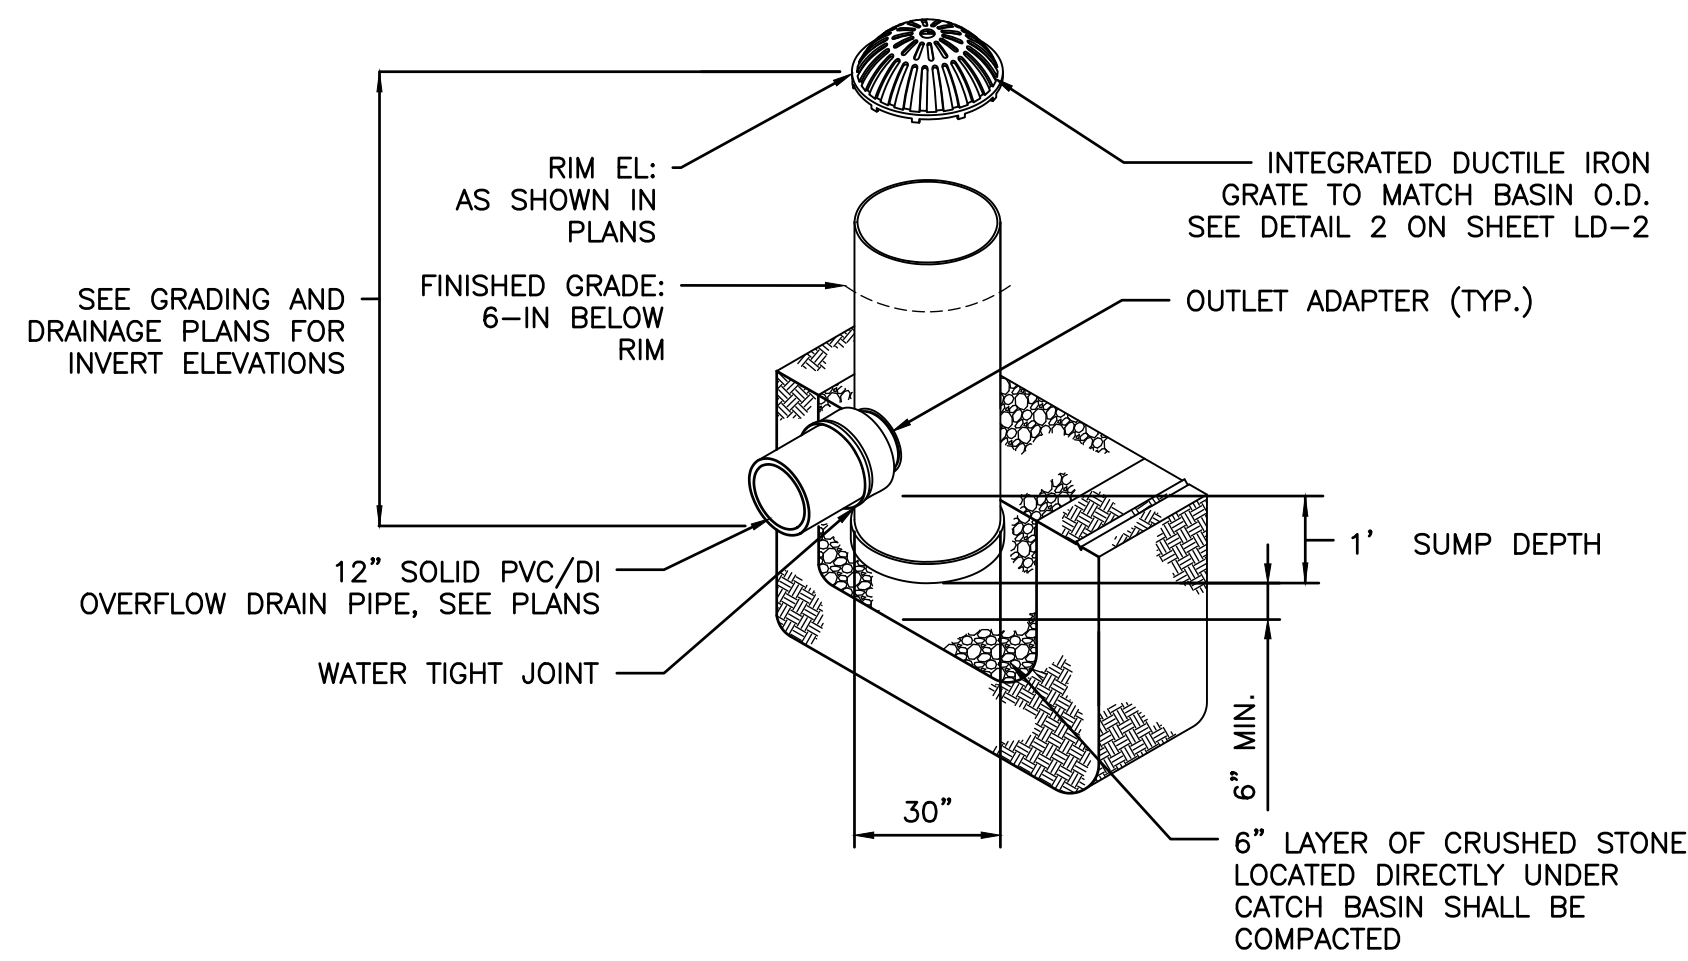


DRAIN BASIN WITH DOME GRATE

DETAIL 1  
1/4"=1'-0" LD-2

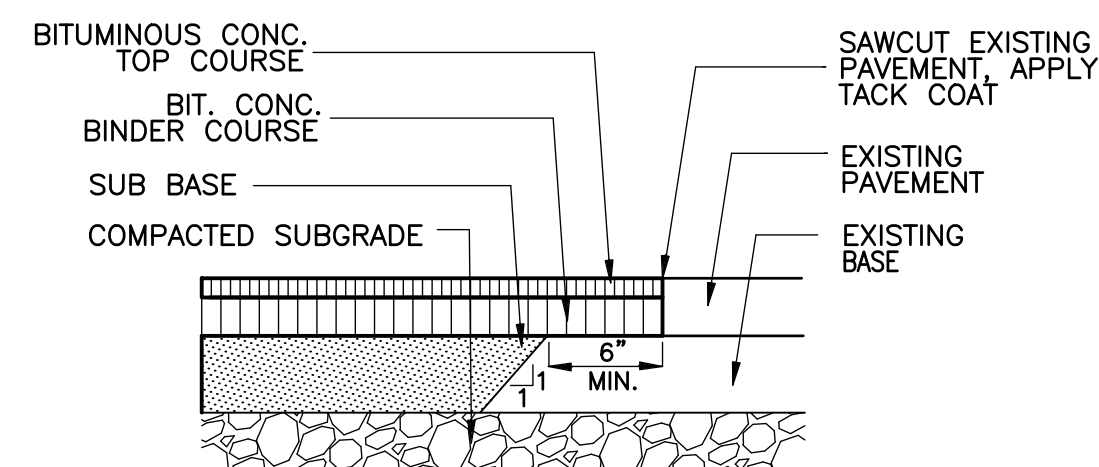

PAVEMENT MATCH


DETAIL 4  
NOT TO SCALE LD-2

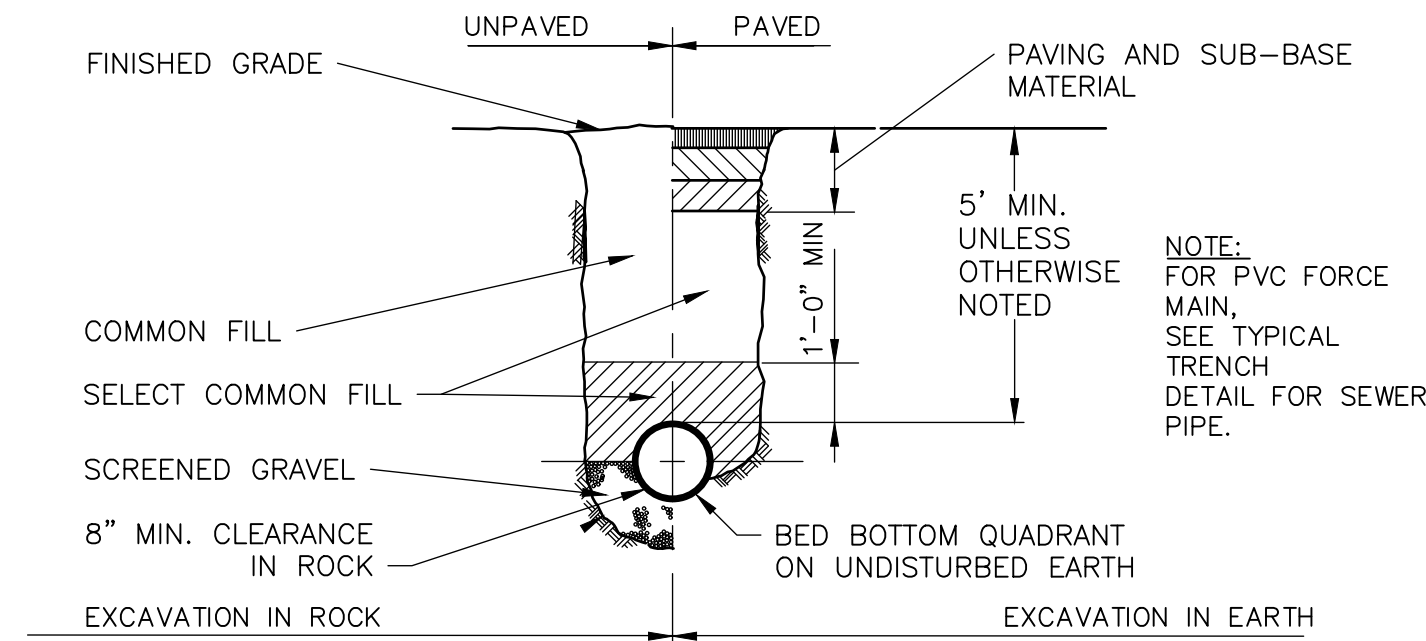


TYPICAL TRENCH DETAILS

DETAIL 7  
NOT TO SCALE LD-2


PIPE MATERIAL	"A" (MAX.)
RC	4'-0"
PVC	3'-3"
DI	4'-6"

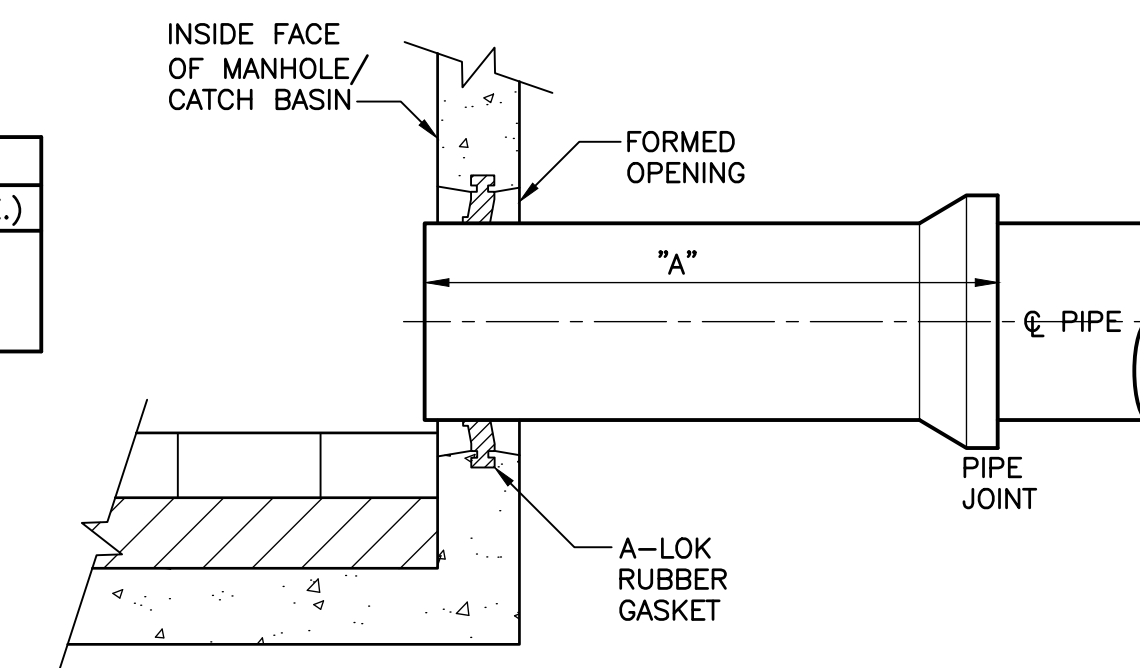


A-LOK SYSTEM

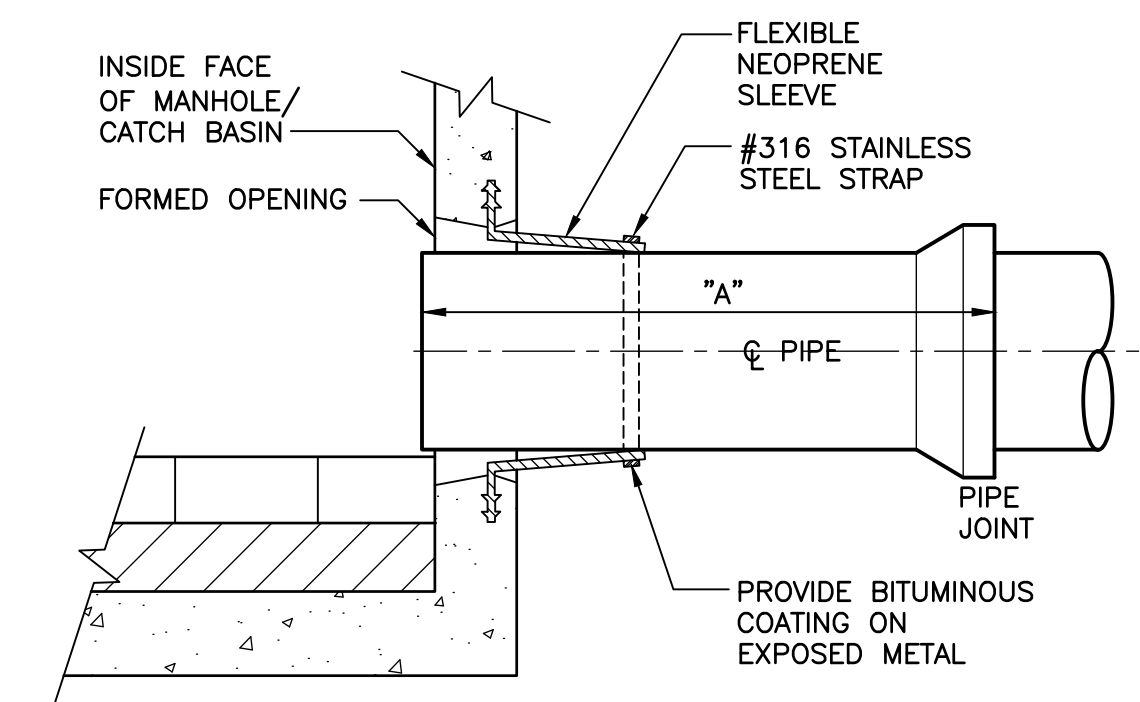

FLEXIBLE SLEEVE

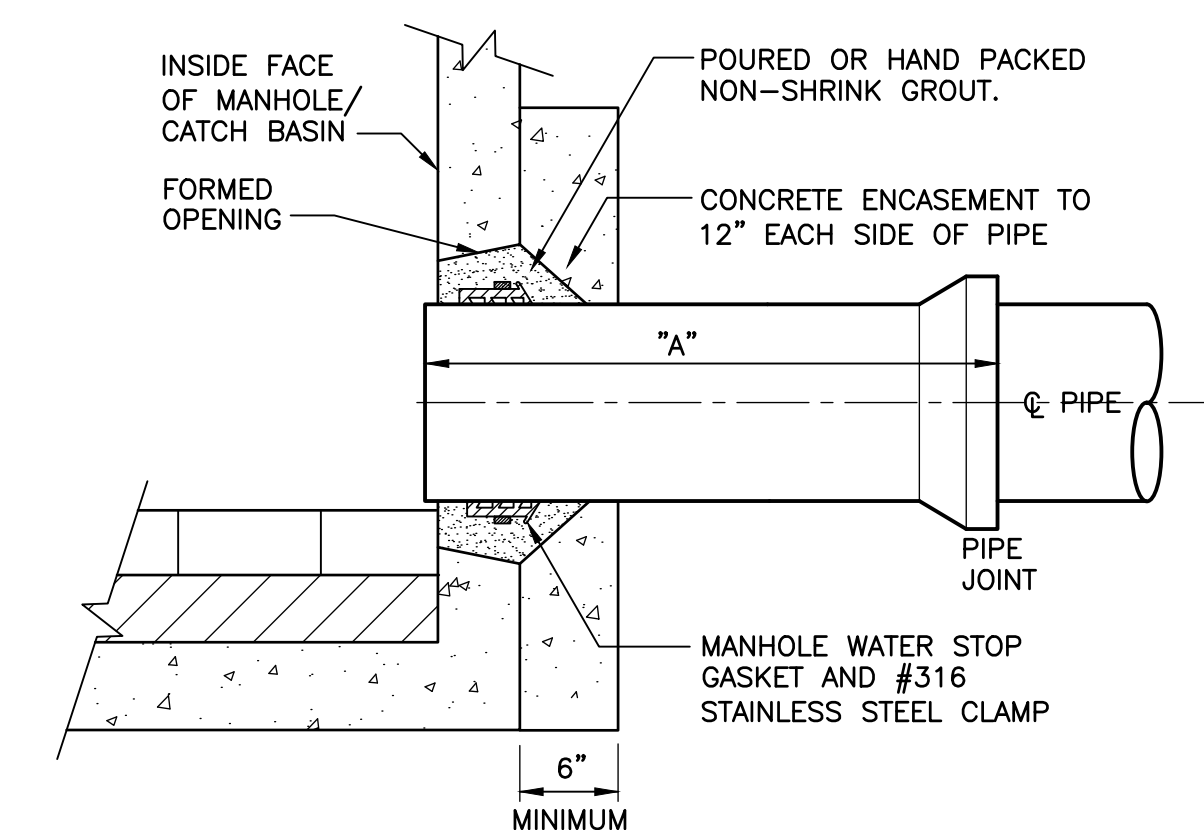


CONCRETE ENCASEMENT

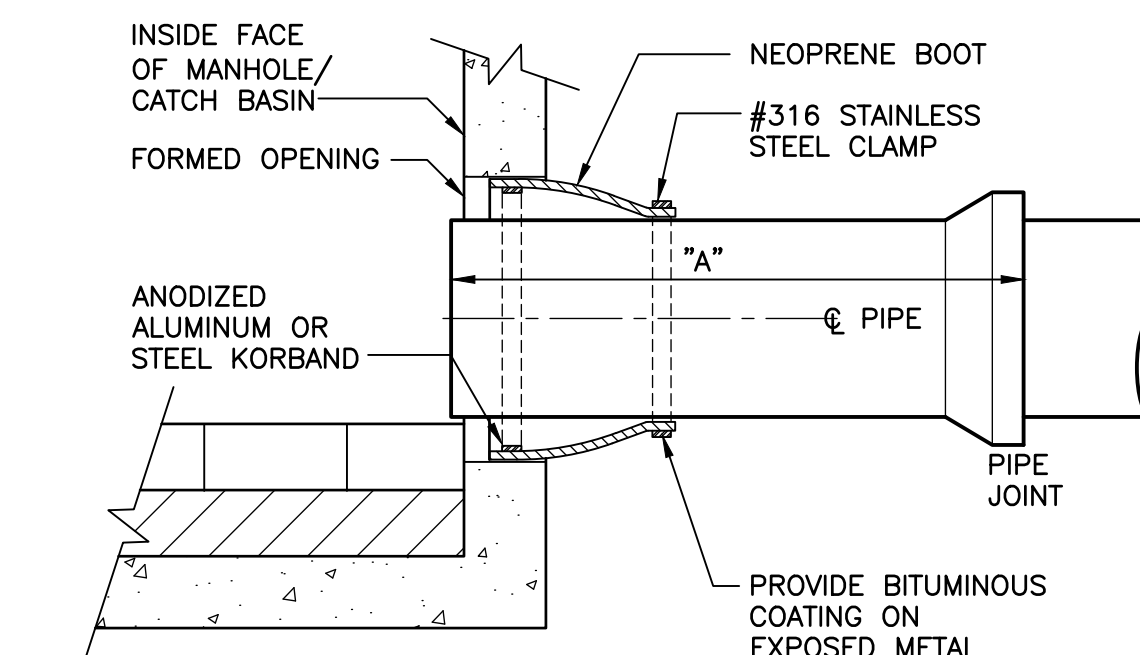

KOR-N-SEAL BOOT


OTHER PIPE CONNECTIONS

DETAIL 9  
NOT TO SCALE LD-2

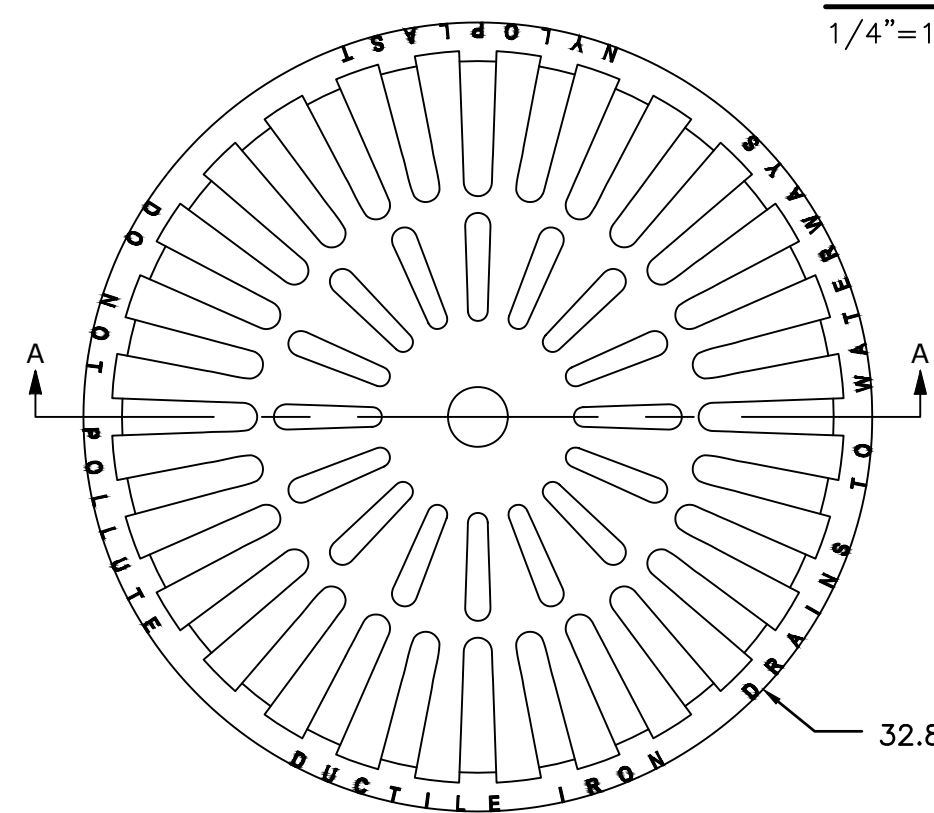


DUCTILE IRON DOME GRATE

DETAIL 2  
1/4"=1'-0" LD-2

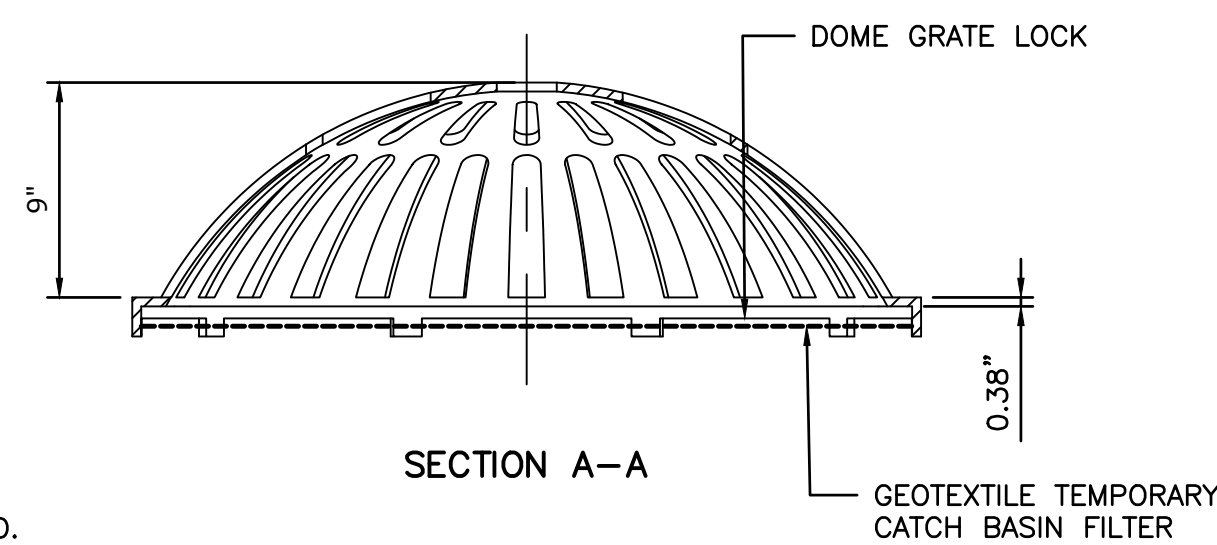


SECTION A-A

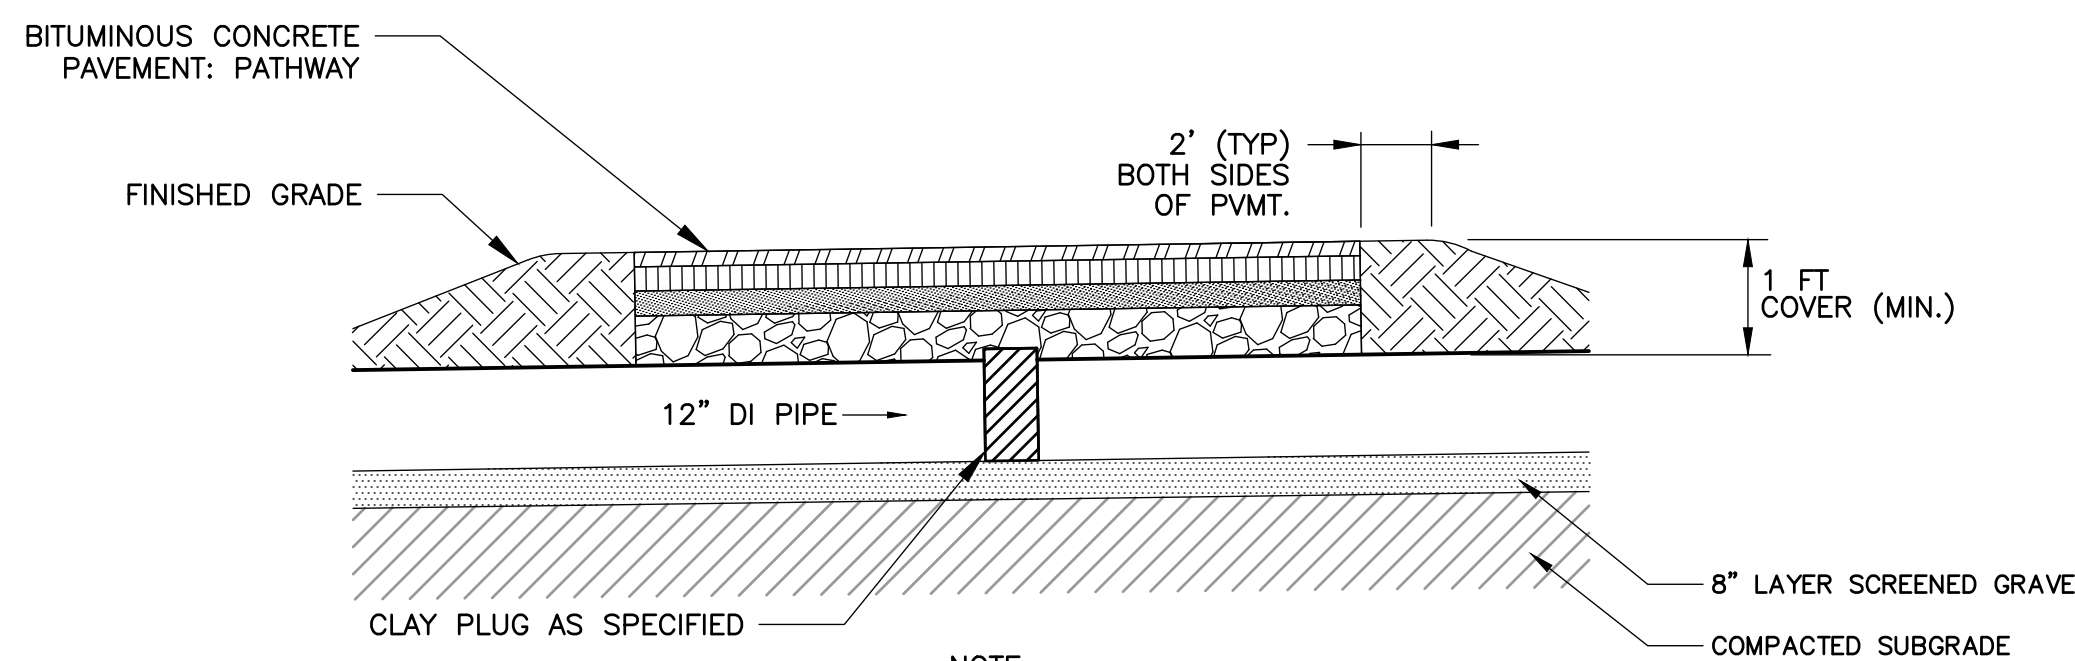


DUCTILE IRON PIPE CULVERT

DETAIL 5  
NOT TO SCALE LD-2

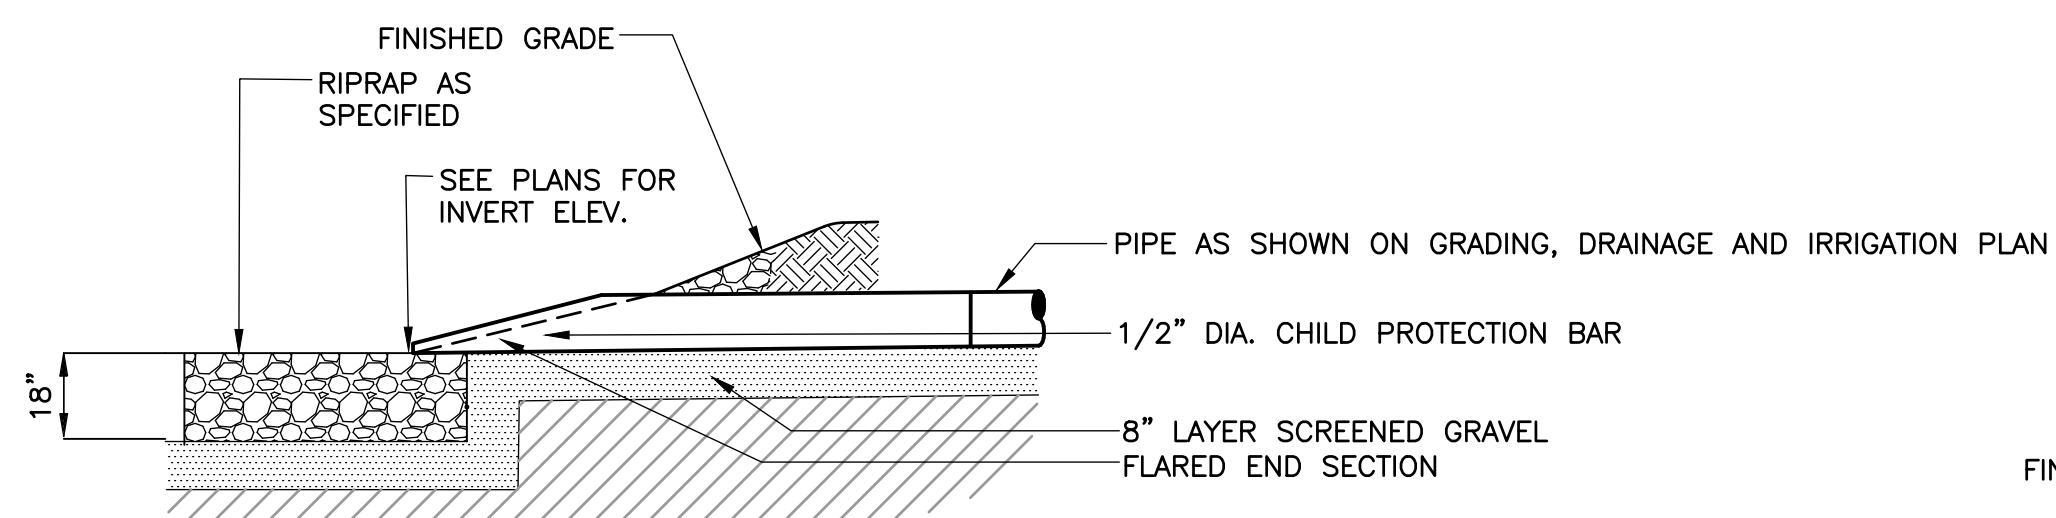


SECTION

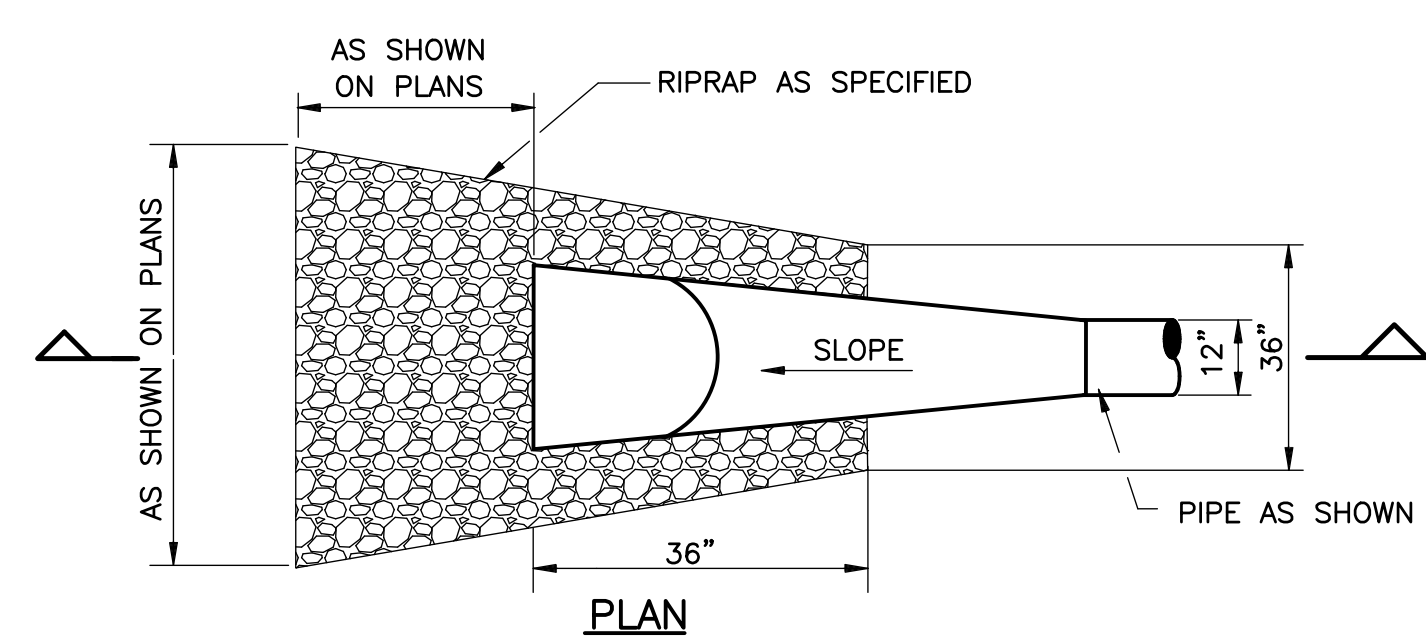


FLARED END SECTION & RIPRAP APRON

DETAIL 3  
NOT TO SCALE LD-2

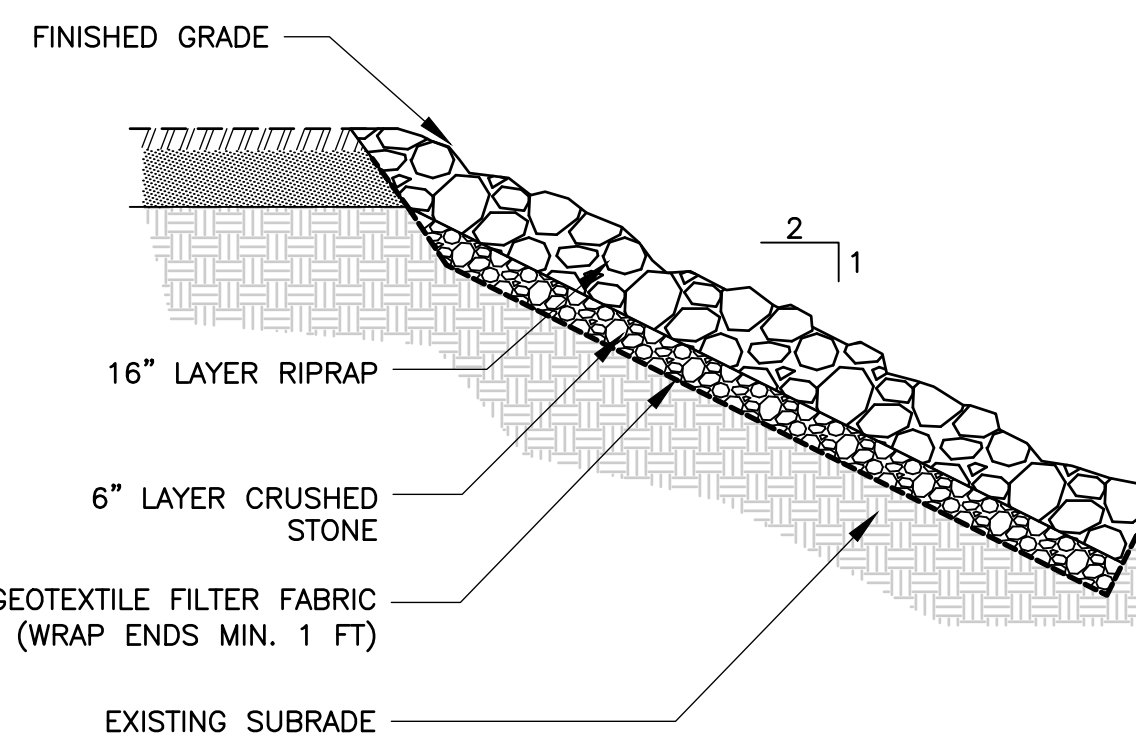

RIPRAP SLOPE

DETAIL 6  
NOT TO SCALE LD-2

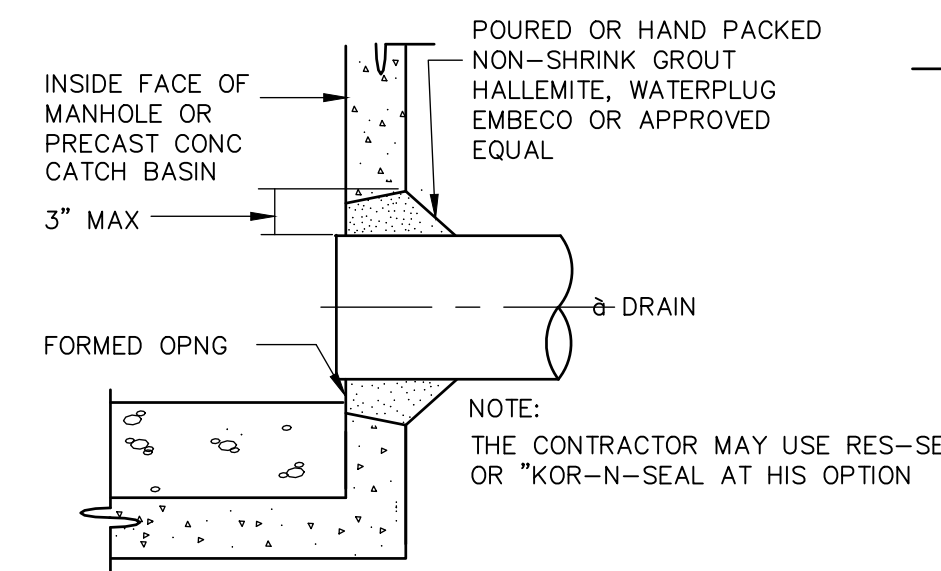

TYPICAL PIPE CONNECTION

DETAIL 8  
NOT TO SCALE LD-2



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REV. NO.	DATE	DRWN	CHKD	REMARKS

DESIGNED BY:	M. DODSON
DRAWN BY:	M. CARLSON
SHEET CHK'D BY:	S. LANDGREN
CROSS CHK'D BY:	M. DODSON
APPROVED BY:	M. DODSON
DATE:	MAY 2024



CITY OF NEWTON, MASSACHUSETTS  
Burr Elementary School  
Field Improvements


CIVIL DETAILS II

PROJECT NO.	0865-272529
FILE NAME:	COOOD1
SHEET NO.	LD-2


ISSUED FOR BID




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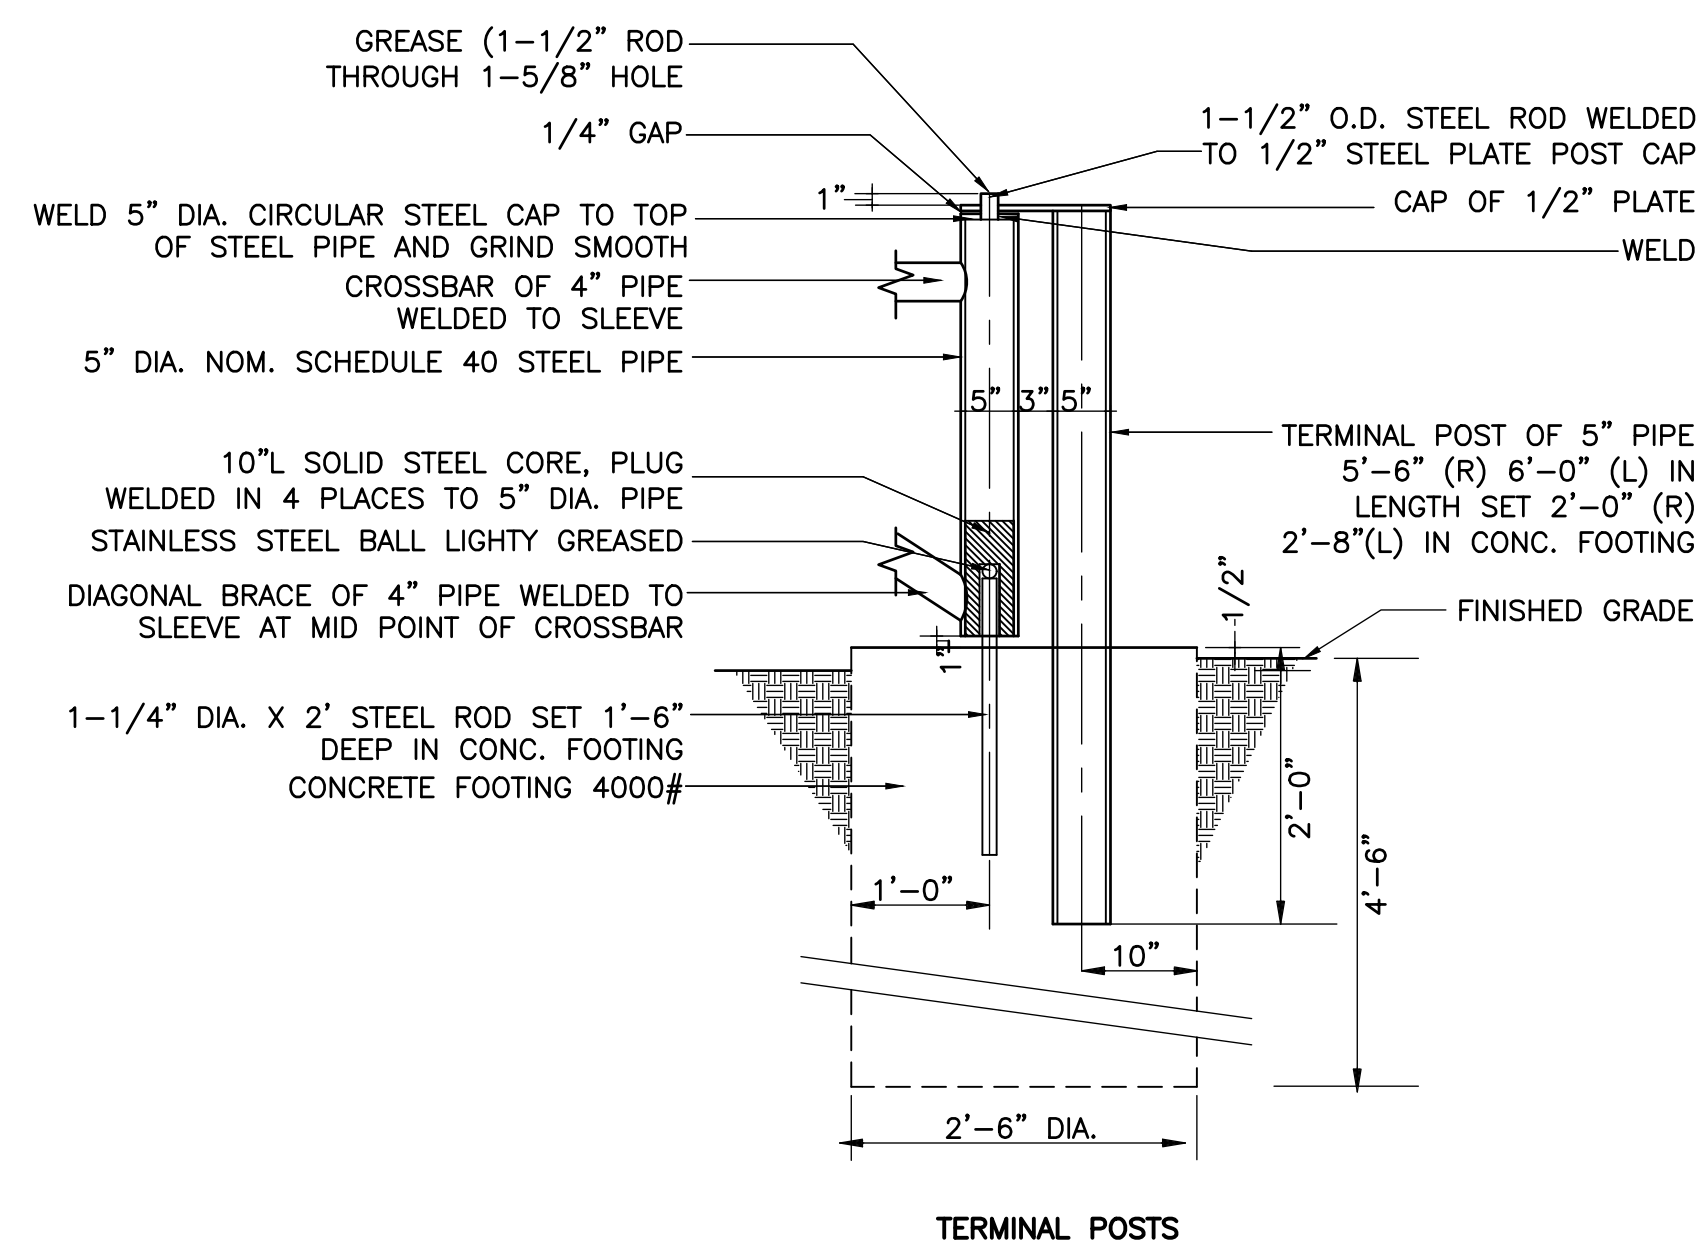
PLAN

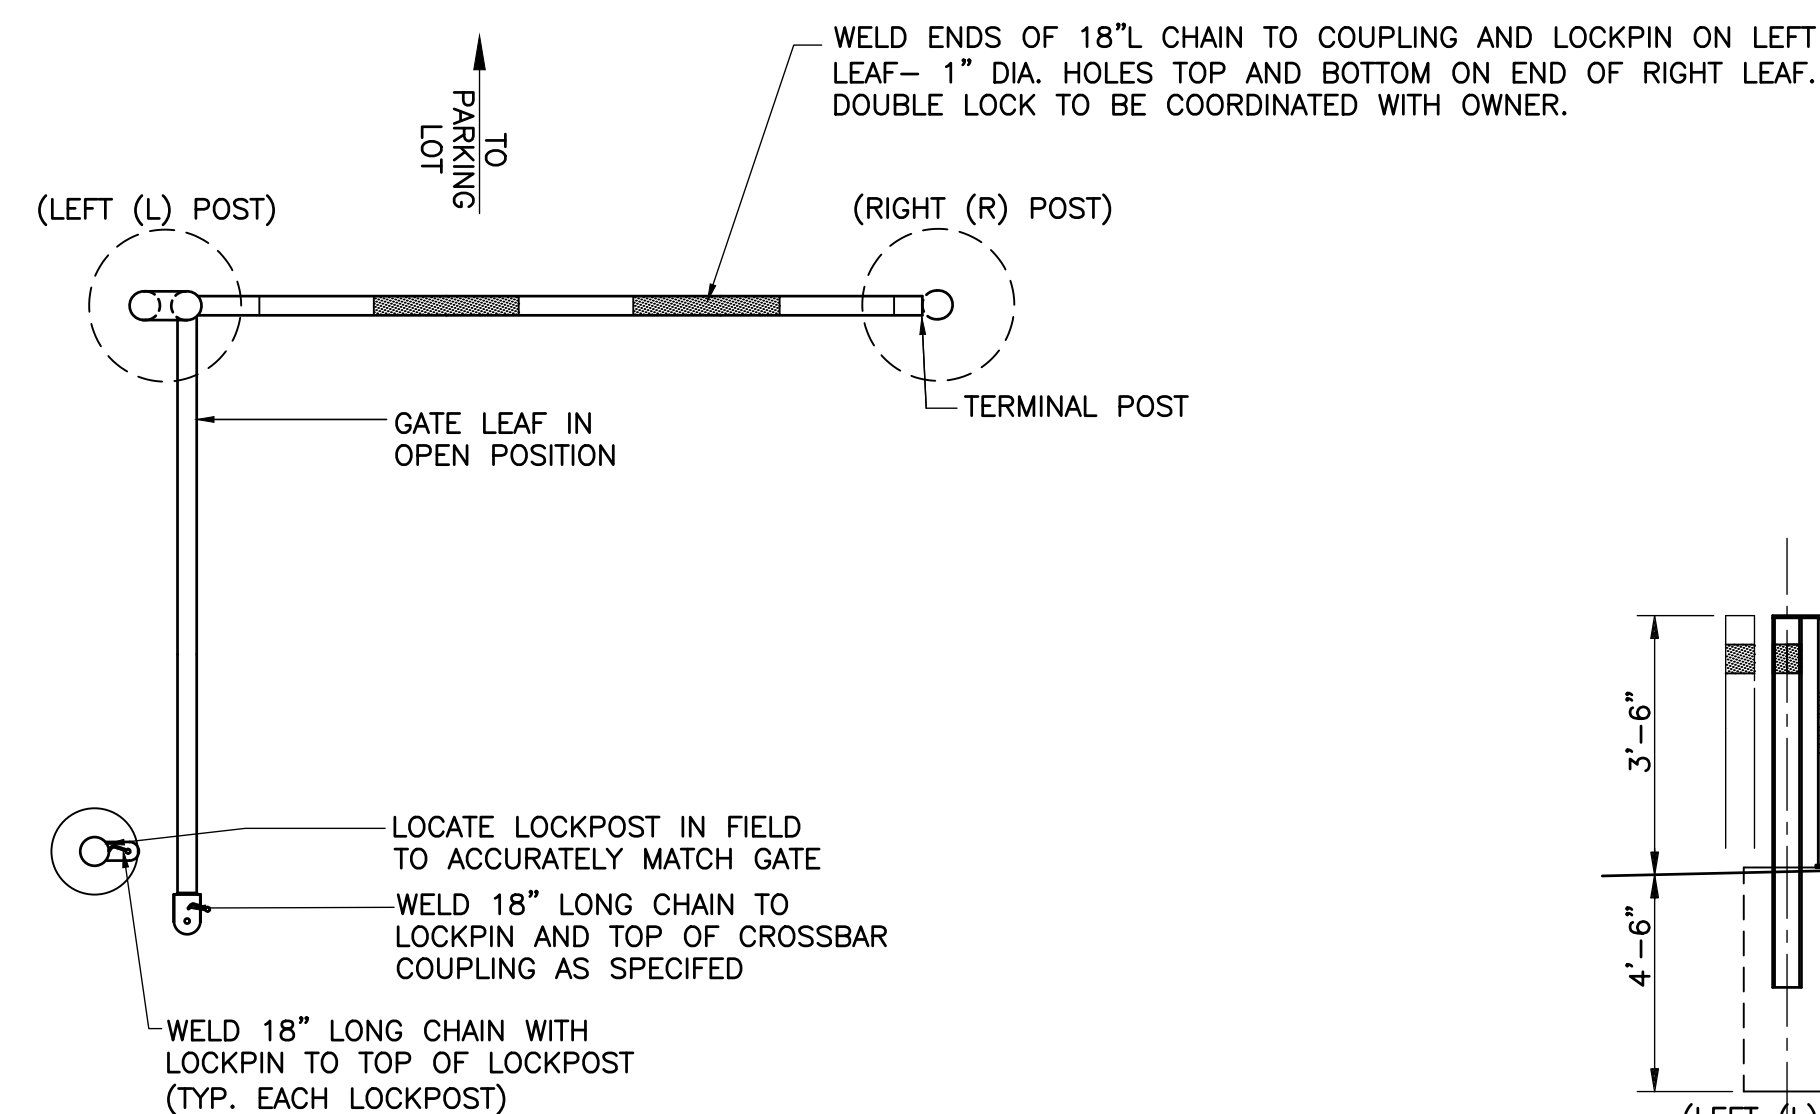


ELEVATION

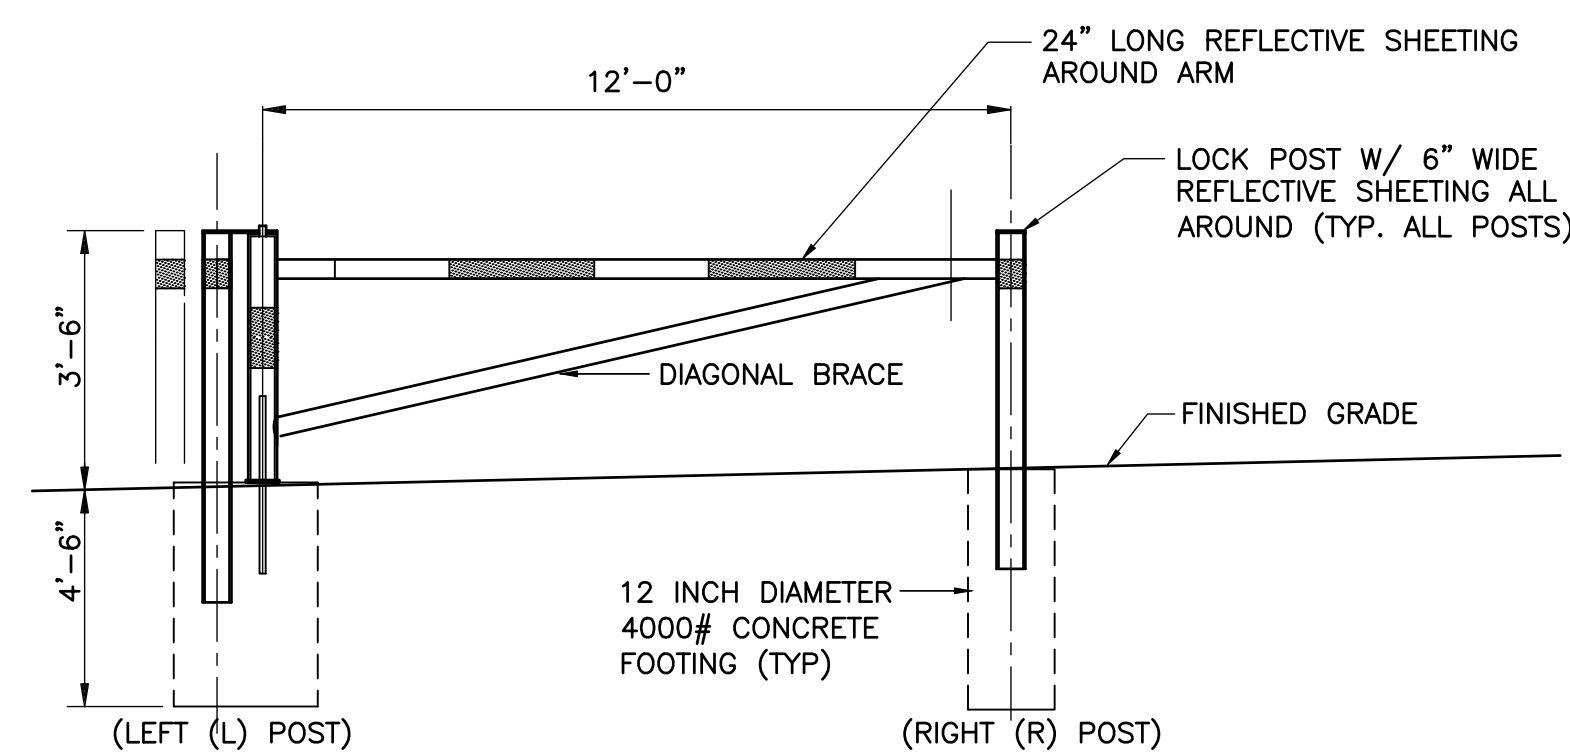


TYPICAL FIELD SECTION  
DETAIL 2  
NOT TO SCALE LD-3

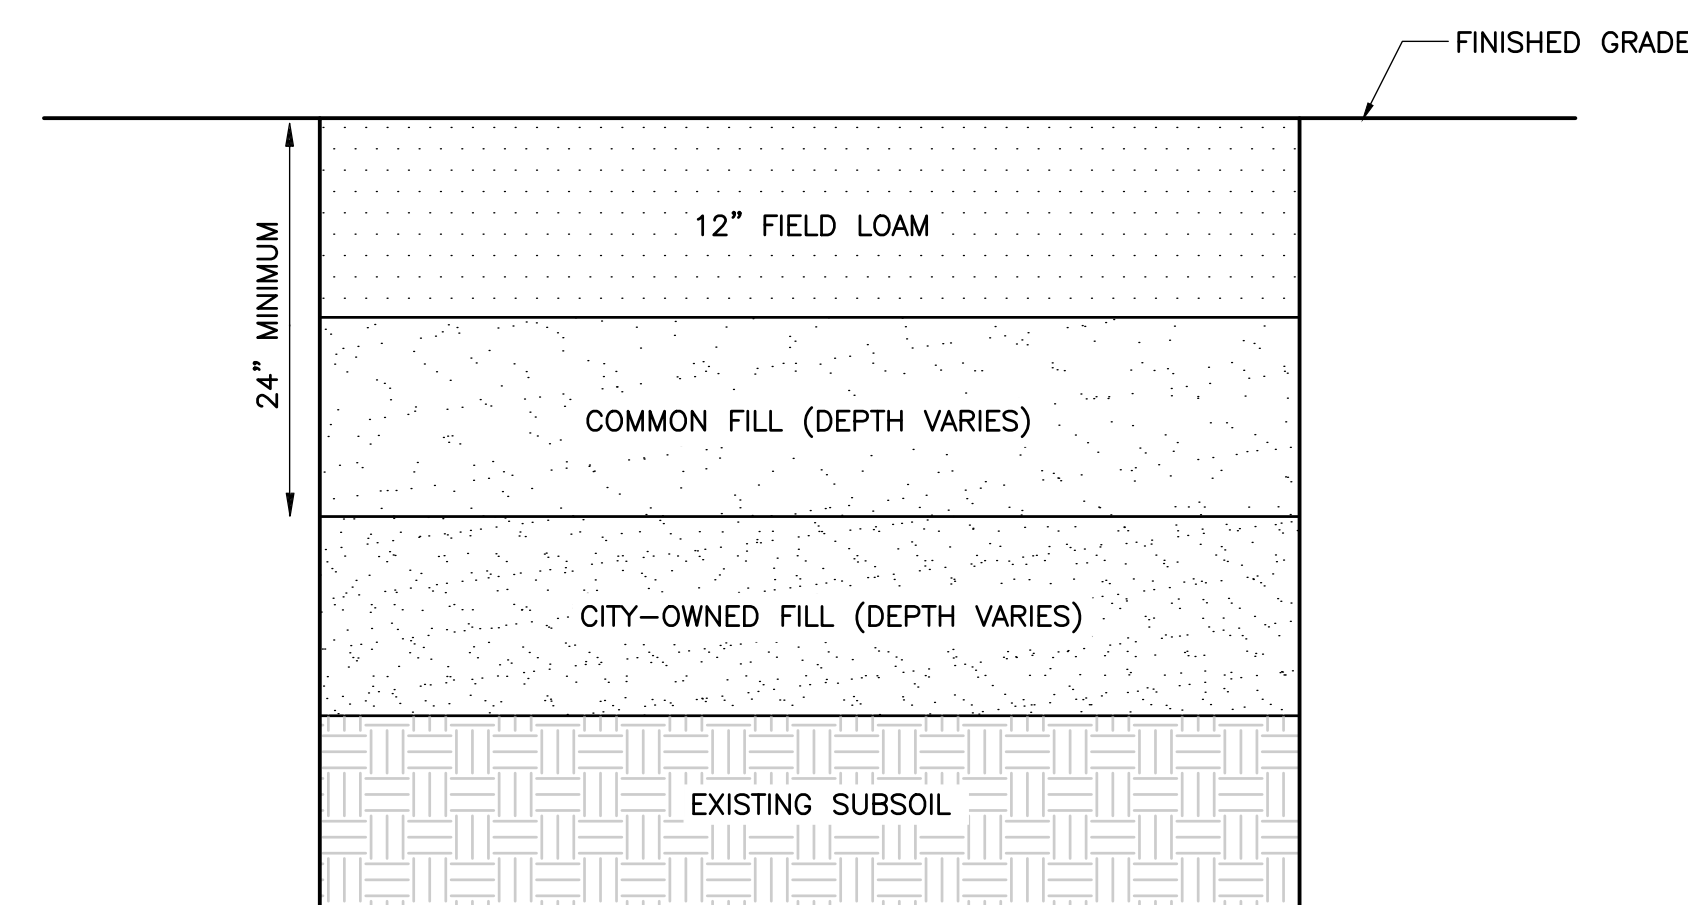

TERMINAL POSTS

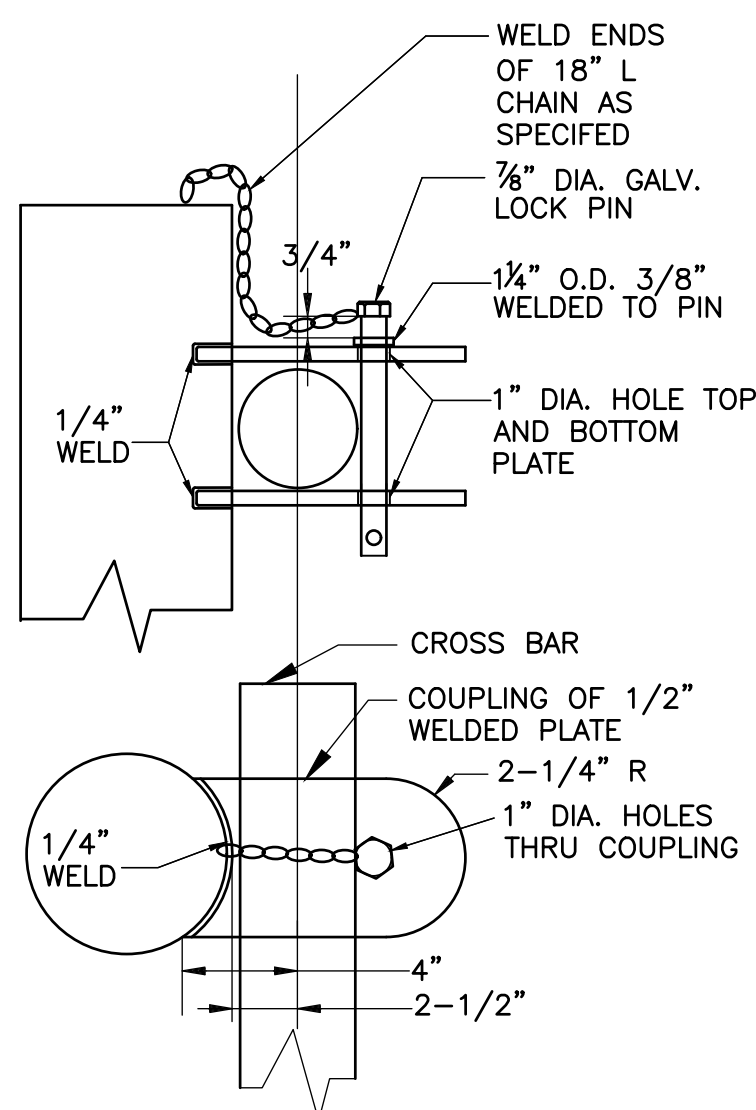


COUPLING AND LOCK

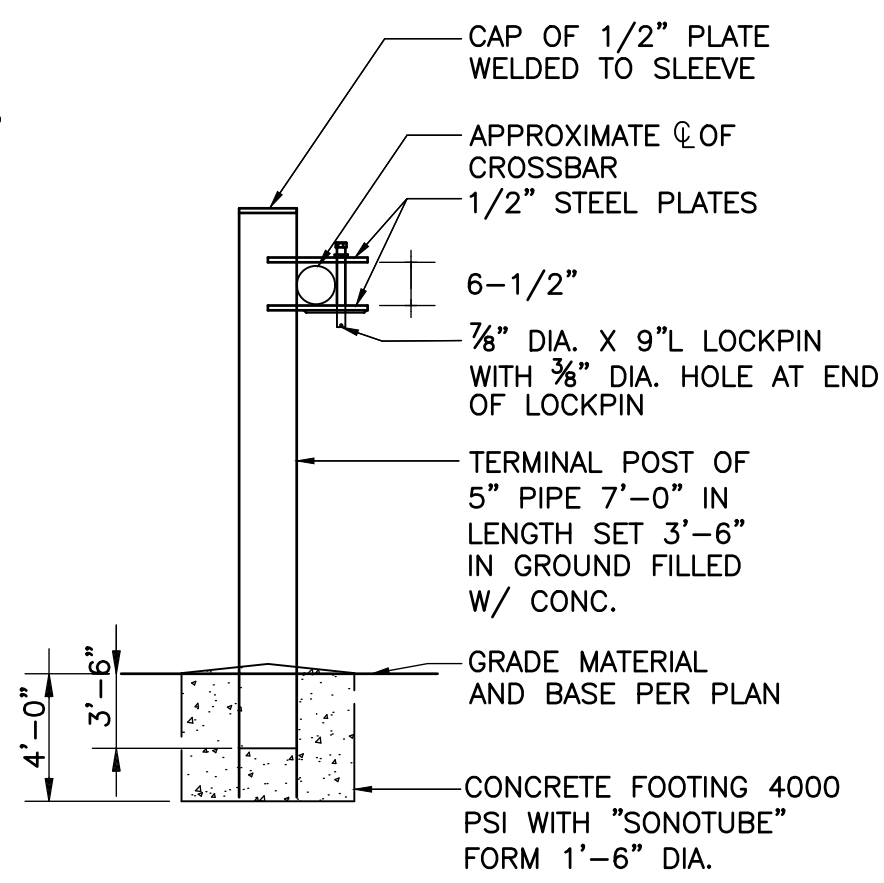

LOCK POST

VEHICLE CONTROL GATE  
DETAIL 1  
NOT TO SCALE LD-3

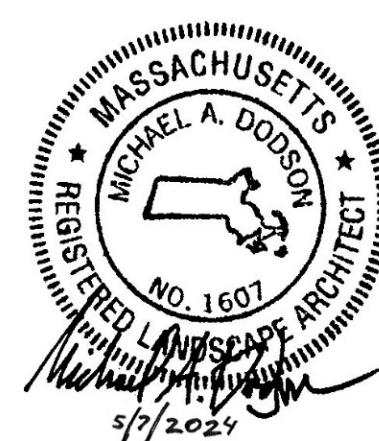

REV. NO.	DATE	DRWN	CHKD	REMARKS

DESIGNED BY: M. DODSON  
 DRAWN BY: M. CARLSON  
 SHEET CHK'D BY: S. LANDGREN  
 CROSS CHK'D BY: M. DODSON  
 APPROVED BY: M. DODSON  
 DATE: MAY 2024



CITY OF NEWTON, MASSACHUSETTS  
 BURR ELEMENTARY SCHOOL  
 FIELD IMPROVEMENTS

CIVIL DETAILS III  
 SHEET NO. LD-3

PROJECT NO. 0865-272529  
 FILE NAME: C000DIII  
 SHEET NO. LD-3  
 ISSUED FOR BID



**ELECTRICAL ABBREVIATIONS**

AFF	ABOVE FINISHED FLOOR
AFG	ABOVE FINISHED GRADE
AUX	AUXILIARY
BKR	BREAKER
CKT	CIRCUIT
COMP	COMPRESSOR
CONT	CONTROL
CP	CONTROL PANEL
DISC	DISCONNECT
DN	DOWN
DWG	DRAWING
ELEC.	ELECTRIC
ELEV	ELEVATION
EM	EMERGENCY
EXIST	EXISTING
EQUIP	EQUIPMENT
FIN. FL.	FINISHED FLOOR
GFEP	GROUND FAULT EQUIPMENT PROTECTION
G. OR GRD.	GROUND
GRND	GROUNDING
H.O.A.	HAND-OFF-AUTO
J-J/B	JUNCTION BOX
LTG	LIGHTING
LTS	LIGHTS
MP	MAIN PANEL
MS	MOTOR STARTER
MTD	MOUNT-MOUNTED
MTG	MOUNTING
N.C.	NORMALLY CLOSED
N.O.	NORMALLY OPEN
NO.	NUMBER
NEC	NATIONAL ELECTRIC CODE
OL	OVER LOAD
REC	RECEPTACLE
RM	ROOM
SW	SWITCH
T/B	TERMINAL BOX
TRANSF	TRANSFORMER
TEL.	TELEPHONE
TEMP.	TEMPERATURE
U.G.	UNDER GROUND
UON	UNLESS OTHERWISE NOTED
V	VOLT
WP	WEATHER PROOF

**GENERAL REQUIREMENTS**

- THE WORK TO BE DONE UNDER THIS PROJECT INCLUDES PROVIDING ALL EQUIPMENT, MATERIALS, LABOR AND SERVICES, AND PERFORMING ALL OPERATIONS FOR COMPLETE AND OPERATING SYSTEMS. ANY WORK NOT SPECIFICALLY COVERED BUT NECESSARY TO COMPLETE THIS INSTALLATION, SHALL BE PROVIDED. ALL EQUIPMENT AND WIRING TO BE NEW AND PROVIDED UNDER THIS CONTRACT UNLESS OTHERWISE NOTED.
- ENTIRE INSTALLATION, INCLUDING MATERIALS, EQUIPMENT AND WORKMANSHIP, SHALL CONFORM TO THE 2023 EDITION OF THE NATIONAL ELECTRIC CODE (NFPA 70 AND 527 CMR) AS WELL AS ALL APPLICABLE LAWS AND REGULATIONS AND REGULATORY BODIES HAVING JURISDICTION OVER THIS WORK.
- THE TERM "FURNISH" SHALL MEAN TO OBTAIN AND SUPPLY TO THE JOB SITE. THE TERM "INSTALL" SHALL MEAN TO FIX IN POSITION AND CONNECT FOR USE. THE TERM "PROVIDE" SHALL MEAN TO FURNISH AND INSTALL.
- ALL NEW ELECTRICAL MATERIAL AND EQUIPMENT SHALL BE LISTED BY UNDERWRITERS' LABORATORIES, INC. (UL) AND BEAR THE UL LABEL.
- PROVIDE ALL SCAFFOLDING, LADDERS, RIGGING, HOISTING, ETC., FOR THIS WORK.
- PROVIDE TECHNICAL MANUALS, PER SPECIFICATIONS, AND GIVE INSTRUCTIONS TO USER FOR ALL EQUIPMENT AND SYSTEMS PROVIDED UNDER THIS CONTRACT AFTER ALL ARE CLEANED AND OPERATING.
- THE DRAWINGS ARE DIAGRAMMATIC AND ALL SPECIALTIES AND APPURTENANCES ARE NOT SHOWN, BUT SHALL BE PROVIDED AS REQUIRED.
- CONTRACTOR SHALL FIELD VERIFY DIMENSIONS OF FINISHED CONSTRUCTION PRIOR TO FABRICATION AND INSTALLATION OF FIXTURES AND EQUIPMENT.
- THE WORK SHALL INCLUDE ALL PANELS, DEVICES, FEEDERS AND BRANCH CIRCUIT WIRING AS REQUIRED FOR THE DISTRIBUTION SYSTEM INDICATED AND CALLED FOR ON THE DRAWINGS, REQUIRED BY SPECIFICATIONS AND AS NECESSARY FOR COMPLETE FUNCTIONAL SYSTEMS PRESENTED AND INTENDED.
- CONTRACTOR SHALL FURNISH ALL MATERIAL, LABOR, TOOLS, EQUIPMENT, CONSUMABLES AND SERVICES REQUIRED FOR OBTAINING, DELIVERY, INSTALLATION, CONNECTION, DISCONNECTION, REMOVAL, RELOCATION, REPAIR, REPLACEMENT, TESTING AND COMMISSIONING OF ALL EQUIPMENT AND DEVICES INCLUDED IN OR NECESSARY FOR THE WORK, AS APPLICABLE.
- ELECTRICAL WORK SHALL INCLUDE ALL REQUIRED CUTTING, PATCHING AND THE FULL RESTORATION OF WALL AND FLOOR STRUCTURE AND SURFACES.
- EXACT ROUTING OF CONDUITS SHALL BE DETERMINED IN THE FIELD.
- CONTRACTOR SHALL VISIT THE SITE AND BECOME FAMILIAR WITH ALL CONDITIONS AND SYSTEMS THAT EFFECT HIS BIDDING AND WORK, AND SHALL PROVIDE VALUE FOR SAME IN HIS BID.
- UPON COMPLETION OF THE ELECTRICAL WORK, CONTRACTOR SHALL TEST THE COMPLETE ELECTRICAL SYSTEM FOR SHORTS, GROUNDS, AND PROPER OPERATION, IN THE PRESENCE OF THE OWNER'S REPRESENTATIVE.
- UPON COMPLETION OF WORK, THE CONTRACTOR SHALL CLEAN AND ADJUST ALL EQUIPMENT AND LIGHTING AND TEST SYSTEMS TO THE SATISFACTION OF OWNER AND ENGINEER. RESULTS SHALL BE SUBMITTED TO THE ENGINEER FOR APPROVAL.
- ALL WORK SHALL BE PERFORMED BY THOSE SKILLED IN THEIR PARTICULAR TRADE IN A NEAT AND WORKMANLIKE MANNER.
- ELECTRICAL WORK SHALL BE DONE AT SUCH A TIME, AND IN SUCH MANNER, AS WILL LEAST INTERFERE WITH THE MAINTENANCE AND OPERATION OF THE SITE'S AND/OR BUILDING'S ACTIVITIES. PROVISIONS SHALL BE MADE TO PERMIT THE USE OF ALL EXISTING ELECTRICAL SYSTEMS AT ALL TIMES. PROVIDE TEMPORARY FACILITIES TO SECURE THESE CONDITIONS AND REMOVE SUCH TEMPORARY FACILITIES WHEN NO LONGER REQUIRED.
- SHUTDOWN WORK SHALL BE SCHEDULED AT SUCH TIME AND IN SUCH MANNER AS DIRECTED BY THE OWNER AND ENGINEER. PROVIDE A MINIMUM ONE WEEK NOTICE.  
  
WHERE ALLOWABLE SHUTDOWN PERIODS CANNOT BE OF DURATION TO ACCOMMODATE ALL OF THE REQUIRED WORK, THE CONTRACTOR SHALL PERFORM THE WORK IN A SERIES OF PREPLANNED STAGES DURING ALLOWABLE SHUTDOWN PERIODS. PROVIDE TEMPORARY FACILITIES TO ALLOW RE-ENERGIZING OF SERVICES BETWEEN WORKING STAGES.

**PROJECT COORDINATION**

- VERIFY FIELD CONDITIONS AT THE SITE AND NOTIFY THE OWNER OF ANY DISCREPANCIES, PRIOR TO COMMENCING WITH THE WORK.

**PROTECTION OF WORK**

- EFFECTIVELY PROTECT ALL MATERIALS AND EQUIPMENT FROM ENVIRONMENTAL AND PHYSICAL DAMAGE UNTIL FINAL ACCEPTANCE. CLOSE AND PROTECT ALL OPENINGS DURING CONSTRUCTION. PROVIDE NEW MATERIALS AND EQUIPMENT TO REPLACE ITEMS DAMAGED.

**RACEWAYS**

- ALL EXPOSED AND CONCEALED CONDUIT SHALL BE HOT DIP GALVANIZED RIGID STEEL UNLESS OTHERWISE NOTED.
- CONDUIT SHALL BE RUN AT RIGHT ANGLES AND PARALLEL TO BUILDING LINES, SHALL BE NEATLY RACKED, AND SECURELY FASTENED. JUNCTION BOXES SHALL BE PROVIDED WHERE REQUIRED TO FACILITATE INSTALLATION OF WIRES.
- ALL CONDUIT AND ELECTRICAL EQUIPMENT SHALL BE SUPPORTED FROM THE BUILDING STRUCTURE IN AN APPROVED MANNER.
- ARRANGEMENT OF CONDUIT AND EQUIPMENT SHALL BE AS REQUIRED TO AVOID INTERFERENCES.
- FOR CONDUITS CROSSING EXPANSION JOINTS, PROVIDE EXPANSION FITTINGS FOR SIZE 1-1/4", AND LARGER. PROVIDE SECTIONS OF FLEXIBLE CONDUIT WITH GROUNDING JUMPERS FOR SIZES 1" AND SMALLER.
- UNDERGROUND CONDUITS SHALL BE MINIMUM 1".
- INSTALL DETECTABLE UNDERGROUND TAPES FOR THE PROTECTION, LOCATION, AND IDENTIFICATION OF UNDERGROUND CONDUIT INSTALLATIONS.
- CONDUITS WITHOUT DESIGNATED SIZE SHALL BE 3/4".
- CONDUITS TERMINATING IN NEMA 4 OR NEMA 4X ENCLOSURES SHALL BE TERMINATED WITH MYERS TYPE HUBS.
- LIQUID TIGHT FLEXIBLE CONDUIT SHALL BE USED FOR ALL MOTOR TERMINATIONS AND EQUIPMENT WHERE VIBRATION MAY BE PRESENT.
- ALL CONDUIT WHICH MAY UNDER ANY CIRCUMSTANCE CONTAIN LIQUIDS SUCH AS WATER, CONDENSATION, LIQUID CHEMICALS, ETC., SHALL BE ARRANGED TO DRAIN AWAY FROM THE EQUIPMENT SERVED. IF CONDUIT DRAINAGE IS NOT POSSIBLE, CONDUIT SEALS SHALL BE USED TO PLUG THE CONDUITS.
- CONDUIT HANGERS AND SUPPORTS SHALL BE THE SAME MATERIAL AS CONDUIT, ATTACHED TO STRUCTURAL STEEL BY MEANS OF BEAM OR CHANNEL CLAMPS. WHERE ATTACHED TO CONCRETE SURFACES, CONCRETE INSERTS OF THE SPOT TYPE SHALL BE PROVIDED.
- MISCELLANEOUS STEEL FOR THE SUPPORT OF FIXTURES, BOXES, TRANSFORMERS, STARTERS, CONTACTORS, PANELS AND CONDUIT SHALL BE FURNISHED AND INSTALLED.
- STEEL CHANNELS, FLAT IRON AND CHANNEL IRON SHALL BE FURNISHED AND INSTALLED FOR THE SUPPORT OF ALL ELECTRICAL EQUIPMENT AND DEVICES, WHERE REQUIRED, INCLUDING ALL ANCHORS, INSERTS, BOLTS, NUTS, WASHERS, ETC. FOR A RIGID INSTALLATION.

**BOXES AND ENCLOSURES**

- THE ELECTRICAL PANELBOARD SHALL BE NEMA 3R. ALL OTHER ELECTRICAL BOXES AND ENCLOSURES SHALL BE NEMA 4.
- MOUNTING HEIGHTS OF EQUIPMENT AND DEVICES SHALL BE AS INDICATED ON THE DRAWINGS. WHERE MOUNTING HEIGHTS ARE NOT GIVEN ON THE DRAWINGS, UTILIZE THE FOLLOWING MOUNTING HEIGHTS (ALL DIMENSIONS TO CENTERLINE OF BOX):  
A. LIGHTING SWITCHES AND CONTROLS - 48" A.F.F.  
B. PANELBOARDS AND CABINETS - 78" TO TOP OF ENCLOSURE
- WHERE MULTIPLE SWITCHES AND RECEPTACLES ARE INDICATED AT THE SAME LOCATION, THEY SHALL BE MOUNTED BEHIND A COMMON FACEPLATE.
- PROVIDE WHILE IN USE METALLIC COVERS FOR ALL OUTDOOR AND ALL GROUND FAULT CIRCUIT INTERRUPTER (GFCI) RECEPTACLES.

**WIRING**

- INSTALL EACH THREE PHASE CIRCUIT IN A SEPARATE CONDUIT.
- WHERE EQUIPMENT, LIGHTING FIXTURES AND WIRING DEVICES ARE SHOWN WITH CIRCUIT NUMBERS ONLY, THE MINIMUM BRANCH CIRCUITING REQUIREMENTS SHALL BE AS FOLLOWS:  
A. LIGHTING FIXTURES - (2)#12 & #12 GND.  
B. RECEPTACLES - (2)#12 & #12 GND.  
C. HOMERUNS TO PANEL BOARDS SHALL CONTAIN NO MORE THAN THREE CIRCUITS.
- WIRE SHALL BE XHHW-2 TYPE. WIRE SIZES SHALL BE INCREASED TO COMPENSATE FOR VOLTAGE DROP. INCREASE WIRE SIZE TO COMPENSATE FOR VOLTAGE DROP FOR 20 AMP CIRCUITS AS FOLLOWS:  
A. 120V CIRCUITS LONGER THAN 80' SHALL UTILIZE MIN. #10 AWG.  
B. 208V CIRCUITS LONGER THAN 150' SHALL UTILIZE MIN. #10 AWG.

**GROUNDING**

- PROVIDE AN EQUIPMENT GROUNDING CONDUCTOR IN ALL RACEWAYS AND WIREWAYS, SIZED PER NFPA 70.


**PANELBOARDS**

- PROVIDE A NEW TYPED CIRCUIT DIRECTORY FOR EACH PANEL AFFECTED BY THE ELECTRICAL WORK.
- NOT USED
- CIRCUIT NUMBERS SHOWN SHALL BE ADHERED TO IN GENERAL, EXCEPT WHEN FIELD CONDITIONS, SHOP DRAWINGS OF CONNECTED EQUIPMENT, OR APPROVED FIELD CHANGES REQUIRE CHANGE IN CIRCUITING.
- ALL CIRCUIT NUMBERS SHALL BE INDICATED ON RESPECTIVE PLANS AND PANEL CIRCUIT SCHEDULES PREPARED FOR RECORD DRAWINGS.

PLAN	DESCRIPTION
	POWER PANELBOARD (PP-#) OR DISTRIBUTION PANELBOARD (DP-#) SHOWN ON PLAN PER ACTUAL PANEL DIMENSIONS
	CONTROL PANEL
	CONDUIT CONCEALED IN WALL, IN SLAB ABOVE, OR ABOVE CEILING.
	CONDUIT CONCEALED IN OR BELOW FLOOR OR UNDERGROUND.
	DENOTES A QUANTITY OF TWO (2) 3-INCH CONDUITS EACH CONTAINING THREE NO. 3/0 AWG CONDUCTORS AND 1 NO. 2 AWG GROUND CONDUCTOR.
(3) 4"C.	THREE 4-INCH CONDUITS
	JUNCTION BOX
	GROUND SYSTEM GRID OR LOOP, 36" BELOW FINISHED GRADE UNLESS OTHERWISE NOTED.
	EXOTHERMIC WELD CONNECTION
	3/4" x 10'-0" GROUND ROD. UNLESS SPECIFIED OTHERWISE.
	ABOVE GROUND PULLBOX




**SYMBOL WHERE THERE IS A DETAIL**

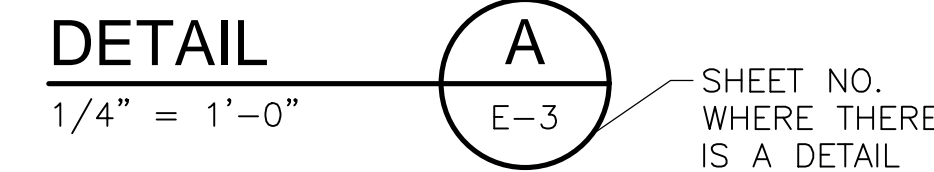


**SYMBOL WHERE DETAIL IS DRAWN**

**DETAIL SYMBOL**

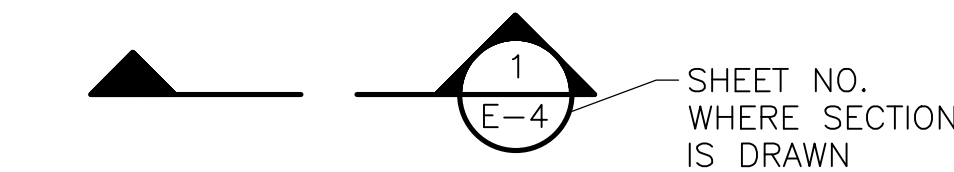


**SYMBOL WHERE THERE IS A SECTION**

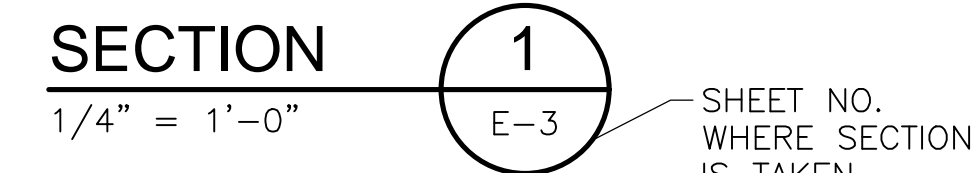

**SYMBOL WHERE SECTION IS DRAWN**

**SECTION SYMBOL**

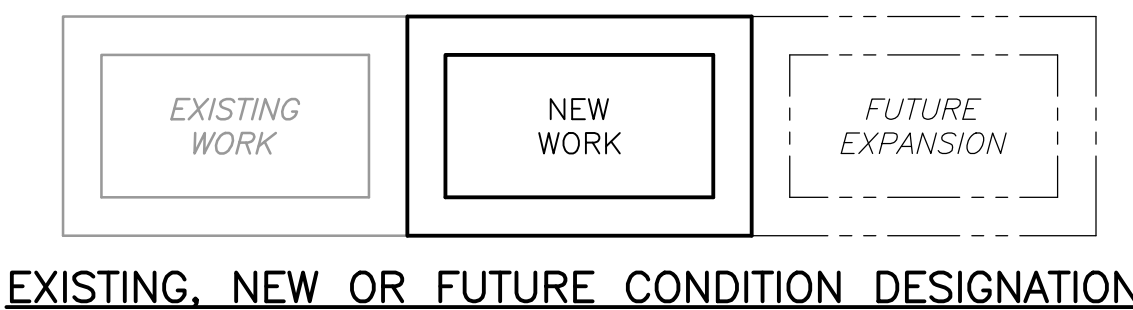

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REV. NO.	DATE	DRWN	CHKD	REMARKS

DESIGNED BY:	N. DILUISO
DRAWN BY:	N. DILUISO
SHEET CHK'D BY:	S. JONG
CROSS CHK'D BY:	M. DODSON
APPROVED BY:	S. JONG
DATE:	MAY 2024

75 State Street  
Boston, MA 02109  
Tel: (617) 452-6000

CITY OF NEWTON, MASSACHUSETTS  
**BURR ELEMENTARY SCHOOL  
FIELD IMPROVEMENTS**

**ELECTRICAL LEGEND**

SHEET NO.  
**E-1**

PROJECT NO. 0865-272529  
FILE NAME: E001NFLG

ISSUED FOR BID



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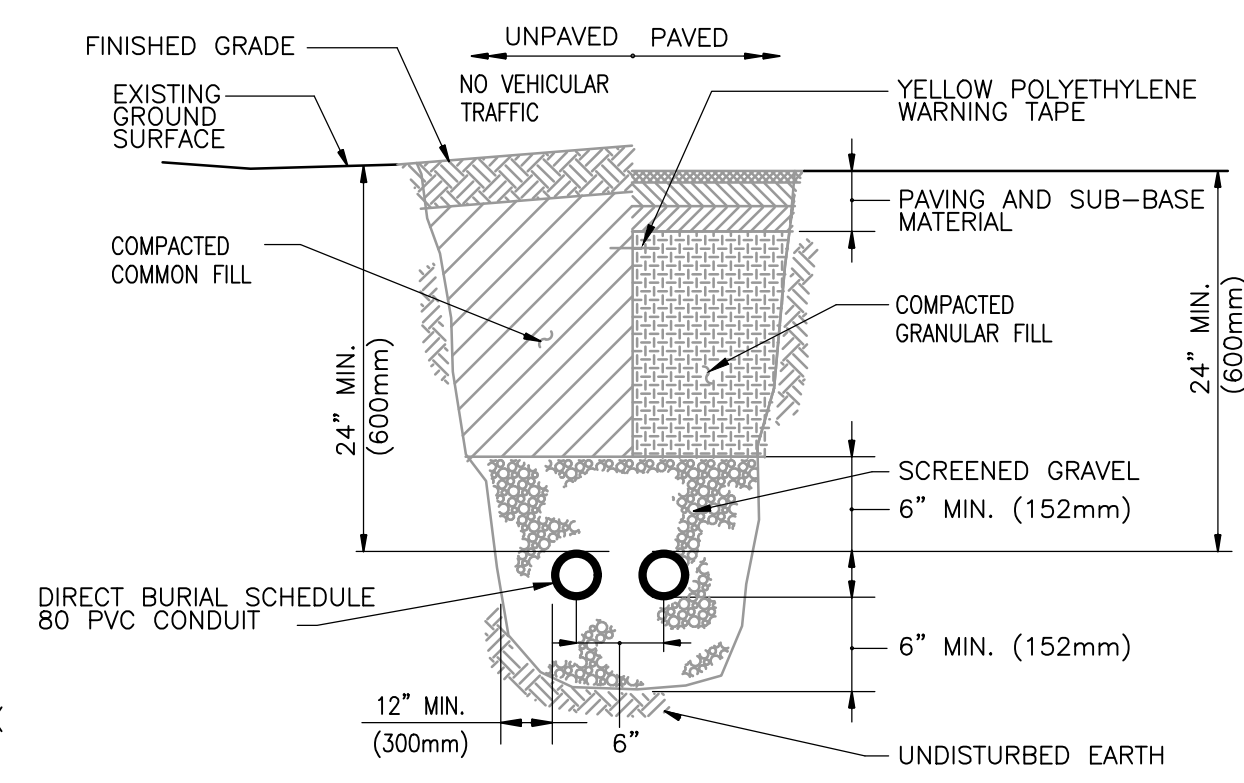
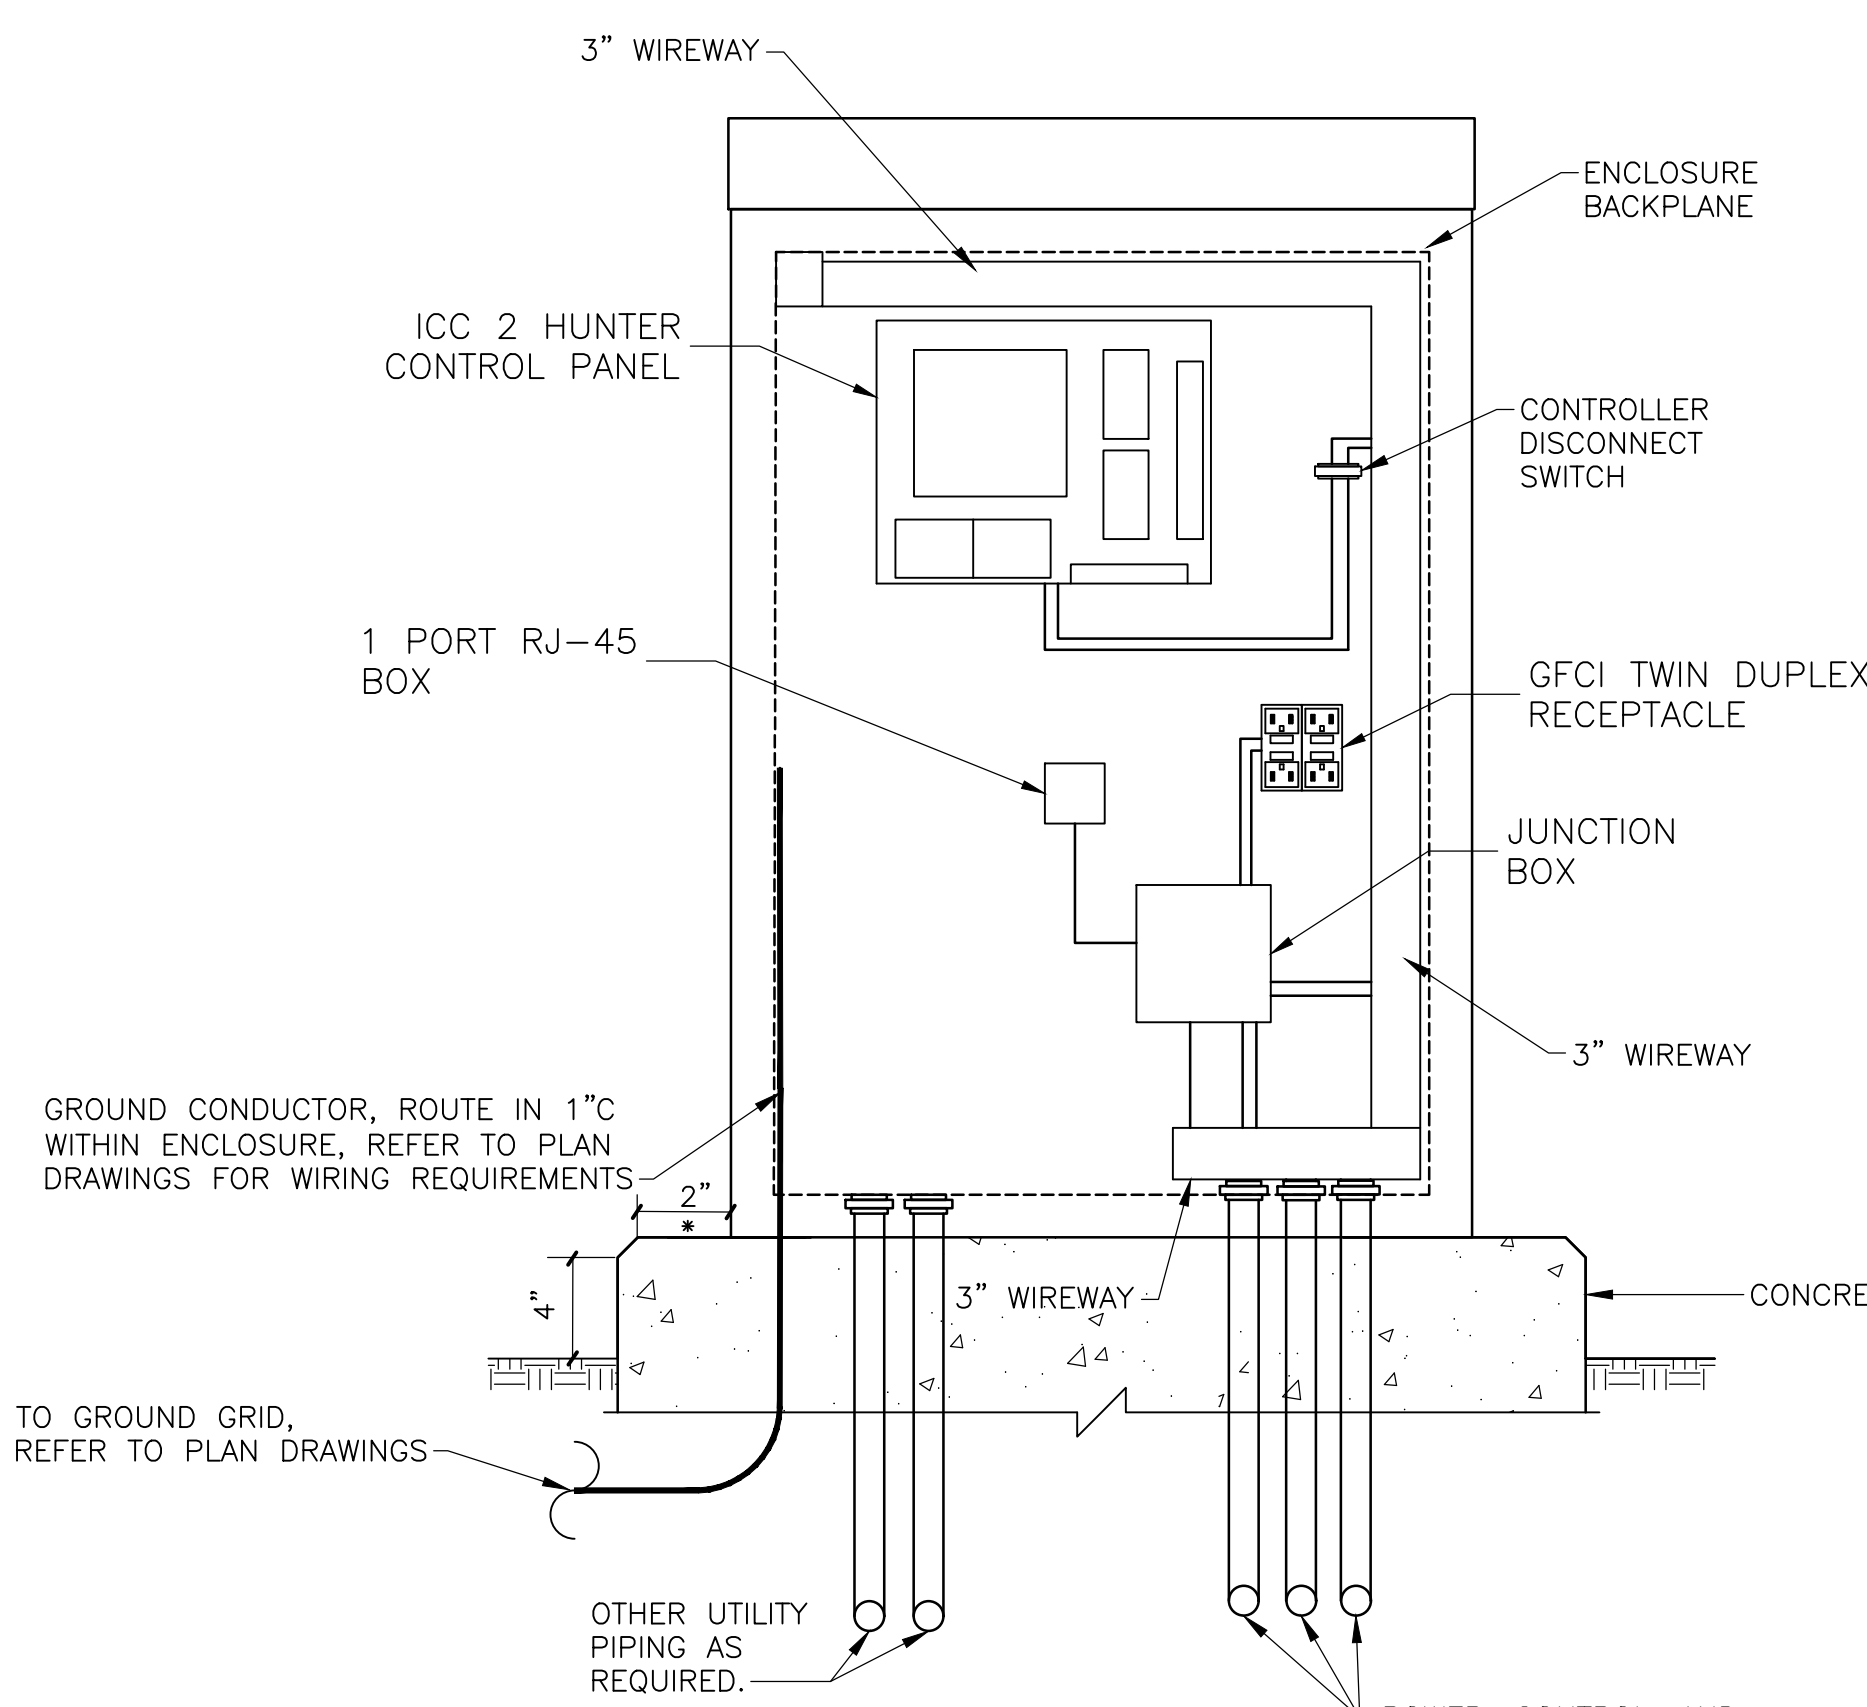
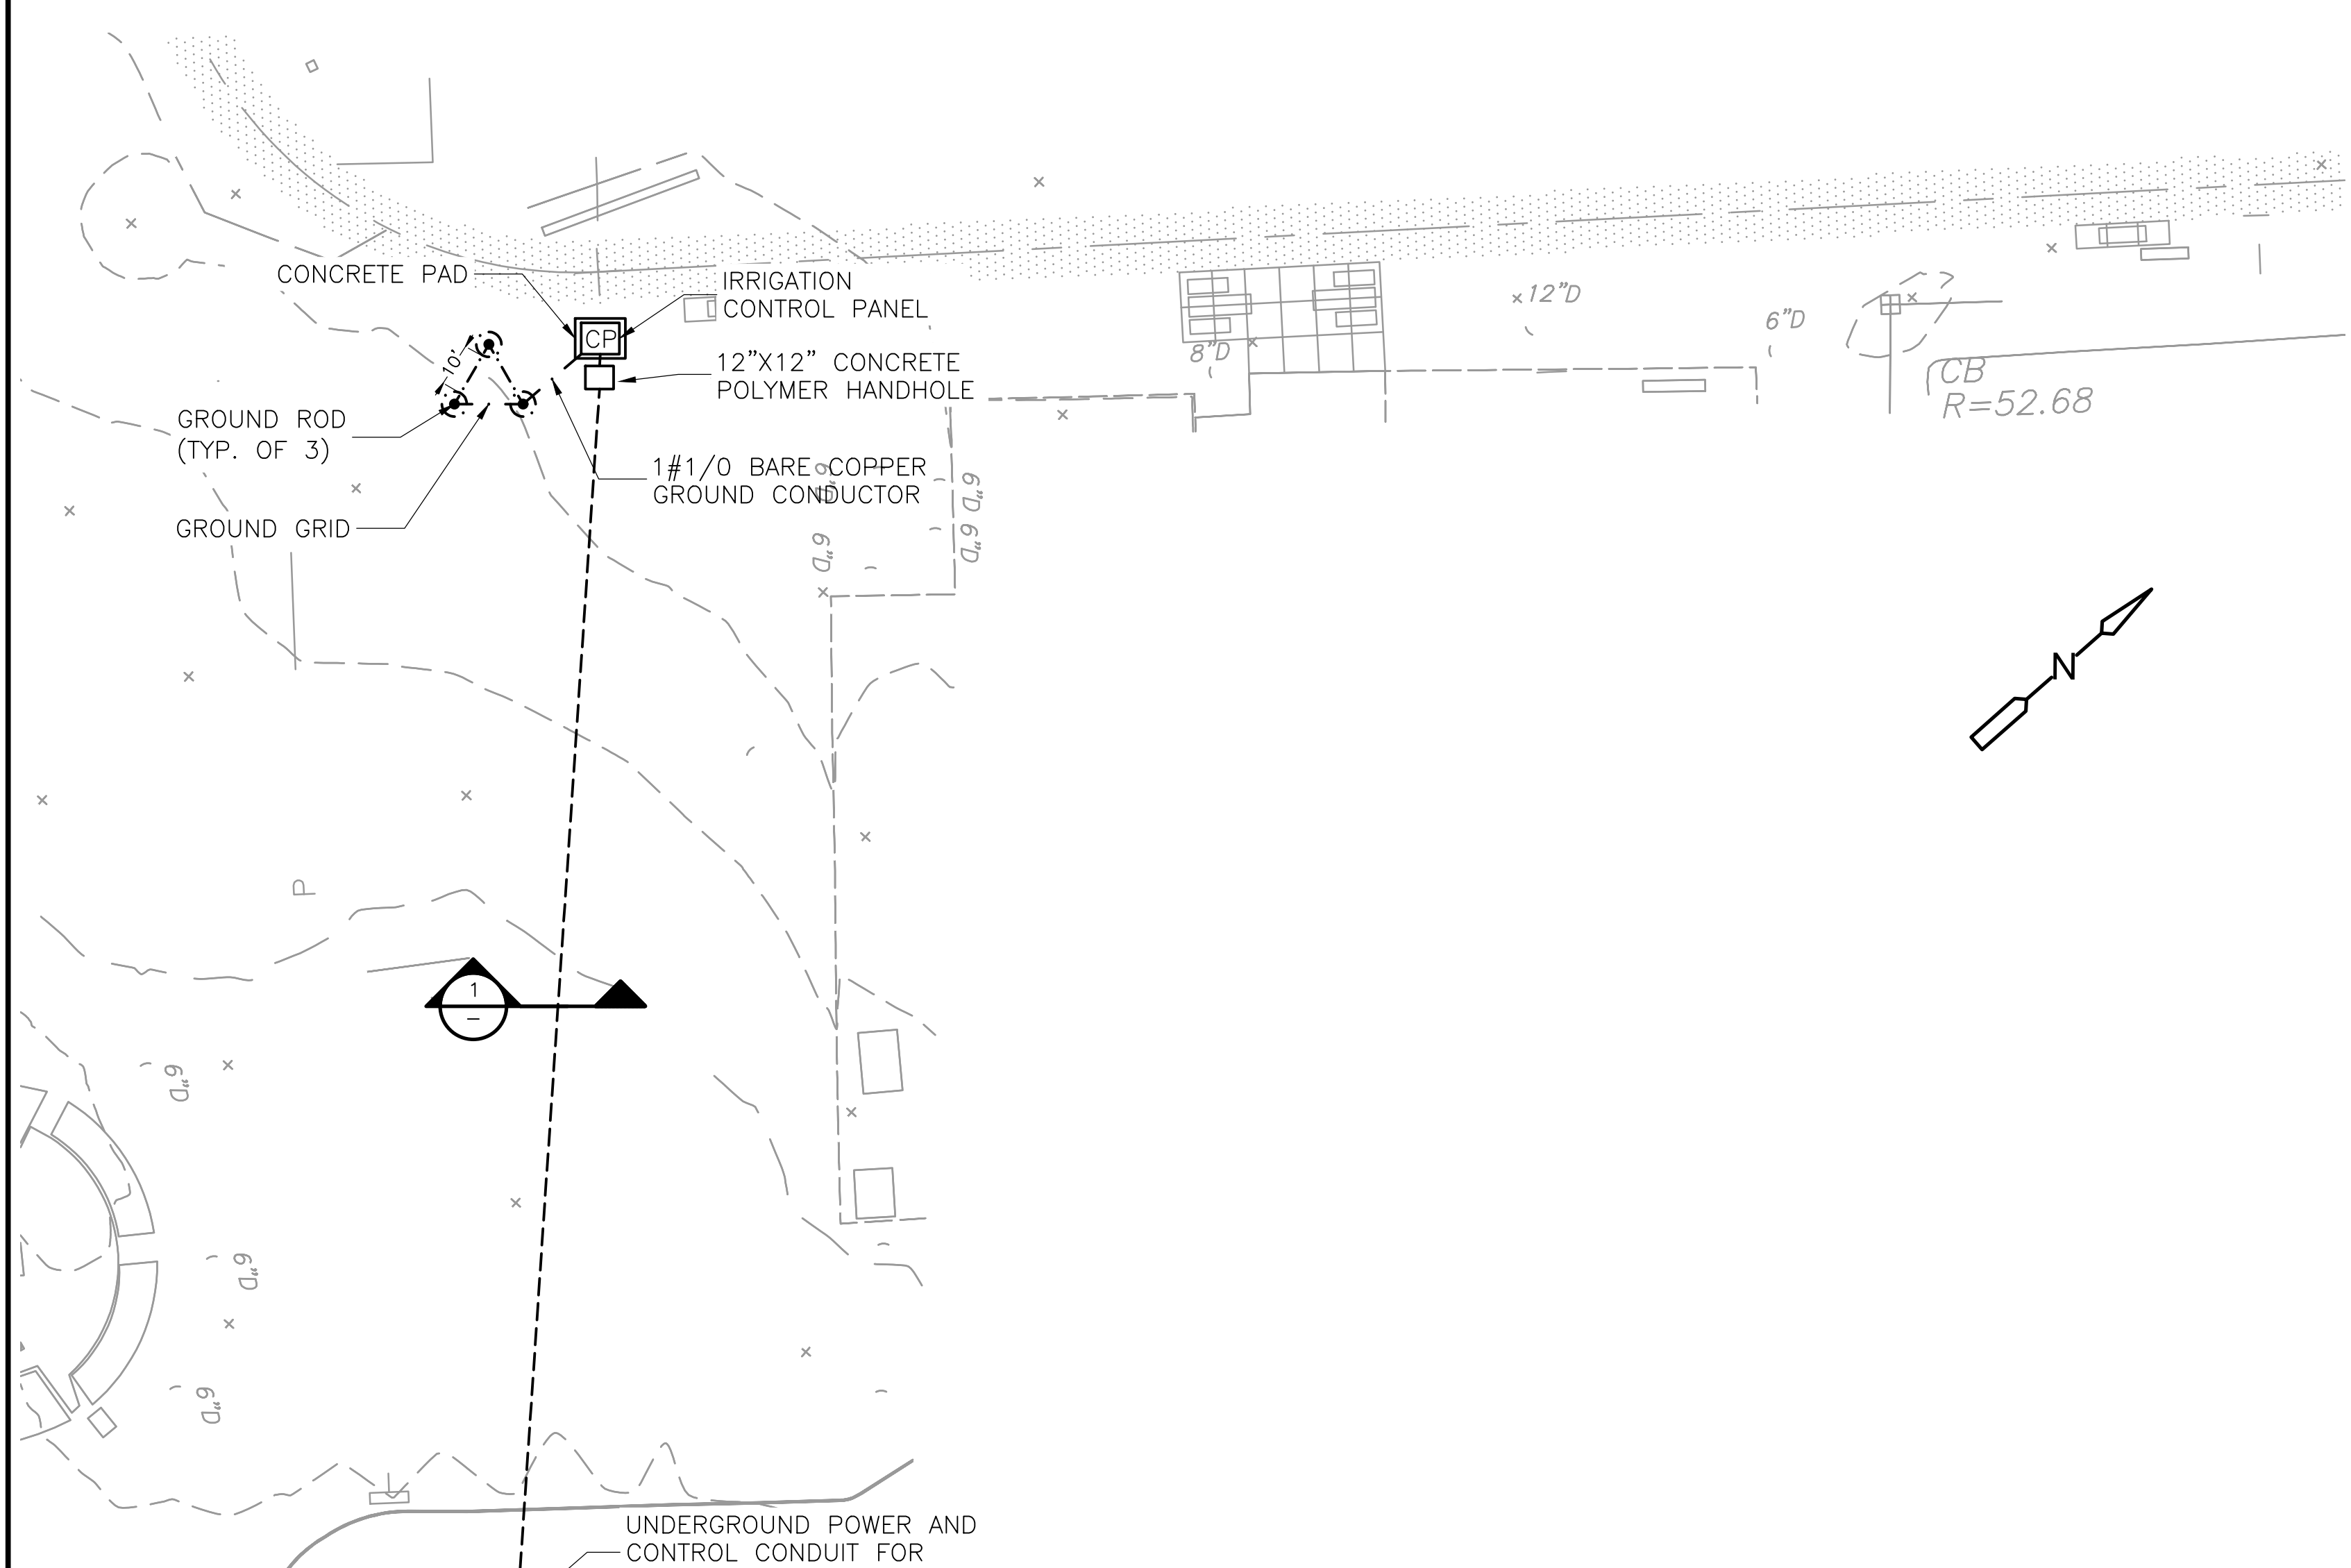
CONDUIT AND WIRE LEGEND (NUMBERS REFERENCE THIS SHEET ONLY)	
NO.	DESCRIPTION
P1	2" C., 2#10, 1#10G
P2	3/4" C., 2#10, 1#10G
C1	2" C., 1 CAT 7 CABLE
C2	1" C., 1 CAT 7 CABLE
S	2" C., SPARE

P1
C1
S

**UNDERGROUND CONDUIT SCHEDULE**

**SECTION 1**


NTS



**TYPICAL DIRECT BURIAL CONDUIT INSTALLATION**

**DETAIL C**


NTS

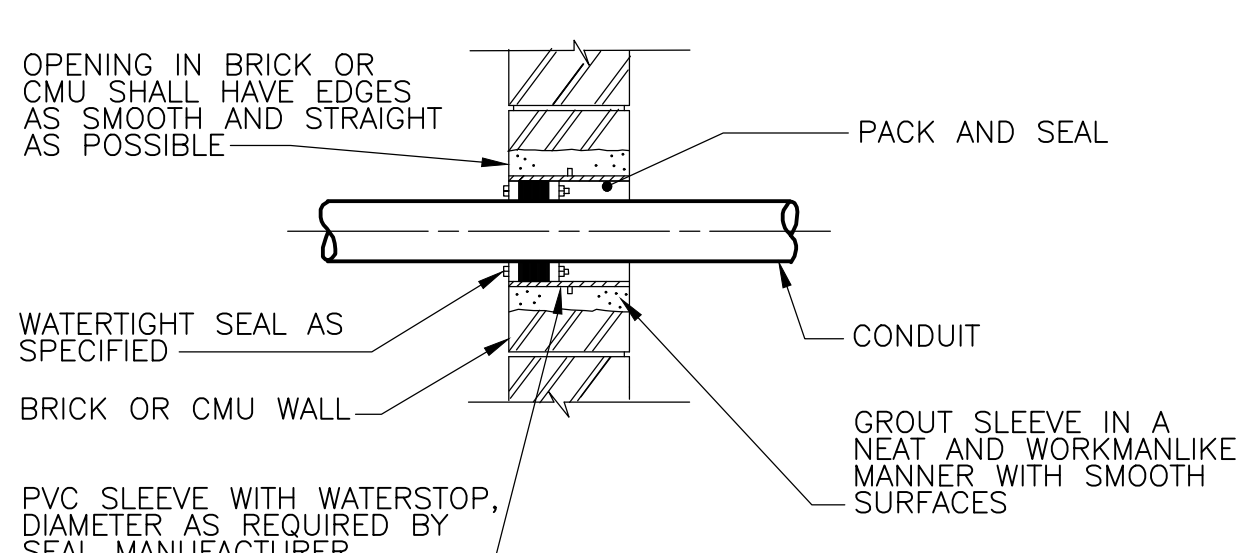

**CONDUIT PENETRATION**

**DETAIL B**

NTS

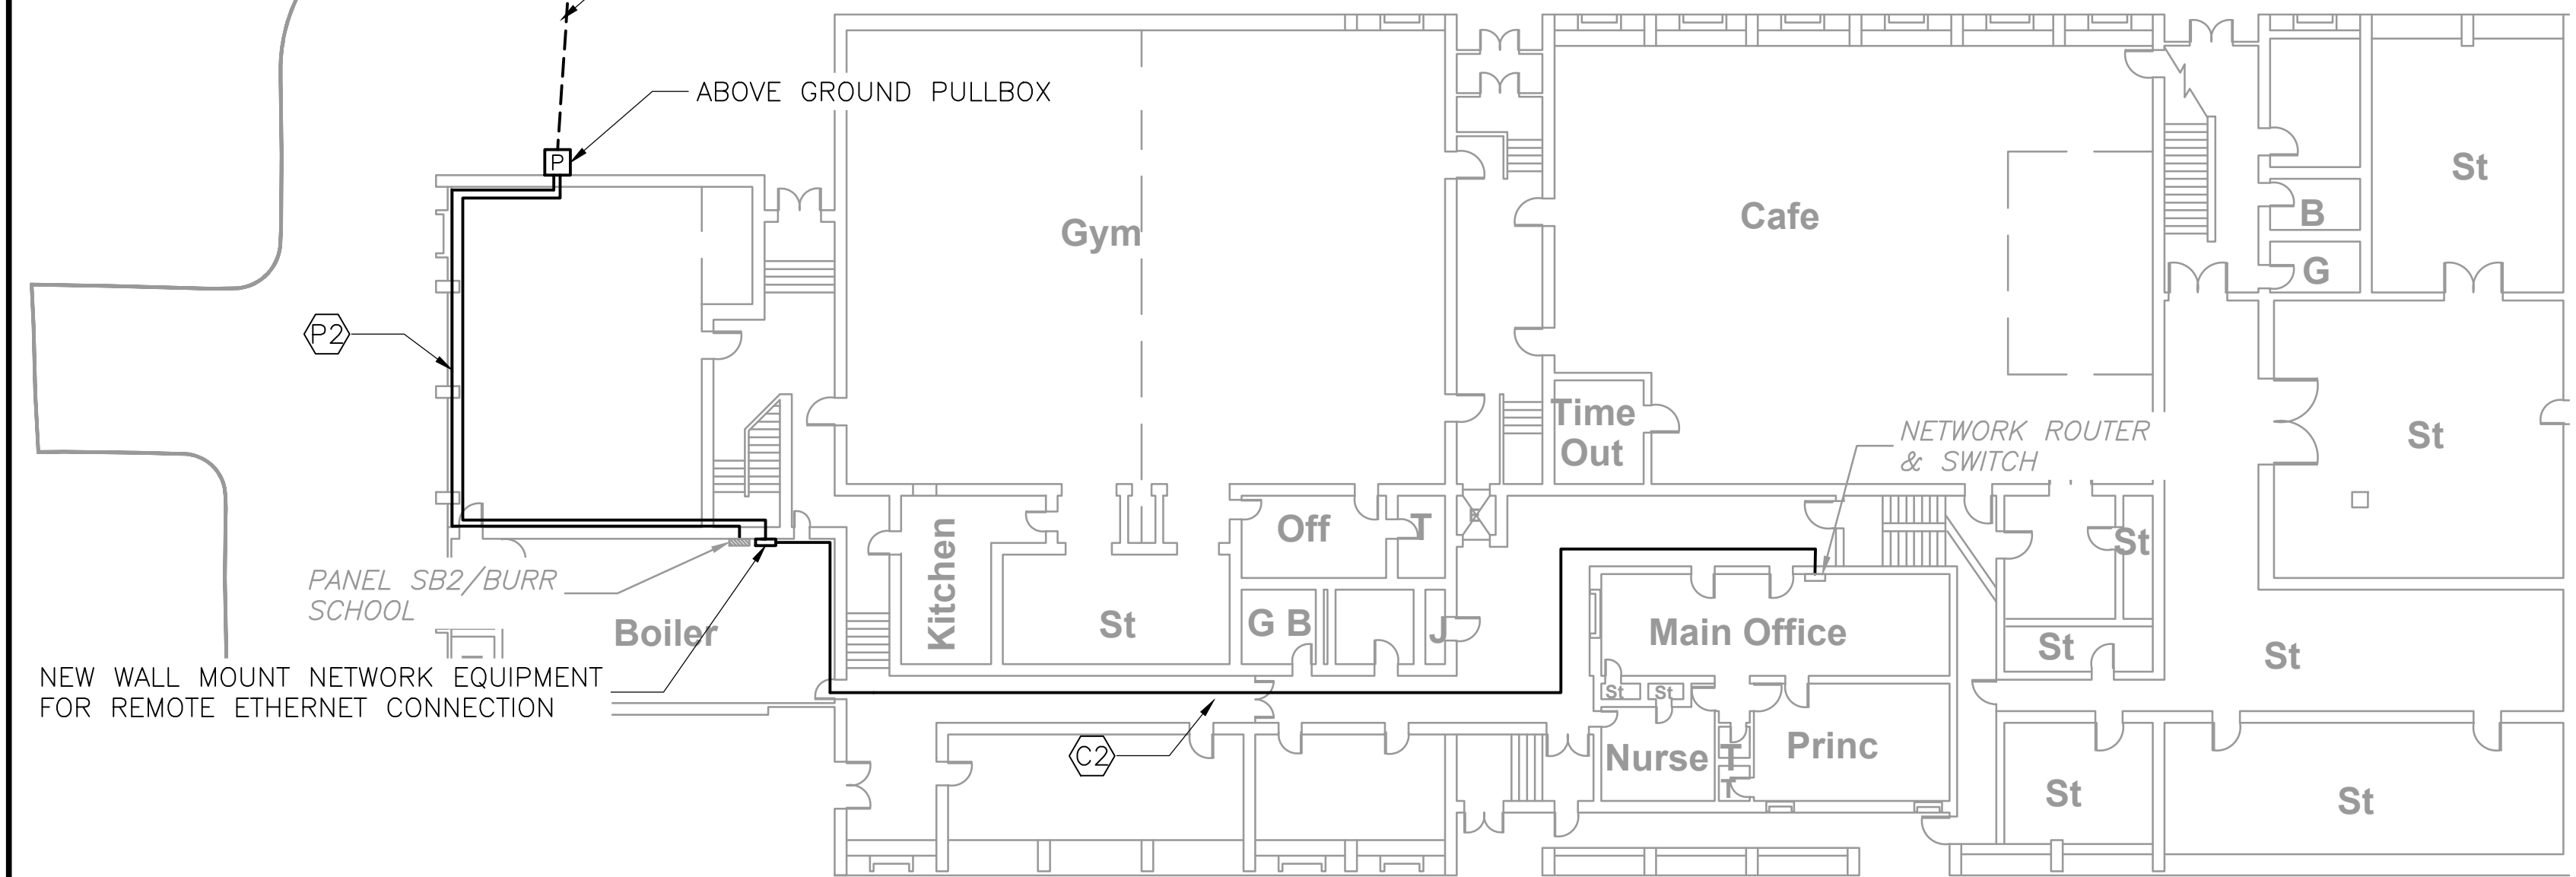

**ELECTRICAL SITE PLAN**

**PLAN**

3/4" = 1'

**CABINET INSIDE VIEW**

**ELECTRICAL CABINET**

**DETAIL A**

N.T.S.

125 AMP MAIN BREAKER 125 AMP BUS RATING 208/120 VOLTS					30 POLES 3 PHASE 4 WIRE 60 Hz.					Burr School SB-2 22 KA SHORT CIRCUIT RATING ELECTRONIC GRADE: NO					LOCATION: BURR SCHOOL BOILER ROOM ENCLOSURE RATING: NEMA 1 MOUNTING SURFACE				
CIRCUIT NO.	DESCRIPTION	PHASE A	PHASE B	PHASE C	LOAD KVA	BREAKER AMPS/POLES	NOTES	CIRCUIT NO.	DESCRIPTION	PHASE A	PHASE B	PHASE C	LOAD KVA	BREAKER AMPS/POLES	NOTES				
1	GENERATOR DAMPERS					20 / 1		2	UNKNOWN					20 / 1					
3	BOILER FANS					15 / 2		4	VFD #1 FOR PUMP					60 / 3					
5								6											
7								8											
9	BOILER #1					30 / 3		10	FIRE ALARM					20 / 1					
11								12	UNKNOWN					20 / 1					
13	UNKNOWN					20 / 1		14	IRRIGATION CONTROL PANEL					20 / 1	7				
15	SPARE					/ 1		16	SPARE					/ 1					
17	SPARE					/ 1		18	SPARE					/ 1					
19	SPARE					/ 1		20	SPARE					/ 1					
21	SPARE					/ 1		22	SPARE					/ 1					
23	SPARE					/ 1		24	SPARE					/ 1					
25	SPARE					/ 1		26	SPARE					/ 1					
27	SPARE					/ 1		28	SPARE					/ 1					
29	SPARE					/ 1		30	SPARE					/ 1					
TOTAL PHASE KVA THIS SIDE		0.33	0.33	0.33				TOTAL PHASE KVA THIS SIDE		0	0	0							
								TOTAL KVA PER PHASE		0.33	0.33	0.33							
								TOTAL THREE PHASE KVA		0.99									

NOTES:

1. PROVIDE LOCKING HARDWARE	2. 15 mA GROUND FAULT INTERRUPTER (GFI) CIRCUIT BREAKER
3. 30 mA GFCI CIRCUIT BREAKER FOR EQUIPMENT PROTECTION ONLY (HEAT TRACE)	4. PROVIDE LOCKING HARDWARE & PAINT BREAKER HANDLE RED (FACP)
5. BRANCH CIRCUIT WIRING: 3/4" C, 2#12 & 1#12G	6. BRANCH CIRCUIT WIRING: 3/4" C, 2#10 & 1#10G
7. REFER TO CONDUIT AND WIRE LEGEND	8.



REV. NO.	DATE	DRWN	CHKD	REMARKS

DESIGNED BY: N. DILUISSO  
 DRAWN BY: N. DILUISSO  
 SHEET CHK'D BY: S. JONG  
 CROSS CHK'D BY: M. DODSON  
 APPROVED BY: S. JONG  
 DATE: MAY 2024

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CITY OF NEWTON, MASSACHUSETTS  
**BURR ELEMENTARY SCHOOL**  
**FIELD IMPROVEMENTS**

**ELECTRICAL SITE PLAN AND DETAILS**

PROJECT NO. 0865-272529  
 FILE NAME: E002PEPL  
 SHEET NO.  
**E-2**

ISSUED FOR BID