


INTERIOR ELEVATION - FIRST FLOOR ELEVATOR LOBBY 1/4" = 1'-0" SCALE

2 INTERIOR ELEVATION - FIRST FLOOR VETERANS OFFICE

INTERIOR ELEVATION - SECOND FLOOR ELEVATOR LOBBY

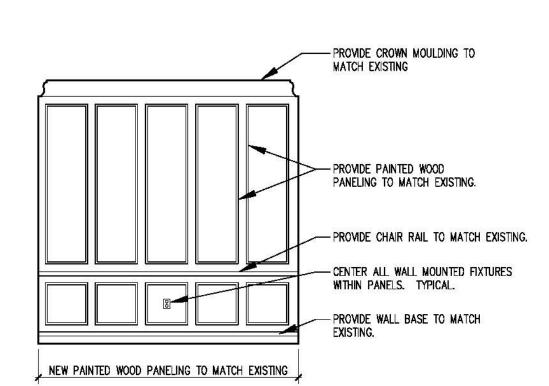

4 INTERIOR ELEVATION - SECOND FLOOR STAIR VESTIBULE

<u> </u>	11111	11111	1111111111	9
- 4	// //	11/11/11/11/	2777	

•	INTERNOTE LEEVE TO THE SECOND FEOOR LEEVE TO THE		111	11:11/1/1/1	1111111	- 3
<b>3</b>		91111.	11111111		"	
	I/4" = 1'-0" SCALE	0	2'	4'	8'	12'

**SUITE 102 NEWTON, MA 02458** 1. THE CONTRACTOR AND SUB—CONTRACTORS ARE REQUIRED TO INSPECT THE SITE AND CONTRACT DOCUMENTS AND TO NOTIFY THE ARCHITECT OF ANY DISCREPANCIES OR INCONSISTENCIES IN THE DOCUMENTS PRIOR TO PROVIDING BID PRICES.

2. THE DRAWINGS ARE MERELY REPRESENTATIONAL AND DO NOT FREE THE CONTRACTOR OR SUB—CONTRACTORS FROM THE REQUIREMENT OF PERFORMING NORMALLY REQUIRED TASKS TO PERFORM A SAFE, CODE—COMPLYING AND COMPLETE PROJECT.

3. FIELD MEASUREMENTS: THE CONTRACTOR SHALL TAKE ALL NECESSARY FIELD MEASUREMENTS PRIOR TO FABRICATION AND INSTALLATION OF WORK AND SHALL ASSUME COMPLETE RESPONSIBILITY FOR ACCURACY OF SAME. PRIOR TO CONSTRUCTION, THE CONTRACTOR IS RESPONSIBLE FOR CHECKING THE DIMENSIONS ON THE DRAWINGS AND NOTIFYING THE ARCHITECT OF ANY DISCREPANCIES WHICH ARE FOUND. NO MATERIALS SHALL BE ORDERED OR FABRICATED BASED ON DIMENSIONS SHOWN ON THE DRAWINGS. ALL DIMENSIONS MUST BE VERIFIED. NO DRAWINGS SHALL BE SCALED.

4. THE CONTRACTOR SHALL LAY OUT ALL NEW WALLS W/ CHALK FOR ARCHITECT APPROVAL PRIOR TO THE CONSTRUCTION OF ANY WALLS, TYPICAL. **LOCUS PLAN** 

PROJECT ARCHITECT

**GOLDMAN REINDORF** 

ARCHITECTS INC.

**427 WATERTOWN STREET** 

CITY OF NEWTON
WAR MEMORIAL
<b>ELEVATOR</b>

NOT TO SCALE

38.	
REVISION/DATE	
DRAWN BY: JM	CHECKED BY: MK

**INTERIOR ELEVATIONS** 


DATE: 11-07-13

COPYRIGHT 2013 (C) GOLDMAN REINDORF ARCHITECTS INC

DESIGN DEVELOPMENT SET NOT FOR CONSTRUCTION

GOLDMAN REINDORF ARCHITECTS INC. **427 WATERTOWN STREET SUITE 102** NEWTON, MA 02458 **LOCUS PLAN** NOT TO SCALE CITY OF NEWTON WAR MEMORIAL **ELEVATOR** REVISION/DATE DRAWN BY: FJM CHECKED BY: JB DATE: - ADD NEW W8x15 TIE BM. BETWEEN COL. D-8 **ELEVATOR** & (E) W9 AT STAIR **PART PLANS** COPYRIGHT 2013 © GOLDMAN REINDORF ARCHITECTS INC.

PROJECT ARCHITECT

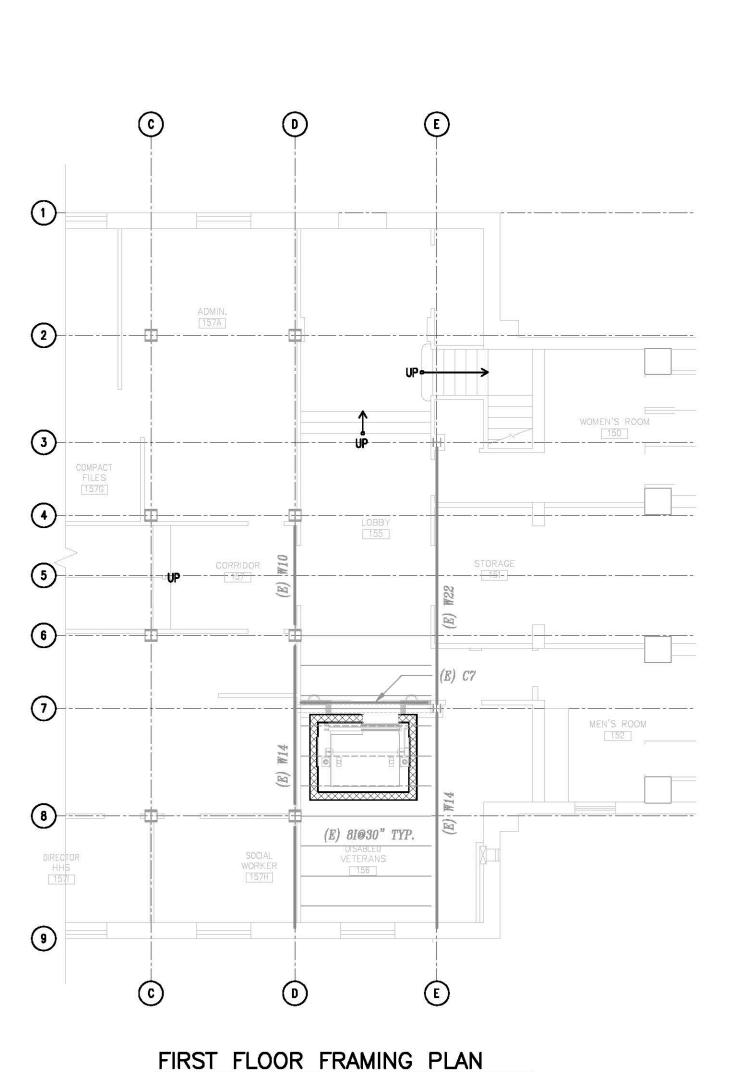

## BASEMENT / FOUNDATION PLAN 1/8"=1"-0" 1/8"=1'-0" PLAN NOTES:

1'-4" CONC. MAT. REINF. W/

#5's @ 12"o.c., E.W., T&B

TOP OF MAT 4'-0" BELOW

BASEMENT SLAB.

- 18"x18" (E) PIER

ASSUMED TOP OF

4'-4"x4'-4"x1'-8" (E) FTG. 95'-0"

ASSUMED TOP OF 3'-4"x3'-9"x1'-4" (E) FTG. 94'-8"

1. EXISTING INFORMATION TAKEN FROM ORIGINAL DWG #14F. 2. EXISTING BASEMENT SLAB ELEVATION 100'-0". 3. ASSUMED EXISTING BOTTOM OF FTG. ELEVATION 93'-4".

WOMEN'S ROOM B51J

— BOTTOM OF MAT

EL 94'-8"

1'-6"

ASSUMED TOP OF -

3'-4"x3'-9"x1'-4" (E) FTG. 94'-8"

16"x20" (E) PIER —

PLAN NOTES:

 NEW CMU WALL TO BE REINFORCED AND GROUTED SOLID.
 EXISTING FLOOR SLABS TO BEAR 3" ON HOISTWAY WALLS. DRY-PACK ALL VOIDS BETWEEN CMU & UNDERSIDE OF SLAB.


## (E) 4"ø -POST UP (E) 91@30" TYP. SECOND FLOOR FRAMING PLAN

## 1/8"=1"-0"

PLAN NOTES:

2

NEW CMU WALL TO BE REINFORCED AND GROUTED SOLID.
 EXISTING FLOOR SLABS TO BEAR 3" ON HOISTWAY WALLS. DRY-PACK ALL VOIDS BETWEEN CMU & UNDERSIDE OF SLAB.

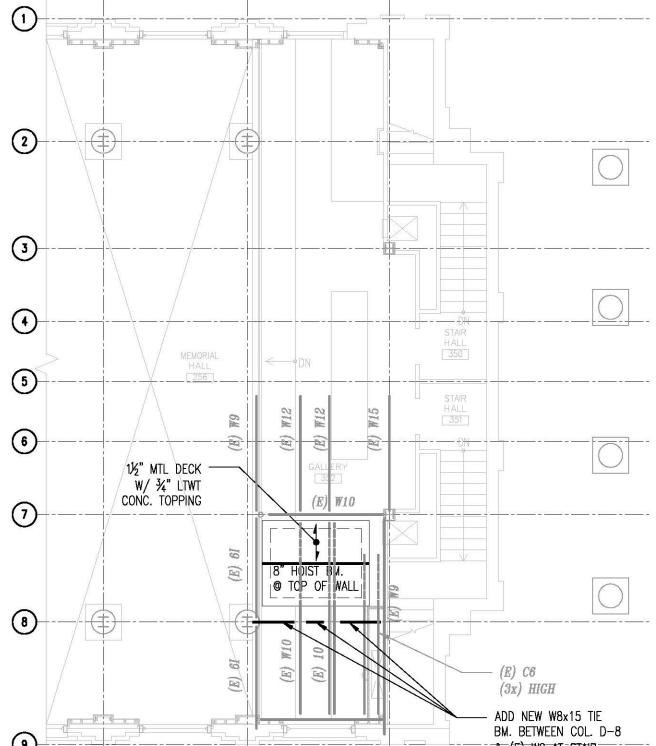

## GALLERY FLOOR FRAMING PLAN 1/8"=1'-0"

PLAN NOTES:

**(D)** 

NEW CMU WALL TO BE REINFORCED AND GROUTED SOLID.
HOIST WAY WALLS TO EXTEND UP ABOVE GALLERY. 3. EXISTING FLOOR SLABS TO BEAR 3" ON HOISTWAY WALLS. DRY-PACK ALL VOIDS BETWEEN CMU & UNDERSIDE OF SLAB.

PROGRESS 10-24-2013