UNION TWIST DISPENSARY


1158 BEACON STREET, NEWTON, MA
PERMITTING PLANS

OCTOBER 23, 2019

PREPARED FOR

UNION TWIST, INC.

1 INTERNATIONAL PL #3700 BOSTON, MA 02110

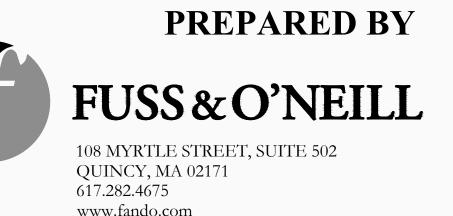

SHEET INDEX

SITE DETAILS

SITE PHOTOMETRIC PLAN

CD-502-503

SL-101

SHEET No. SHEET TITLE GI-001 COVER SHEET CN-101 GENERAL NOTES SHEET 1 OF 1 BOUNDARY & TOPOGRAPHIC SURVEY BY CONTROL POINT ASSOCIATES CP-101 SITE PREPARATION PLAN CE-101 EROSION AND SEDIMENT CONTROL PLAN CS-101 SITE LAYOUT PLAN LND-101 SITE LANDSCAPING PLAN EROSION AND SEDIMENT CONTROL DETAILS CD-501

PROJECT TEAM

ARCHITECT BKA ARCHITECTS INC 344 BOYLSTON STREET BOSTON, MA 02116 508-728-3853

LAND SURVEYOR
CONTROL POINT ASSOCIATES
45 FRANKLIN STREET 5TH FLOOR
BOSTON, MA 02110
857-400-3311



LOCATION MAP

SCALE: 1" = 200'

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PROJ. No.: 20190241.A30 DATE: 10/23/2019

GI-001

- 2. DO NOT RELY SOLELY ON ELECTRONIC VERSIONS OF DRAWINGS, SPECIFICATIONS, AND DATA FILES THAT ARE PROVIDED BY THE ENGINEER. FIELD VERIFY LOCATION OF PROJECT FEATURES.
- 3. PERFORM NECESSARY CONSTRUCTION NOTIFICATIONS, APPLY FOR AND OBTAIN NECESSARY PERMITS, PAY FEES, AND POST BONDS ASSOCIATED WITH THE WORK AS REQUIRED BY THE CONTRACT DOCUMENTS.
- 4. SEE ARCHITECTURAL DRAWINGS FOR DIMENSIONS OF BUILDINGS AND ADJACENT SITE ELEMENTS INCLUDING SIDEWALKS, RAMPS, BUILDING ENTRANCES, STAIRWAYS, UTILITY PENETRATIONS, CONCRETE DOOR PADS, COMPACTOR PAD, LOADING DOCKS, BOLLARDS,
- 5. BASE PLAN: OBTAINED FROM A PLAN ENTITLED "BOUNDARY & TOPOGRAPHIC SURVEY", PREPARED BY CONTROL POINT ASSOCIATED INC., DATED 04/01/19.
- 6. TOPOGRAPHIC ELEVATIONS ARE BASED ON NAVD88.
- 7. FLOOD ZONE: THE SUBJECT SITE LIES WITHIN ZONE X, AN AREA DETERMINED TO BE OUTSIDE THE 0.2% ANNUAL CHANCE FLOODPLAIN, PER FLOOD INSURANCE RATE MAP (FIRM) PANEL NO. 25017C0554E, EFFECTIVE DATE JUNE 4, 2010.
- 8. AN APPROVED SET OF PLANS AND ALL APPLICABLE PERMITS MUST BE AVAILABLE FOR INSPECTION AT THE CONSTRUCTION SITE AT ALL TIMES.

WORK RESTRICTIONS

- 1. DO NOT CLOSE OR OBSTRUCT ROADWAYS, SIDEWALKS, FIRE HYDRANTS, AND UTILITIES WITHOUT APPROPRIATE PERMITS.
- 2. WORK IS RESTRICTED TO THE HOURS OF 7 AM TO 5 PM ON MONDAY THROUGH FRIDAY, EXCLUDING HOLIDAYS, UNLESS OTHERWISE APPROVED BY THE OWNER.

REGULATORY REQUIREMENTS

- 1. WITHIN RIGHTS-OF-WAY, PERFORM THE WORK IN ACCORDANCE WITH LOCAL MUNICIPAL STANDARDS.
- 2. AT A MINIMUM, CONSTRUCT ACCESSIBLE ROUTES, PARKING SPACES, RAMPS, SIDEWALKS AND WALKWAYS IN CONFORMANCE WITH THE FEDERAL AMERICANS WITH DISABILITIES ACT AND WITH STATE AND LOCAL LAWS AND REGULATIONS (WHICHEVER ARE MORE STRINGENT).
- 3. TRAFFIC SIGNAGE AND PAVEMENT MARKINGS SHALL CONFORM TO THE LATEST EDITION OF THE MANUAL OF UNIFORM TRAFFIC CONTROL DEVICES.
- 4. SECURE THE PROJECT SITE AND PERFORM CONSTRUCTION ACTIVITIES IN ACCORDANCE WITH OSHA STANDARDS AND LOCAL REQUIREMENTS.
- 5. DISPOSE OF DEMOLITION DEBRIS IN ACCORDANCE WITH APPLICABLE FEDERAL, STATE AND LOCAL REGULATIONS, ORDINANCES AND STATUTES.

DEMOLITION

- 1. THE DEMOLITION PLAN IS PROVIDED FOR INFORMATION ONLY AND MAY NOT INDICATE ALL ITEMS REQUIRED TO BE DEMOLISHED. PERFORM A PRE—BID SITE INSPECTION. COORDINATE DEMOLITION OF UNIDENTIFIED UTILITIES OR STRUCTURES WITH OWNER. DEMOLISH STRUCTURES, SITE IMPROVEMENTS, UTILITIES, ETC. AS REQUIRED TO CONSTRUCT PROPOSED FACILITY AND UTILITY SERVICES.
- 2. TREES, BRUSH AND STUMPS REMOVED BY CLEARING & GRUBBING OPERATIONS SHALL BE TRANSPORTED OFF THE PROJECT SITE TO AN APPROVED DISPOSAL LOCATION.
- 3. ITEMS TO BE STOCKPILED ON—SITE FOR REUSE OR TO BE RELOCATED SHALL BE PROTECTED FROM CONSTRUCTION OPERATIONS. IF DAMAGED DURING CONSTRUCTION THEY SHALL BE REPLACED IN—KIND AT NO ADDITIONAL COST TO THE OWNER.

EARTHWORK

- NOTIFY THE FOLLOWING AT LEAST 72 HOURS BEFORE STARTING EXCAVATION EXCLUSIVE OF WEEKENDS AND HOLIDAYS.
 "DIG SAFE" AT 1-888-344-7233.
- 2. WITHIN THE LIMITS OF THE BUILDING FOOTPRINT, PERFORM EARTHWORK OPERATIONS TO SUBGRADE ELEVATIONS. SEE DRAWINGS BY OTHERS FOR WORK ABOVE SUBGRADE.

CONSTRUCTION LAYOUT

- 1. PROVIDE PROPER TRANSITIONS BETWEEN EXISTING AND PROPOSED SITE IMPROVEMENTS. FIELD VERIFY EXISTING PAVEMENT AND GROUND ELEVATIONS AT THE INTERFACE WITH PROPOSED PAVEMENTS AND DRAINAGE STRUCTURES BEFORE START OF CONSTRUCTION.
- 2. PRIOR TO ORDERING MATERIALS AND BEGINNING CONSTRUCTION, FIELD VERIFY PROPOSED UTILITY ROUTES AND IDENTIFY ANY INTERFERENCES OR OBSTRUCTIONS WITH EXISTING UTILITIES OR PUBLIC RIGHTS—OF—WAY.
- 3. IMMEDIATELY INFORM THE ENGINEER IN WRITING IF EXISTING UTILITY CONDITIONS CONFLICT OR DIFFER FROM THAT INDICATED AND IF THE WORK CANNOT BE COMPLETED AS INDICATED.
- 4. DIMENSIONS ARE FROM FACE OF CURB, FACE OF BUILDING, FACE OF WALL, AND CENTER LINE OF PAVEMENT MARKINGS, UNLESS NOTED OTHERWISE.
- 5. BOUNDS OR MONUMENTATION DISTURBED DURING CONSTRUCTION SHALL BE SET OR RESET BY A PROFESSIONAL LICENSED SURVEYOR.

EROSION AND SEDIMENT CONTROL

- DISTURBANCE OF SOIL SURFACES IS REGULATED BY STATE LAW AND LOCAL ORDINANCE. WORK SHALL COMPLY WITH THE FOLLOWING CRITERIA TO PREVENT OR MINIMIZE SOIL FROSION.
- 2. INSTALL, INSPECT, MAINTAIN, AND REPAIR OR REPLACE TEMPORARY AND PERMANENT EROSION CONTROL DEVICES TO ENSURE PROPER OPERATION IN A TIMELY MANNER THROUGHOUT THE LIFE OF THE PROJECT. MAINTAIN PERMANENT MEASURES UNTIL CONSTRUCTION OF THE PROJECT IS COMPLETED OR UNTIL IT IS ACCEPTED BY THE OWNER. DISPOSE OF SEDIMENT IN AN UPLAND AREA.
- 3. INSPECT EROSION AND SEDIMENT CONTROLS DAILY AND REMOVE ACCUMULATED SEDIMENTS AS NEEDED. REPAIR OR CORRECT ANY ISSUES.
- 4. MAINTAIN A STOCKPILE OF ADDITIONAL EROSION AND SEDIMENT CONTROL DEVICES ON SITE AT ALL TIMES. AT A MINIMUM, MAINTAIN A STOCKPILE OF AT LEAST 100 FEET OR 10% OF THE TOTAL AMOUNT OF DEVICES CURRENTLY DEPLOYED AT THE SITE, WHICHEVER IS GREATER.
- 5. CLEAN ROADS, CONTROL DUST, AND TAKE NECESSARY MEASURES TO ENSURE THAT THE SITE AND ALL ROADS BE MAINTAINED IN A MUD— AND DUST—FREE CONDITION AT ALL TIMES THROUGHOUT THE LIFE OF THE CONTRACT. DUST CONTROL SHALL INCLUDE, BUT IS NOT LIMITED TO, WATER AND/OR CRUSHED STONE OR COARSE GRAVEL, SUBJECT TO THE APPROVAL OF THE ENGINEER.
- 6. INSTALL PERIMETER SEDIMENT CONTROL BARRIERS AS SHOWN ON THE SITE PLANS OR AS MAY BE REQUIRED TO PREVENT SEDIMENT FLOW TO STORM DRAINS OR SURFACE WATERS. A ROW OF STAKED HAYBALES OR A SILT FENCE SHALL ALSO BE INSTALLED AROUND ANY SOIL STOCKPILE AREAS. CLEANOUT OF ACCUMATED SEDIMENT BEHIND PERIMETER SEDIMENT CONTROL BARRIER IS NECESSARY IF ONE—HALF THE ORIGINAL HEIGHT OF THE BARRIER BECOMES FILLED WITH SEDIMENT. REPLACE BARRIER IMMEDIATELY IF BARRIER DECOMPOSED OR BECOMES INEFFECTIVE.
- 7. PERFORM CONSTRUCTION SEQUENCING IN SUCH A MANNER TO CONTROL EROSION AND TO MINIMIZE THE TIME THAT EARTH MATERIALS ARE EXPOSED BEFORE THEY ARE COVERED, SEEDED, OR OTHERWISE STABILIZED.
- 8. IF FINAL GRADING IS TO BE DELAYED FOR MORE THAN THIRTY (30) DAYS AFTER LAND DISTURBANCES CEASE, TEMPORARY VEGETATION OR MULCH SHALL BE USED TO STABILIZE SOILS. OUTSIDE OF THE GROWING SEASON, ONLY WOOD MULCH SHALL BE USED.
- 9. PERMANENT VEGETATIVE COVER SHALL BE APPLIED TO ALL DISTURBED AREAS THAT HAVE REACHED FINISHED GRADE AS SOON AS POSSIBLE, BUT NOT MORE THAN FOURTEEN (14) DAYS AFTER THE CONSTRUCTION ACTIVITY IN THAT AREA HAS PERMANENTLY CEASED. THE RECOMMENDED PERMANENT SEEDING DATES ARE APRIL 1 TO JUNE 15 AND AUGUST 15 TO SEPTEMBER 30.
- LIMESTONE AND FERTILIZER SHALL BE APPLIED ACCORDING TO SOIL TEST RECOMMENDATIONS OFFERED BY THE UNIVERSITY OF MASSACHUSETTS SOIL TESTING LABORATORY. IF SOIL TESTING IS NOT FEASIBLE ON SMALL OR VARIABLE SITES, OR WHERE TIMING IS CRITICAL, FERTILIZER MAY BE APPLIED AT THE RATE OF 500 POUNDS PER ACRE OR 11.5 POUNDS PER 1,000 SQUARE FEET OF 10-20-20 OR EQUIVALENT. APPLY LIMESTONE (EQUIVALENT TO 50 PERCENT CALCIUM PLUS MAGNESIUM OXIDE) AS FOLLOWS: 4 TONS PER ACRE (OR 180 POUNDS PER 1,000 SQUARE FEET) FOR CLAY, CLAY LOAM AND HIGH ORGANIC SOIL; 3 TONS PER ACRE (OR 135 POUNDS PER 1,000 SQUARE FEET) FOR SANDY LOAM, LOAM, OR SILT LOAM; AND 2 TONS PER ACRE (OR 90 POUNDS PER 1,000 SQUARE FEET) LOAMY SAND OR SAND.
- 10. EXISTING OR PROPOSED STORMWATER DRAINAGE STRUCTURES THAT MAY BE SUBJECT TO SEDIMENTATION SHALL BE PROTECTED WITH STAKED STRAW BALES, WATTLES, SILT FENCE, SILT SACKS, OR OTHER APPROVED MEASURES THROUGHOUT THE ENTIRE CONSTRUCTION
- 11. WASTE DISPOSAL: MATERIALS WHICH COULD BE A POTENTIAL SOURCE OF STORMWATER POLLUTION SUCH AS GASOLINE, DIESEL FUEL, HYDRAULIC OIL, ETC., SHALL BE STORED AT THE END OF EACH DAY IN A STORAGE TRAILER OR COVERED LOCATION AND TAKEN OFF—SITE AND PROPERLY DISPOSED OF. ALL TYPES OF WASTE GENERATED AT THIS SITE SHALL BE DISPOSED OF IN A MANNER CONSISTENT WITH STATE LAW AND/OR REGULATIONS.
- 12. GOOD HOUSEKEEPING: THE PROJECT SITE SHALL PROVIDE FOR THE MINIMIZATION OF EXPOSURE OF CONSTRUCTION DEBRIS (INCLUDING, BUT NOT LIMITED TO, INSULATION, WIRING, PAINTS AND PAINT CANS, SOLVENTS, WALL BOARD, ETC.) TO PRECIPITATION BY MEANS OF DISPOSAL AND/OR PROPER SHELTER OR COVER. CONSTRUCTION WASTE MUST BE PROPERLY DISPOSED OF IN ORDER TO AVOID EXPOSURE TO PRECIPITATION AT THE END OF EACH WORKING DAY.
- 13. UPON COMPLETION OF CONSTRUCTION AND ESTABLISHMENT OF PERMANENT GROUND COVER, REMOVE AND DISPOSE OF TEMPORARY EROSION CONTROL MEASURES. CLEAN SEDIMENT AND DEBRIS FROM TEMPORARY MEASURES AND FROM PERMANENT STORM DRAIN AND SANITARY SEWER SYSTEMS.

SITE RESTORATION

- PROVIDE 6 INCHES OF TOPSOIL AND SEED IN AREAS DISTURBED DURING CONSTRUCTION AND NOT DESIGNATED AS IMPERVIOUS SURFACES (BUILDINGS, PAVEMENTS, WALKS, ETC.) UNLESS OTHERWISE NOTED. SUPPLEMENT EXISTING TOPSOIL WITH IMPORTED TOPSOIL AS REQUIRED TO ACHIEVE DEPTH.
- 2. REPAIR DAMAGES RESULTING FROM CONSTRUCTION LOADS, AT NO ADDITIONAL COST TO OWNER.
- 3. RESTORE AREAS DISTURBED BY CONSTRUCTION OPERATIONS TO THEIR ORIGINAL CONDITION OR BETTER, AT NO ADDITIONAL COST TO OWNER.

<u>PLANTING</u>

- 1. ALL PLANTING MATERIAL TO BE NURSERY GROWN STOCK SUBJECT TO A.A.N. STANDARDS.
- 2. SUPPLY ALL PLANTS IN QUANTITIES SUFFICIENT TO COMPLETE THE WORK SHOWN ON THE DRAWINGS AND LISTED IN THE PLANT LIST. IN THE EVENT OF A DISCREPANCY BETWEEN QUANTITIES SHOWN IN THE PLANT LIST AND THOSE REQUIRED BY THE DRAWINGS, THE LARGER NUMBER SHALL APPLY.
- 3. ALL PLANTS SHALL BE APPROVED PRIOR TO INSTALLATION AND SHALL BE LOCATED ON SITE FOR THE APPROVAL OF THE LANDSCAPE ARCHITECT. ANY INSTALLATIONS WHICH WERE NOT APPROVED BY THE LANDSCAPE ARCHITECT AND WHICH ARE SUBSEQUENTLY REQUESTED TO BE MOVED WILL BE DONE AT NO EXPENSE TO THE OWNER.
- 4. PRECISE LOCATION OF ITEMS NOT DIMENSIONED ON THE PLAN ARE TO BE FIELD STAKED AND SHALL BE SUBJECT TO THE REQUIREMENTS SPECIFIED IN THE PREVIOUS NOTE.
- 5. ALL SHRUB MASSINGS AND TREE PITS SHALL BE MULCHED TO A DEPTH OF 3" WITH SHREDDED PINE BARK MULCH.
- 6. TREES SHALL NOT BE STAKED UNLESS OTHERWISE NOTED.
- 7. ANY DAMAGED VEGETATION SHALL BE REPLACED OR REPAIRED AT NO EXPENSE TO THE OWNER.
- 8. ALL SHRUB AND GROUNDCOVER PLANTING AREAS SHALL HAVE CONTINUOUS BEDS OF
- 9. WHERE PLANT MATERIAL MAY INTERFERE WITH UTILITIES, NOTIFY THE LANDSCAPE ARCHITECT TO COORDINATE THEIR INSTALLATION.
- 10. FOR PLANTING SOIL MIX, SEE SPECIFICATIONS OR PLANTING DETAILS.
- 11. ALL EXISTING RILL, GULLY OR CHANNEL EROSION SHALL BE FILLED WITH APPROPRIATE SOIL MATERIALS, FINE RAKED, SCARIFIED AND STABILIZED WITH VEGETATION, AND/OR EROSION AND SEDIMENTATION CONTROLS.
- 12. ADJUSTMENTS TO THE LOCATION OF THE PROPOSED PLANT MATERIALS AS A RESULT OF CONFLICTS WITH EXISTING VEGETATION TO REMAIN SHALL BE APPROVED BY THE LANDSCAPE ARCHITECT PRIOR TO INSTALLATION.
- 13. MAINTAIN, REPLACE, AND REPAIR PLANT MATERIAL AS REQUIRED, FOR THE DURATION OF THE PROJECT AND SUBSEQUENT WARRANTY PERIOD.
- 14. UPON COMPLETION OF PLANTING, REMOVE FROM SITE ALL EXCESS SOIL, MULCH, AND MATERIALS AND DEBRIS RESULTING FROM WORK OPERATIONS. CLEAN UP SHOULD BE COMPLETED AT THE END OF EACH WORKING DAY. RESTORE TO ORIGINAL CONDITIONS ALL DAMAGED PAVEMENTS, PLANTING AREAS, STRUCTURES AND LAWN AREAS RESULTING FROM LANDSCAPING OPERATIONS.
- 15. SURVEY, LOCATE, AND PROTECT ALL TREES WITHIN AREAS SHOWN AS "EXISTING VEGETATION TO REMAIN" WITHIN THE DEVELOPMENT ENVELOPE FOR REVIEW BY LANDSCAPE ARCHITECT PRIOR TO CLEARING OPERATIONS.
- 16. ALL DISTURBED AREAS ARE TO BE SEEDED WITH LAWN UNLESS OTHERWISE NOTED ON LANDSCAPE PLAN.
- 17. PLANT MATERIAL WITHIN TRAFFIC SIGHT LINES AT INTERSECTIONS TO BE LESS THAN 3 FEET IN HEIGHT AND TREES ARE TO BE LIMBED UP TO A BRANCHING HEIGHT OF AT LEAST 7 FEET.
- 18. TREES ALONG SIDEWALKS TO BE LIMBED TO A HEIGHT OF 7-8 FEET ABOVE GROUND.

SCALE:

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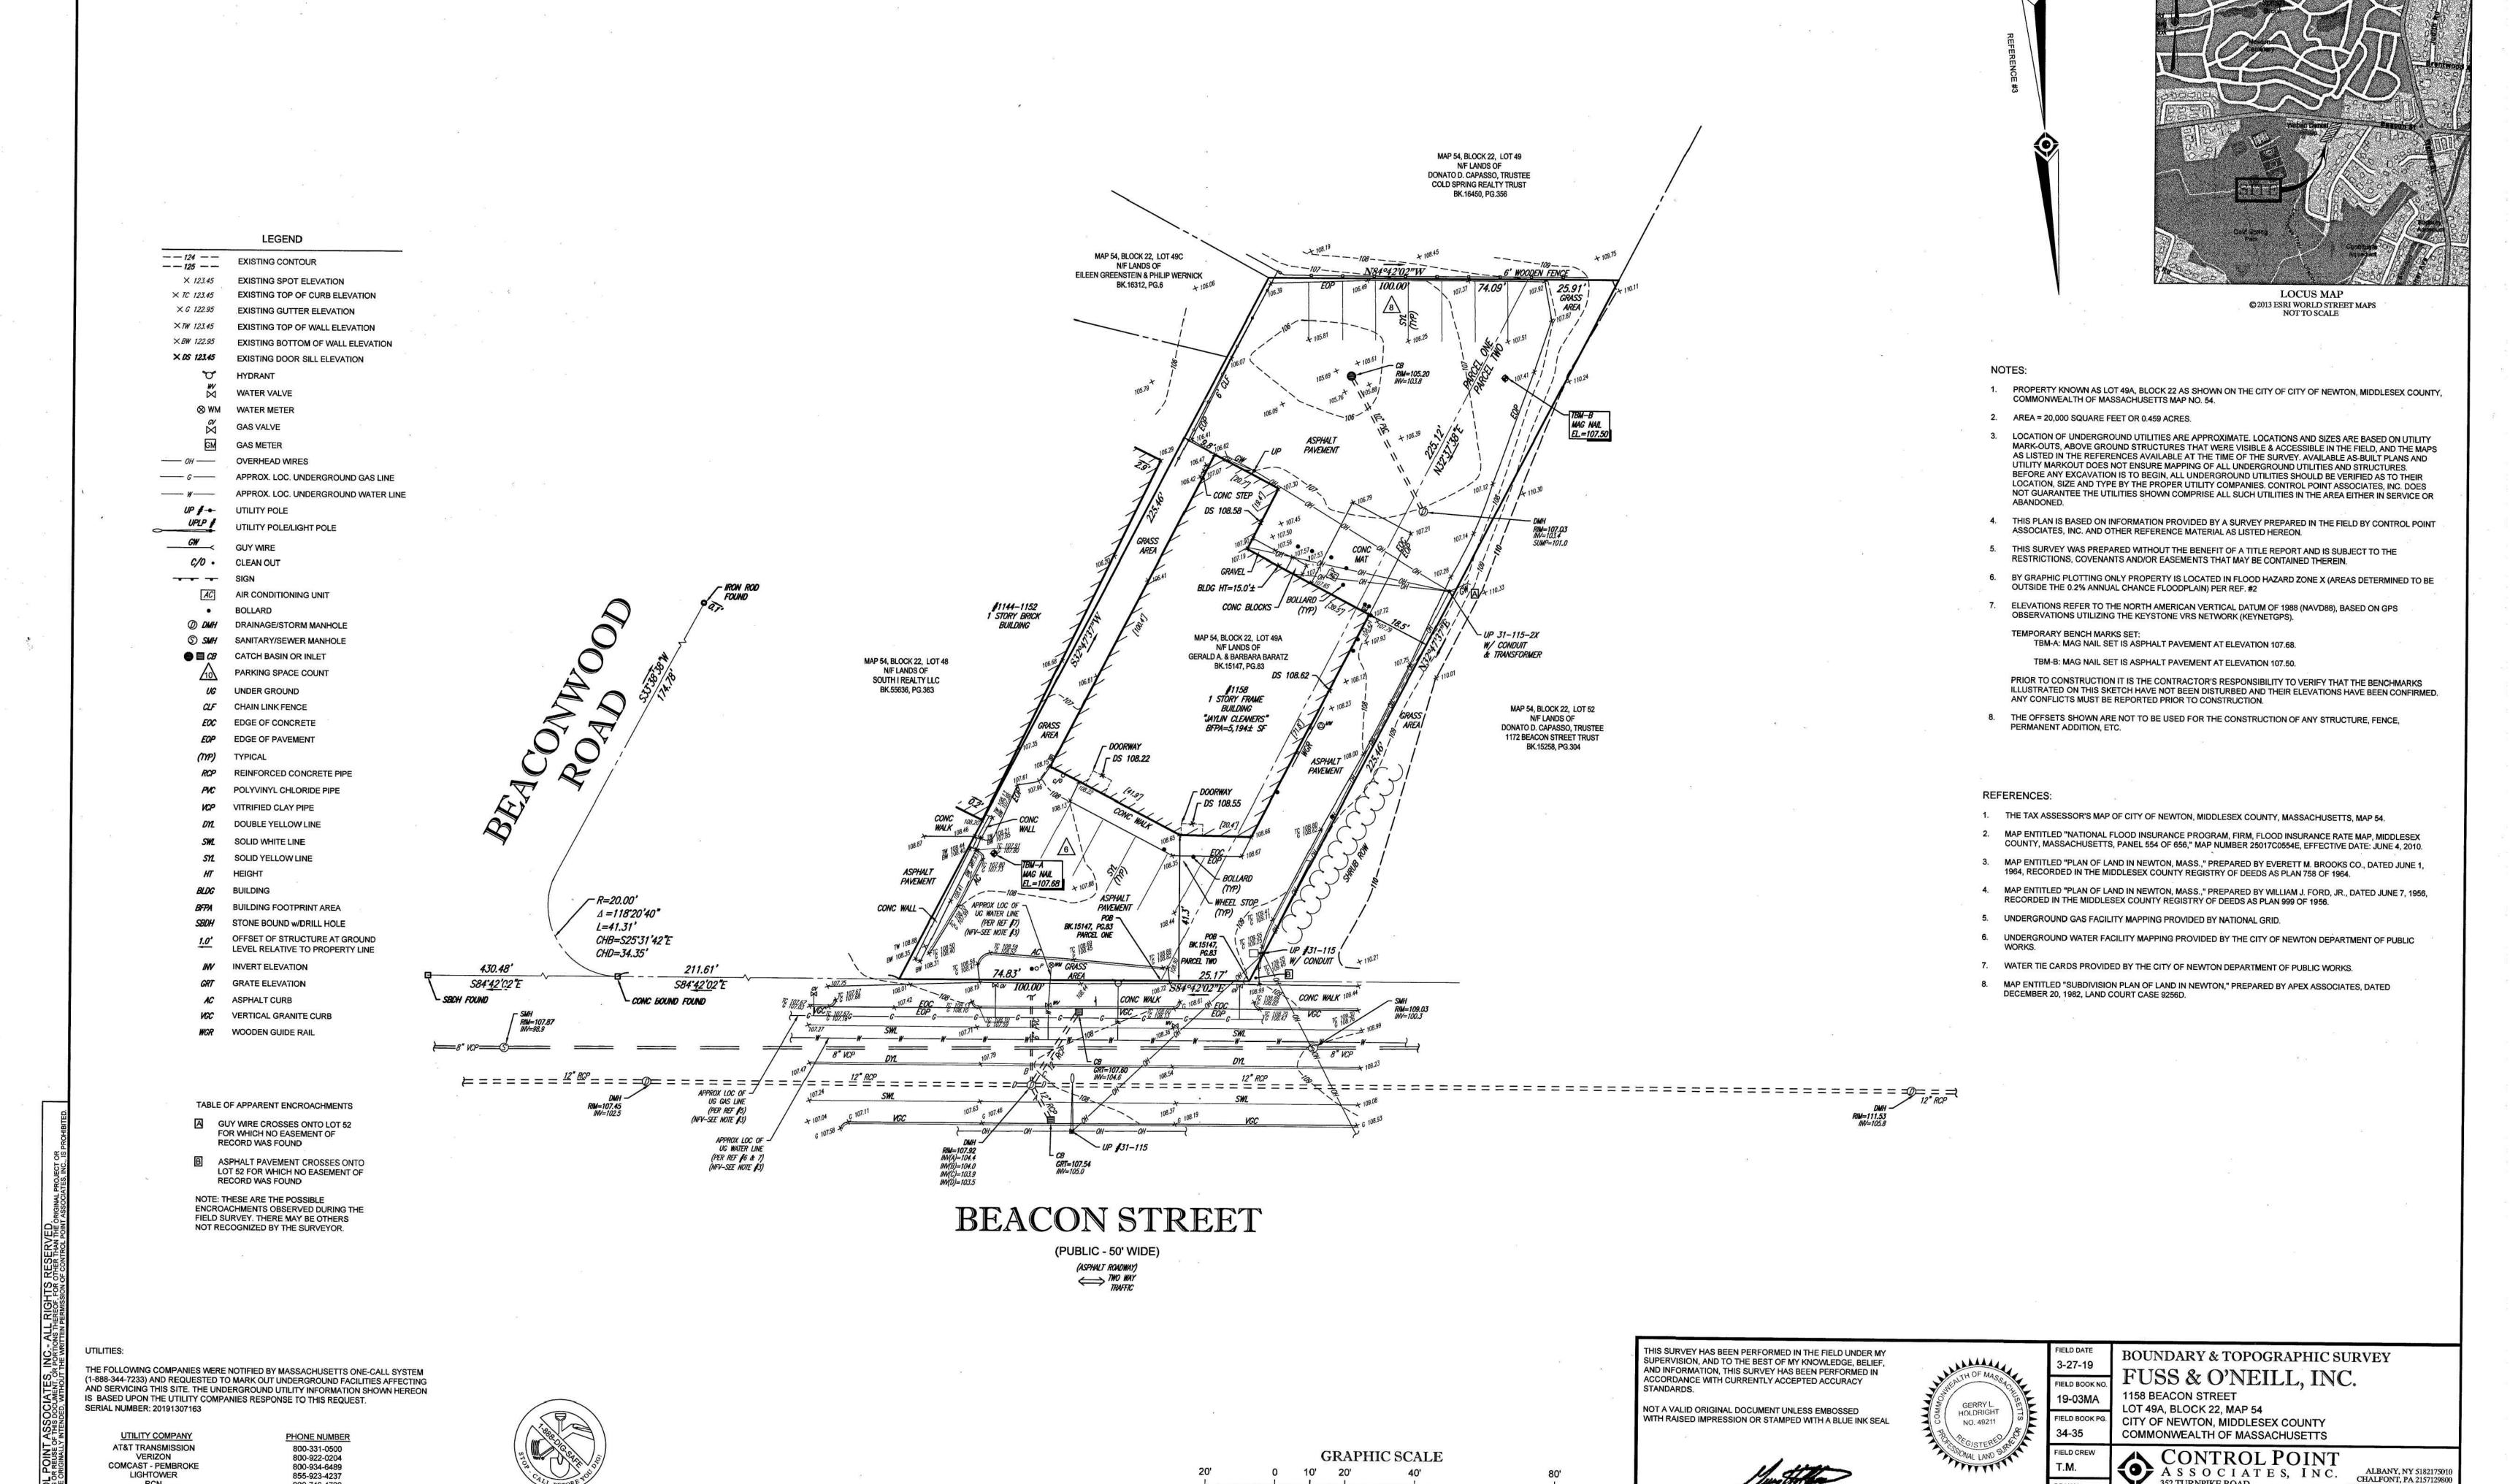
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CRAPHIC SCALE

CN-101

PROJ. No.: 20190241.A30

DATE: 10/23/2019



(IN FEET) 1 inch = 20' ft.

800-746-4726

800-592-2000

800-233-5325

781-235-7600

THE COMMONWEALTH OF MASSACHUSETTS REQUIRES NOTIFICATION

BY EXCAVATORS, DESIGNERS, OR ANY PERSON PREPARING TO DISTURB THE EARTH'S SURFACE ANYWHERE IN THE COMMONWEALTH

EVERSOURCE - ELECTRIC

NATIONAL GRID GAS - BOSTON

VELLESLEY MUNICIPAL LIGHTING PLANT

352 TURNPIKE ROAD

A.D./A.M.

REVIEWED:

S.P.P.

MASSACHUSETTS PROFESSIONAL LAND SURVEYOR #49211

SOUTHBOROUGH, MA 01772

508.948.3000 - 508.948.3003 FAX

1" = 20'

06-190021


MANHATTAN, NY 6467800411

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MT LAUREL, NJ 6098572099

WARREN, NJ 908668009

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CE-101

1/2 BUILDING HEIGHT OR ABUTTING SETBACK (BUILDING HEIGHT - 13 FT) (13/2 = 6.5 FT)

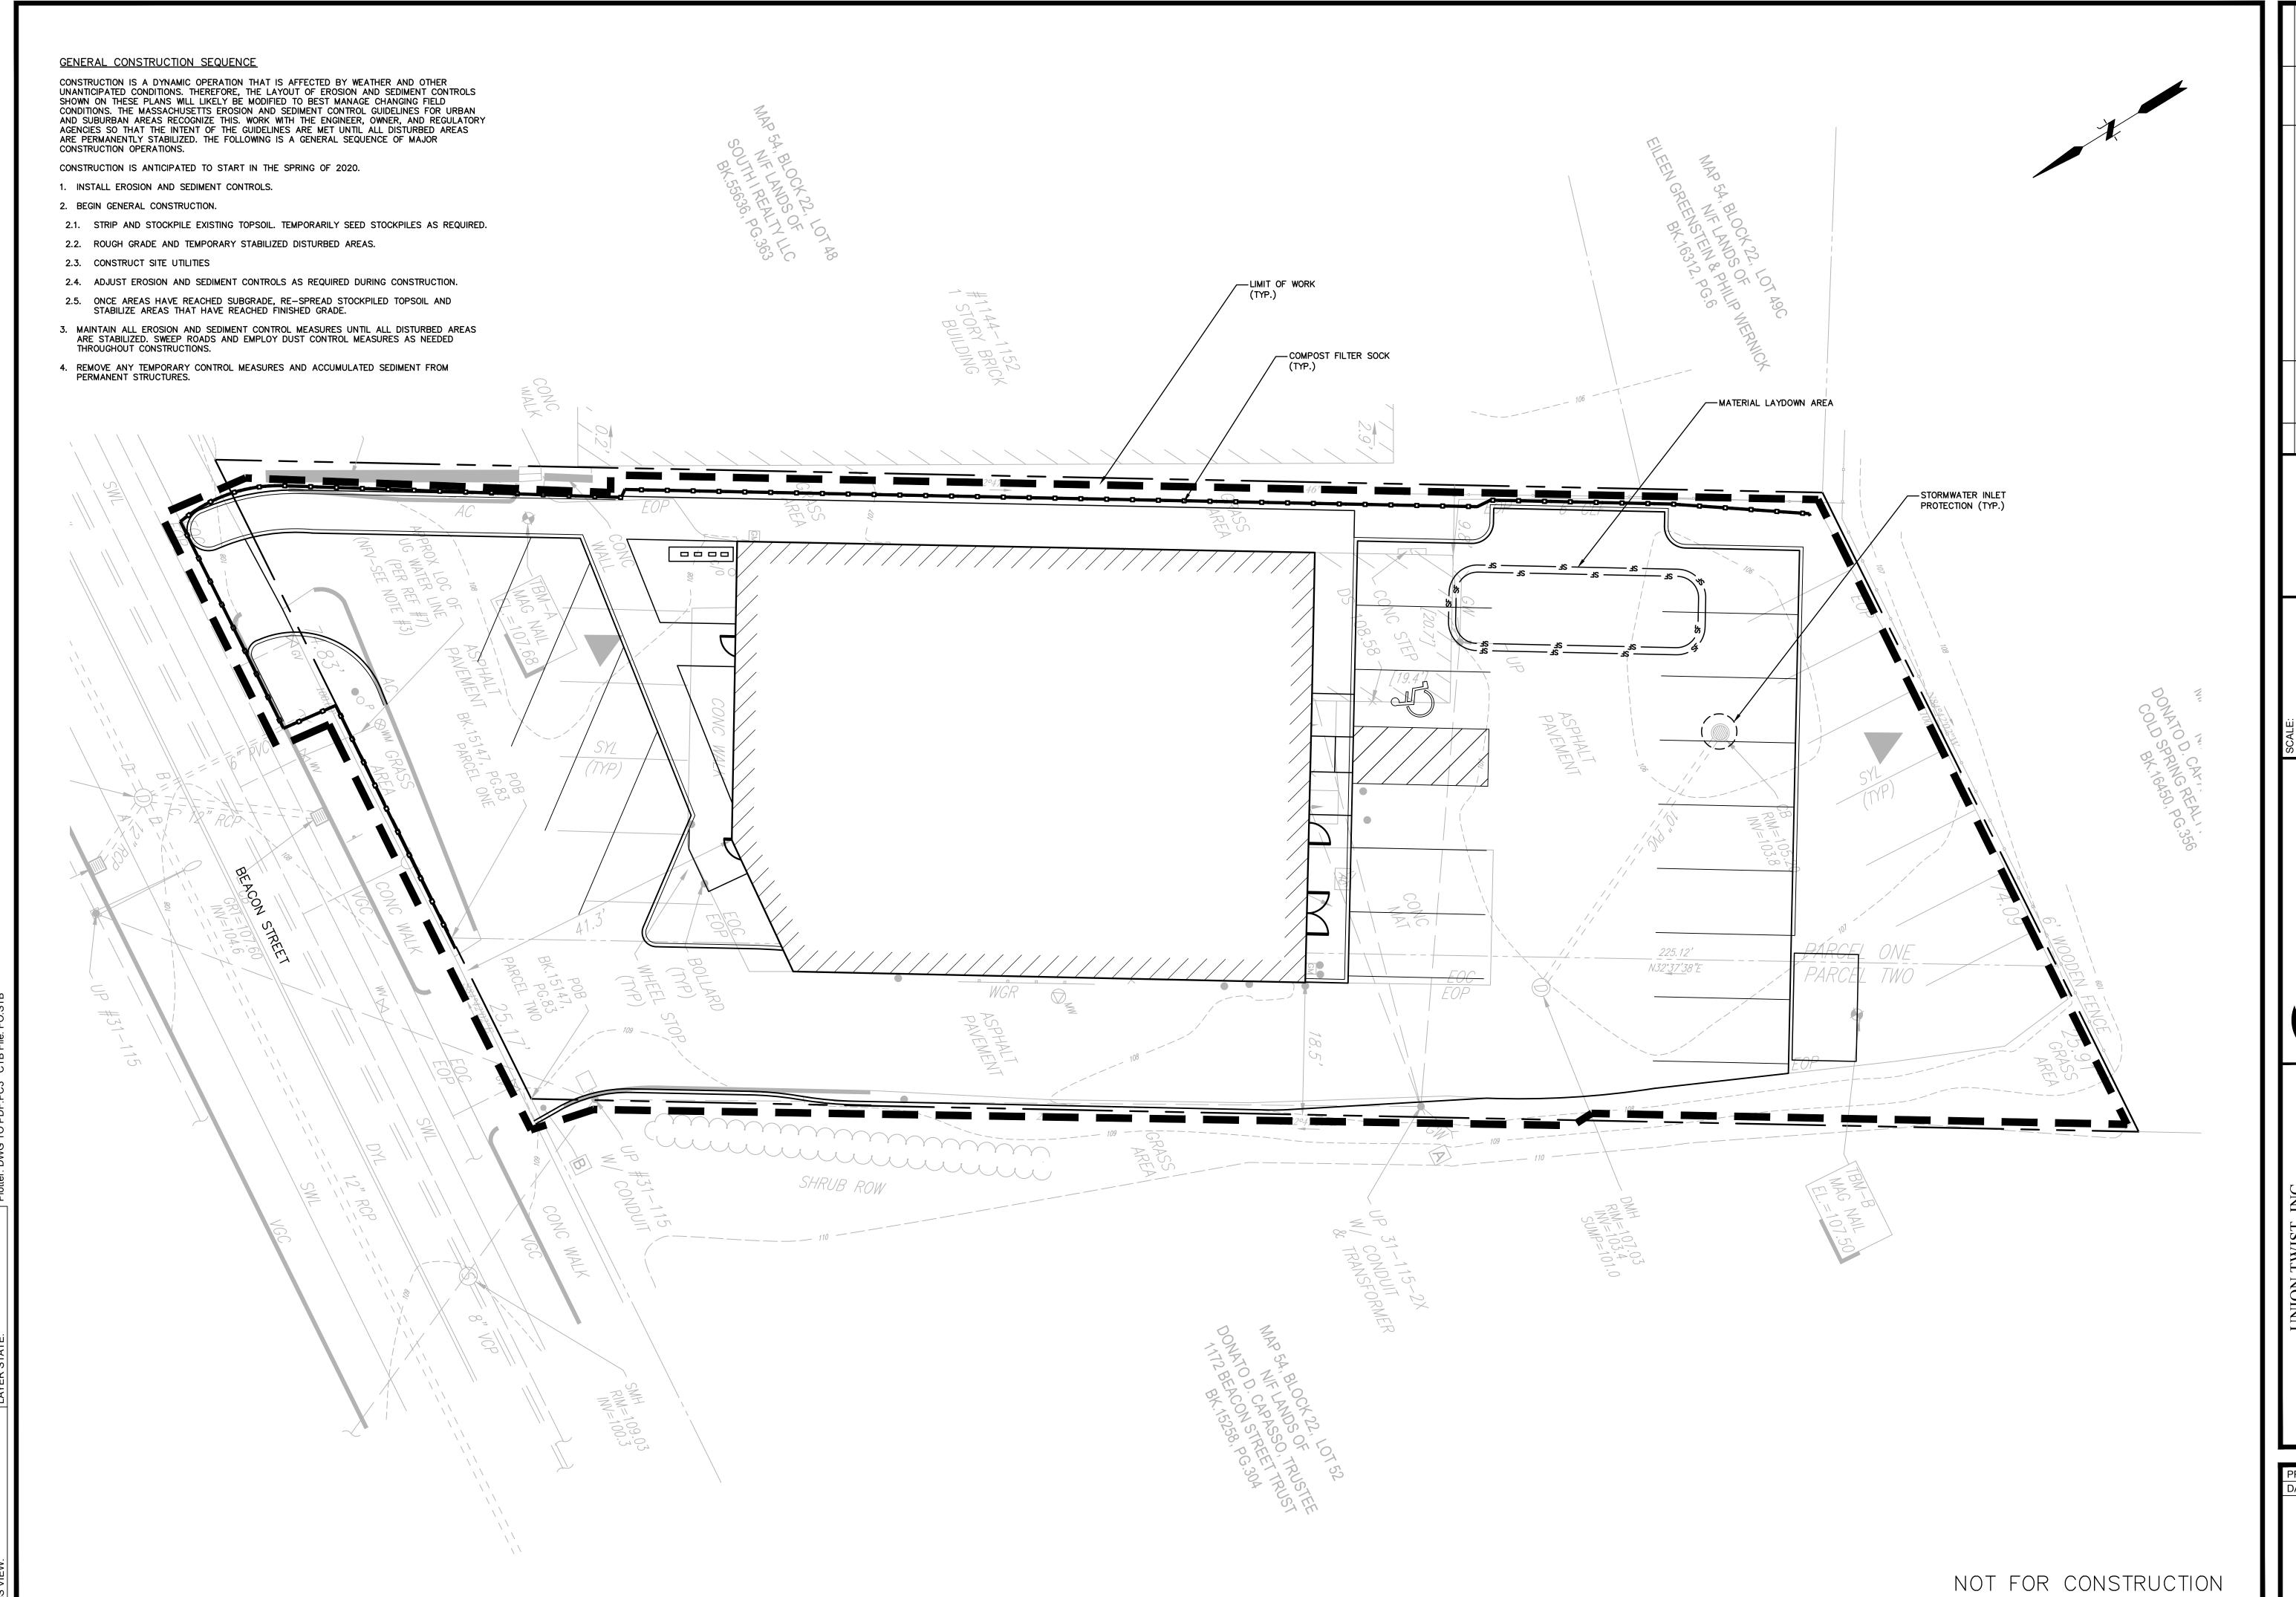3. GREATER 1/2 BUILDING HEIGHT (6.5') OR 15 FEET WHEN ABUTTING A RESIDENTIAL LOT OR PUBLIC USE.

NOT FOR CONSTRUCTION