



Zoning	Required	Existing	Proposed
SR-3 Old			
Min. Lot Area	7,000 sf	6,377 sf	
Setbacks			
Front	25.0'	17.2	17.2' (No Change)
Side	7.5'	9.0'	9.0'(No Change)
Rear	15.0'	34.2	17.8'
	%	%	%
Lot Coverage	30.0%	22.70%	28.45%
Open Space	50.0%	67.11%	58.00%
Floor Area Ratio	0.48/**0.50	0.565	0.72
Bld Height	35'	32.08	32.47
Stories	2.5	3	3

Zoning District: SR-3 Old Lot Status

Allowed/Required Lot Coverage=30.0% Open Space=50.0%

Existing Lot Coverage=22.70% Open Space=67.11%

Proposed Lot Coverage=28.45% Open Space=58.00%

Allowed FAR=0.48 (3061 sf) **Allowed FAR w/Bonus=0.50 (3188.5)

Existing FAR=0.565 (3606 sf) Proposed FAR=0.720 (4596 sf)


Existing FAR Calculation Lower Level=1186 sf Main Floor=1186 sf Top Floor=1234 sf Attic=0Total=3606 sf


Proposed FAR Calculation Lower Level=1516 sf Main Floor=1516 sf Top Floor=1564 sf Attic=0Total=4596 sf

Zoning Notes: 1. Existing Basement (Lower Level) counts as a story. See Existing Height Calculation.

2. Existing zoning district information and lot status is based on information obtained from the City of Newton on-line data base and property deeds and plans obtained from Middlesex South District Registry of Deeds. Final zoning district and lot status to be determined by the City of Newton Inspectional Services Department.

Waltham Street Fessenden School

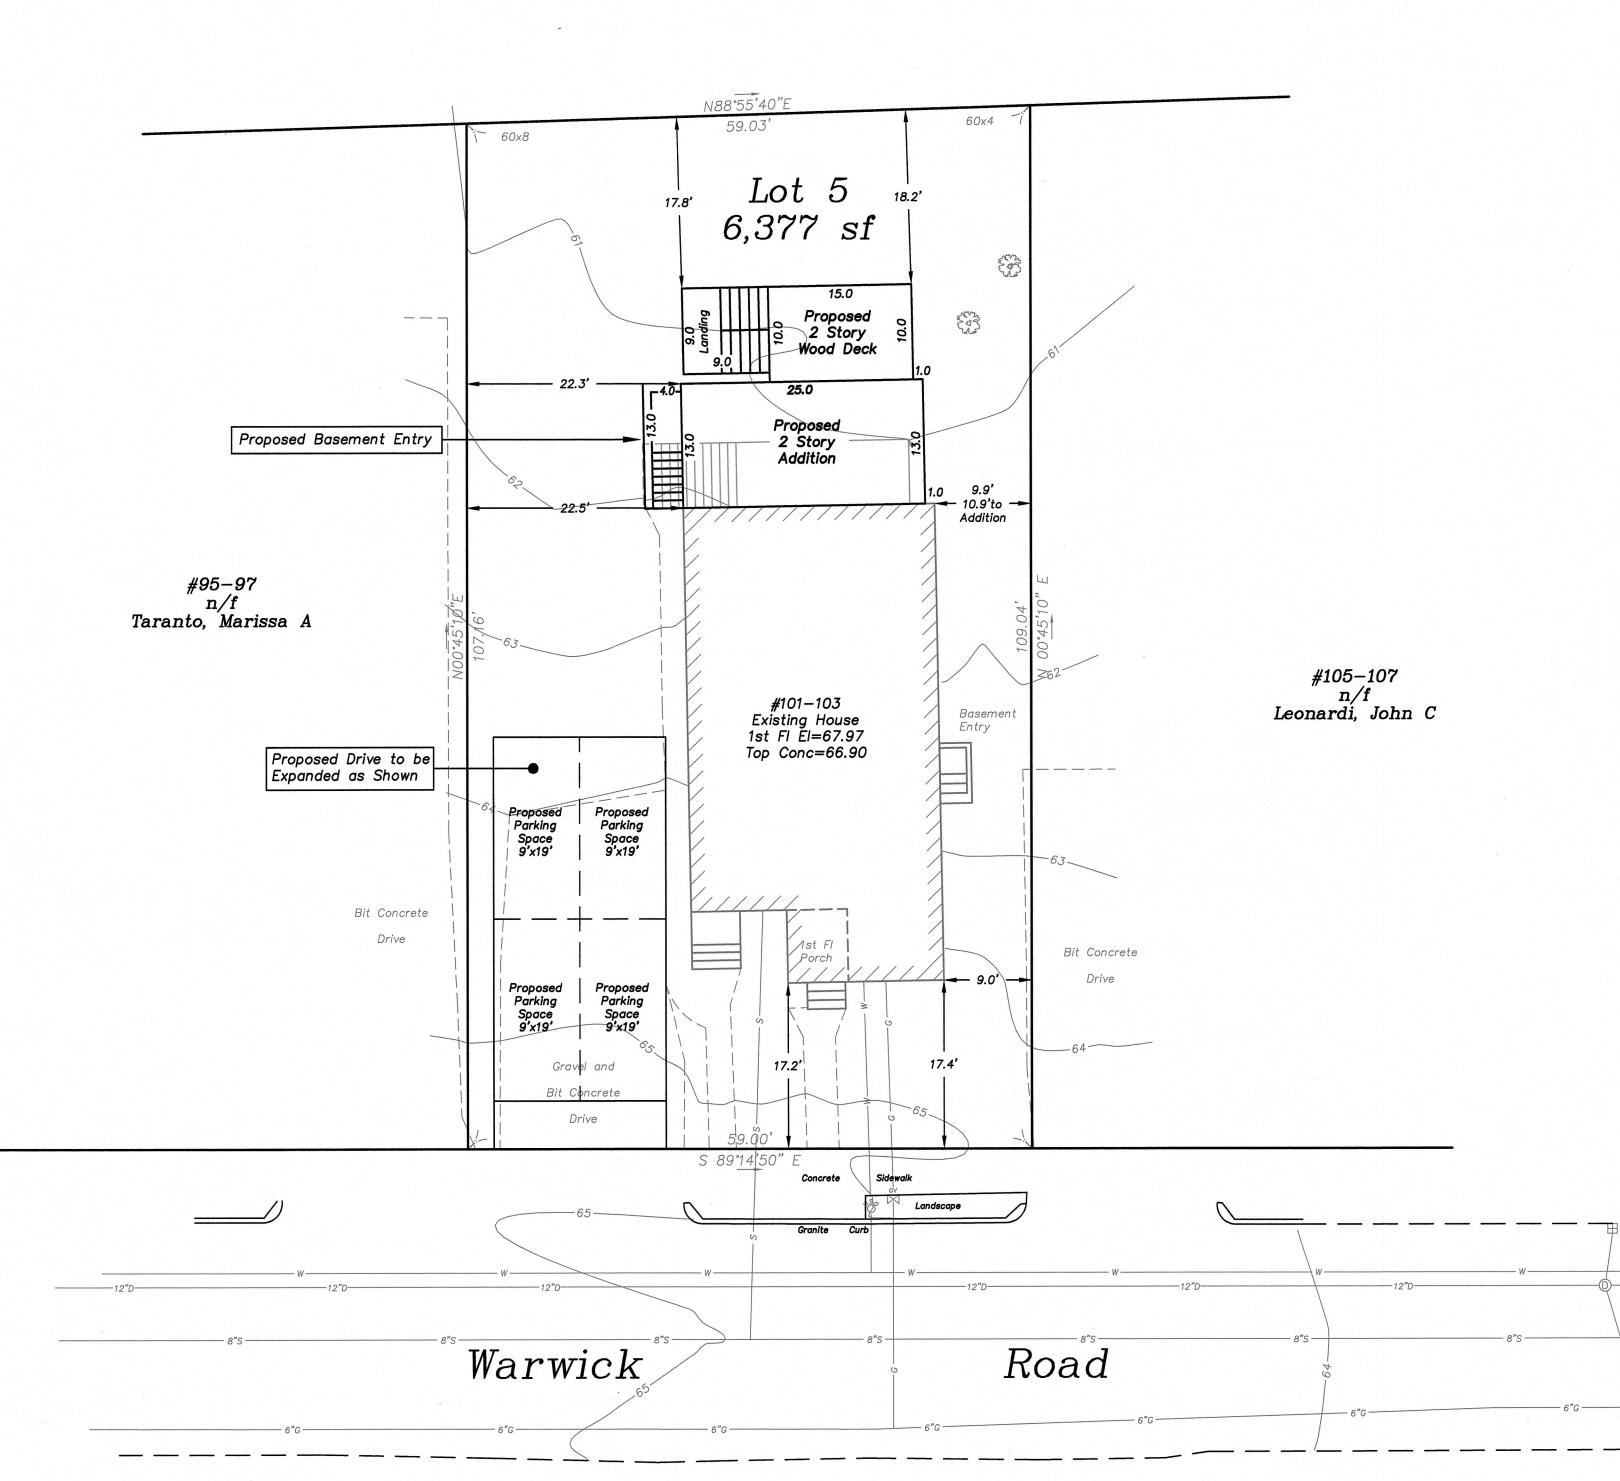

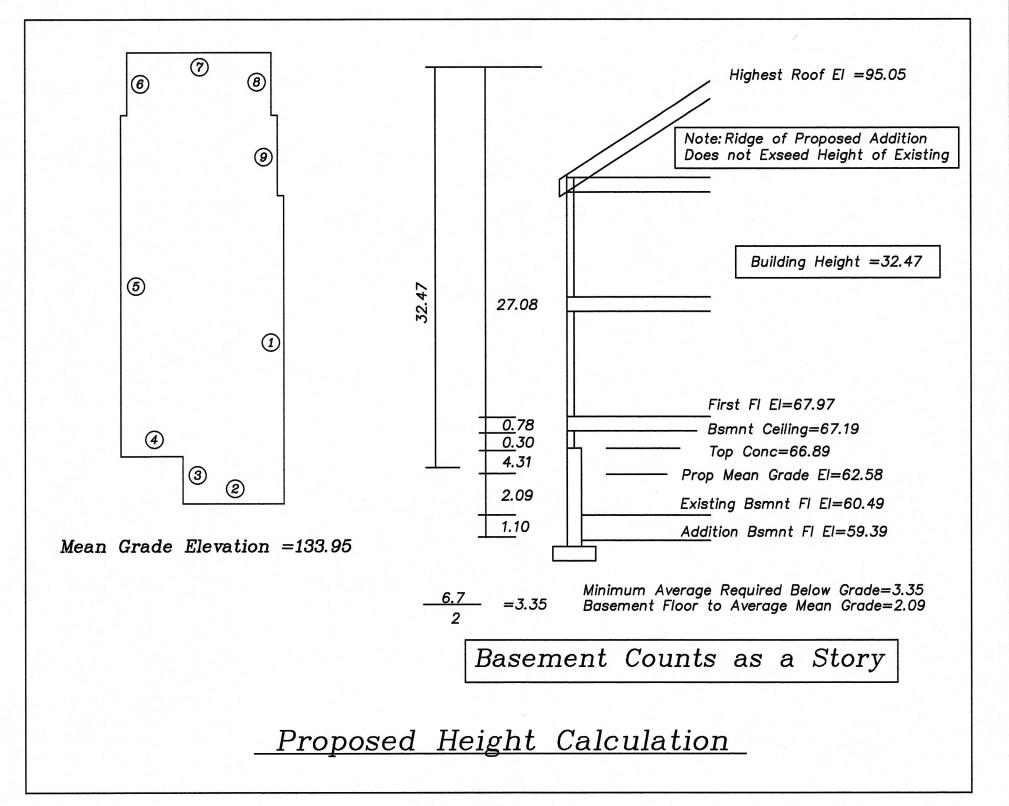

1. Upon City of Newton Special Permit/Variance approval the Applicant will need to apply for a separate Building Permit with Inspectional Services.

2. In association with the proposed addition, and after City of Newton Engineering Division review, it may be determined that the Applicant install an on-site drainage system that meets City of Newton requirements.

3. In association with the proposed addition, and after City of Newton Engineering Division review, it may be determined that the Applicant update/replace the existing water and sewer services.

4. The utilities shown are from field locations and available plans of utility companies and may or may not be correct. Contractor is to contact Dig Safe, all local utility companies and field verify all locations as required prior to any excavation.

5. An erosion control barrier shall be in place prior to any construction and all materials must be contained on site.

6. No excavation is allowed within any City right of way between November 15th and April 15th. If an emergency exists or there are extenuating circumstances, Applicant ma seek permission for such work from the City DPW Commissioner via City Engineer. If permission is granted, special construction standards will be applied. Applicant or Applicant's representative must contact the City Engineering Department prior to start of work for clarification.

7. As of January 1, 2009, all trench excavation contractors shall comply with M.G.L. Chapter 82A, Trench Excavation Safety Requirements, to protect the general public from unauthorized access to unattended trenches. Trench Excavation Permit required. This applies to all trenches on public and private property.

8. Any tree removed from site must comply with City of Newton Tree Ordinance.

101-103 Warwick Road

Newton, Massachusetts

Proposed Conditions Site Plan

Scale: 1"=10'

September 11, 2020

VERNE T. PORTER Jr., PLS

Land Surveyors — Civil Engineers

354 Elliot Street Newton, Massachusetts 02464


Sheet_2_ of_._.


Project: 20011 Checked By: V. Porter Jr.

Drawn By: R. Jardine Jr.

Increase of Impervious Surface=680± sf

Existing utilities shown are from field locations and available plans of record and may or may not be correct. Field verify all locations prior to any excavation.

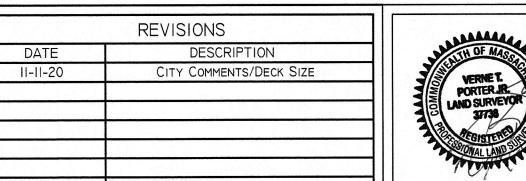

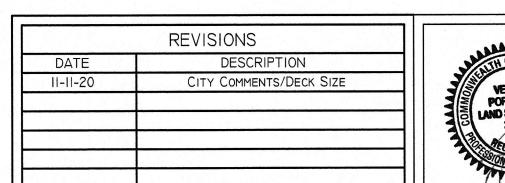

GENERAL NOTES:

ALL WORK TO CONFORM TO MASS. STATE BUILDING CODE CMR 180 NINTH EDITION AND APPLICABLE PLUMBING 4 ELECTRICAL CODES.

CONTRACTOR SHALL OBTAIN ALL REQUIRED PERMITS AND INSPECTIONS. CONTRACTOR TO HAVE WORKMANS COMP. AND LIABILITY INSURANCE AND CONSTRUCTION SUPERVISOR'S LICENSE, AND IS RESPONSIBLE FOR CODE COMPLIANCE AND WORKMANSHIP OF ALL WORK PERFORMED, INCLUDING


CONTRACTOR TO REMOVE AND PROPERLY DISPOSE OF ALL CONSTRUCTION AND DEMOLITION DEBRIS IN WORKMANLIKE FASHION.

CONTRACTOR TO CHECK AND VERIFY ROUGH OPENING SIZES FOR WINDOWS AND DOORS WITH

CONTRACTOR'S BIDS TO INCLIDE SPECIFIC INFORMATION REGARDING WOODWORK, FLOORING, FINISHES, DOOR STYLES, AND PLUMBING HXTURES, WITH ALLOWANCES FOR TILLE WORK, CABINETRY, CONTEXTORS, LIGHTING, AND APPLIANCES INCLUDED WITH PROPOSED WORK.

	WINDOW SCHEDULE						
П	ANDERSEN CATALOG	UNIT SIZE W X H	ROUGH OPENING WXH	NOTES			
\square	TW2646 **	2'-7\$"×4'-8}"	2'-8\(\frac{1}{8}\)" \times 4'-8\(\frac{1}{8}\)"	SINGLE DOUBLE HUNG			
	TW2446-2 **	4'-116"×4'-83"	4'-118"×4'-83"	DOUBLE-WIDE DOUBLE HUNG			
Ø	TW2442	2'-5g"×4'-4g"	2'-68"×4'-48"	SINGLE DOUBLE HUNG			
ø	CWI35	2'-4흫"× 3'-4읂"	2'-43"×3'-53"	CASEMENT WINDOW			
E	CN235	3'-43"×3'-412"	3'-54"×3'-53"	CASEMENT WINDOW			
Œ	FWG6068	5'-112" x 6'-72"	6'-0" × 6'-8"	PATIO SLIDERS			
G							
\odot							
	<u> </u>	· ·					
\otimes		·					

- .. VERIFY THAT WINDOW MEETS BEDROOM EGRESS REQUIREMENT OF MIN. 24W" x 20H" CLEAR OPENING.
- ... TEMPERED GLASS REQUIRED OVER BATH TUB
- VERIFY MIN. 2'-8" WIDE FOR REQUIRED EGRESS

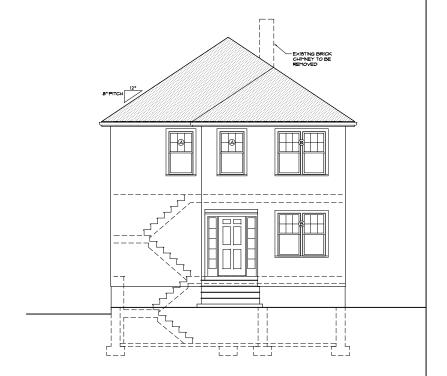

REV.: 11-09-2020 REVISED REAR DECK PER ZBA APPROVAL

© 2020 SCOTT LEWIS - DO NOT REPRODUCE WITHOUT WRITTEN PERMISSION

F.A.R. ARE	AS:	
1,515.5 SF 1,563.4 SF	FIRST FLOOR SECOND FLOOR	101-103 WARWICK ROA
3,078.9 SF 3,122.0 SF	TOTAL F.A.R. AREA MAX. ALLOWABLE F.A.R. W/BONUS	NEWTON, MA



DRAWING LIST:

- COVER SHEET
- A1 FIRST FLOOR PLAN
- A2 SECOND FLOOR PLAN
- Α3 ATTIC FLOOR PLAN
- A4 BASEMENT FLOOR PLAN
- A5 FRONT ELEVATION
- A6 BUILDING SECTION 2
- AT RIGHT SIDE ELEVATION
- AS REAR ELEVATION
- A9 LEFT SIDE ELEVATION
- FI FIRST & SECOND FLOOR FRAMING
- F2 ATTIC & ROOF FRAMING

COVER PAGE

DATE: 03-16-2020 EXISTING CONDITIONS REV.: 05-18-2020 DESIGN DEVELOPMENT REV.: 06-22-2020 FOR CONSTRUCTION

101-103WARWICK_NEWTON_1.dwg


PROJECT DESIGN:

CLIENT: JOSEPH DeNUCCI

SCOTT LEWIS 365 GROVE STREET

119-121 WARWICK ROAD WEST ROXBURY, MA \emptyset 2132 WEST NEWTON, MA \emptyset 2465

(617) 293-6371 (617) 999-0653

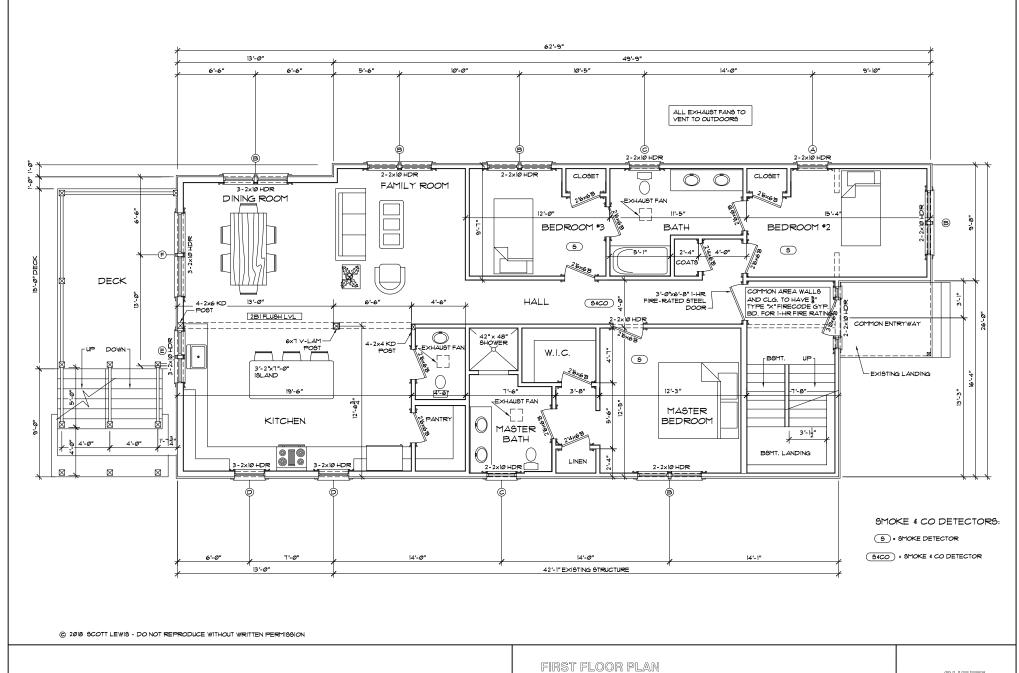


101-103 WARWICK ROAD NEWTON, MA

SCALE: 1/4" = 1'-0"

SCOTT LEWIS 365 GROVE STREET WEST ROXBURY, MA Ø2466

DATE: 11-09-2020

101-103WARWICK_NEWTON_1.dwg

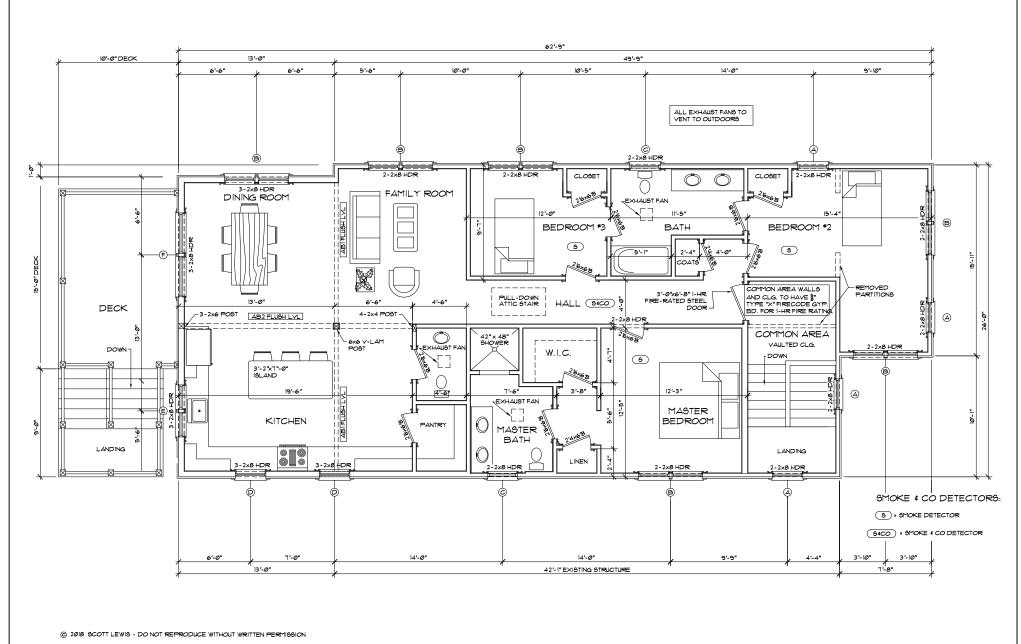

101-103 WARWICK ROAD NEWTON, MA

SECOND FLOOR PLAN


SCALE: 1/4" = 1'-0"

SCOTT LEWIS 365 GROVE STREET WEST ROXBURY, MA 02466

DATE: 11-09-2020

101-103WARWICK_NEWTON_1.dwg



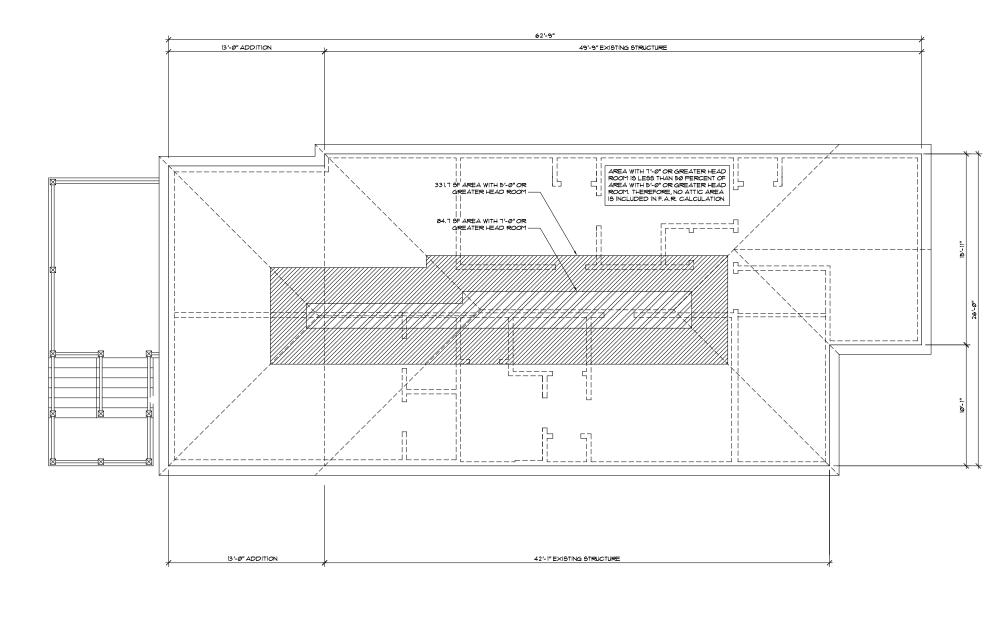

© 2018 SCOTT LEWIS - DO NOT REPRODUCE WITHOUT WRITTEN PERMISSION

101-103 WARWICK ROAD NEWTON, MA

ATTIC FLOOR PLAN

SCALE: 1/4" = 1'-0"


SCOTT LEWIS 365 GROVE STREET WEST ROXBURY, MA 02466


DATE: 11-09-2020



SHEET

101-103WARWICK_NEWTON_1.dwg

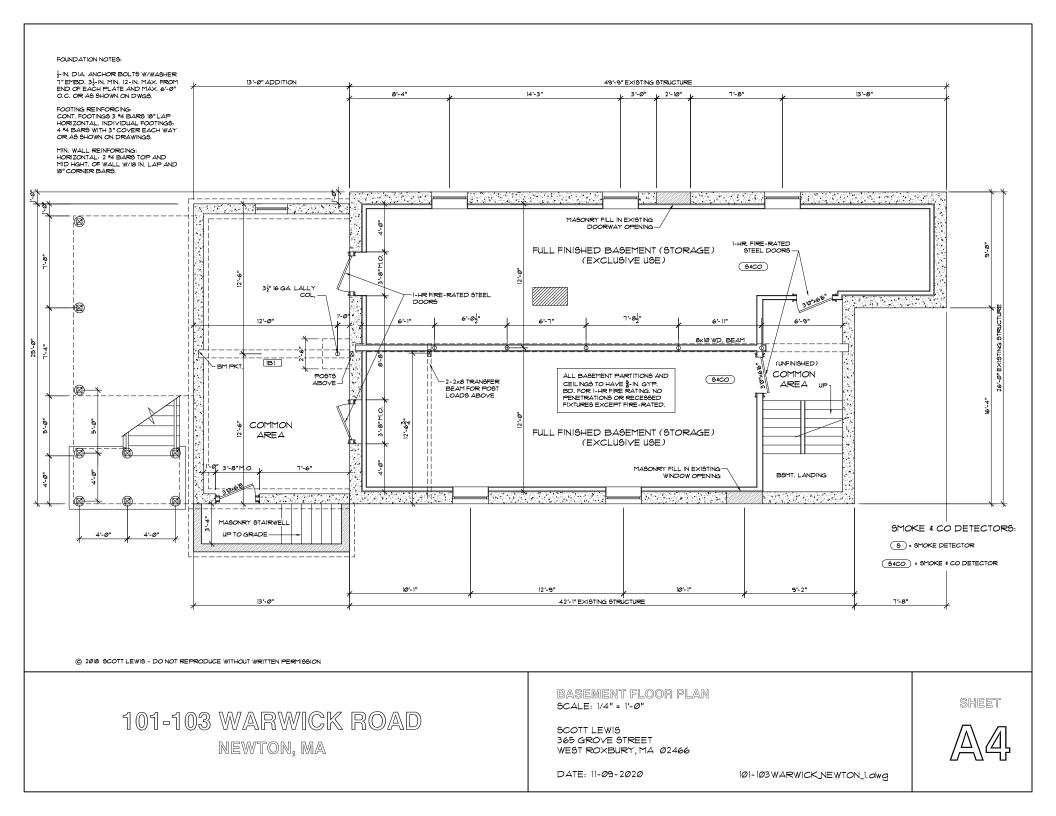

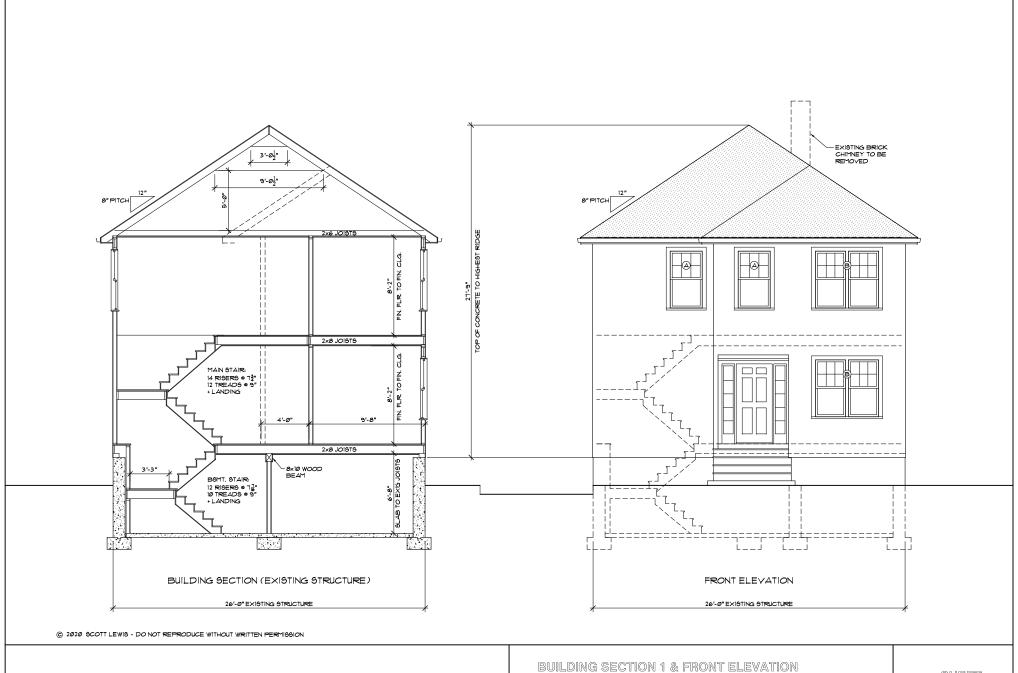

101-103 WARWICK ROAD

NEWTON, MA


SCALE: 1/4" = 1'-0"

SCOTT LEWIS 365 GROVE STREET WEST ROXBURY, MA Ø2466


DATE: 11-09-2020

101-103WARWICK_NEWTON_1.dwg



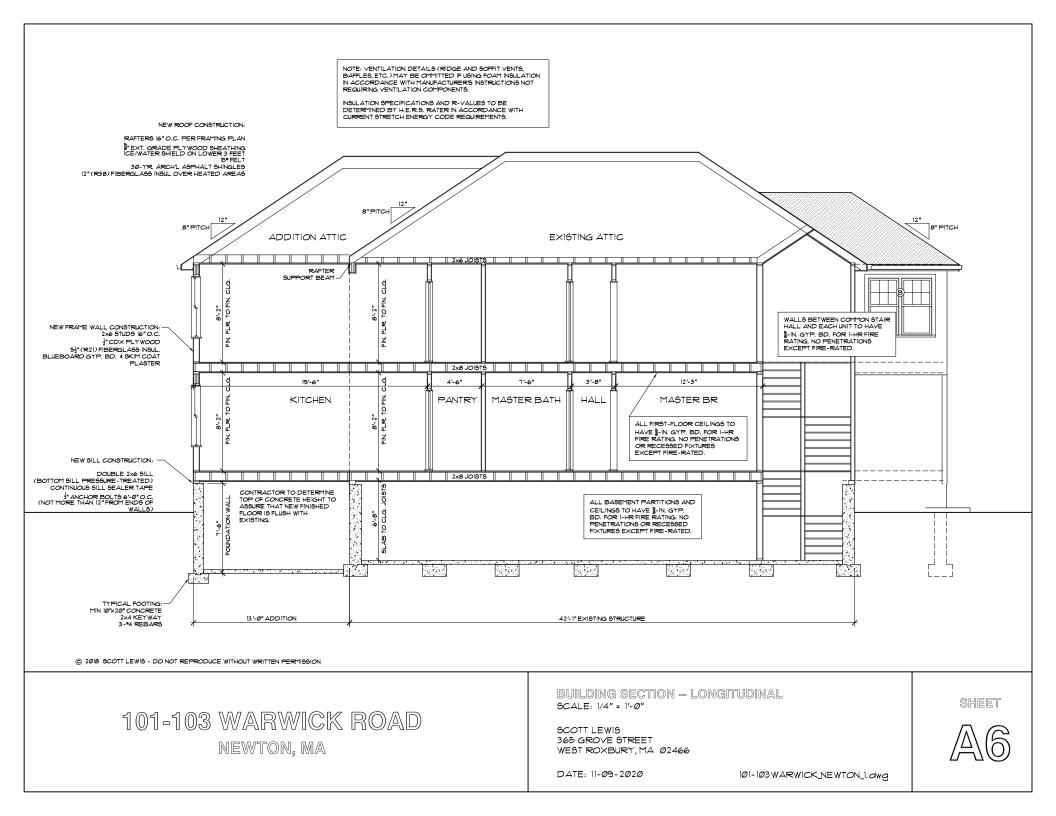



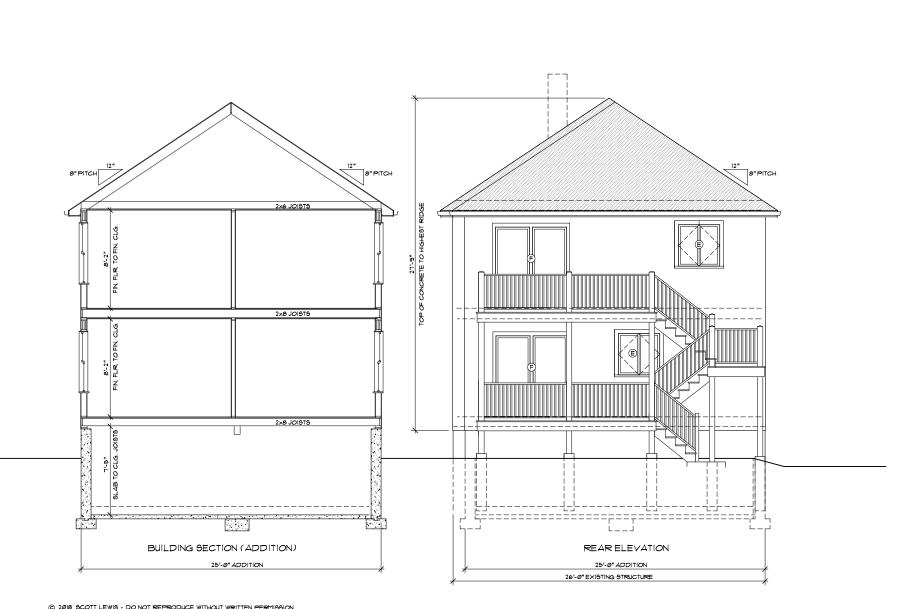

© 2018 SCOTT LEWIS - DO NOT REPRODUCE WITHOUT WRITTEN PERMISSION

101-103 WARWICK ROAD NEWTON, MA

REAR ELEVATION

SCALE: 1/4" = 1'-0"

SCOTT LEWIS 365 GROVE STREET WEST ROXBURY, MA Ø2466

DATE: 11-09-2020

101-103WARWICK_NEWTON_1.dwg





