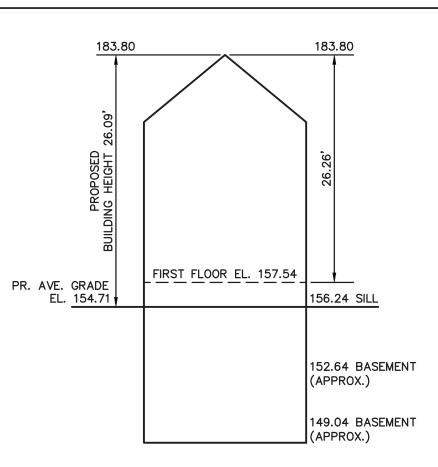


<u>n Weighted Mean</u>								
s /	s Average Grade Calculation							
: it nt	D Height of Low Point of Segment	E E=(C+D)/2 Average Segment Height	F F=BxE					
1000000000	156.32	156.25	1156.25 Sq. Ft.					
	155.92	156.21	2205.69 Sq. Ft.					
	155.92	155.93	904.39 Sq. Ft.					
	155.00	155.53	2266.07 Sq. Ft.					
	154.64	154.94	2788.92 Sq. Ft.					
	154.22	154.62	3107.86 Sq. Ft.					
	154.20	154.30	857.91 Sq. Ft.					
	154.20	154.31	972.12 Sq. Ft.					
	155.60	154.91	1936.31 Sq. Ft.					
	149.37	149.76	1767.17 Sq. Ft.					
	155.26	155.48	404.25 Sq. Ft.					
	156.41	156.41	985.35 Sq. Ft.					
	156.29	156.33	2141.72 Sq. Ft.					
	156.54	156.46	797.95 Sq. Ft.					
	156.41	156.48	1689.93 Sq. Ft.					
	156.16	156.56	1142.85 Sq. Ft.					
	156.24	156.20	2358.62 Sq. Ft.					
			27483.36 Sq. Ft.					



PROPOSED BUILDING HEIGHT NOT TO SCALE

Length Weighted Mean Proposed Conditions Average Grade Calculation								
A	B Length Of Segment in Feet	C Height of High Point of Segment	D Height of Low Point of Segment	E E=(C+D)/2 Average Segment Height	F=BxE			
1	7.40	156.18	156.32	156.25	1156.25 Sq. Ft.			
2	14.12	156.50	155.92	156.21	2205.69 Sq. Ft.			
3	5.80	155.94	155.92	155.93	904.39 Sq. Ft.			
4	14.57	156.06	155.00	155.53	2266.07 Sq. Ft.			
4	19.00	154.25	154.25	154.25	2930.75 Sq. Ft.			
5	20.10	154.50	154.00	154.25	3100.43 Sq. Ft.			
6	42.60	154.00	153.20	153.60	6543.36 Sq. Ft.			
7	16.00	153.10	153.10	153.10	2449.60 Sq. Ft.			
8	26.90	153.20	153.70	153.45	4127.81 Sq. Ft.			
9	12.52	153.70	153.90	153.80	1925.58 Sq. Ft.			
10	6.70	153.50	154.20	153.85	1030.80 Sq. Ft.			
9	11.80	154.00	154.50	154.25	1820.15 Sq. Ft.			
9	2.60	155.30	155.00	155.15	403.39 Sq. Ft.			
10	6.30	156.41	156.00	156.21	984.09 Sq. Ft.			
11	13.70	156.37	156.29	156.33	2141.72 Sq. Ft.			
12	5.10	156.38	156.54	156.46	797.95 Sq. Ft.			
13	10.80	156.54	156.41	156.48	1689.93 Sq. Ft.			
14	7.30	156.95	156.16	156.56	1142.85 Sq. Ft.			
15	15.10	156.16	156.24	156.20	2358.62 Sq. Ft.			
Total	258.41				39979.41 Sq. Ft.			
Total Column F / Total Column B = Average Grade Average Grade: 154.71'								

ZONING CHART NEWTON, MASSACHUSETTS ZONE: SR-2 (OLD) SUBMISSION: BLDG. PERMIT REQUIRED EXISTING EXISTING REGULATION 10,000s.f. 10,417±s.f. LOT AREA N/C N/C LOT FRONTAGE 80.0' 80.0' N/C FRONT SETBACK 25.0'/21.7' 21.3'* SIDE SETBACK 7.5' 8.6' 7.8' REAR SETBACK 32.5**'** 15.0' 57.8**'** BUILDING HEIGHT 28.57' 29.09**'** 36.0' AVERAGE GRADE 155.23 154.71 — LOT COVERAGE 30.0% 19.5% 24.2% 50.0% 75.1% 73.4% OPEN SPACE

> TOPOGRAPHIC SITE PLAN NEWTON, MASSACHUSETTS SHOWING PROPOSED CONDITIONS AT #39 NORWOOD AVENUE

*DOES NOT MEET REQUIREMENTS

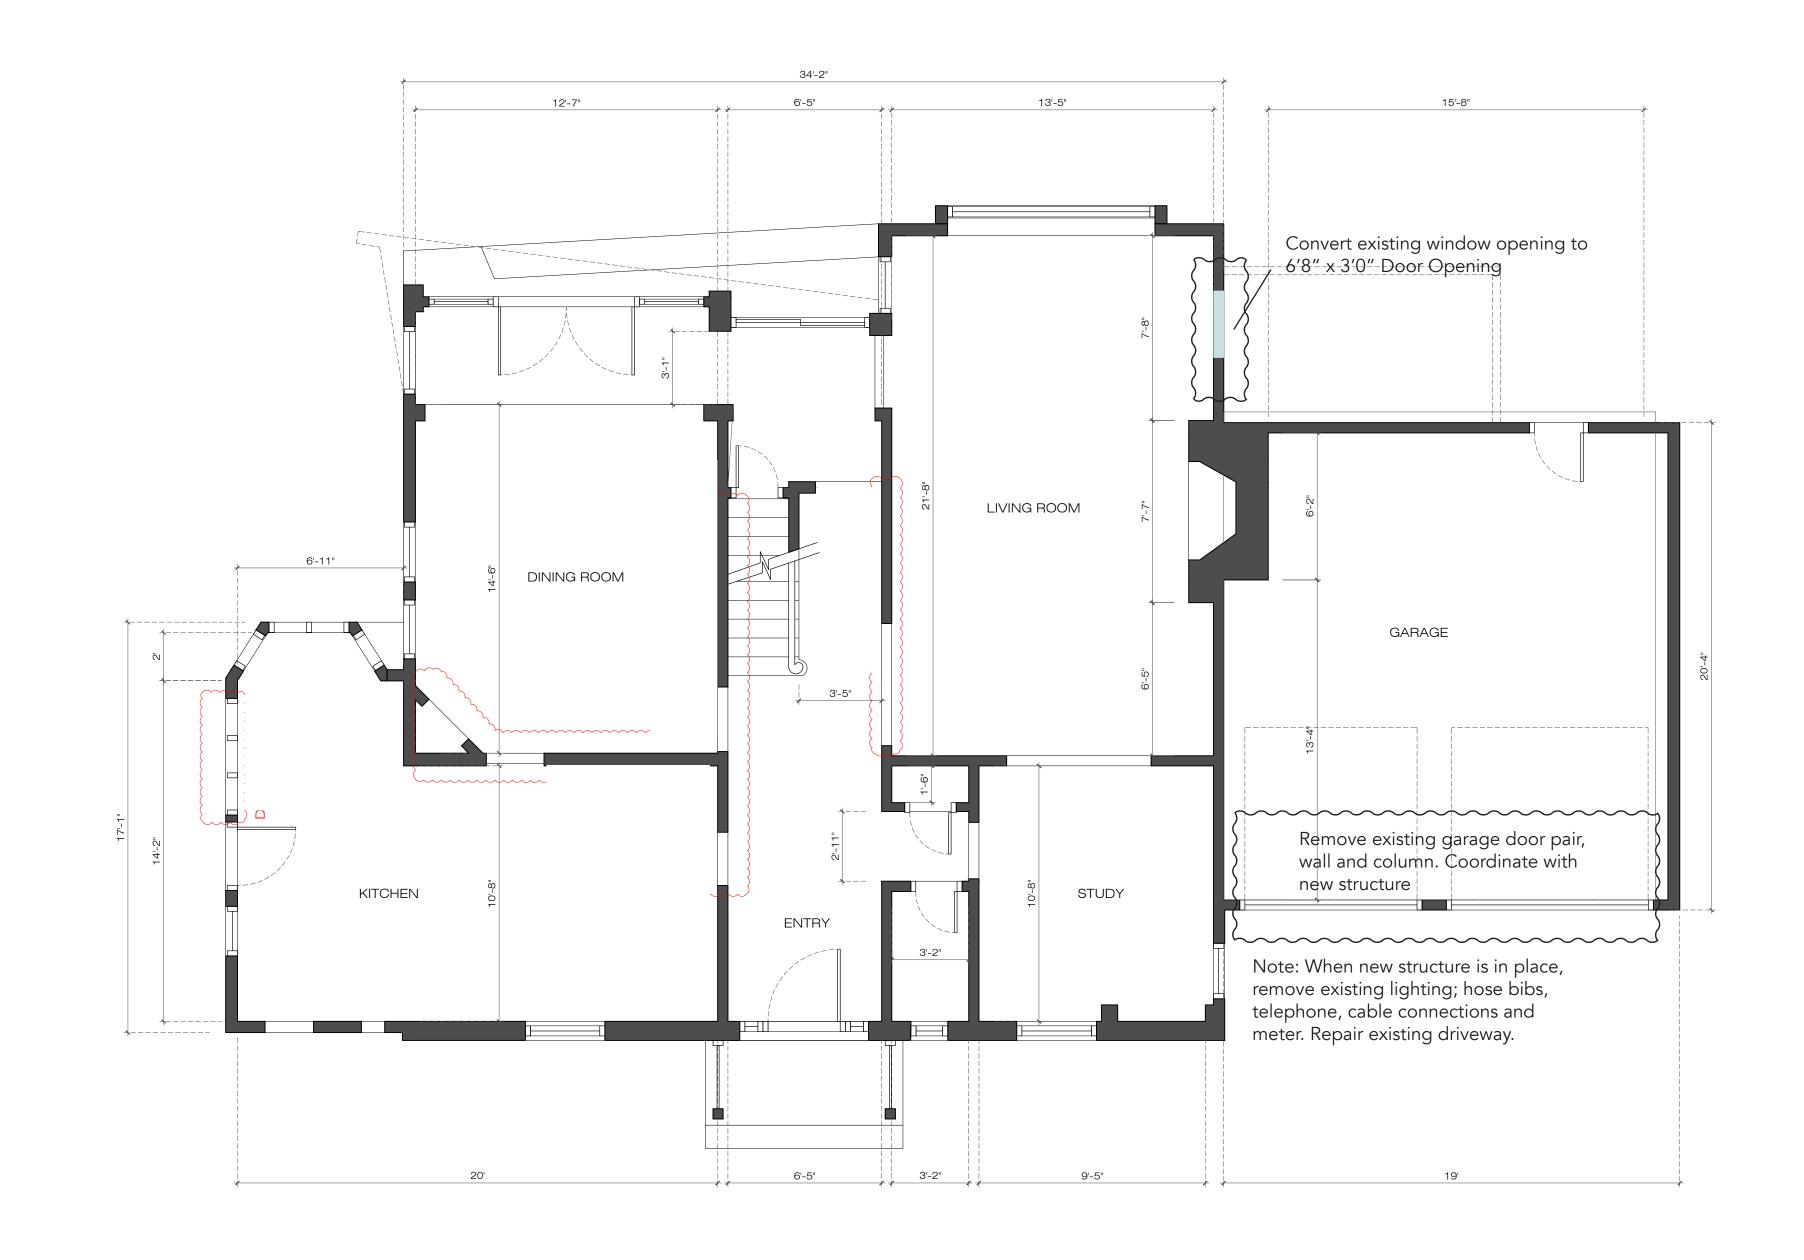
DATE: JULY 2, 2020 REVISED: AUGUST 27, 2020; SCALE: 1in.=10ft. SEPTEMBER 8, 2020 PROJECT: 99228



LAND SURVEYORS – CIVIL ENGINEERS. 132 ADAMS STREET 2ND FLOOR SUITE 3 NEWTON, MA 02458 (617) 332-8271

INC.

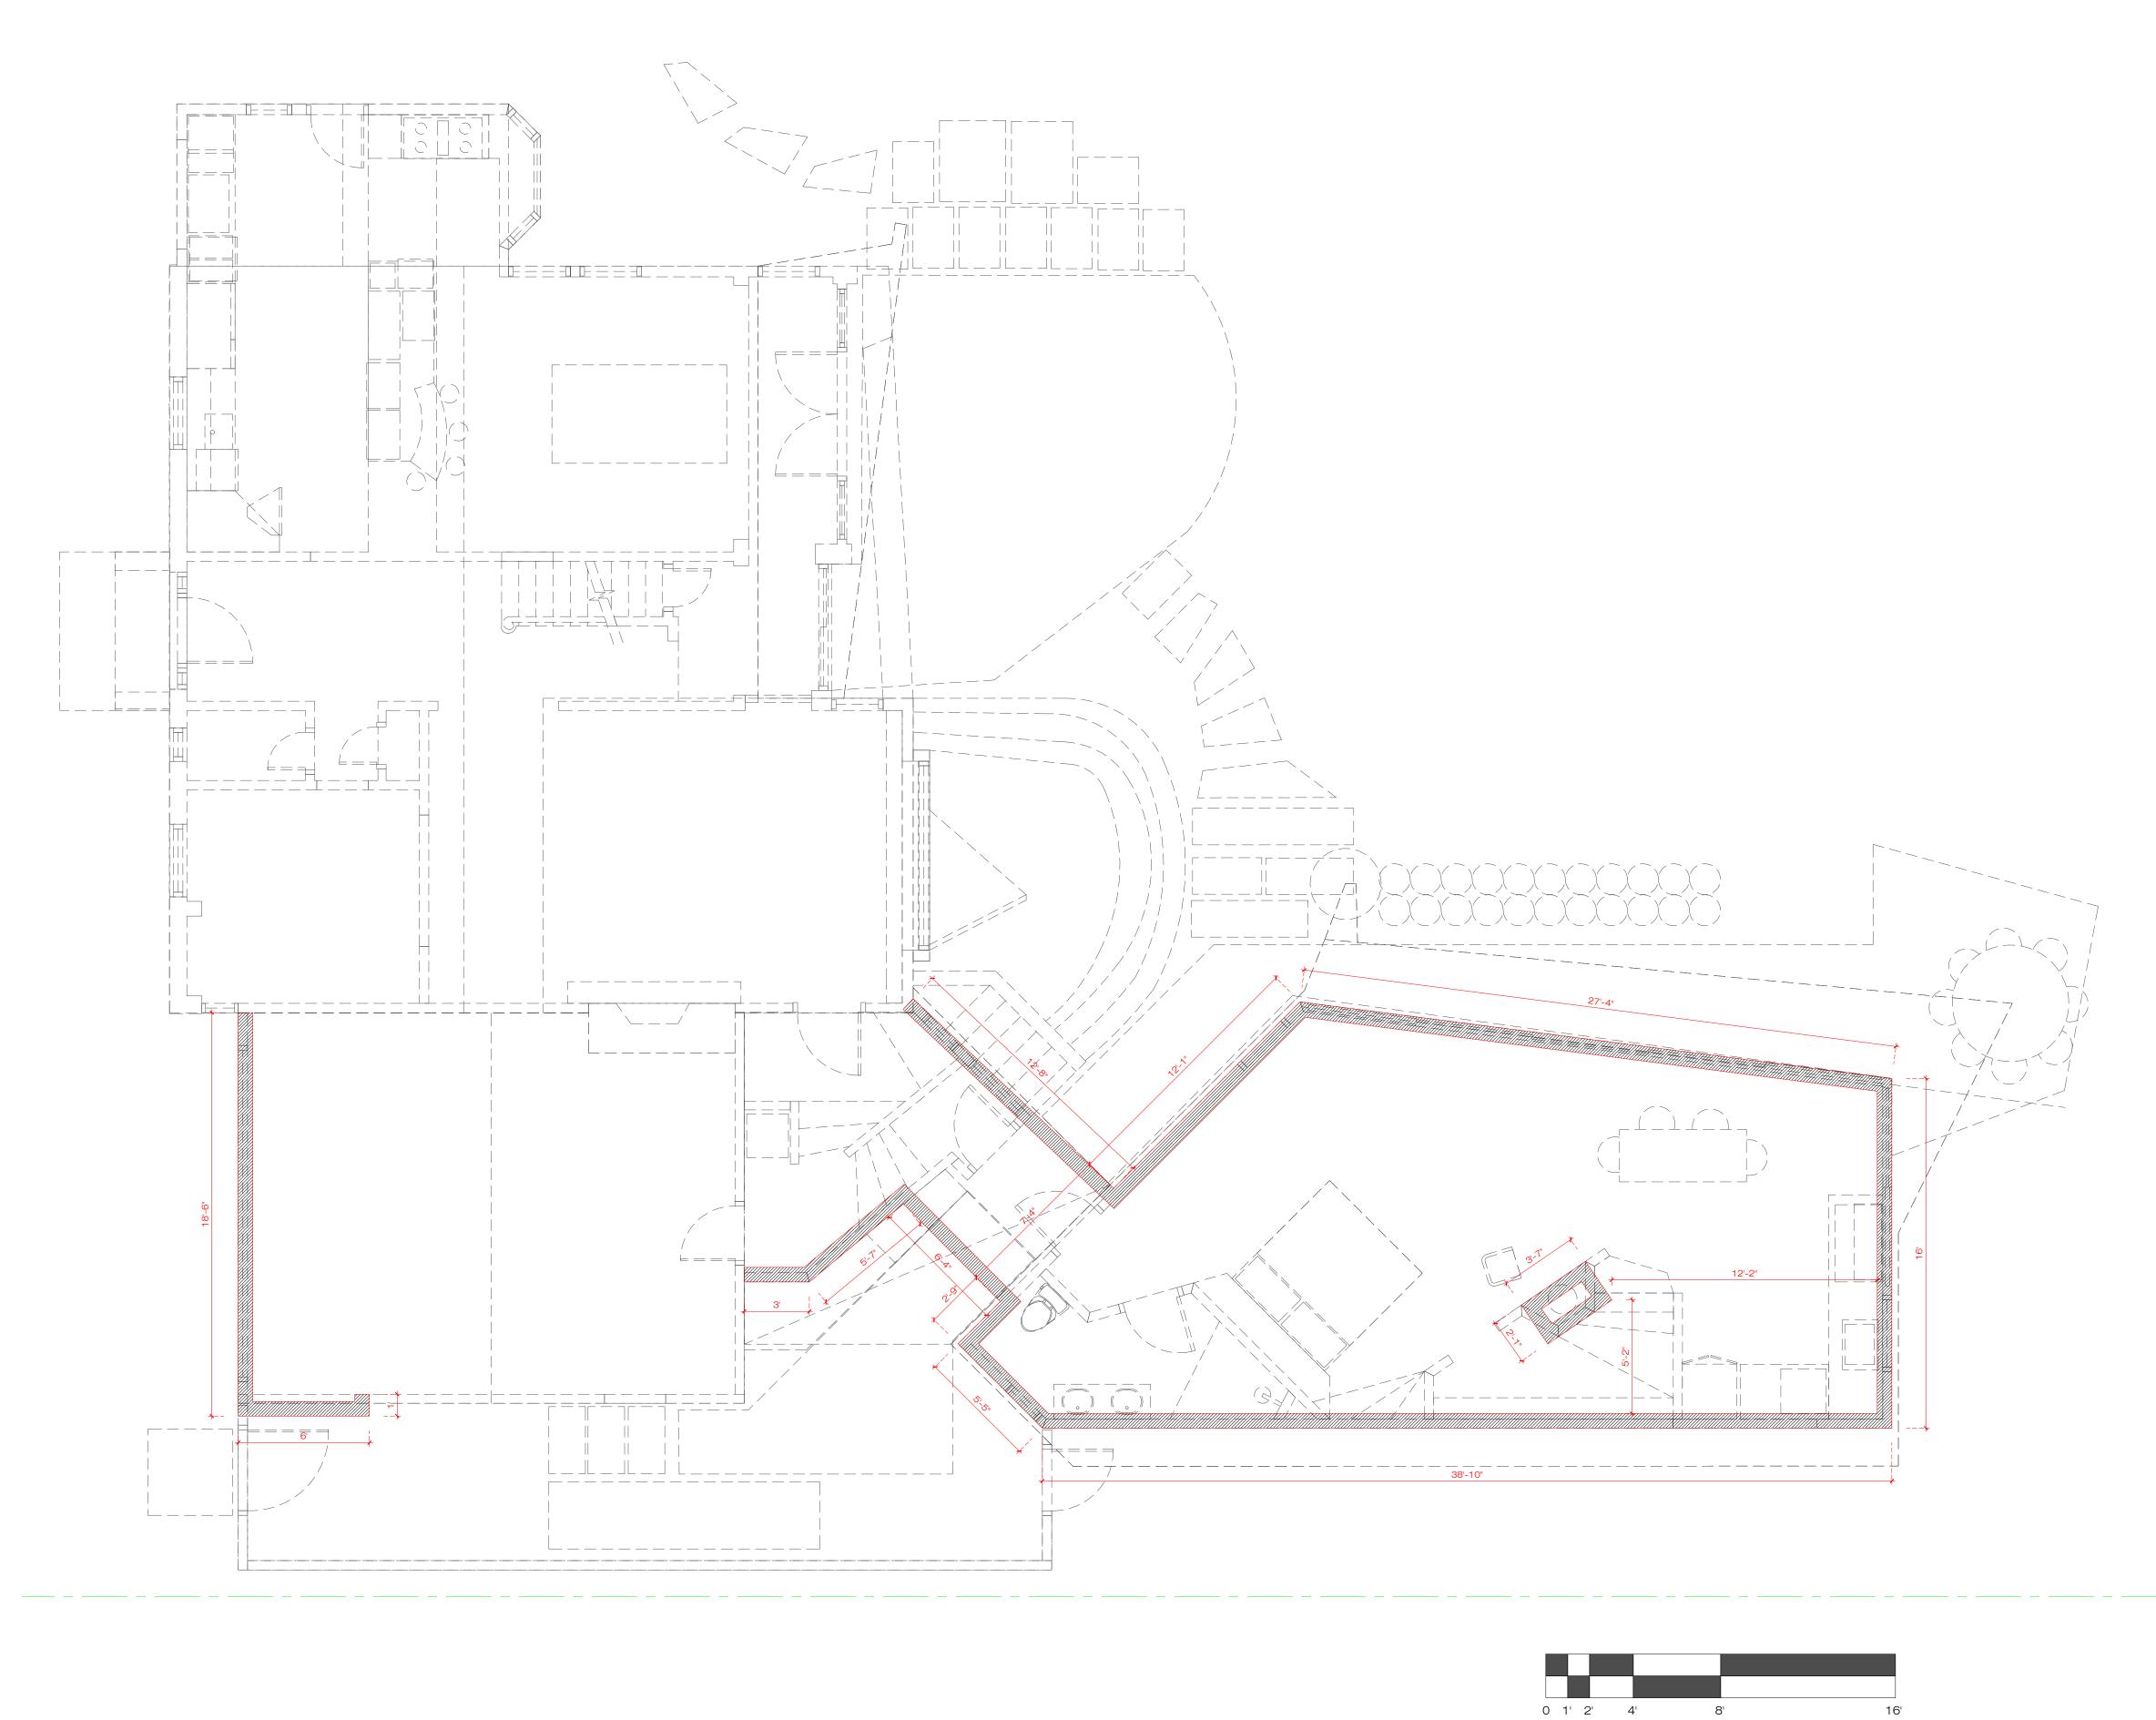
SHEET 1 OF 1



Phase 2- Additions 39 Norwood Avenue Newton Center. MA						
ARCHITECT John R. Shields. FAIA						
INTERIOR DESIGNER						
LANDSCAPE ARCHITECT						
STRUCTURE ENGINEER						
SYSTEMS ENGINEER						
GENERAL NOTE						
REVISION						
No. DATE R.	NOTE					
OWNER						
John R. Shield Christiane S. E						
PROJECT NAME Phase 2- Shield Residential Ren						
DRAWING TITLE						
PROJECT CODE	DRAWING NO.					
	ID-101B					
CONSTRUCTION RE	FERENCE DRAWING					

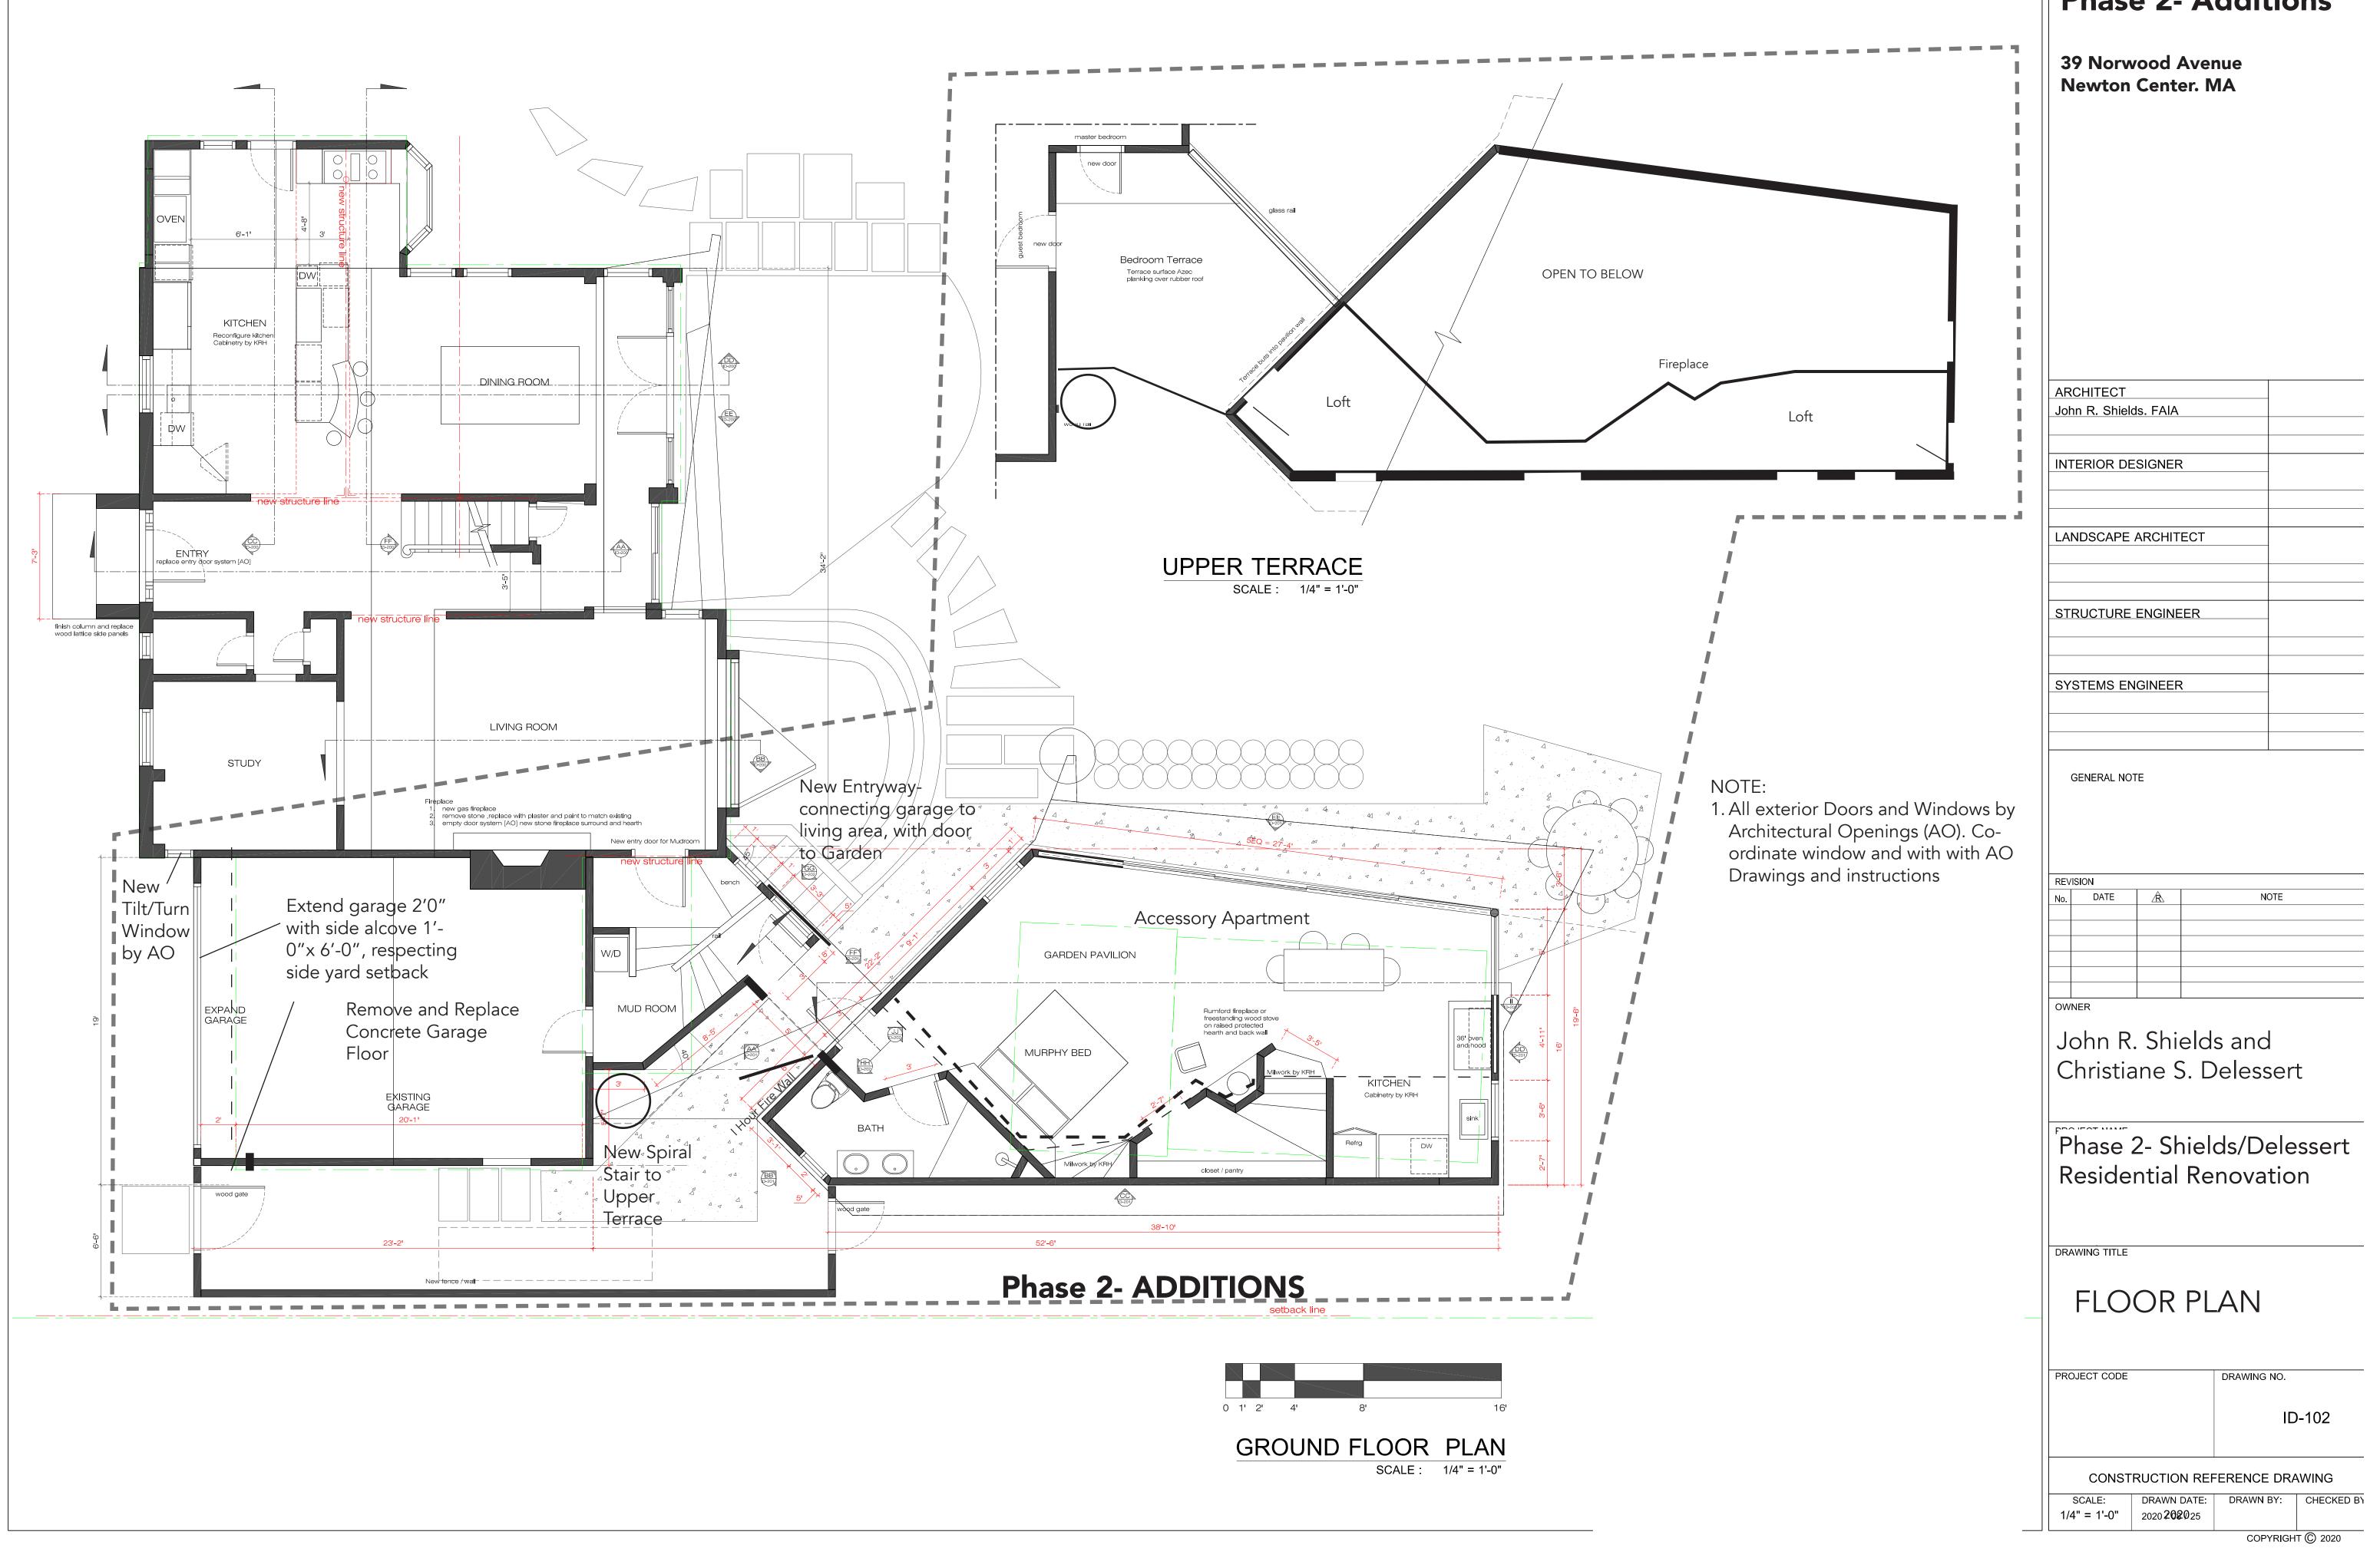






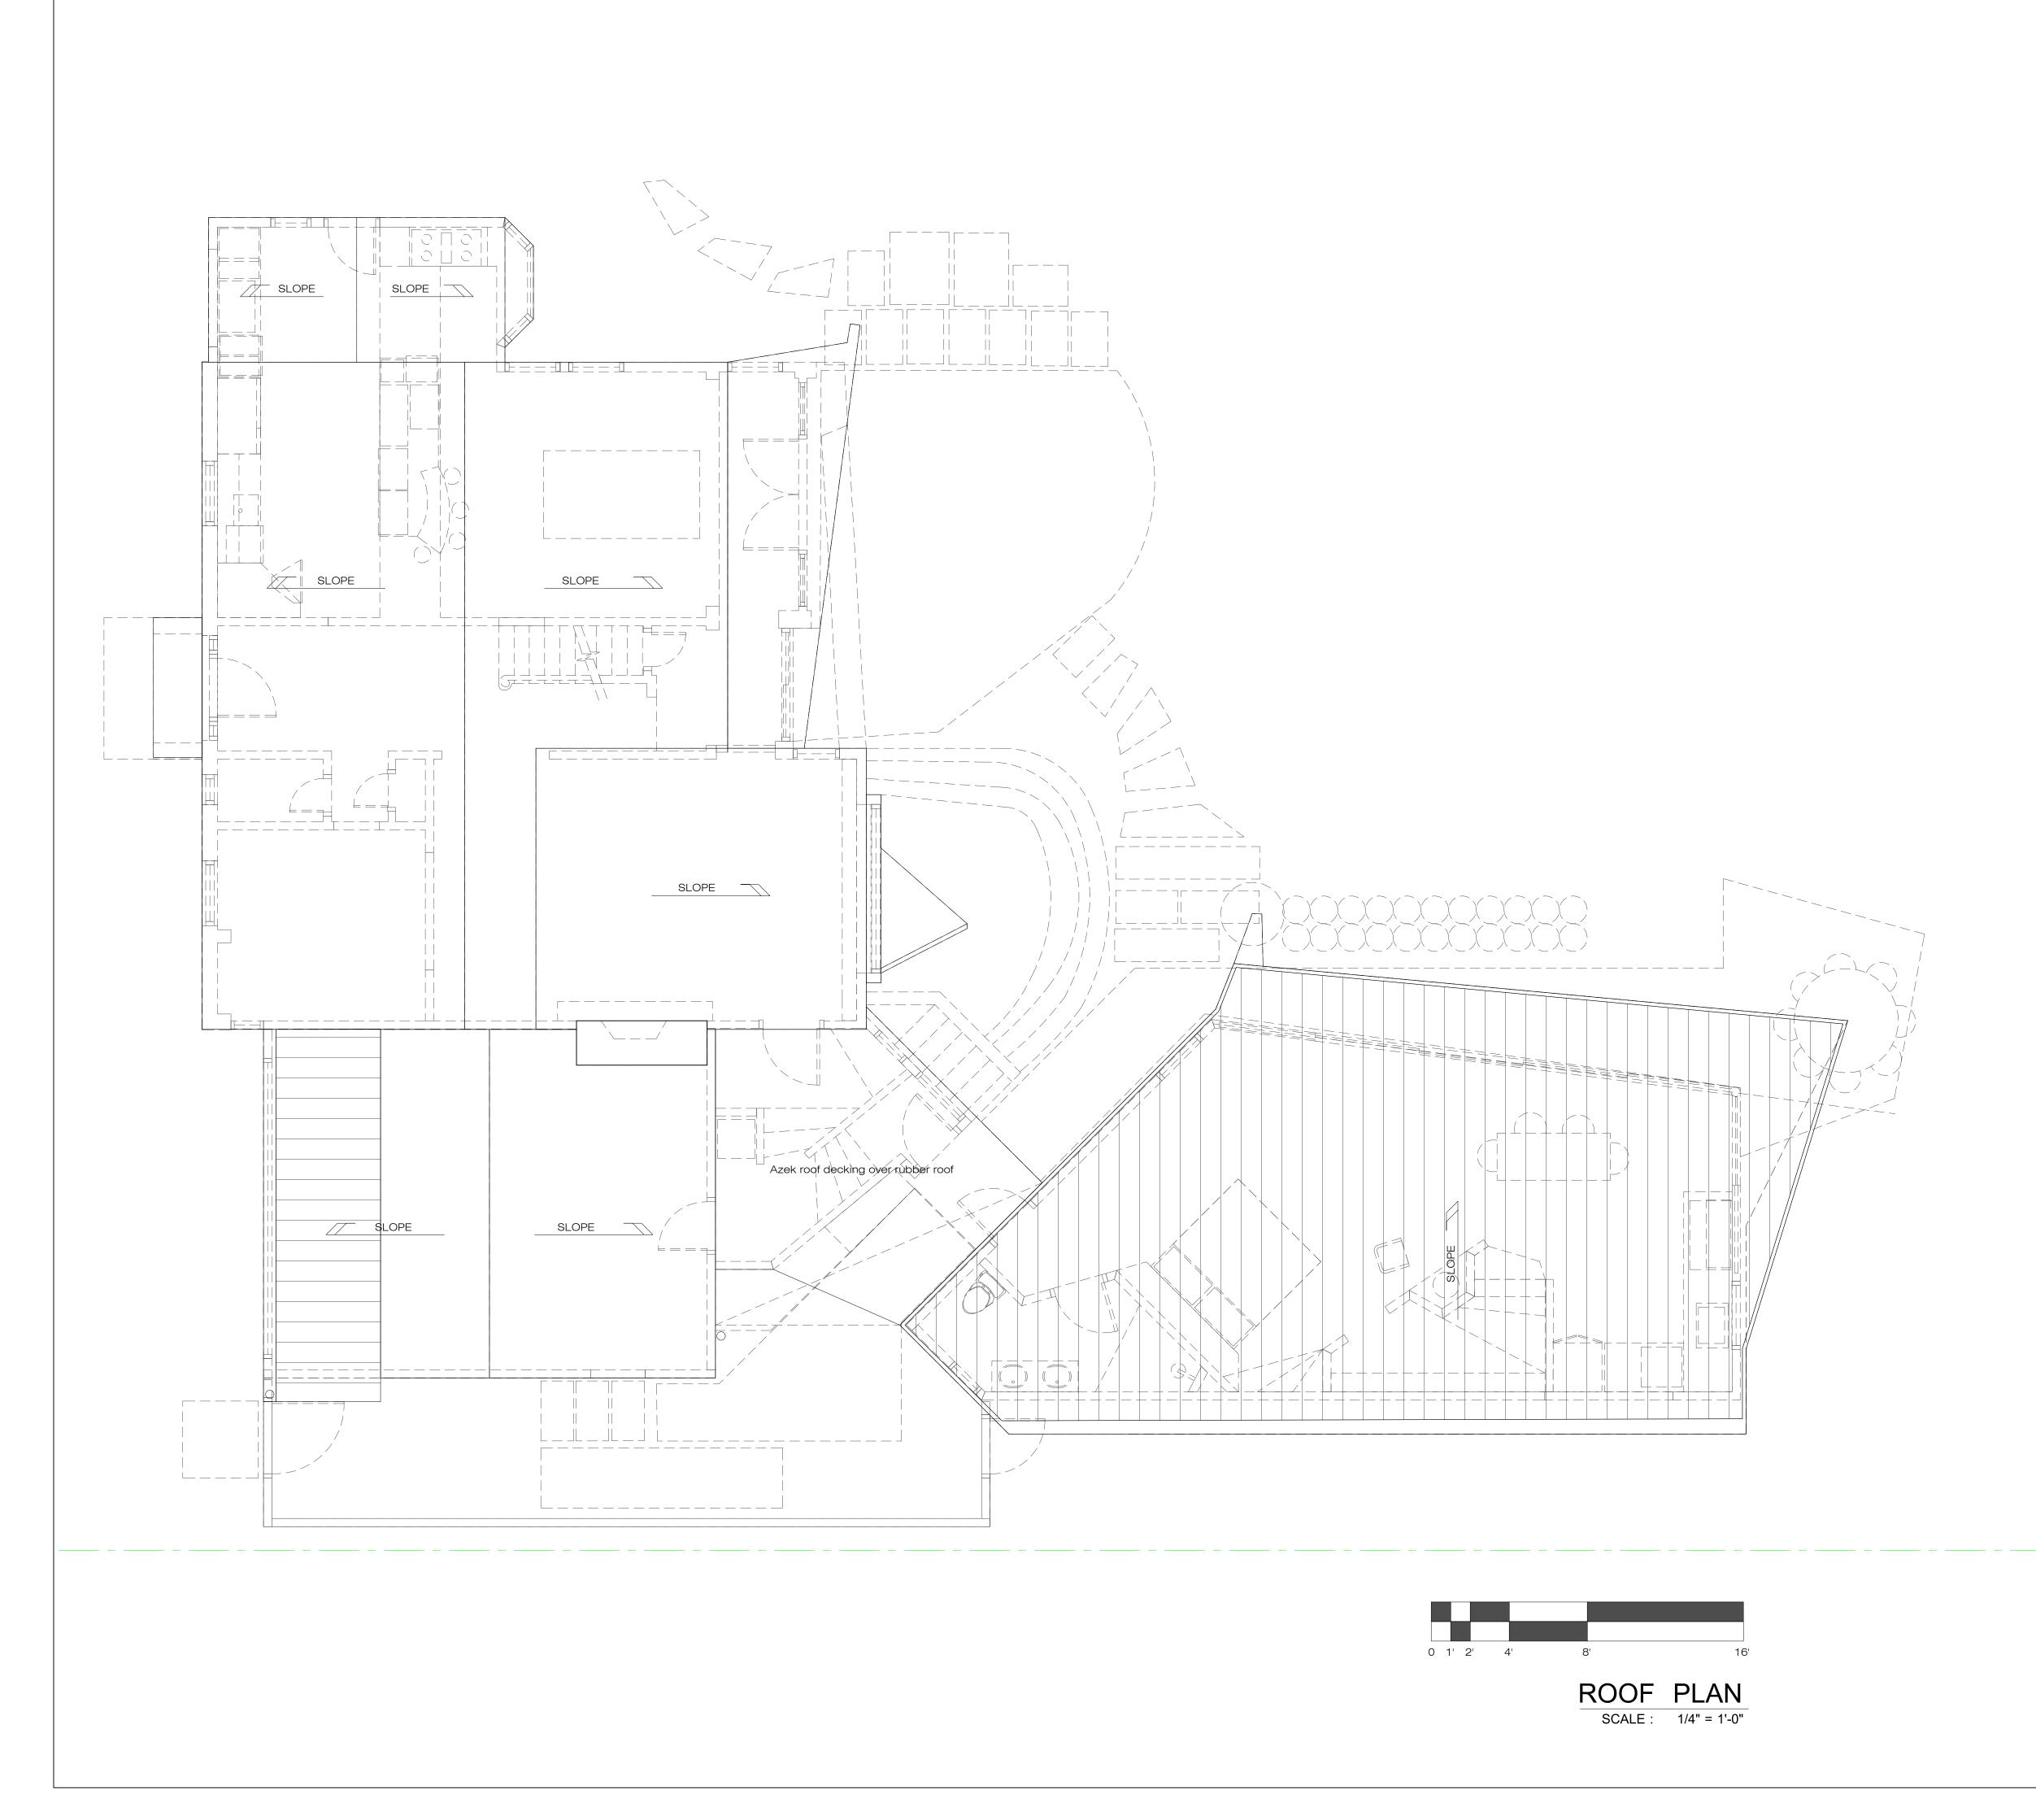
FOUNDATION WALLPLANSCALE :1/4" = 1'-0"

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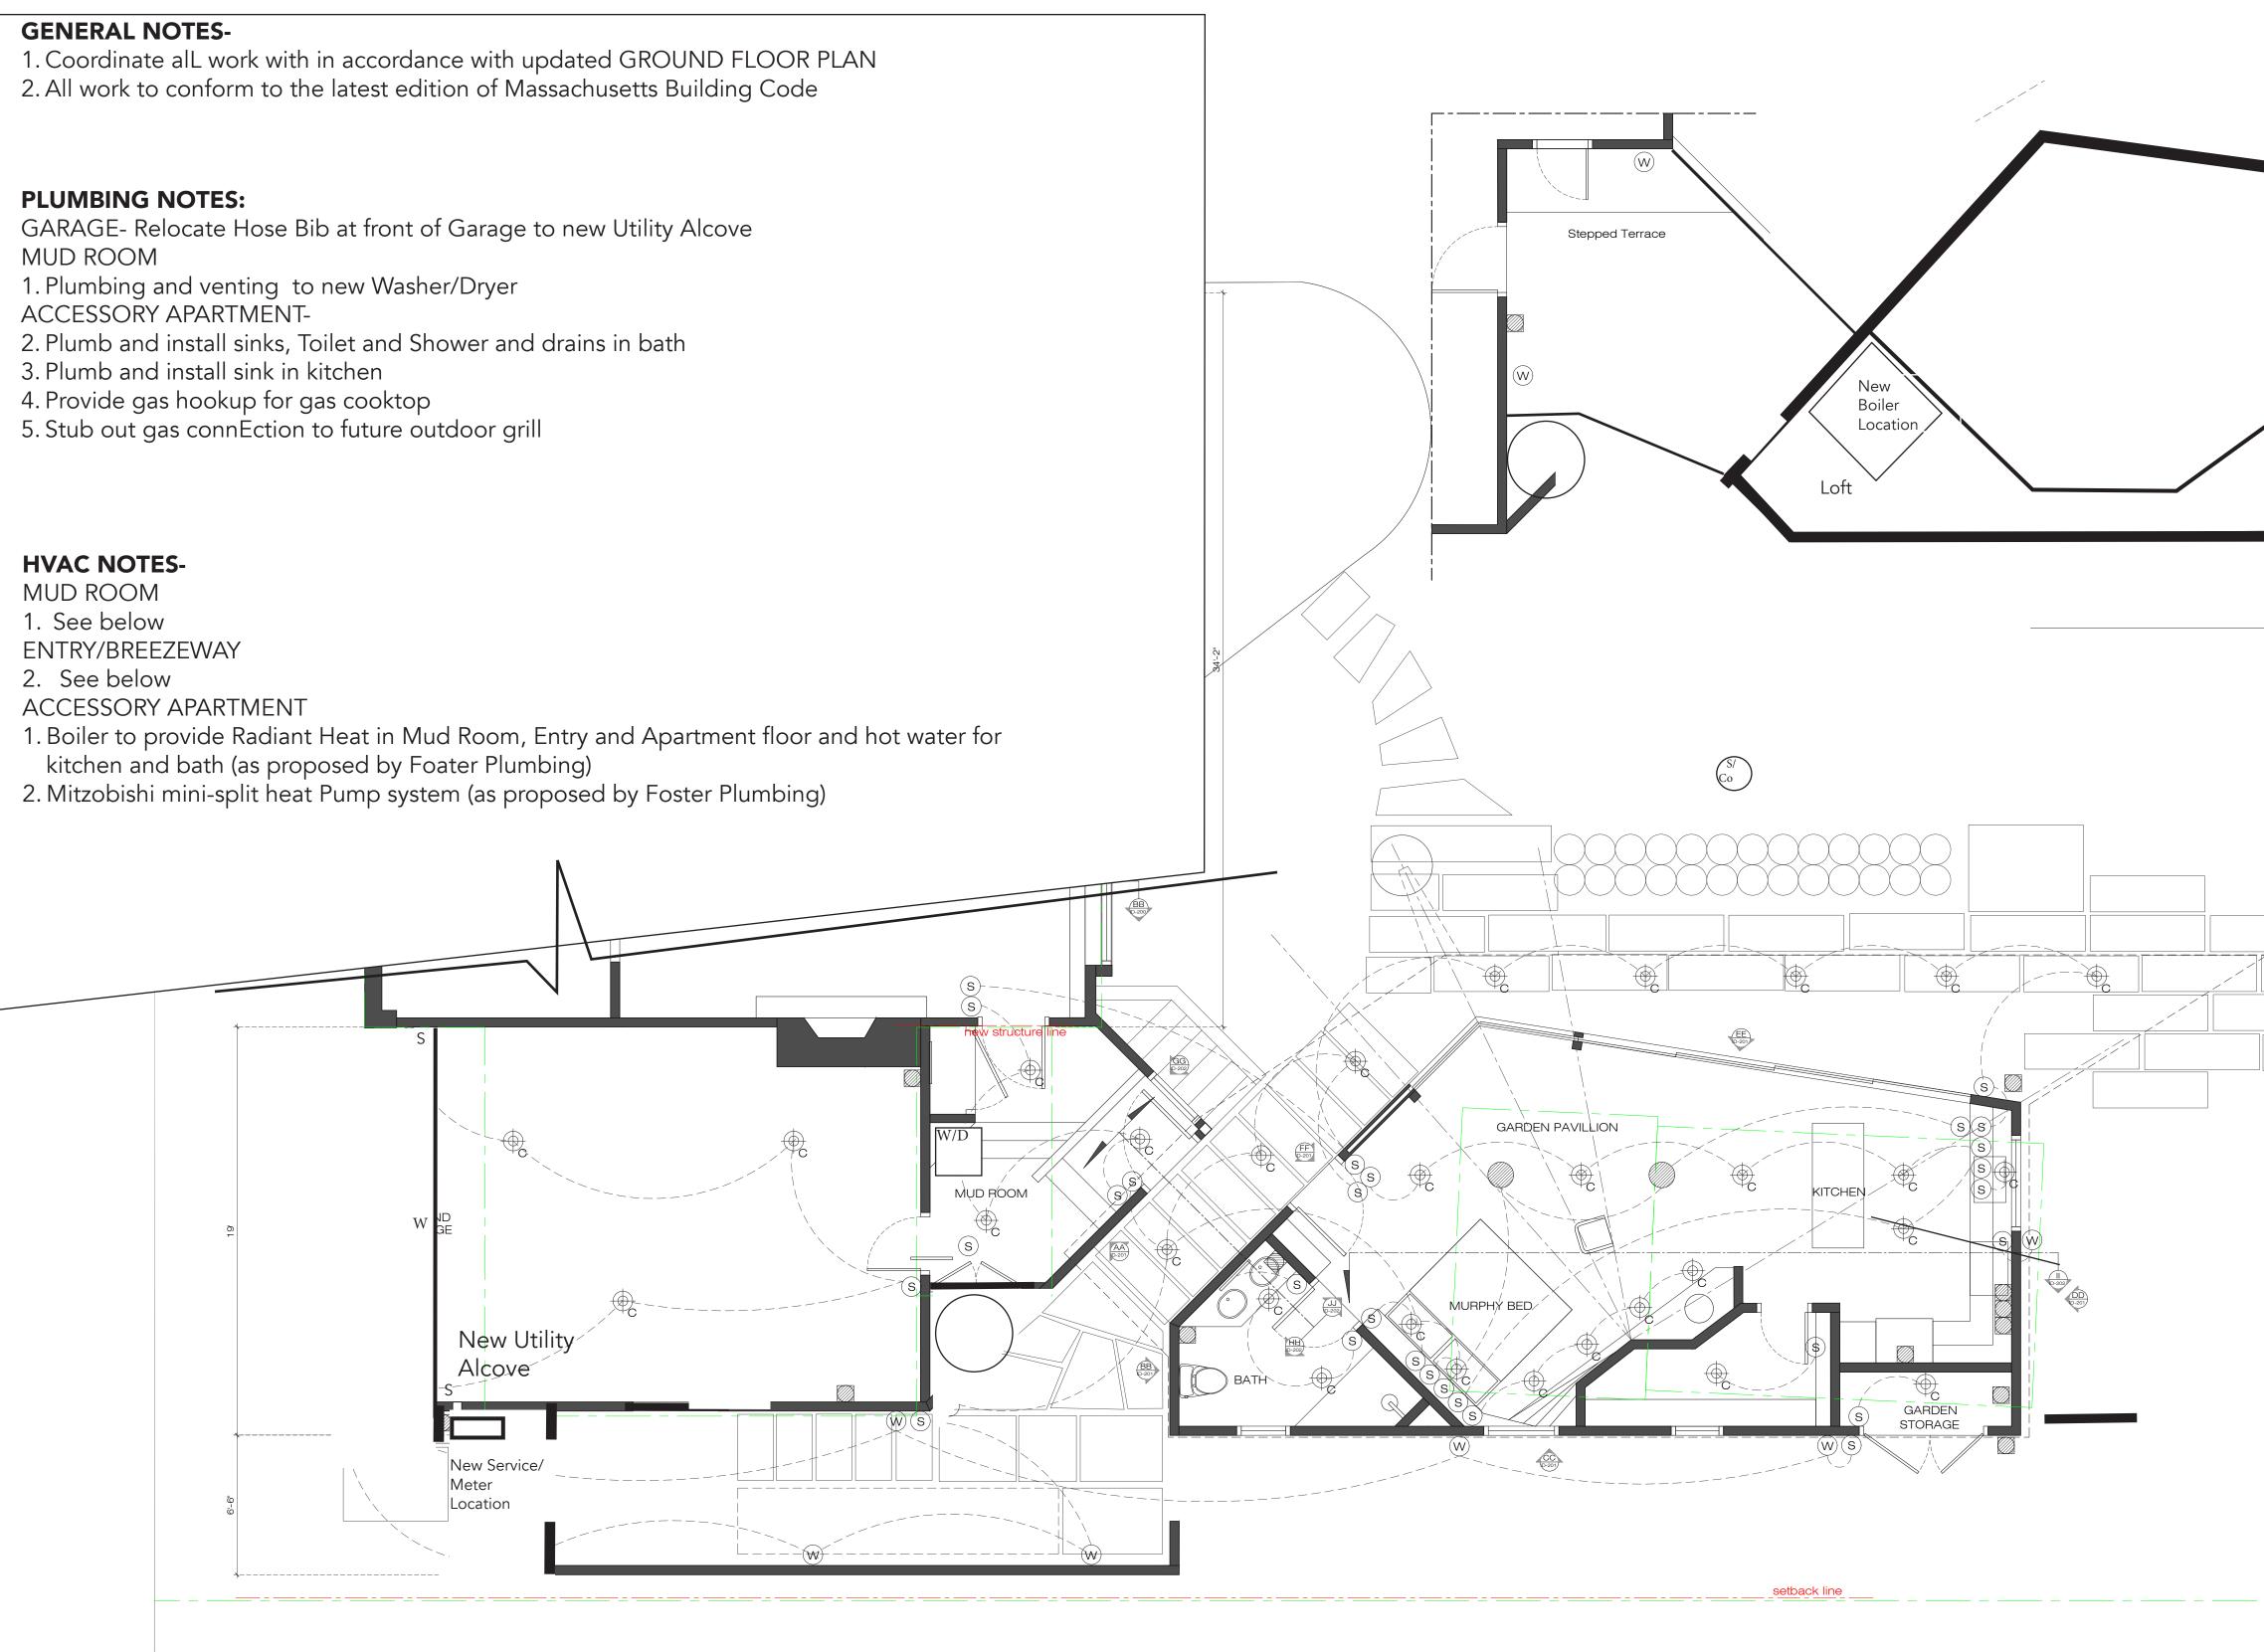




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MUD ROOM



ELECTRICAL NOTE :

1. Receptacles located per code, as specified with additional receptacles as shown [4 gang with 2 outlets switched] 2. Work includes

a. New meter to house [Price both overhead and underground] b. Electrical to new appliance

c. 120v line with 4 gang all-weather receptacle to fire and Tipi circles d. Connection coordination with solar system and hot tub installer



8'

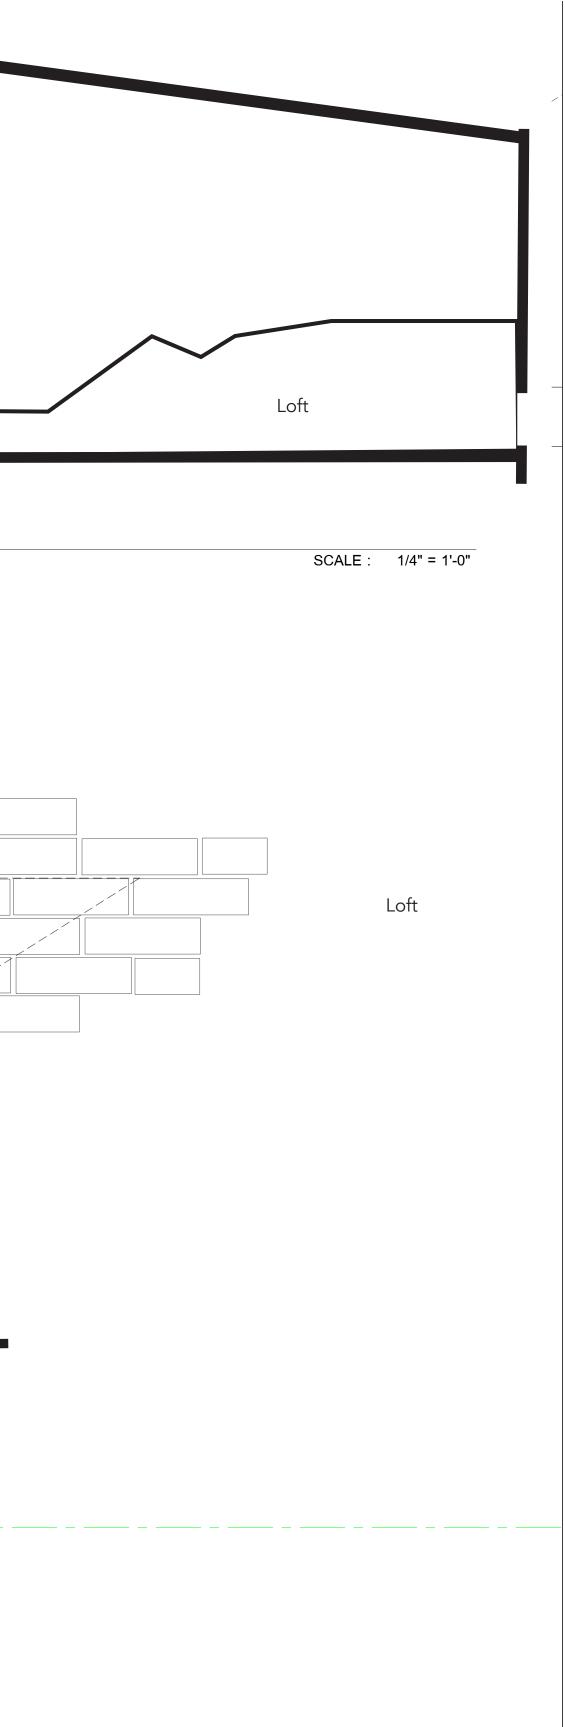
0 1' 2' 4'

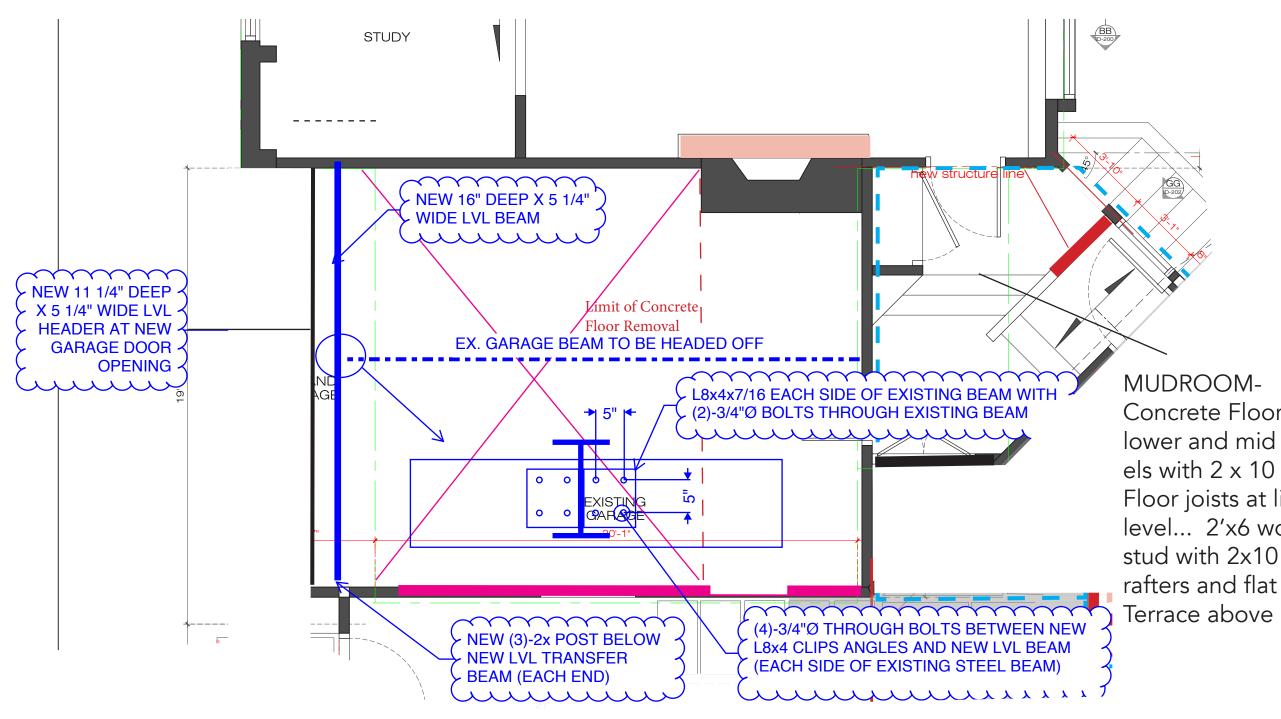
- Ceiling Recessed

Phase 2- Additions

39 Norwood Avenue Newton Center. MA

ARCHITECT	
INTERIOR DESIGNER	
LANDSCAPE ARCHITECT	
STRUCTURE ENGINEER	
SYSTEMS ENGINEER	
GENERAL NOTE	1
REVISION No. DATE	NOTE
OWNER	
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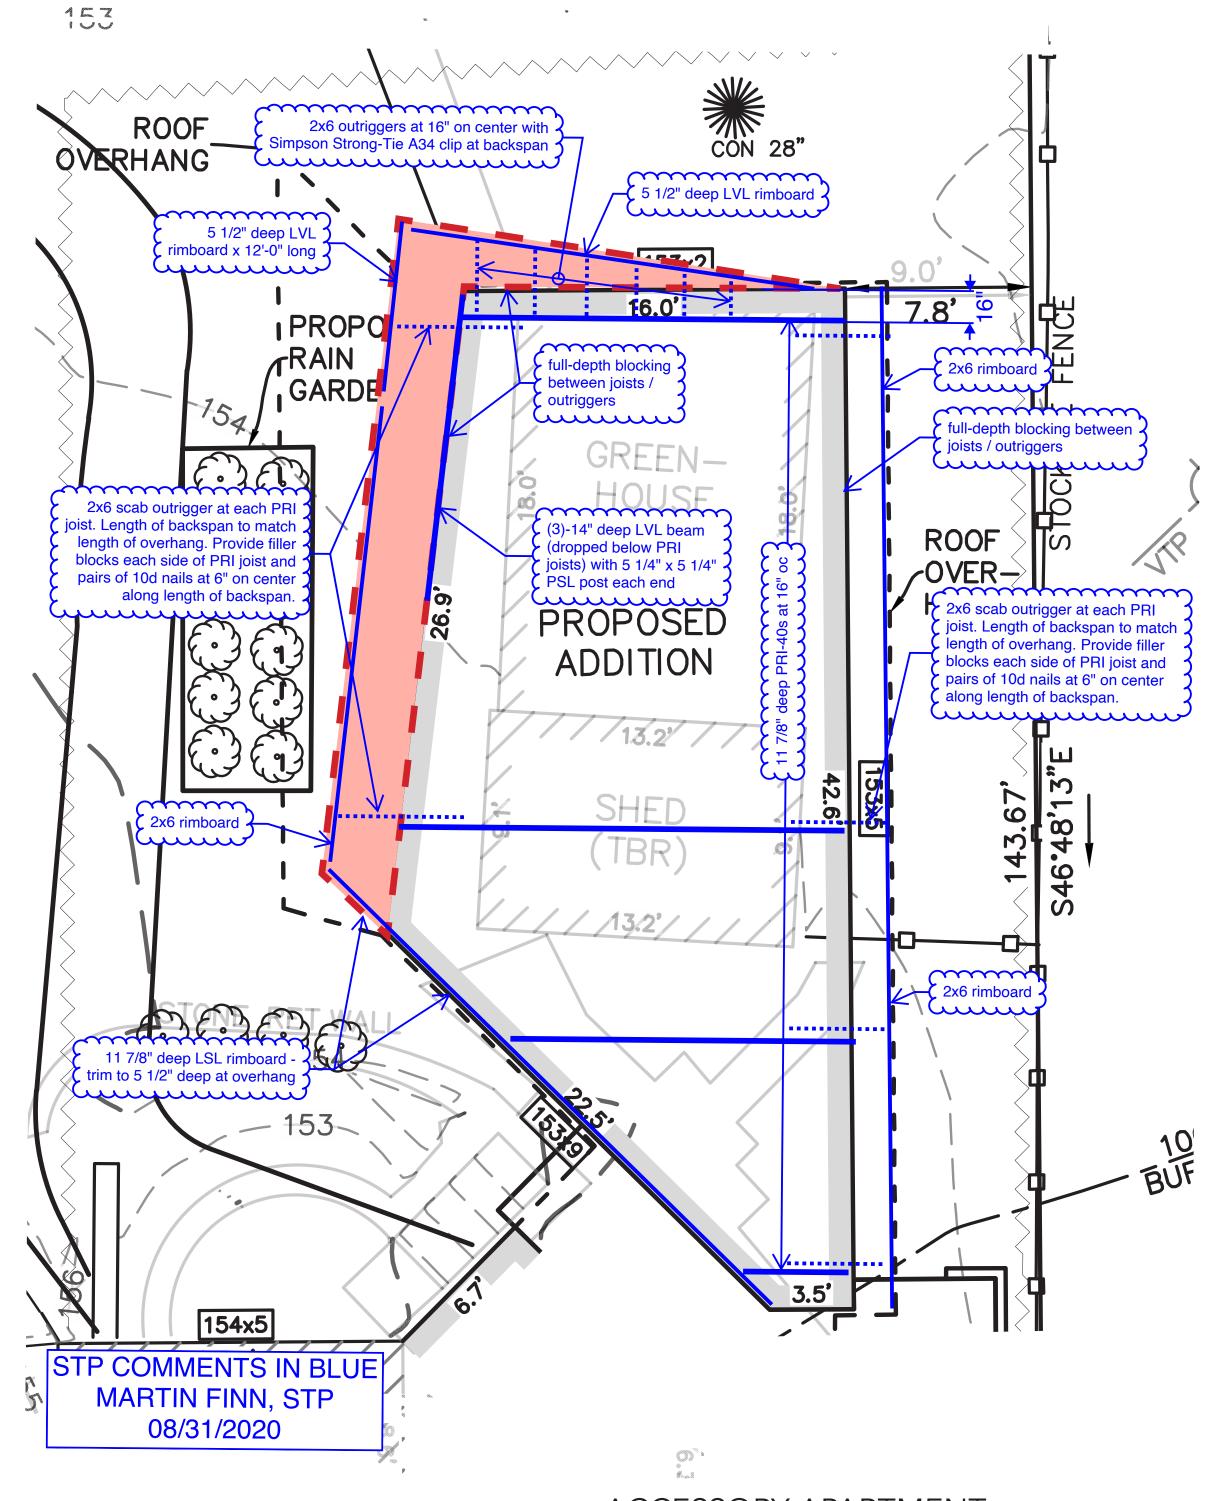




GARAGE EXTENSION AND MUD ROOM ADDITION

MUDROOM-Concrete Floor onlower and mid levels with 2 x 10 wood Floor joists at living level... 2'x6 wood stud with 2x10 wood rafters and flat Roof/

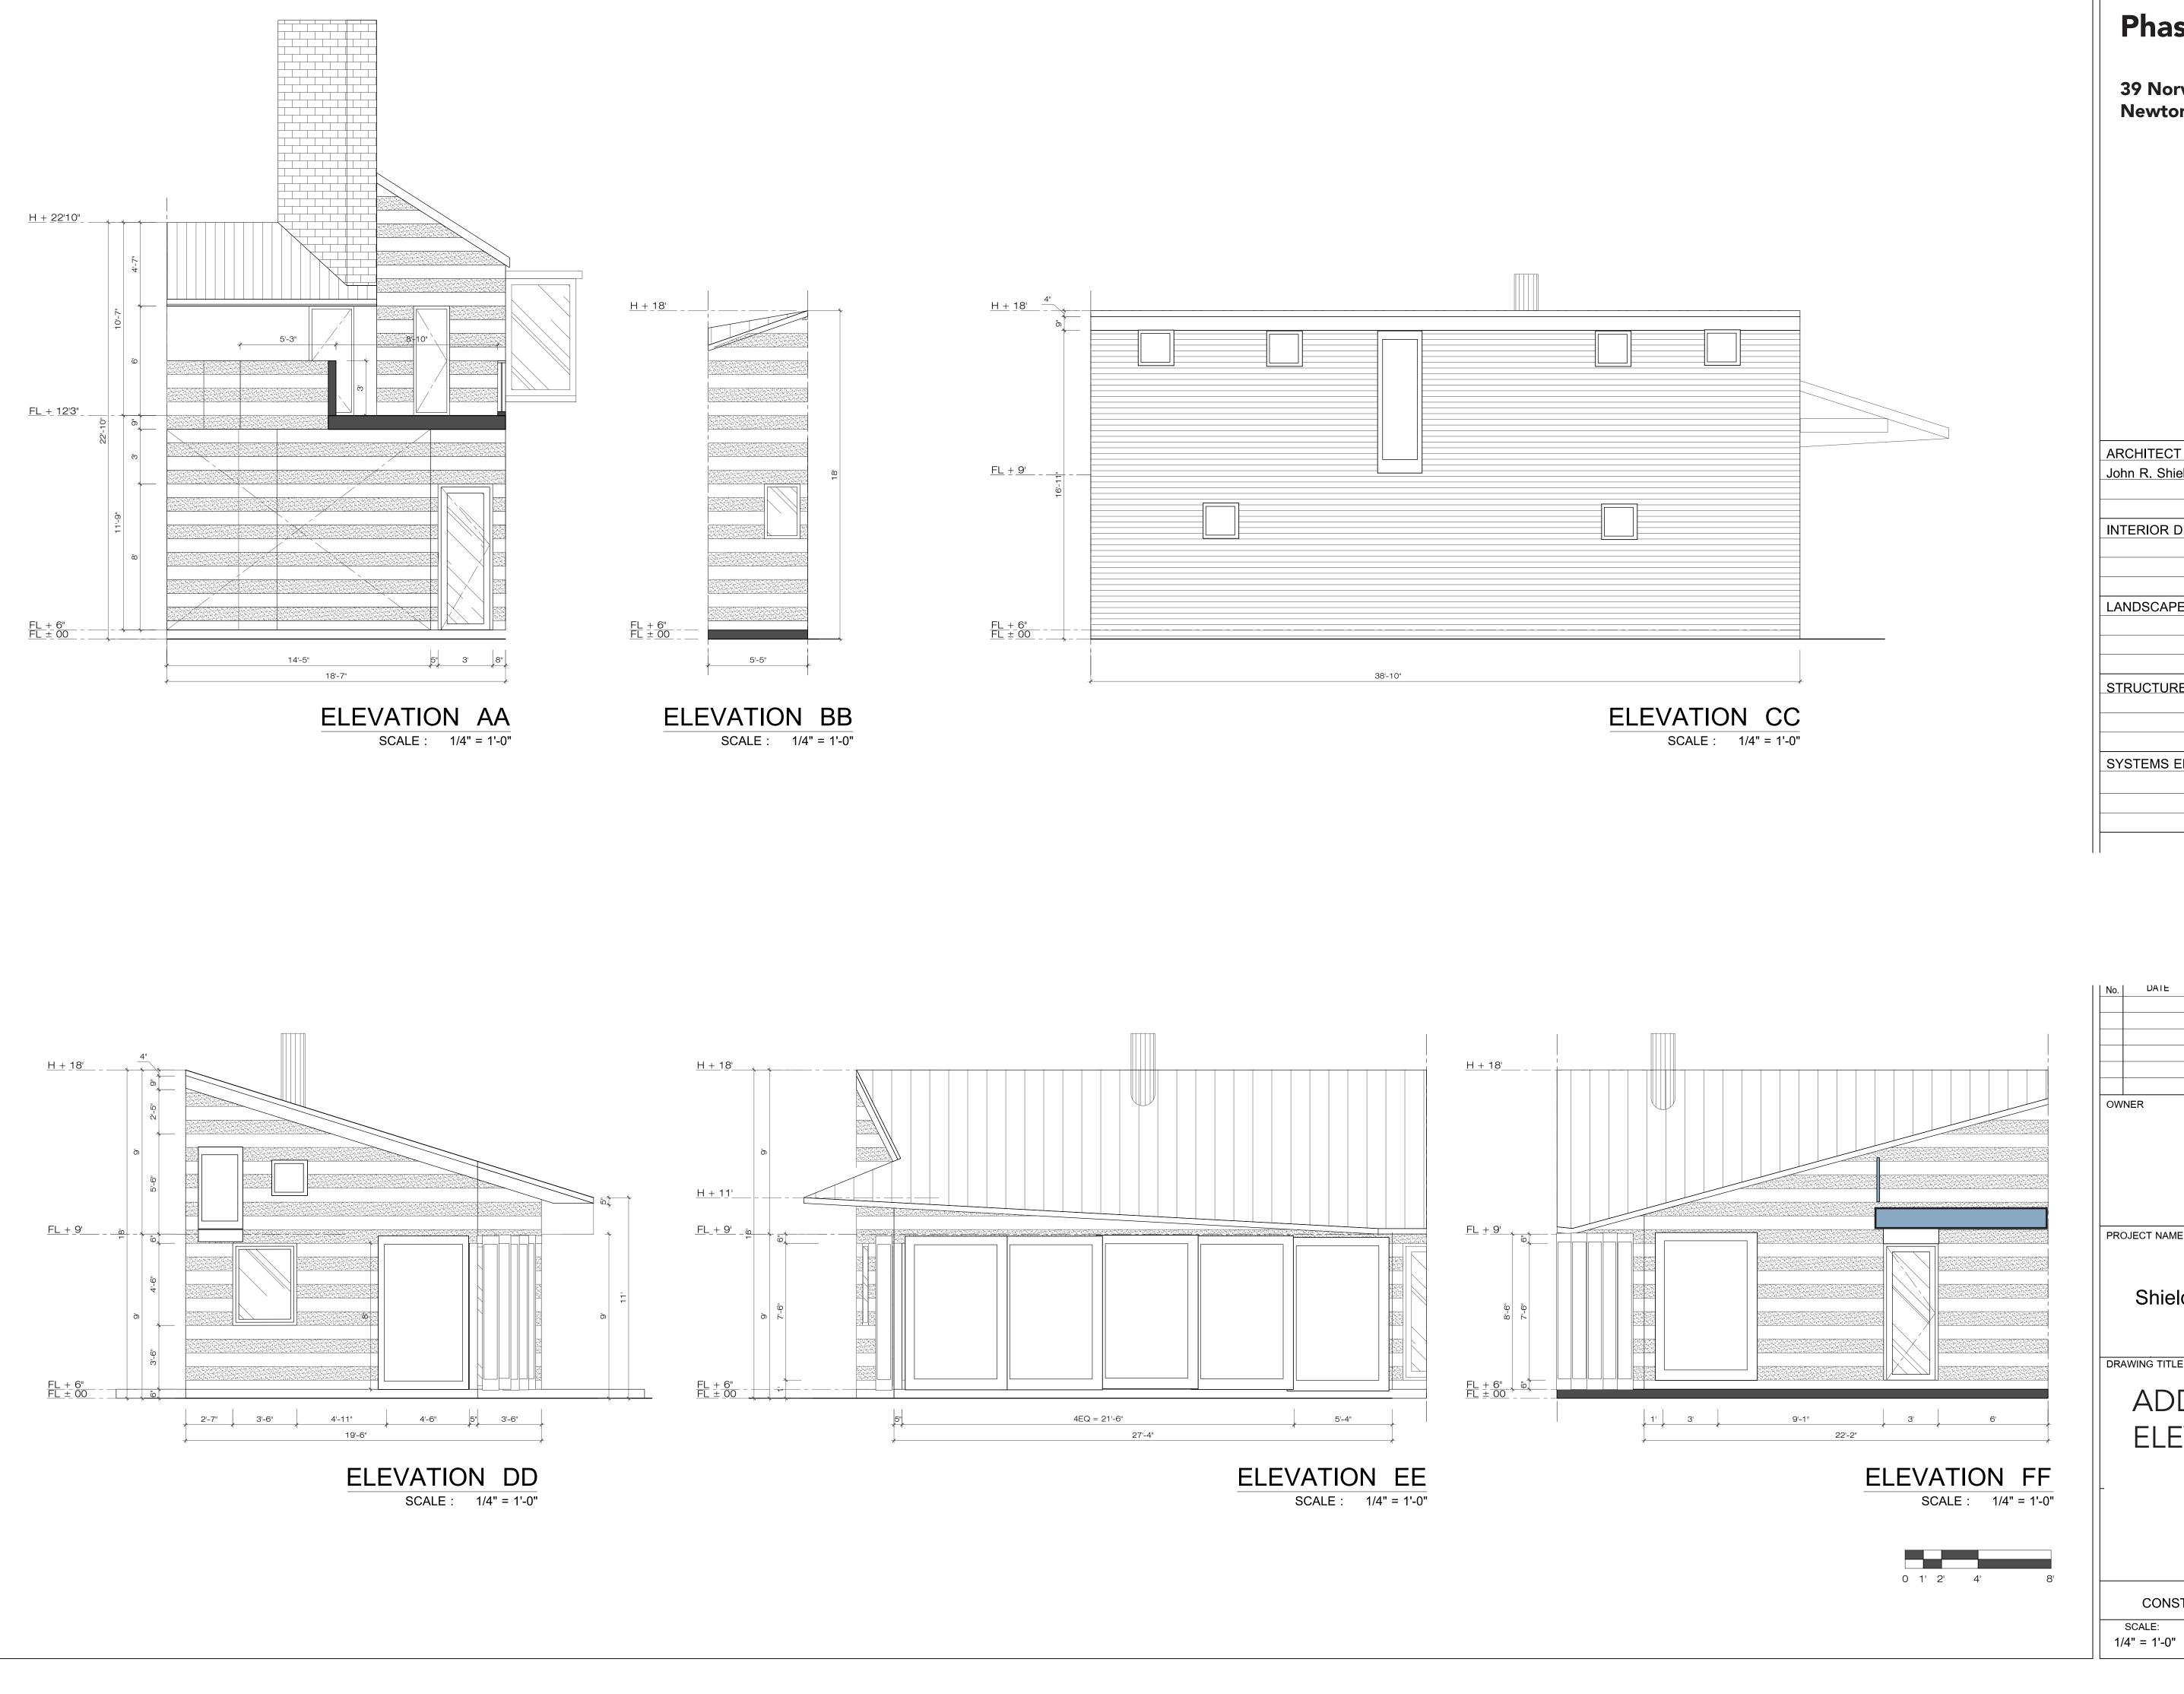
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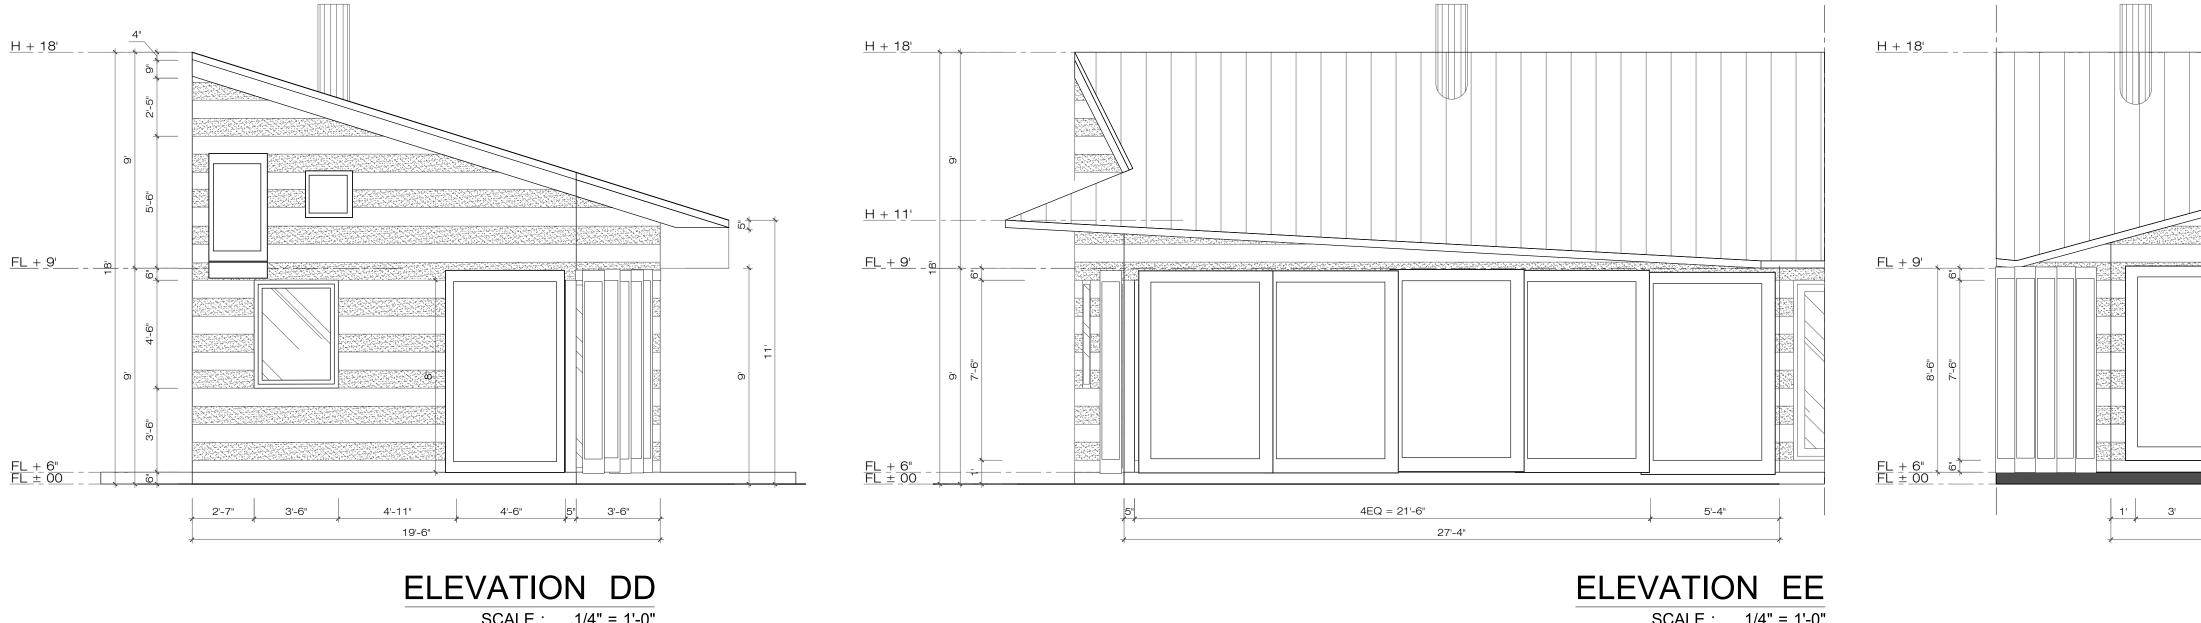


ACCESSORY APARTMENT ADDITION

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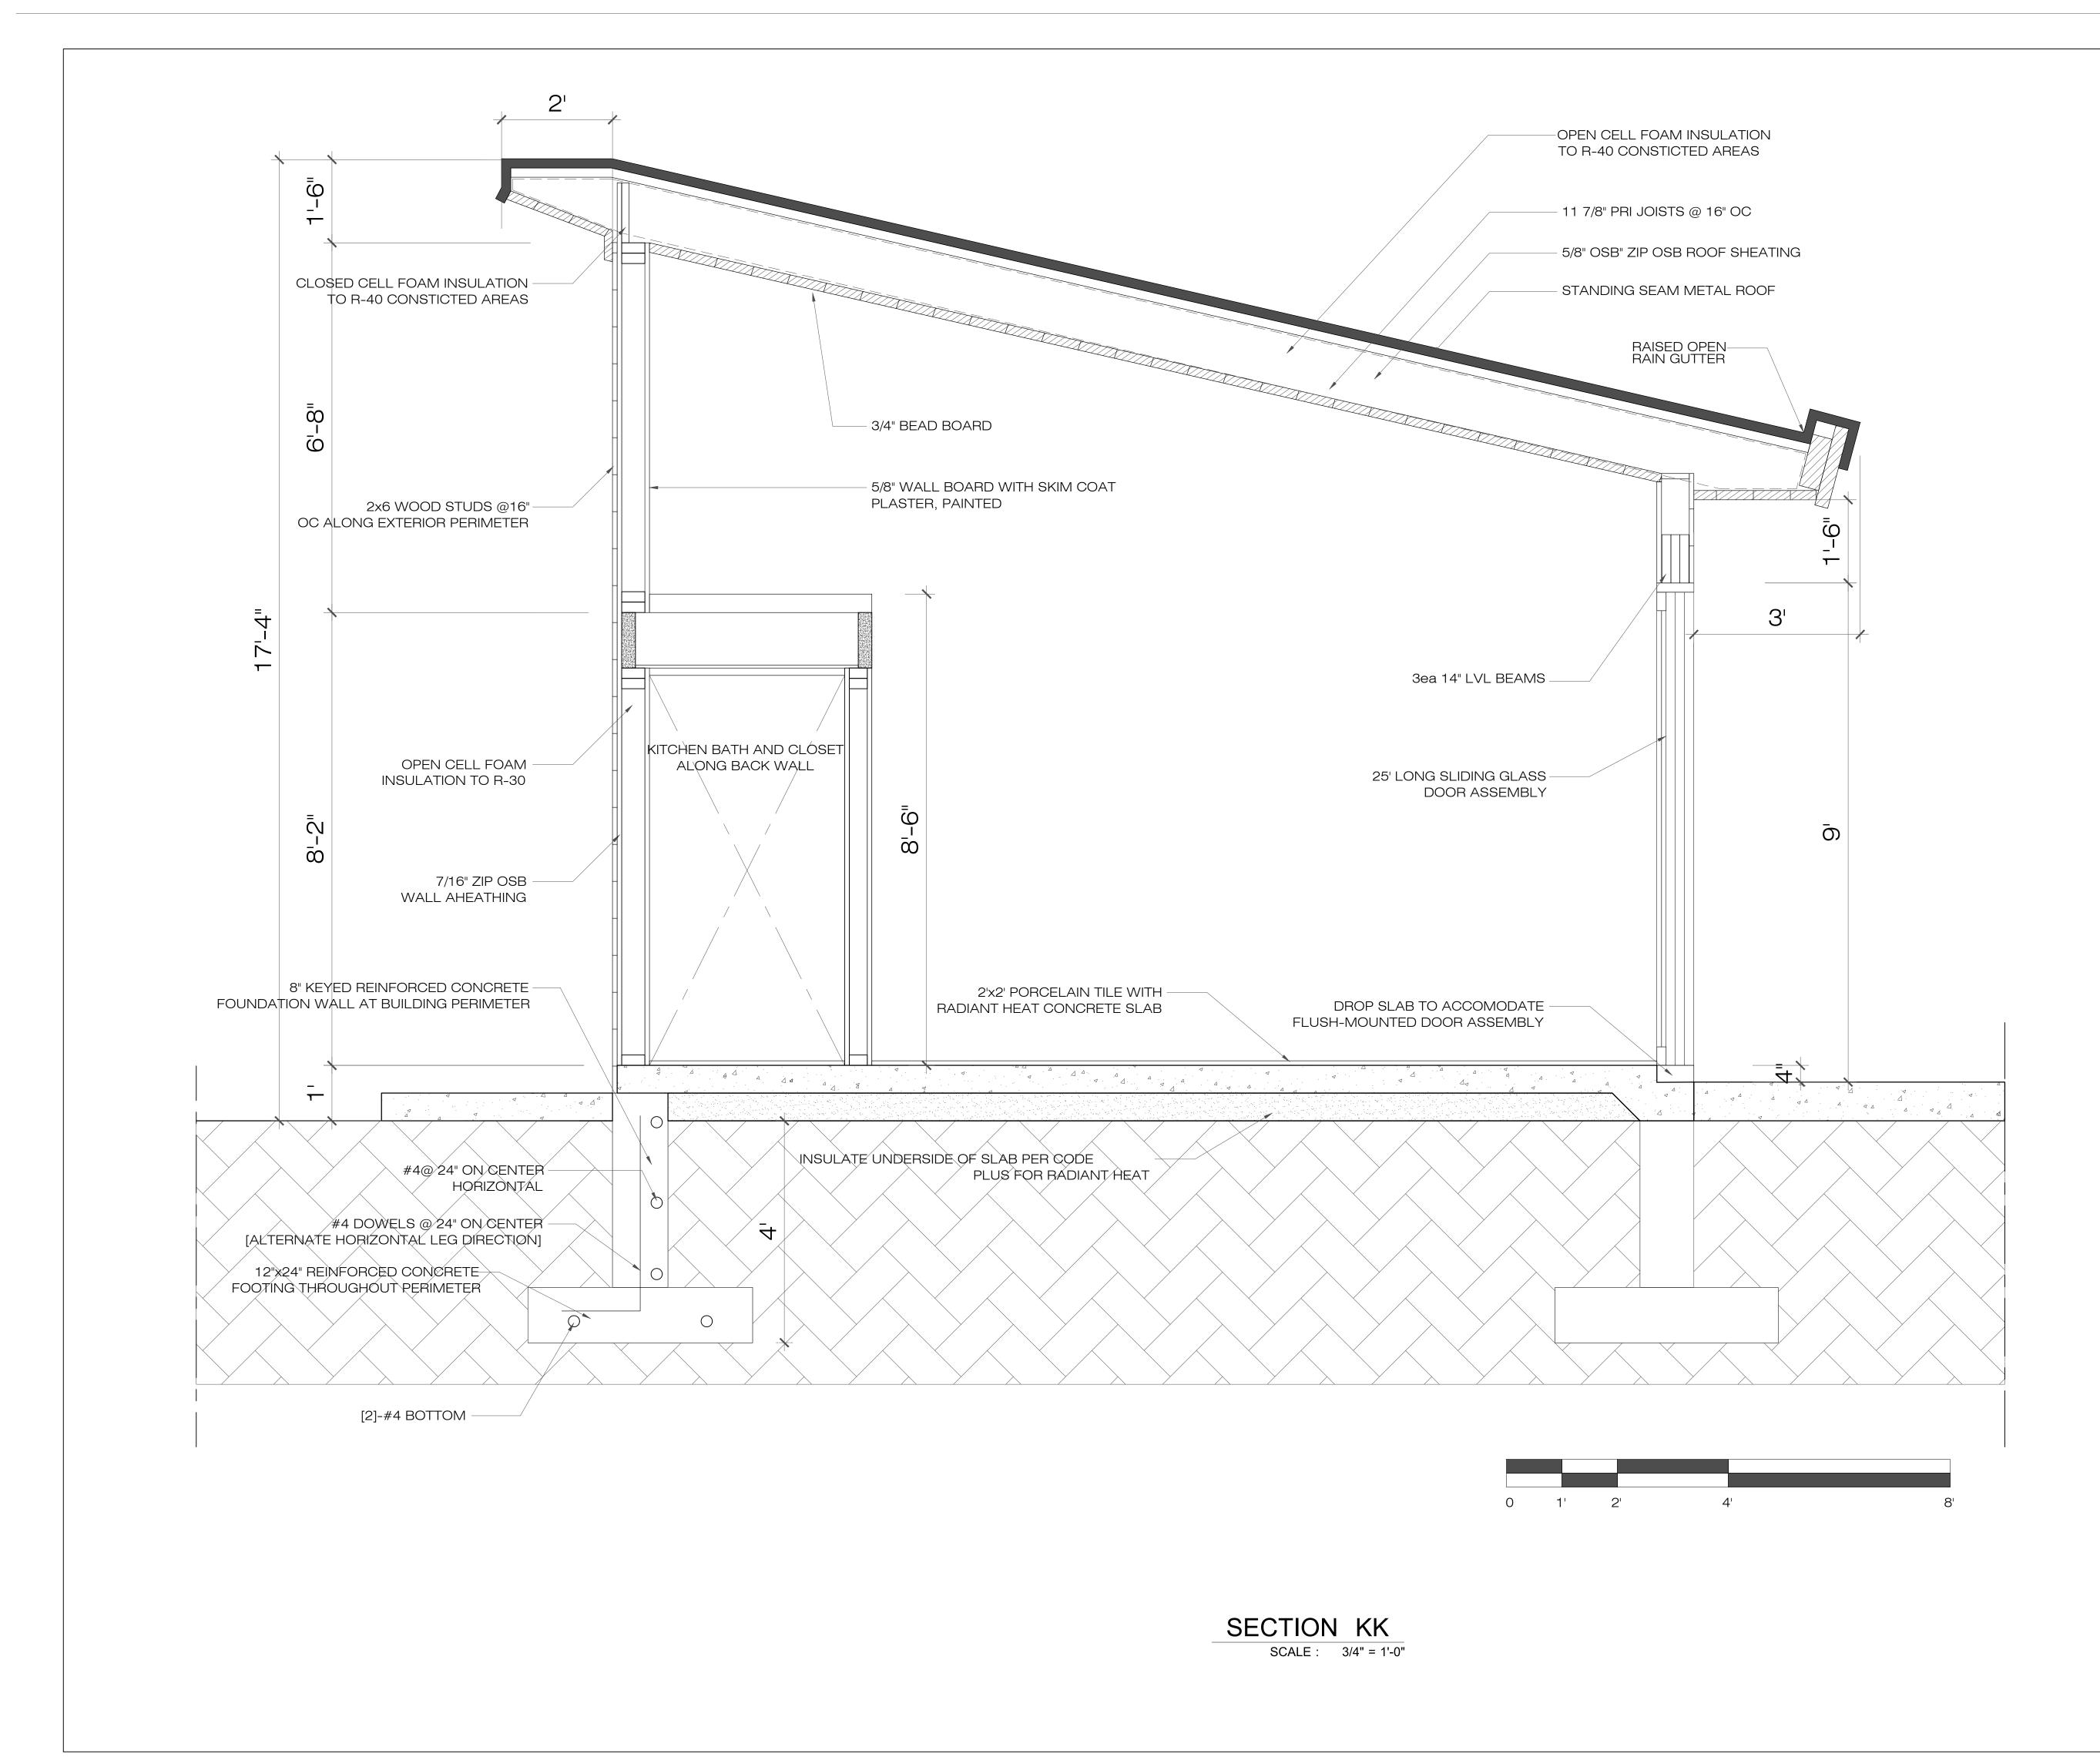




ADDRESS							
Phase 2- Addit	ions						
39 Norwood Avenue Newton Center. MA							
ARCHITECT							
John R. Shields. FAIA							
INTERIOR DESIGNER							
LANDSCAPE ARCHITECT							
STRUCTURE ENGINEER							
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