

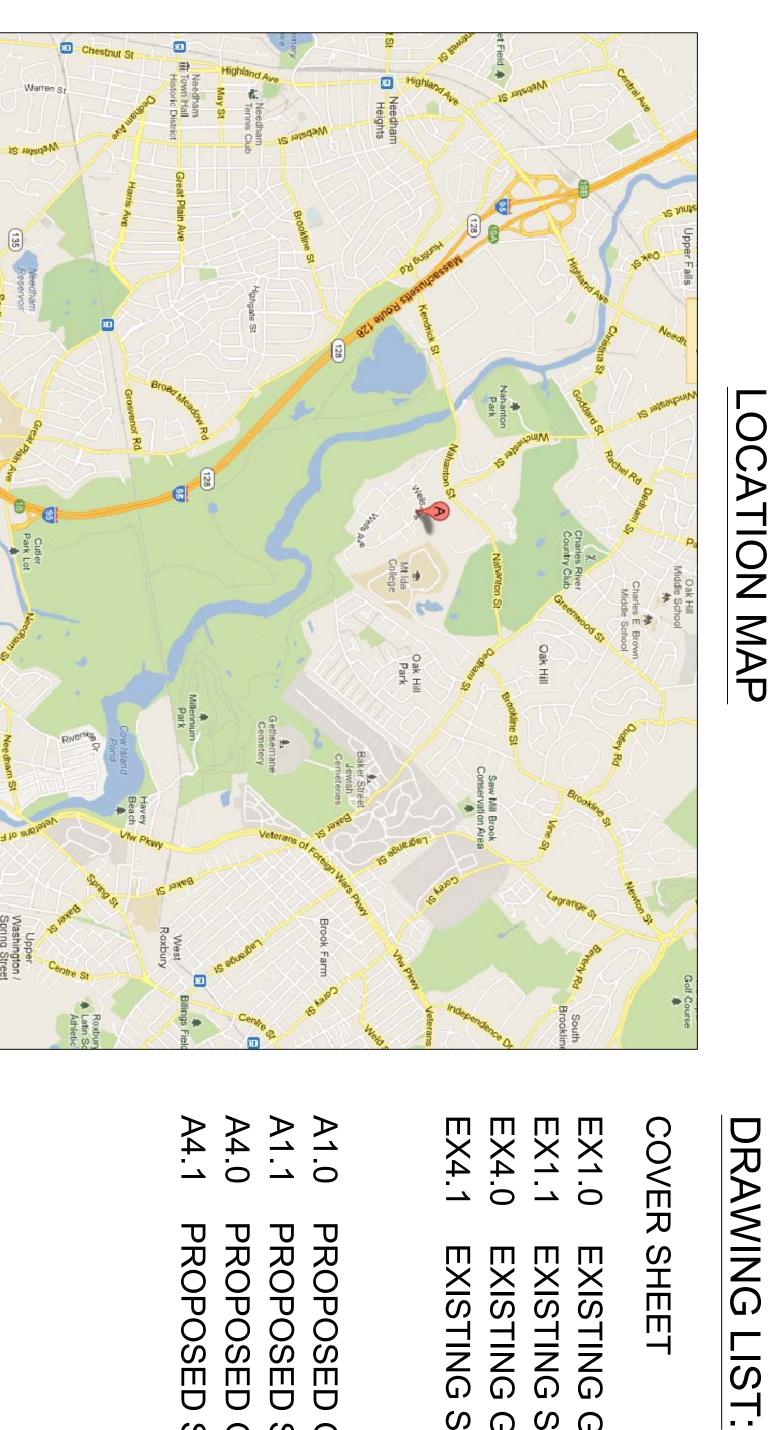
Avenue, Newton, 02459

OWNER

Newton, MA 02459 Russian School of Mathematics 200 Wells Ave

ARCHITECT

1643 Beacon Street Suite 22 Donald Lang Architects, Inc. Waban, MA 02468 Fax: (617) 332-5461 E-Mail: donald@dlaboston.com Phone: (617) 969-8400



OCATION MAP


COVER SHEET

EXISTING GROUND FLOOR PLAN EXISTING SECOND FLOOR PLAN

EX1.0 EX1.1 EX4.0 EXISTING SECOND FLOOR REFLECTED CEILING PLAN EXISTING GROUND FLOOR REFLECTED CEILING PLAN

PROPOSED GROUND FLOOR PLAN PROPOSED SECOND FLOOR PLAN

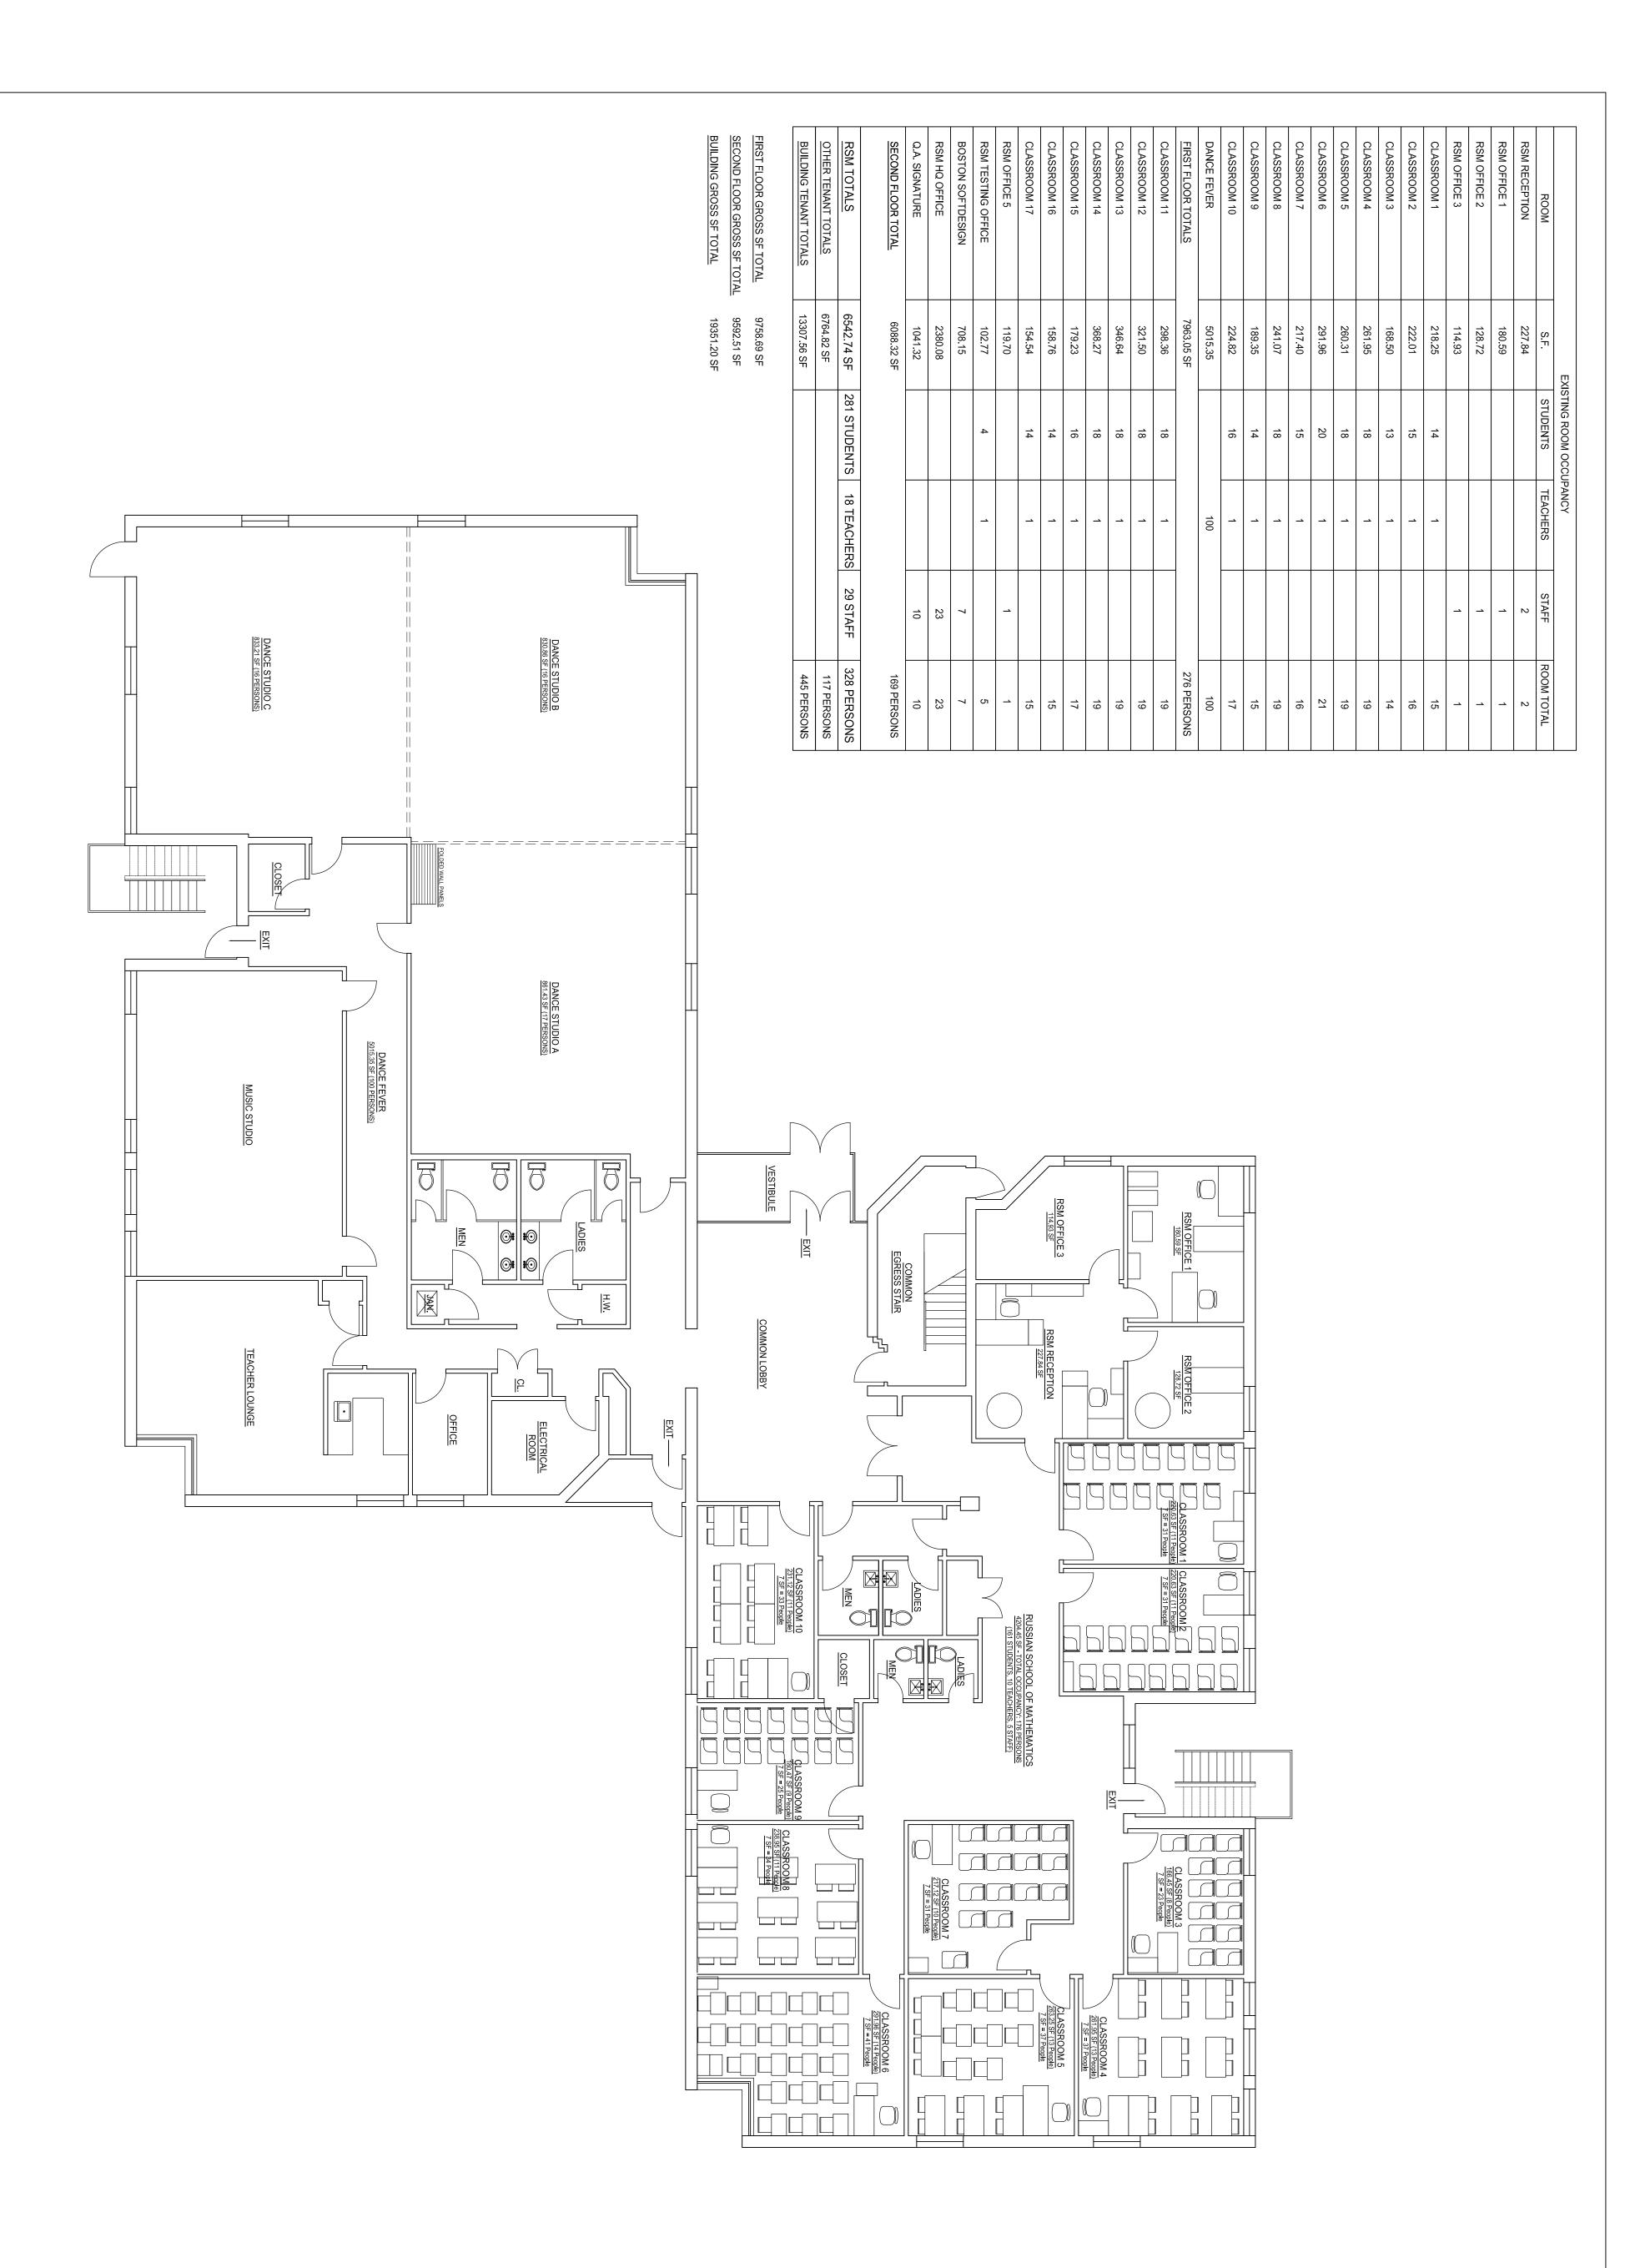PROPOSED PROPOSED GROUND FLOOR REFLECTED CEILING PLAN SECOND FLOOR REFLECTED CEILING PLAN



200 Wells Avenue Newton, MA 02459 **Mathematics** Russian School of

ARCHITECTURE

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Revision D
Date
03-18-13

Project No. W200/DWGs/Existing Plan

Drawn By Checked By

Date Issued

EXISTING GROUND FLOOR PLAN

EXISTING GROUND FLOOR PLAN (10845.19 S.F.) SCALE: 1/8"=1'-0"

EX1.0

EXIT BOSTON SOFTDESIGN 708.15 SF (7 PERSONS)

EXISTING SECOND FLOOR PLAN (10565.44 S.F.)

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EXISTING SECOND FLOOR PLAN

W200/DWGs/Existing Plan

EX1.1

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REMAINING WORK NOTES (COMPLETE BY MARCH 29, 2013) SECOND FLOOR LEFT SIDE

RSM HQ AND ACCOUNTING (USE GROUP "B"- BUSINESS)

16. PROVIDE (2) E.L.S

17. PROVIDE COMBO (E.L. AND EXIT) UNIT AT DOOR TO ACCOUNTING

18. PROVIDE HORN/STROBE AND E.L. WITHIN BREAK ROOM AREA. MEN'S TOILET ROOM
22. SUPPLY AND INSTALL COMPLIANT SIGN HALLWAY - ACCESSING CLASSROOM 16, 17 AND 18
21. REMOVE ABANDONED WOOD DOOR FRAME AND JAMB SECOND FLOOR LOBBY

15. PROVIDE E.L. AT UPPER LEVEL TEACHER'S LOUNGE

14. PROVIDE LIGHTED EXIT SIGN DANCE FEVER DANCE STUDIO "A"

13. PROVIDE SECOND LIGHTED EXIT SIGN MULTI-USER TOILET ROOMS LOBBY HALLWAY

11. PROVIDE COMBO (E.L. AND EXIT) UNIT

12. PROVIDE COMPLIANT ROOM SIGNS TO THE SIDE OF EACH DOOR GROUND FLOOR RIGHT HALLWAY

9. PROVIDE PANIC HARDWARE ON SINGLE EXIT DOOR NEAR CLOSET. ADJUST CLOSER PRESSURE

10. PROVIDE E.L. IN SAME SPACE (2) EXISTING SINGLE USER HC ACCESSIBLE TOILET ROOMS 6. COMPLIANT ROOM SIGNS WITH BRAILLE ARE MISSING GROUND FLOOR LOBBY- MAIN STAIRWELL

2. PROVIDE REQUIRED EMERGENCY LIGHTING WITH BATTERY BACKUP (E.L.)

3. PROVIDE COMPLIANT WALL SIDE STAIRWAY HAND RAILS MAIN ENTRANCE VESTIBULE

1. OUTSIDE DOORS STICK AND NEED OPENING PRESSURE ADJUSTED TO 15 LBS. SCHOOL OFFICE- RECEPTION AREA
7. PROVIDE COMBINATION E.L./ LIGHTED EXIT UNIT (COMBO) ABOVE HALLWAY
8. CHECK HORN/ STROBE DEVICE FUNCTIONALITY IN SAME SPACE GROUND FLOOR LEFT HALLWAY

(2) EXISTING SINGLE USER, NON HC ACCESSIBLE TOILET ROOMS

4. DIRECTIONAL SIGNAGE POINTING TO HC TOILETS IS MISSING

5. RELOCATE "TEACHER'S ONLY" TOILET ROOM SIGN TO NON HC OND FLOOR RIGHT SIDE

ESCAPE #1 - ADJACENT TO TESTING ROOM

ADJUST EXIT DOOR CLOSER PRESSURE TO SLOW

REPAIR PANIC BAR THAT IS MISSING PARTS FIRE ALARM EQUIPMENT LEGEND FIRE EXTINGUISHER LIGHTED EXIT SIGN PULL STATION

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EXISTING GROUND FLOOR REFLECTED

SCALE: 1/8" =1'-0" CEILING PLAN

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EX4.0

EXISTING GROUND FLOOR REFLECTED CEILING PLAN

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EXISTING SECOND FLOOR REFLECTED CEILING PLAN SCALE: 1/8" =1'-0"

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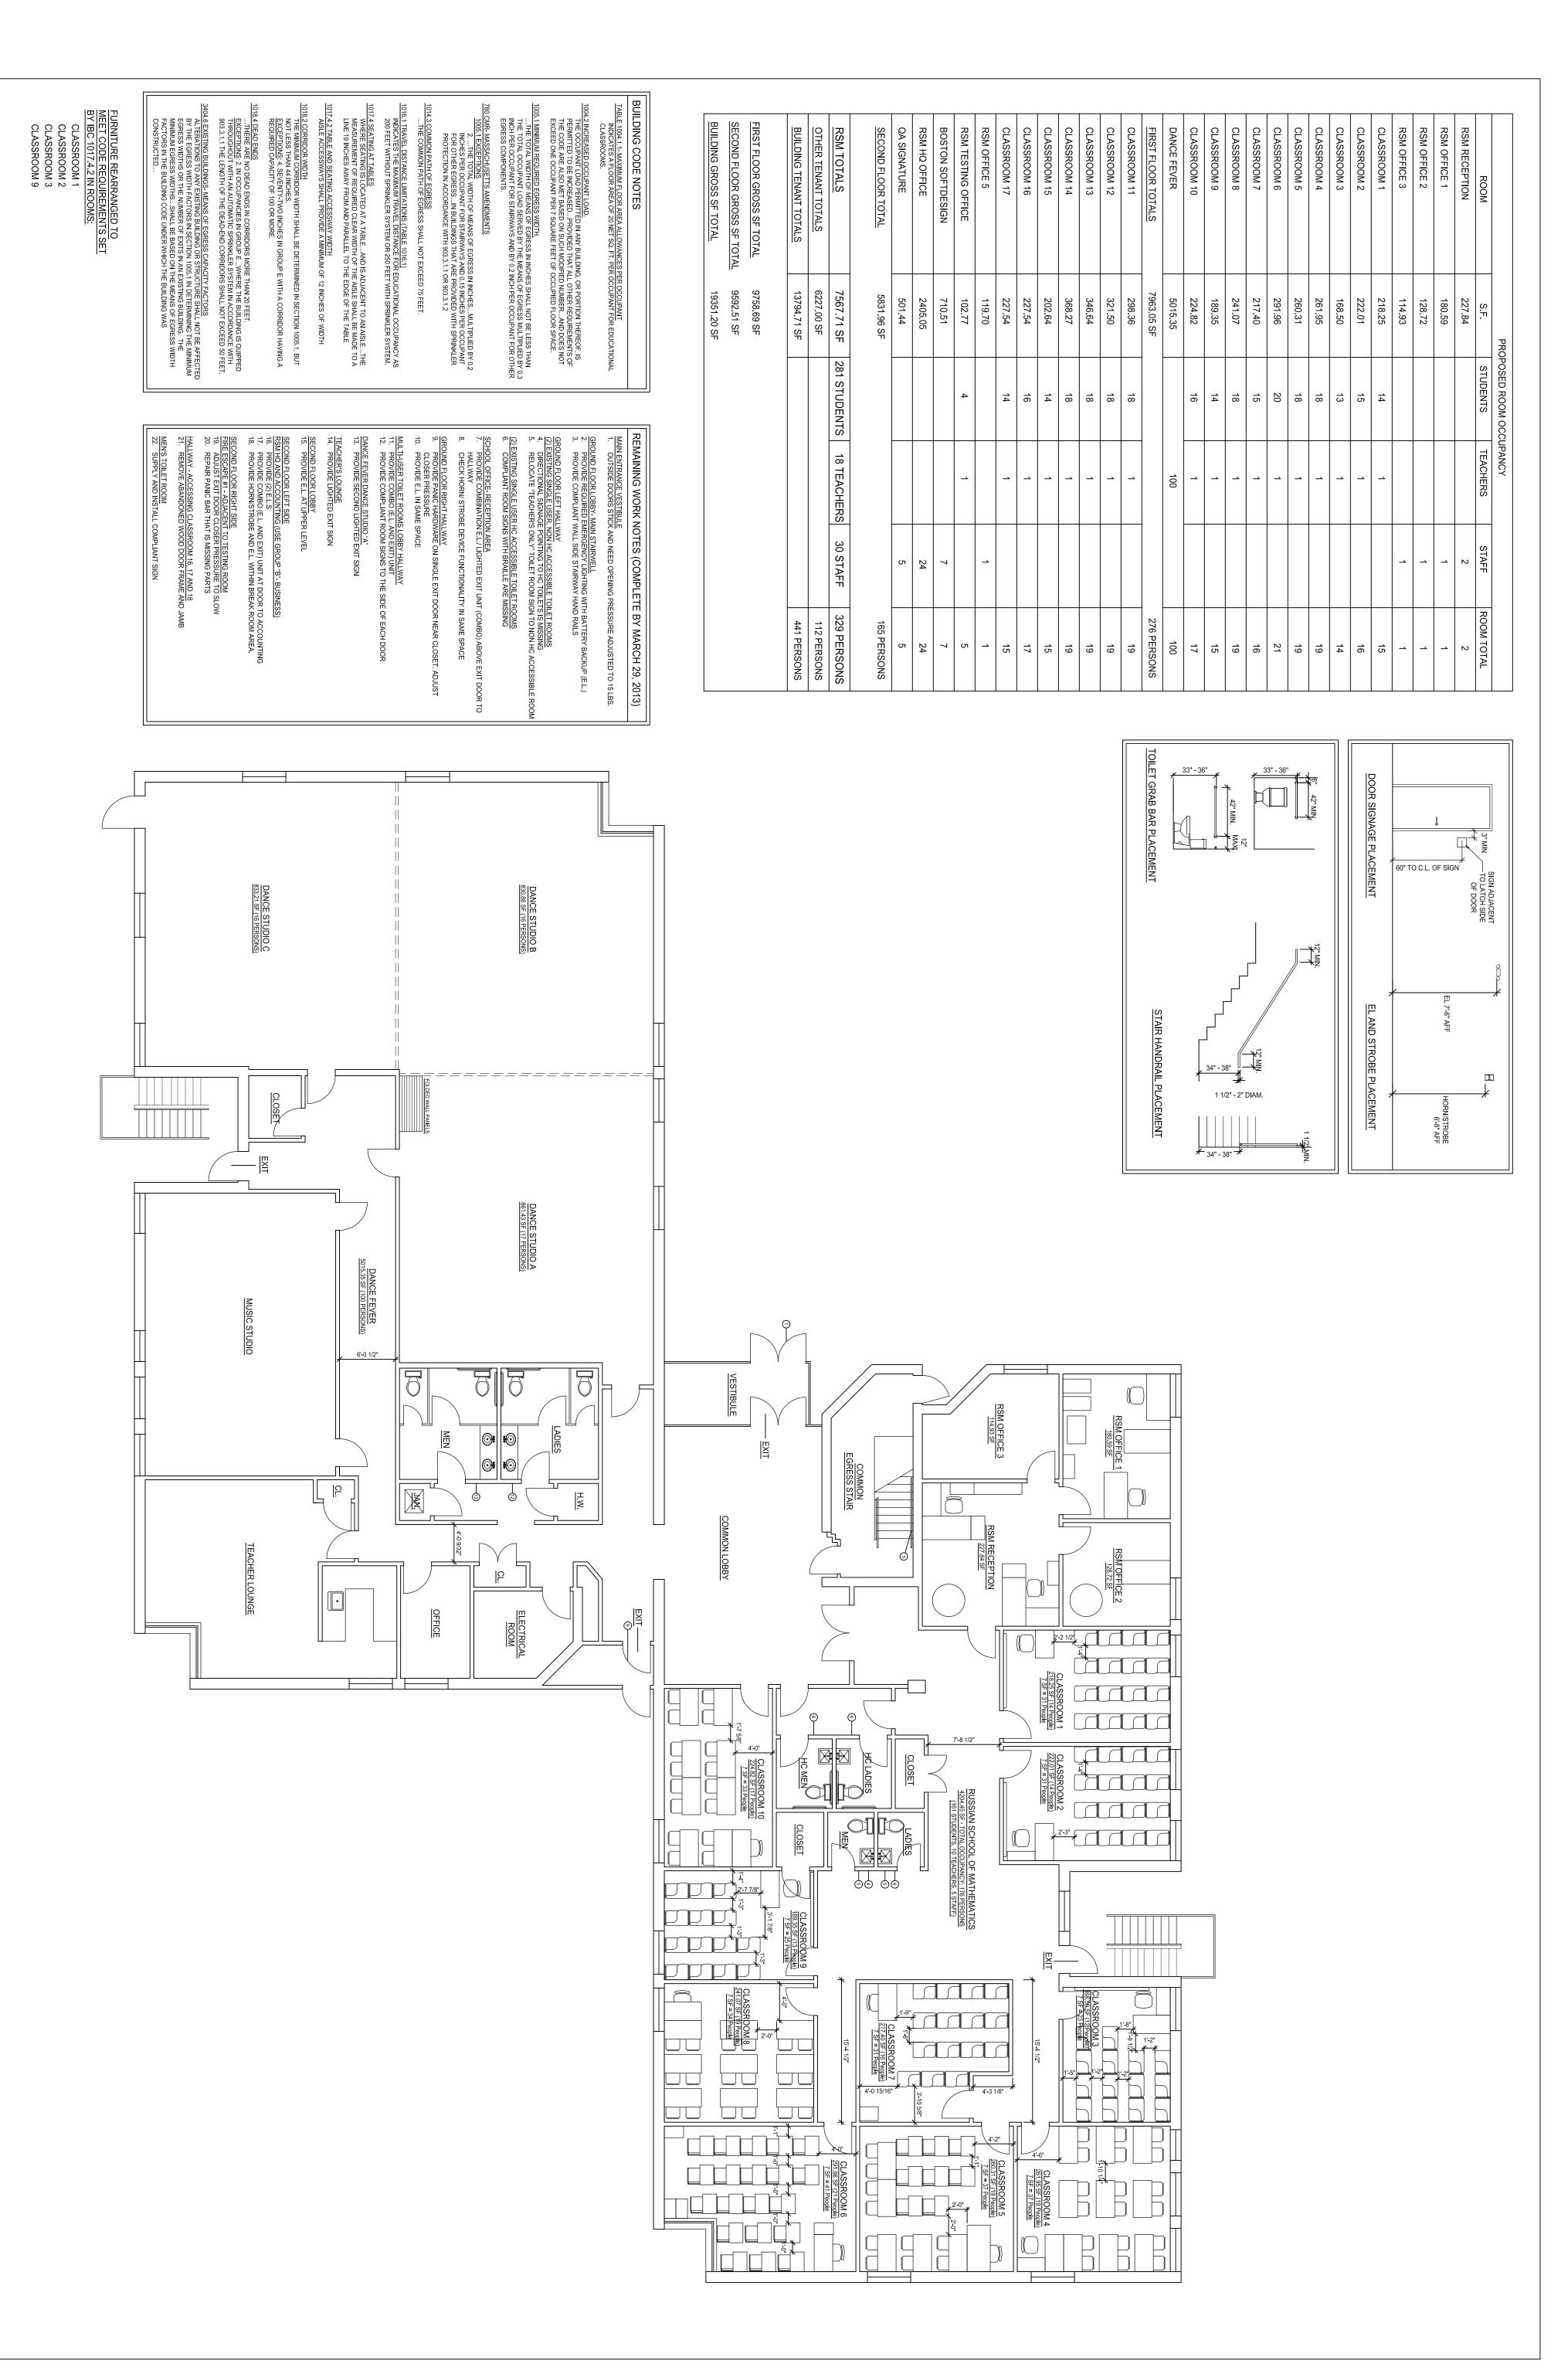
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EX4.1

EXISTING SECOND FLOOR REFLECTED CEILING PLAN



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PROPOSED GROUND FLOOR PLAN

A1.0

PROPOSED GROUND FLOOR PLAN (10845.19 S.F.)

DANCE STUDIO 1656.62 SF (33 PERSONS) RUSSIAN SCHOOL OF MATHEMATICS
3165.87 SF - TOTAL OCCUPANCY: 129 PERSONS
(120 STUDENTS, 8 TEACHERS, 1 STAFF) MECHANICAL ROOM RSM OPEN OFFICE 657.97 SF

PROPOSED SECOND FLOOR PLAN (10565.44 S.F.)

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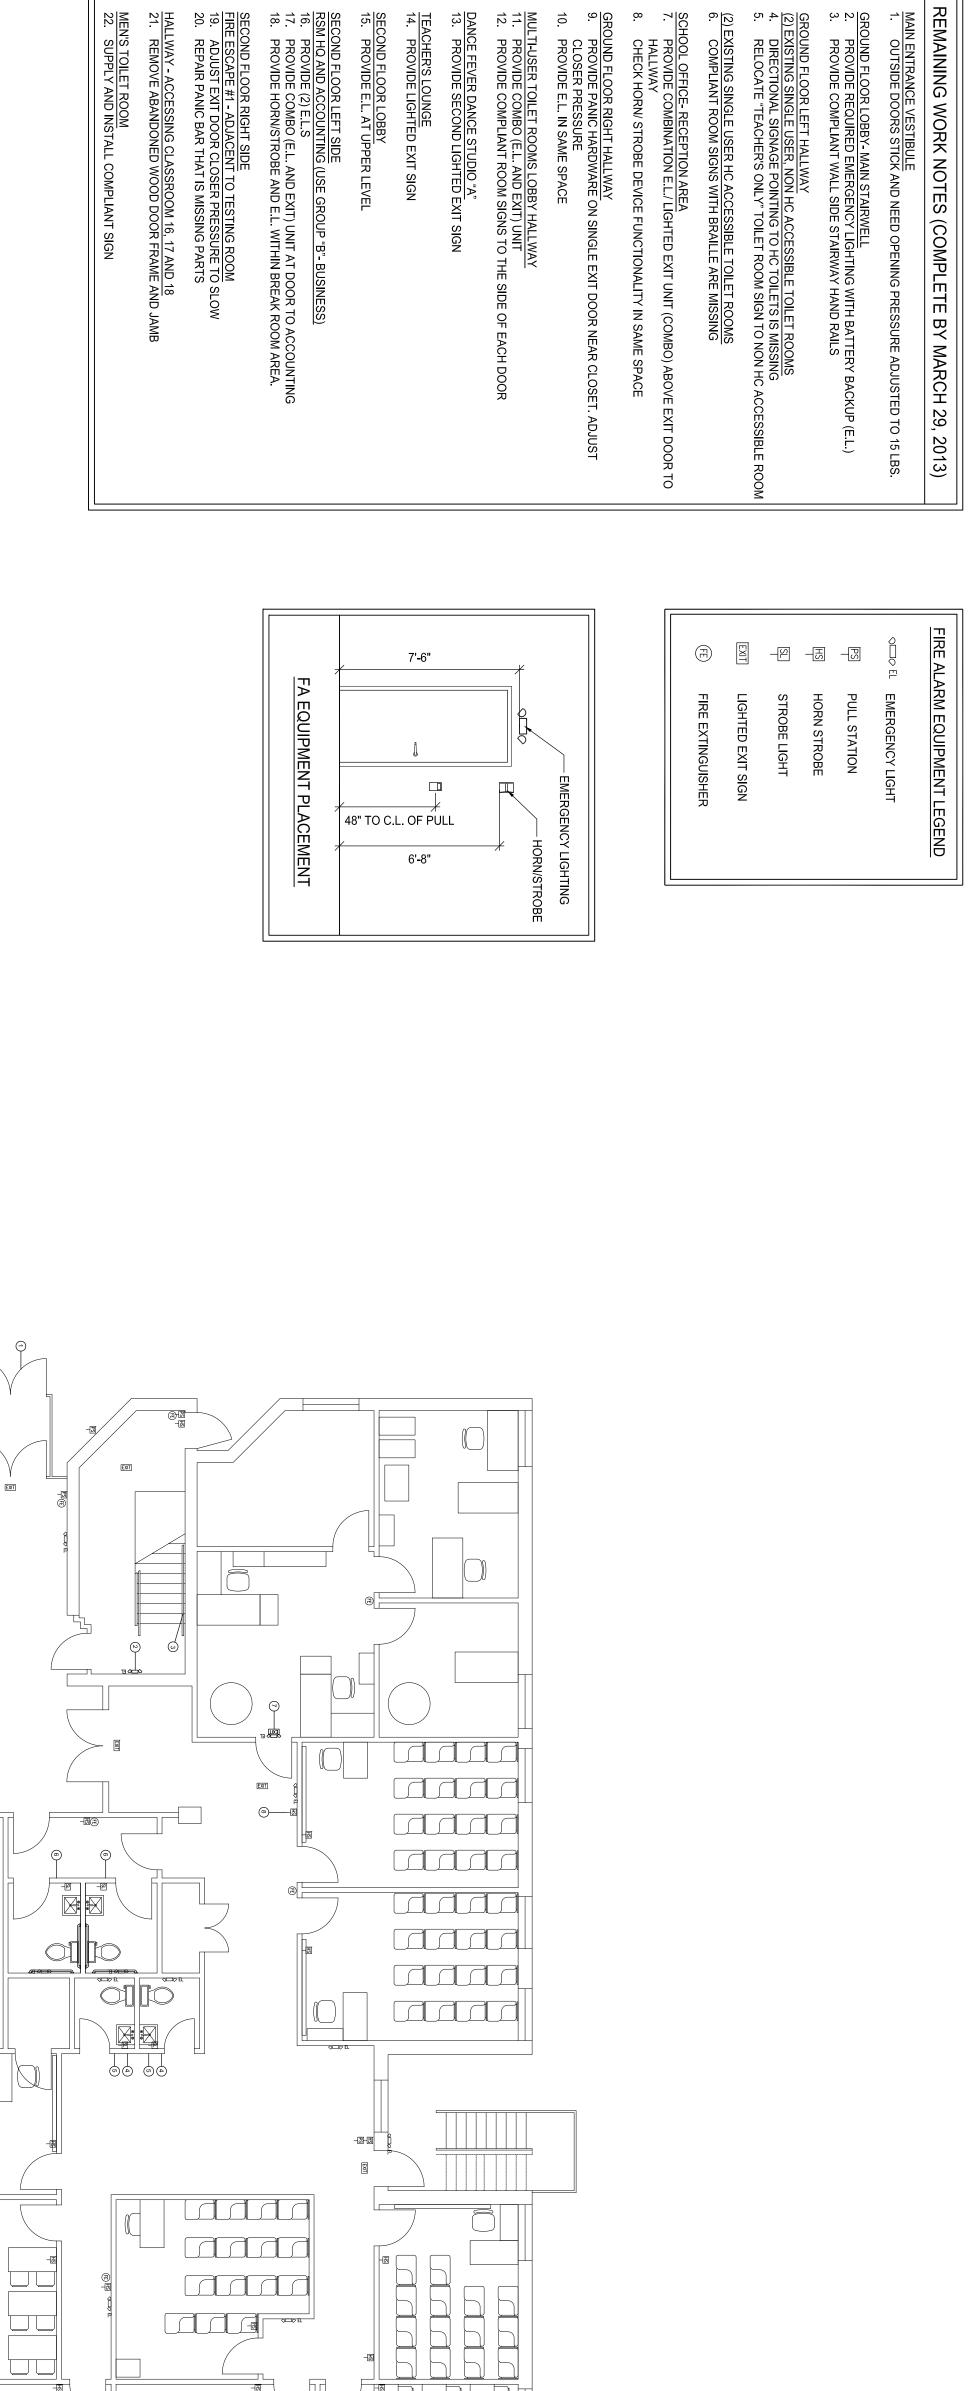
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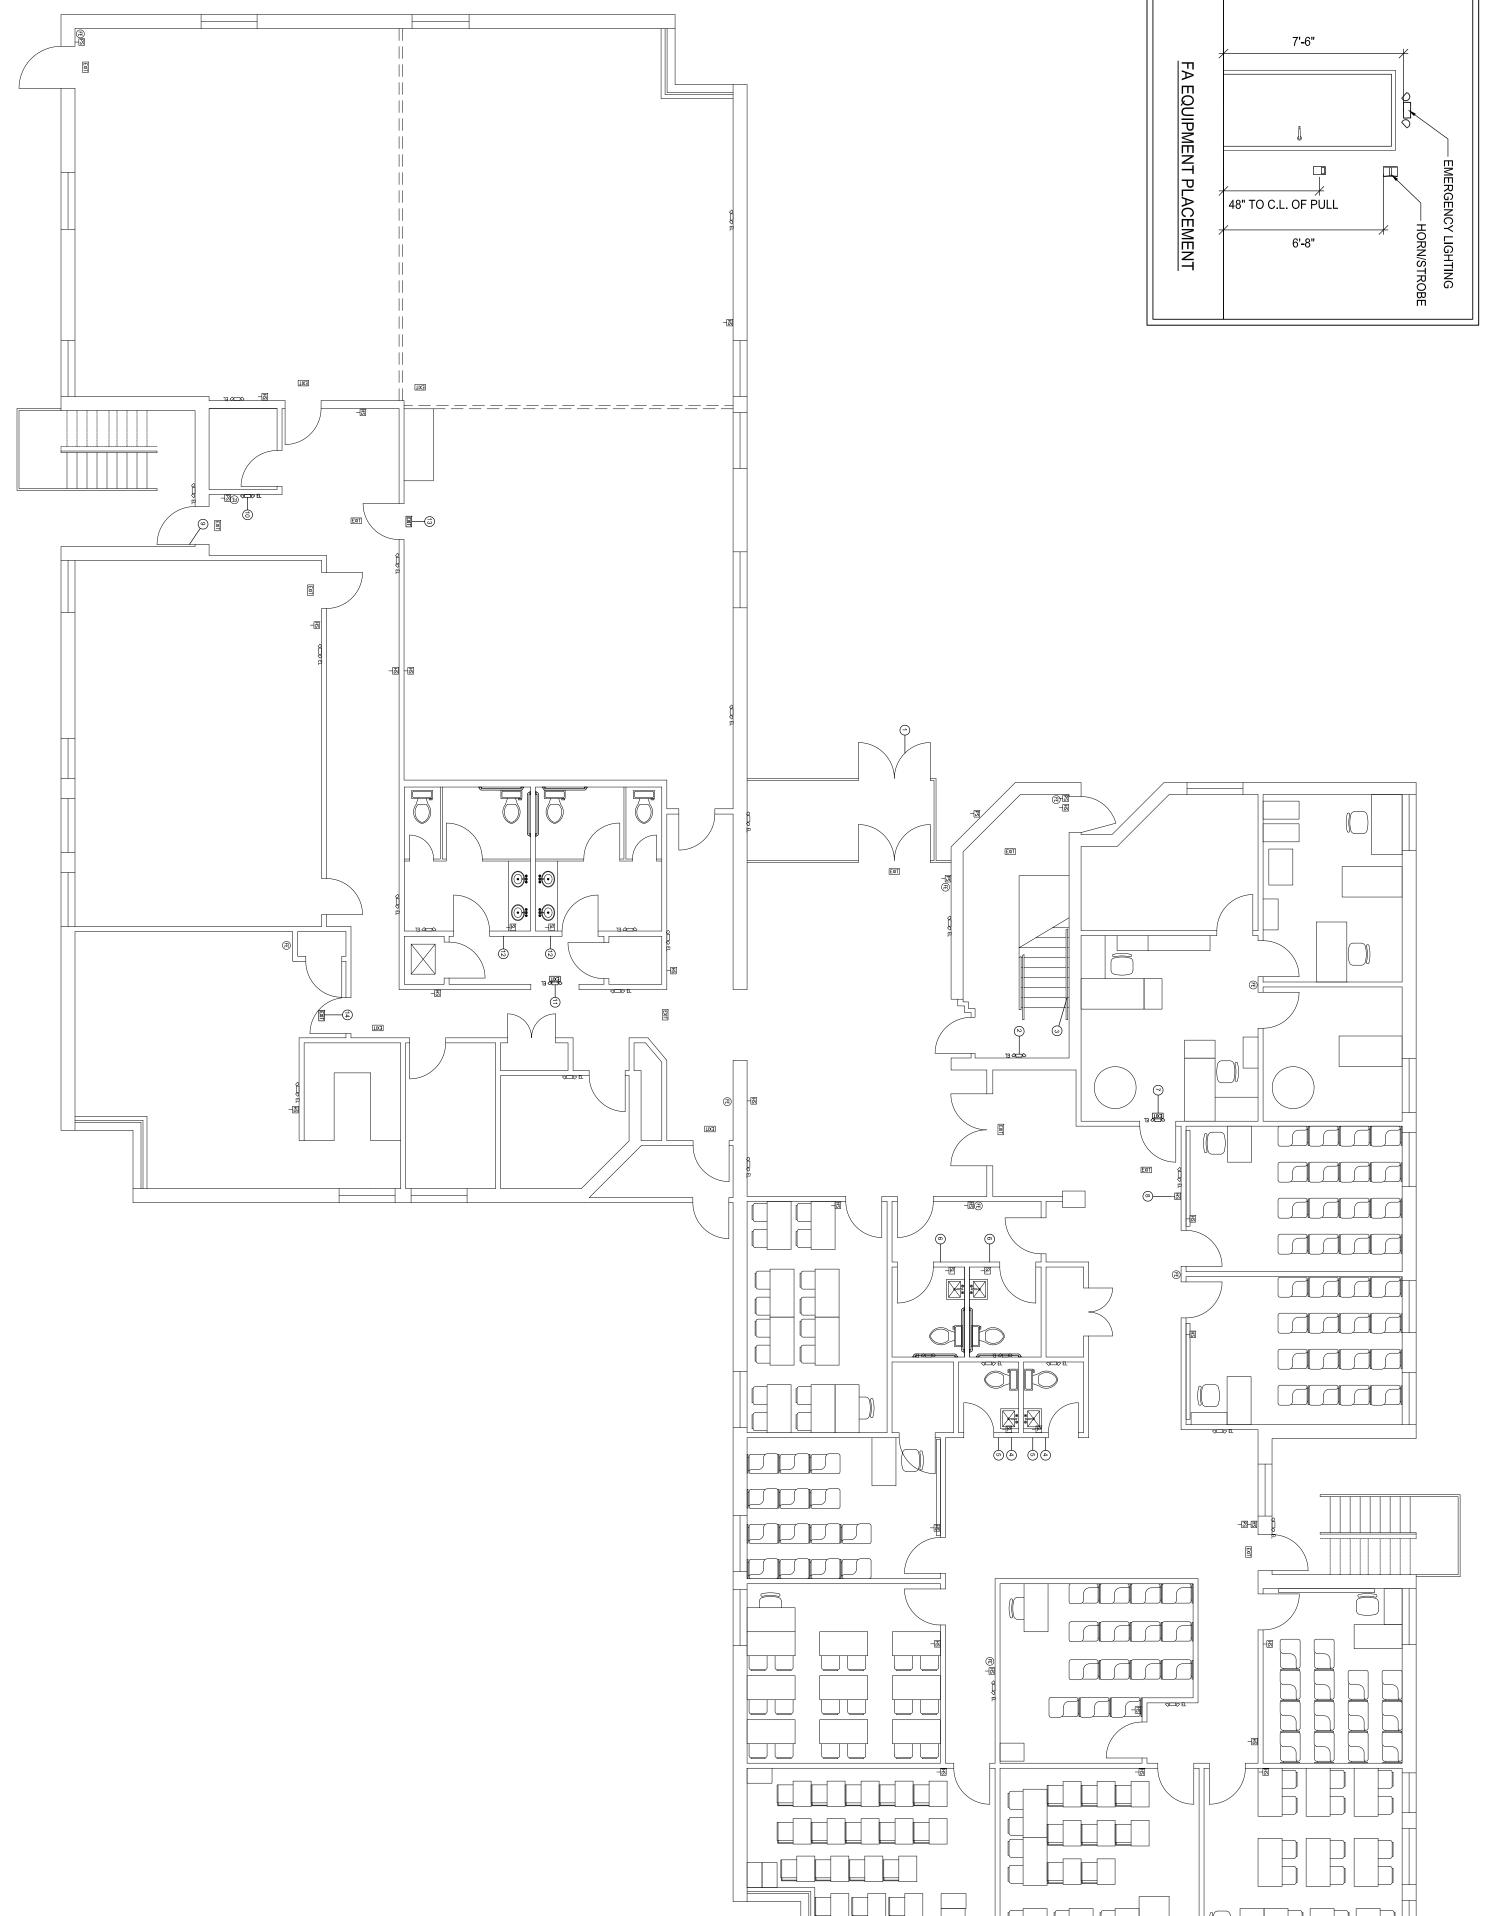
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PROPOSED SECOND FLOOR PLAN





PROPOSED GROUND FLOOR REFLECTED CEILING PLAN

A4.0 SCALE: 1/8" =1'-0"

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PROPOSED GROUND FLOOR REFLECTED CEILING PLAN	DRAWING TITLE
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PROPOSED SECOND FLOOR REFLECTED CEILING PLAN SCALE: 1/8" =1'-0"


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PROPOSED SECOND FLOOR REFLECTED CEILING PLAN



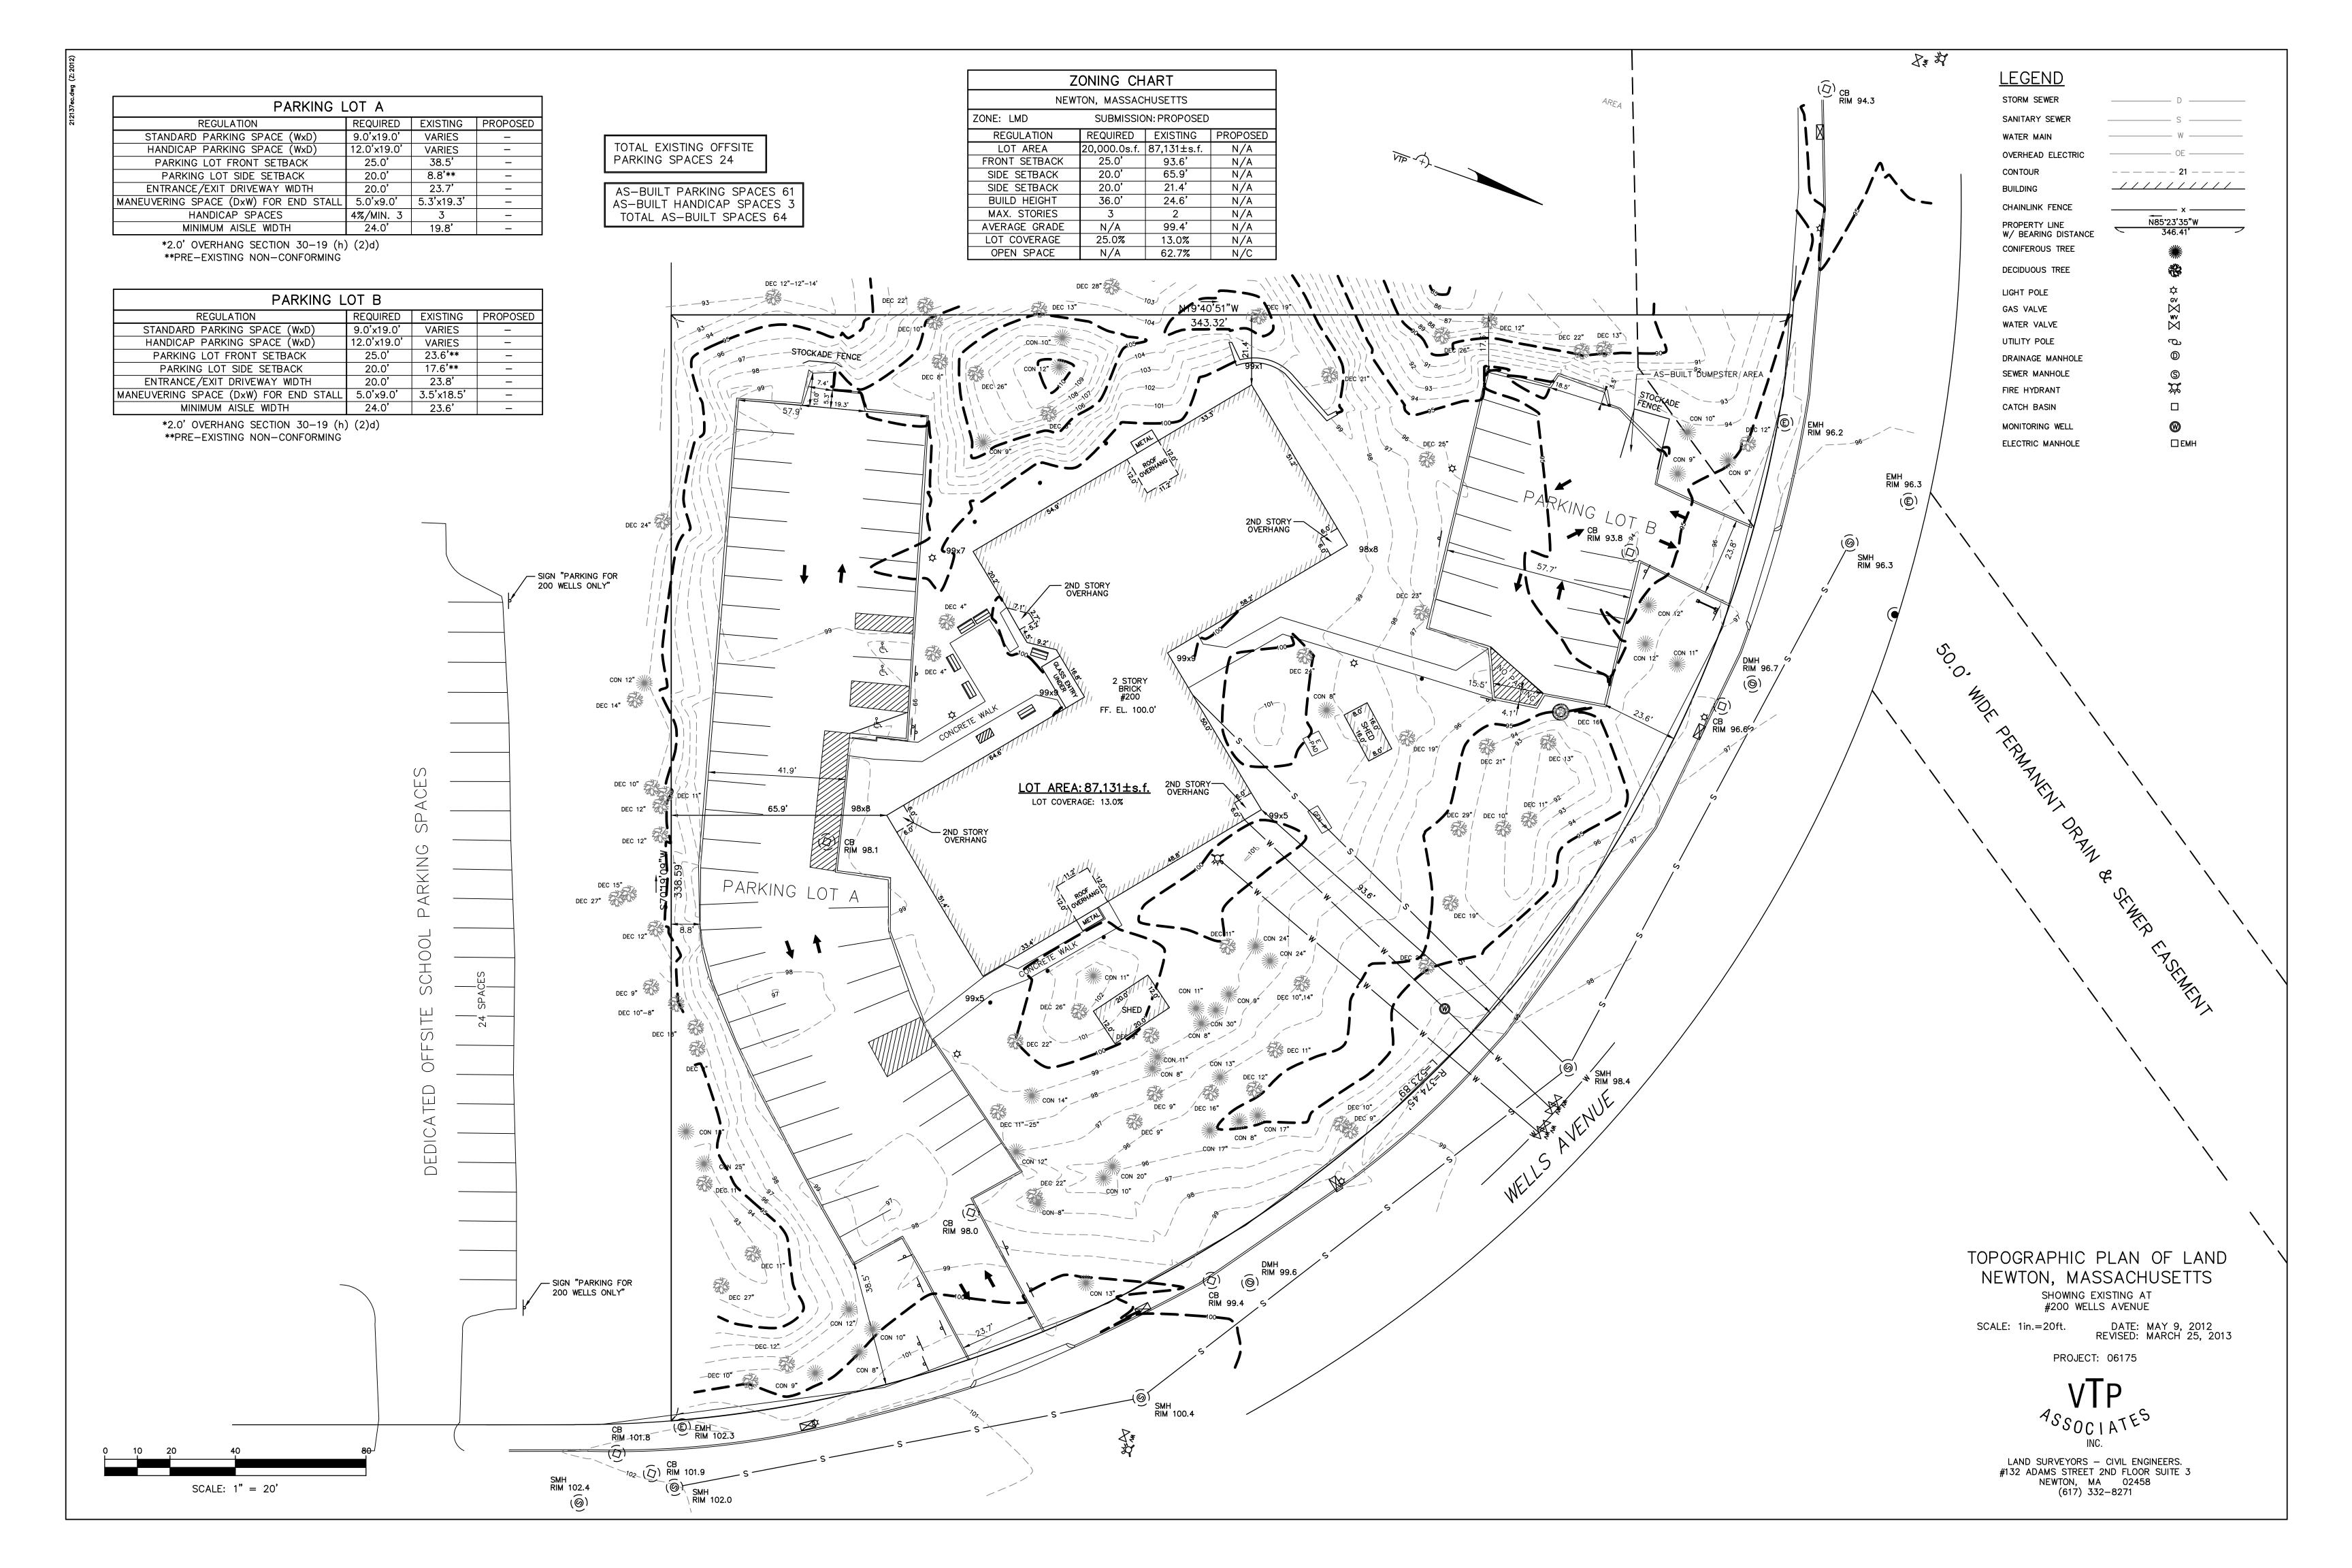\Box	
PARKING LOT A	LEGEND STORM SEWER D D SANITARY SEWER S SANITARY SEWER S OVERHEAD ELECTRIC OE CONTOUR 21 SUILDING CHAINLINK FENCE X SANITARY SEWER S SANITARY SEWER SANITARY SEWER
MINIMUM AISLE WIDTH 24.0' 19.8' -	PROPERTY LINE W/ BEARING DISTANCE CONIFEROUS TREE DECIDUOUS TREE
PARKING LOT B REGULATION REQUIRED EXISTING PROPOSED STANDARD PARKING SPACE (WxD) 9,0'x19,0' VARIES - HANDICAP PARKING SPACE (WxD) 12.0'x19.0' VARIES - PARKING LOT FRONT SETBACK 25,0' 23,6'** - PARKING LOT SIDE SETBACK 20,0' 17,6'** - ENTRANCE/EXIT DRIVEWAY WIDTH 20,0' 23,8' - MANEUVERING SPACE (DxW) FOR END STALL 5,0'x9,0' 3,5'x18,5' - MINIMUM AISLE WIDTH 24.0' 23.6' - *2.0' OVERHANG SECTION 30–19 (h) (2)d) ***PRE-EXISTING NON-CONFORMING	LIGHT POLE GAS VALVE WATER VALVE UTILITY POLE DRAINAGE MANHOLE SEWER MANHOLE SEWER MANHOLE FIRE HYDRANT CATCH BASIN MONITORING WELL MONITORING WELL
NOTE: THE EXISTING DIMENSIONAL REQUIREMENTS FOR PARKING LOT A AND PARKING LOT B HAVE BEEN APPROVED BY BOARD ORDER 325-06.	CON 9" EMH RIM 96.3
DEC 24" STORY STORY SOVERHANG SO	CB RIM 93.8 % (6) PROPOSED STOP SIGN
DEC 4" DEC 4" DEC 4" DEC 4" DEC 23" DEC 24" DEC 24"	CON 12" CON 11" CON 12" CON 11" DMH 96.7/
DEC 4" DEC 4" DEC 4" DEC 2" CON 8" FF. EL. 100.0' DEC 2" CON 8" EXISTING SIGN TO BE RELOCATED SO RELOCAT	RIM 96.7/ (©) CB RIM 96.69
DEC 10" DEC 10" DEC 11" DEC 12" DEC 12" DEC 19" DEC 19" DEC 19" DEC 19" DEC 19" DEC 19" DEC 10" DEC	
DEC 12" DEC 12" DEC 12" DEC 28" DEC 11" DEC 28" DEC 11" DEC 15" DEC 28" DEC 15" DEC 15" DEC 28" DEC 15" DEC 28" DEC 15" DEC 28" DEC 15" DEC 15" DEC 28" DEC 15" DEC 15" DEC 28" DEC 15" DEC 28" DEC 15" DEC	
PROPOSED ONE(1) HOUR PARKING SIGN PROPOSED ONE(1) HOUR PARKING SIGN PROPOSED ONE (1) HOUR PARKING SIGN PROPOSED DEC 110 PROPOSED DEC 111 PROPOSED DEC 1	
DEC 9" DEC 10"-8" DEC 24" DEC 26" D	
PROPOSED 99 ONE(1) HOUR PROPOSED PROPOSED PARKING SIGN CON 14" DEC 9" DEC 16" DEC 17" DEC 9" DEC 16" DEC 9"	SMH RIM 98.4
CON 12" CON 25" DEC 22" CON 10" OBEC 22" OBEC	
SIGN "PARKING FOR 200 WELLS ONLY" SIGN "PARKING FOR CB (®) DMH RIM 99.6 CB (®) DMH RIM 99.6	TOPOGRAPHIC SITE PLAN NEWTON, MASSACHUSETTS
200 WELLS ONLY" CON 12" CON 12" CON 10" CON	SHOWING PROPOSED CONDITIONS AT #200 WELLS AVENUE SCALE: 1in.=20ft. DATE: MARCH 25, 2013 PROJECT: 212137
DEC 10" CON 9" CON 9" PROPOSED SMH RIM 100.4 STOP SIGN S RIM 102.3	VTP ASOCIATES INC.
0 10 20 40 80 SCALE: 1" = 20' SSAH RIM 102.4 (((())) RIM 102.0	LAND SURVEYORS — CIVIL ENGINEERS. 132 ADAMS STREET 2ND FLOOR SUITE 3 NEWTON, MA 02458 (617) 332-8271