# THE MALL AT CHESTNUT HILL 199 BOYLSTON STREET/ROUTE 9 NEWTON, MA

(MODIFICATION TO SPECIAL PERMIT #307-12)

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### PREPARED BY:

RJO'CONNELL & ASSOCIATES, INC.


CIVIL ENGINEERS, SURVEYORS &
LAND PLANNERS
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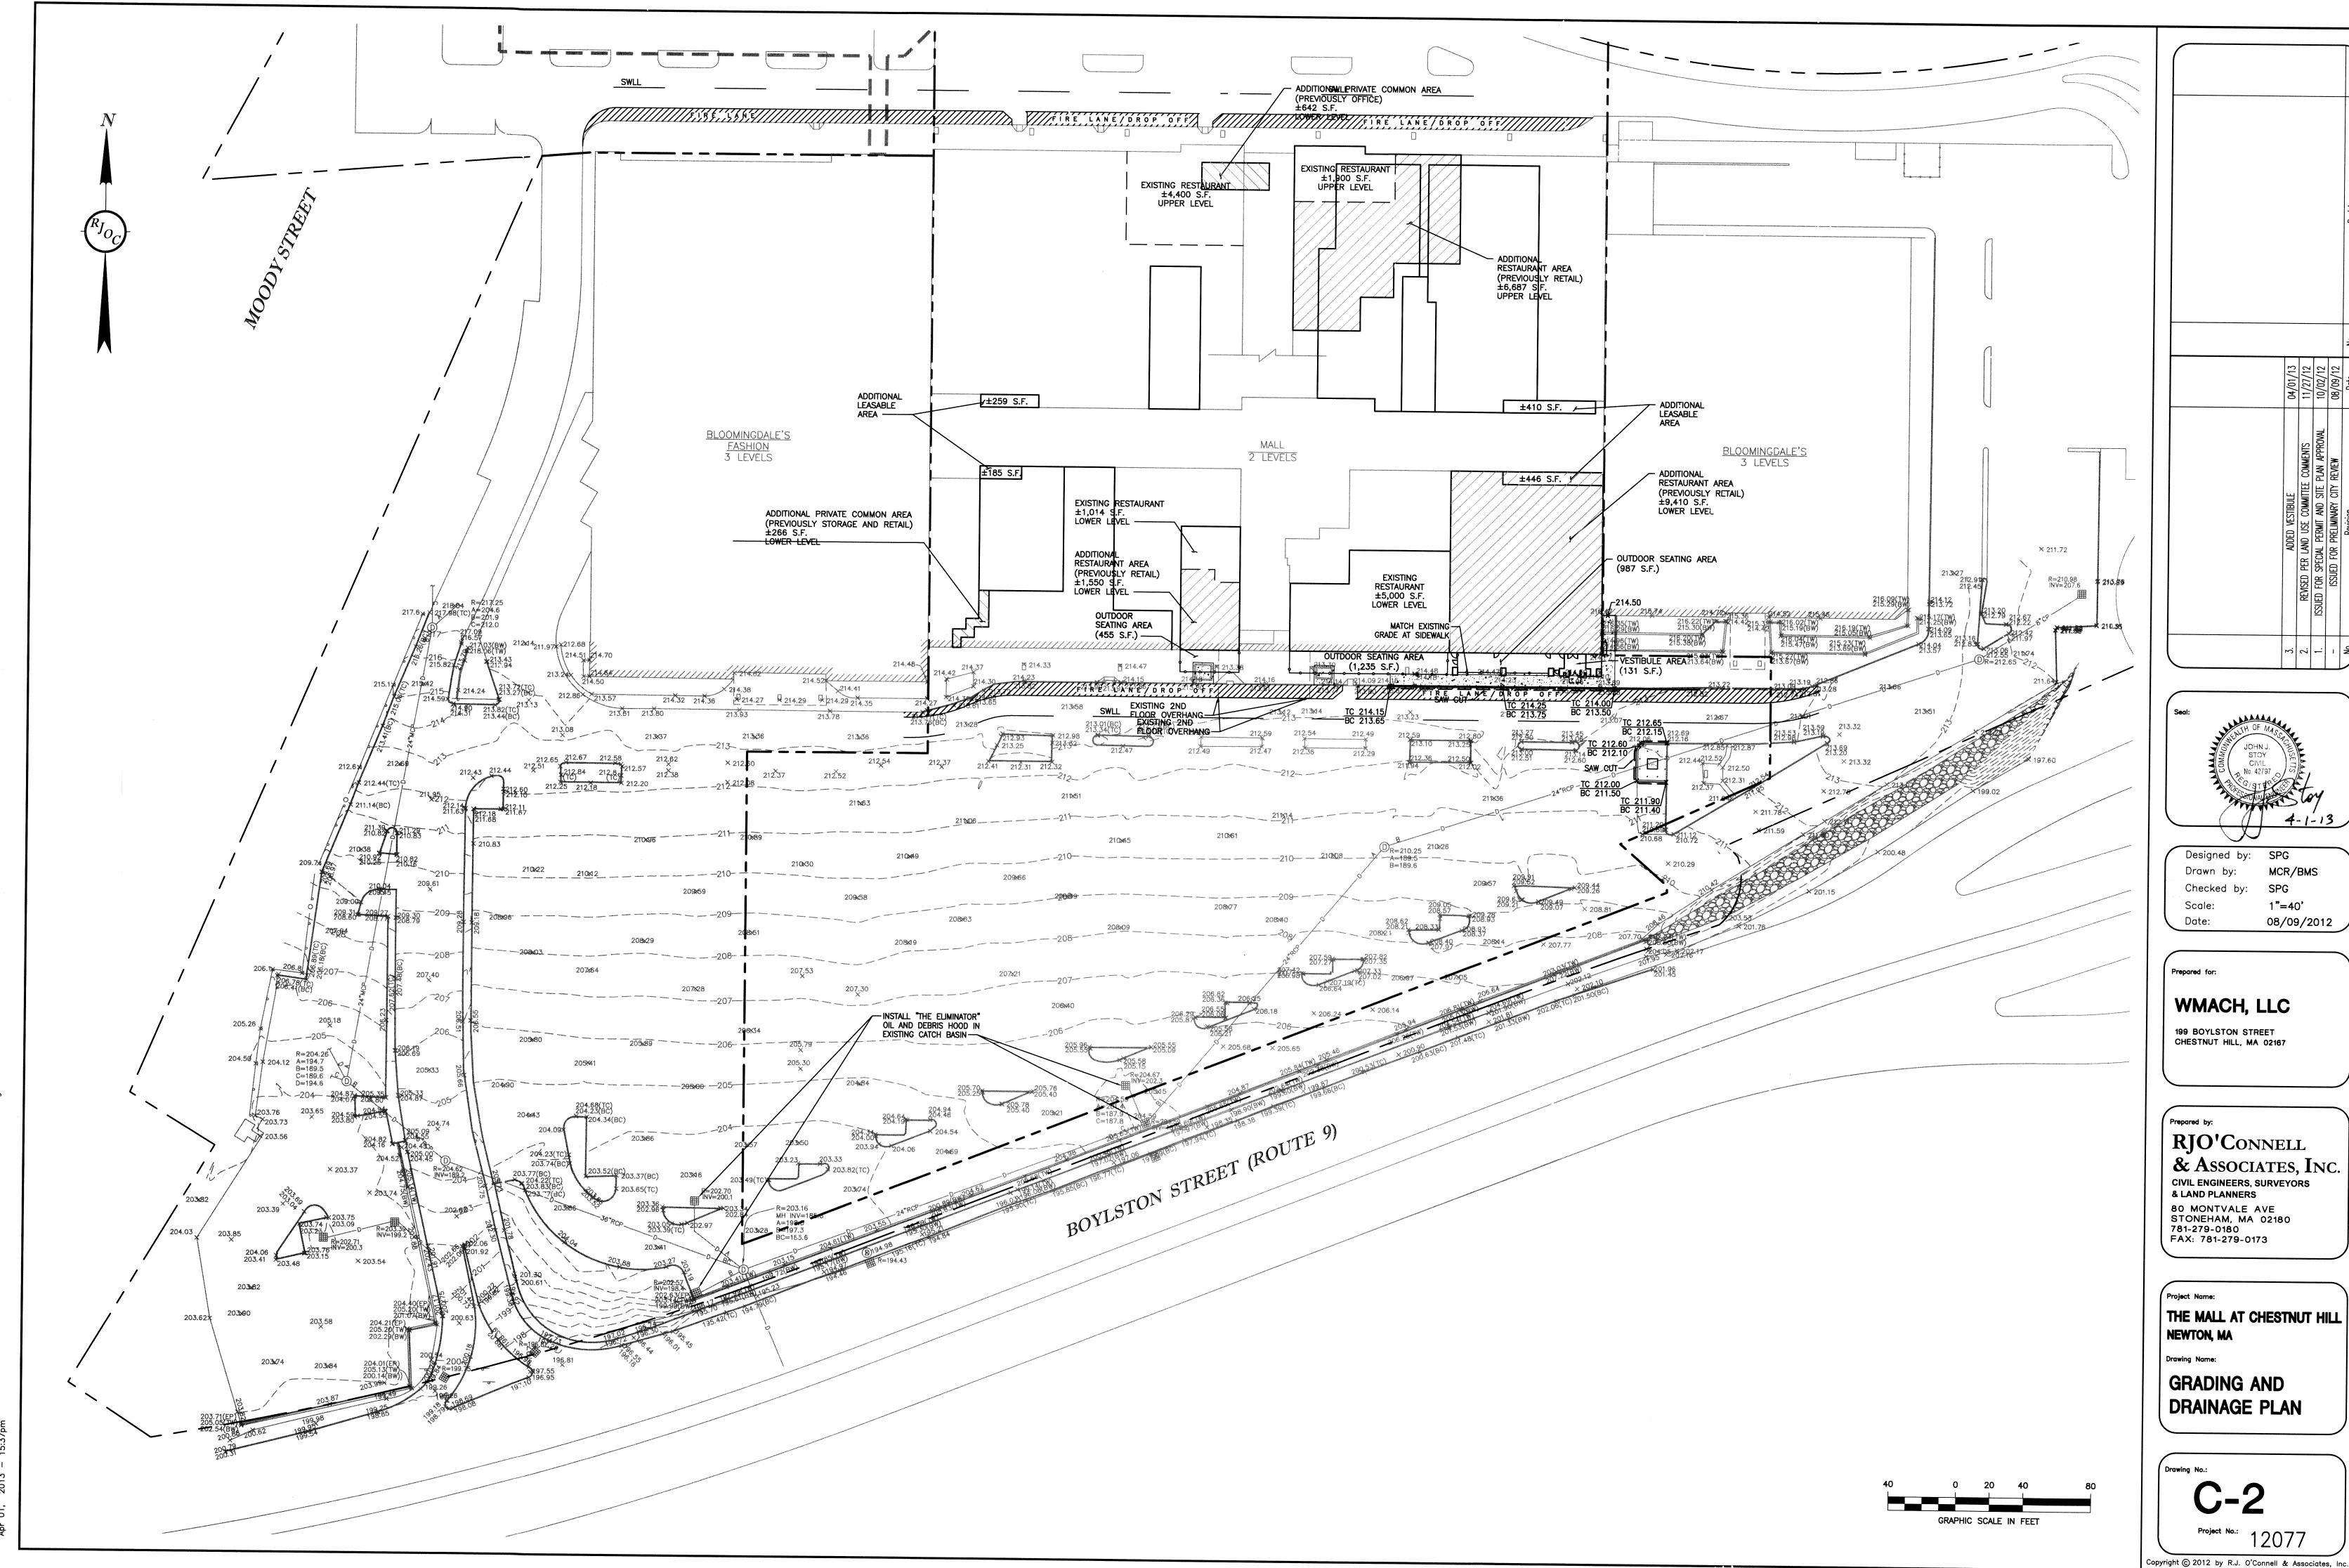
PREPARED FOR:

WMACH, LLC 199 BOYLSTON STREET CHESTNUT HILL, MASSACHUSETTS 02167


| Drawing Index    |   |  |  |  |
|------------------|---|--|--|--|
| Last<br>Revision | Drawing   | Drawing Description  |  |  |
| -                | -   | COVER SHEET  |  |  |
| 04/02/2013       | OSP-1   | OVERALL SITE PLAN  |  |  |
| 04/02/2013       | C-1   | DEMOLITION AND EROSION CONTROL PLAN  |  |  |
| 04/02/2013       | C-2   | GRADING AND DRAINAGE PLAN  |  |  |
| 04/02/2013       | C-3   | UTILITY PLAN   |  |  |
| 04/02/2013       | C-4   | PARKING & TRAFFIC CONTROL PLAN   |  |  |
| 04/02/2013       | C-9   | SIDEWALK ENLARGEMENT PLAN  |  |  |
| -                | -   | PRELIMINARY ELEVATIONS   |  |  |
| -                | -   | ENLARGED VESTIBULE PLAN  |  |  |
| -                | -   | PRELIMINARY FLOOR PLAN   |  |  |
| -                | -   | SIGNAGE DIMENSIONS   |  |  |
| -                | -   | SIGNAGE DIMENSIONS   |  |  |
| -                | -   | SIGNAGE DIMENSIONS   |  |  |
|                  | Revision  -  04/02/2013  04/02/2013  04/02/2013  04/02/2013  04/02/2013 | Last<br>RevisionDrawing04/02/2013OSP-104/02/2013C-104/02/2013C-204/02/2013C-304/02/2013C-4 |  |  |


<sup>☐</sup> ISSUED FOR PERMIT
☐ ISSUED FOR BID/PRICING
☐ ISSUED FOR CONSTRUCTION




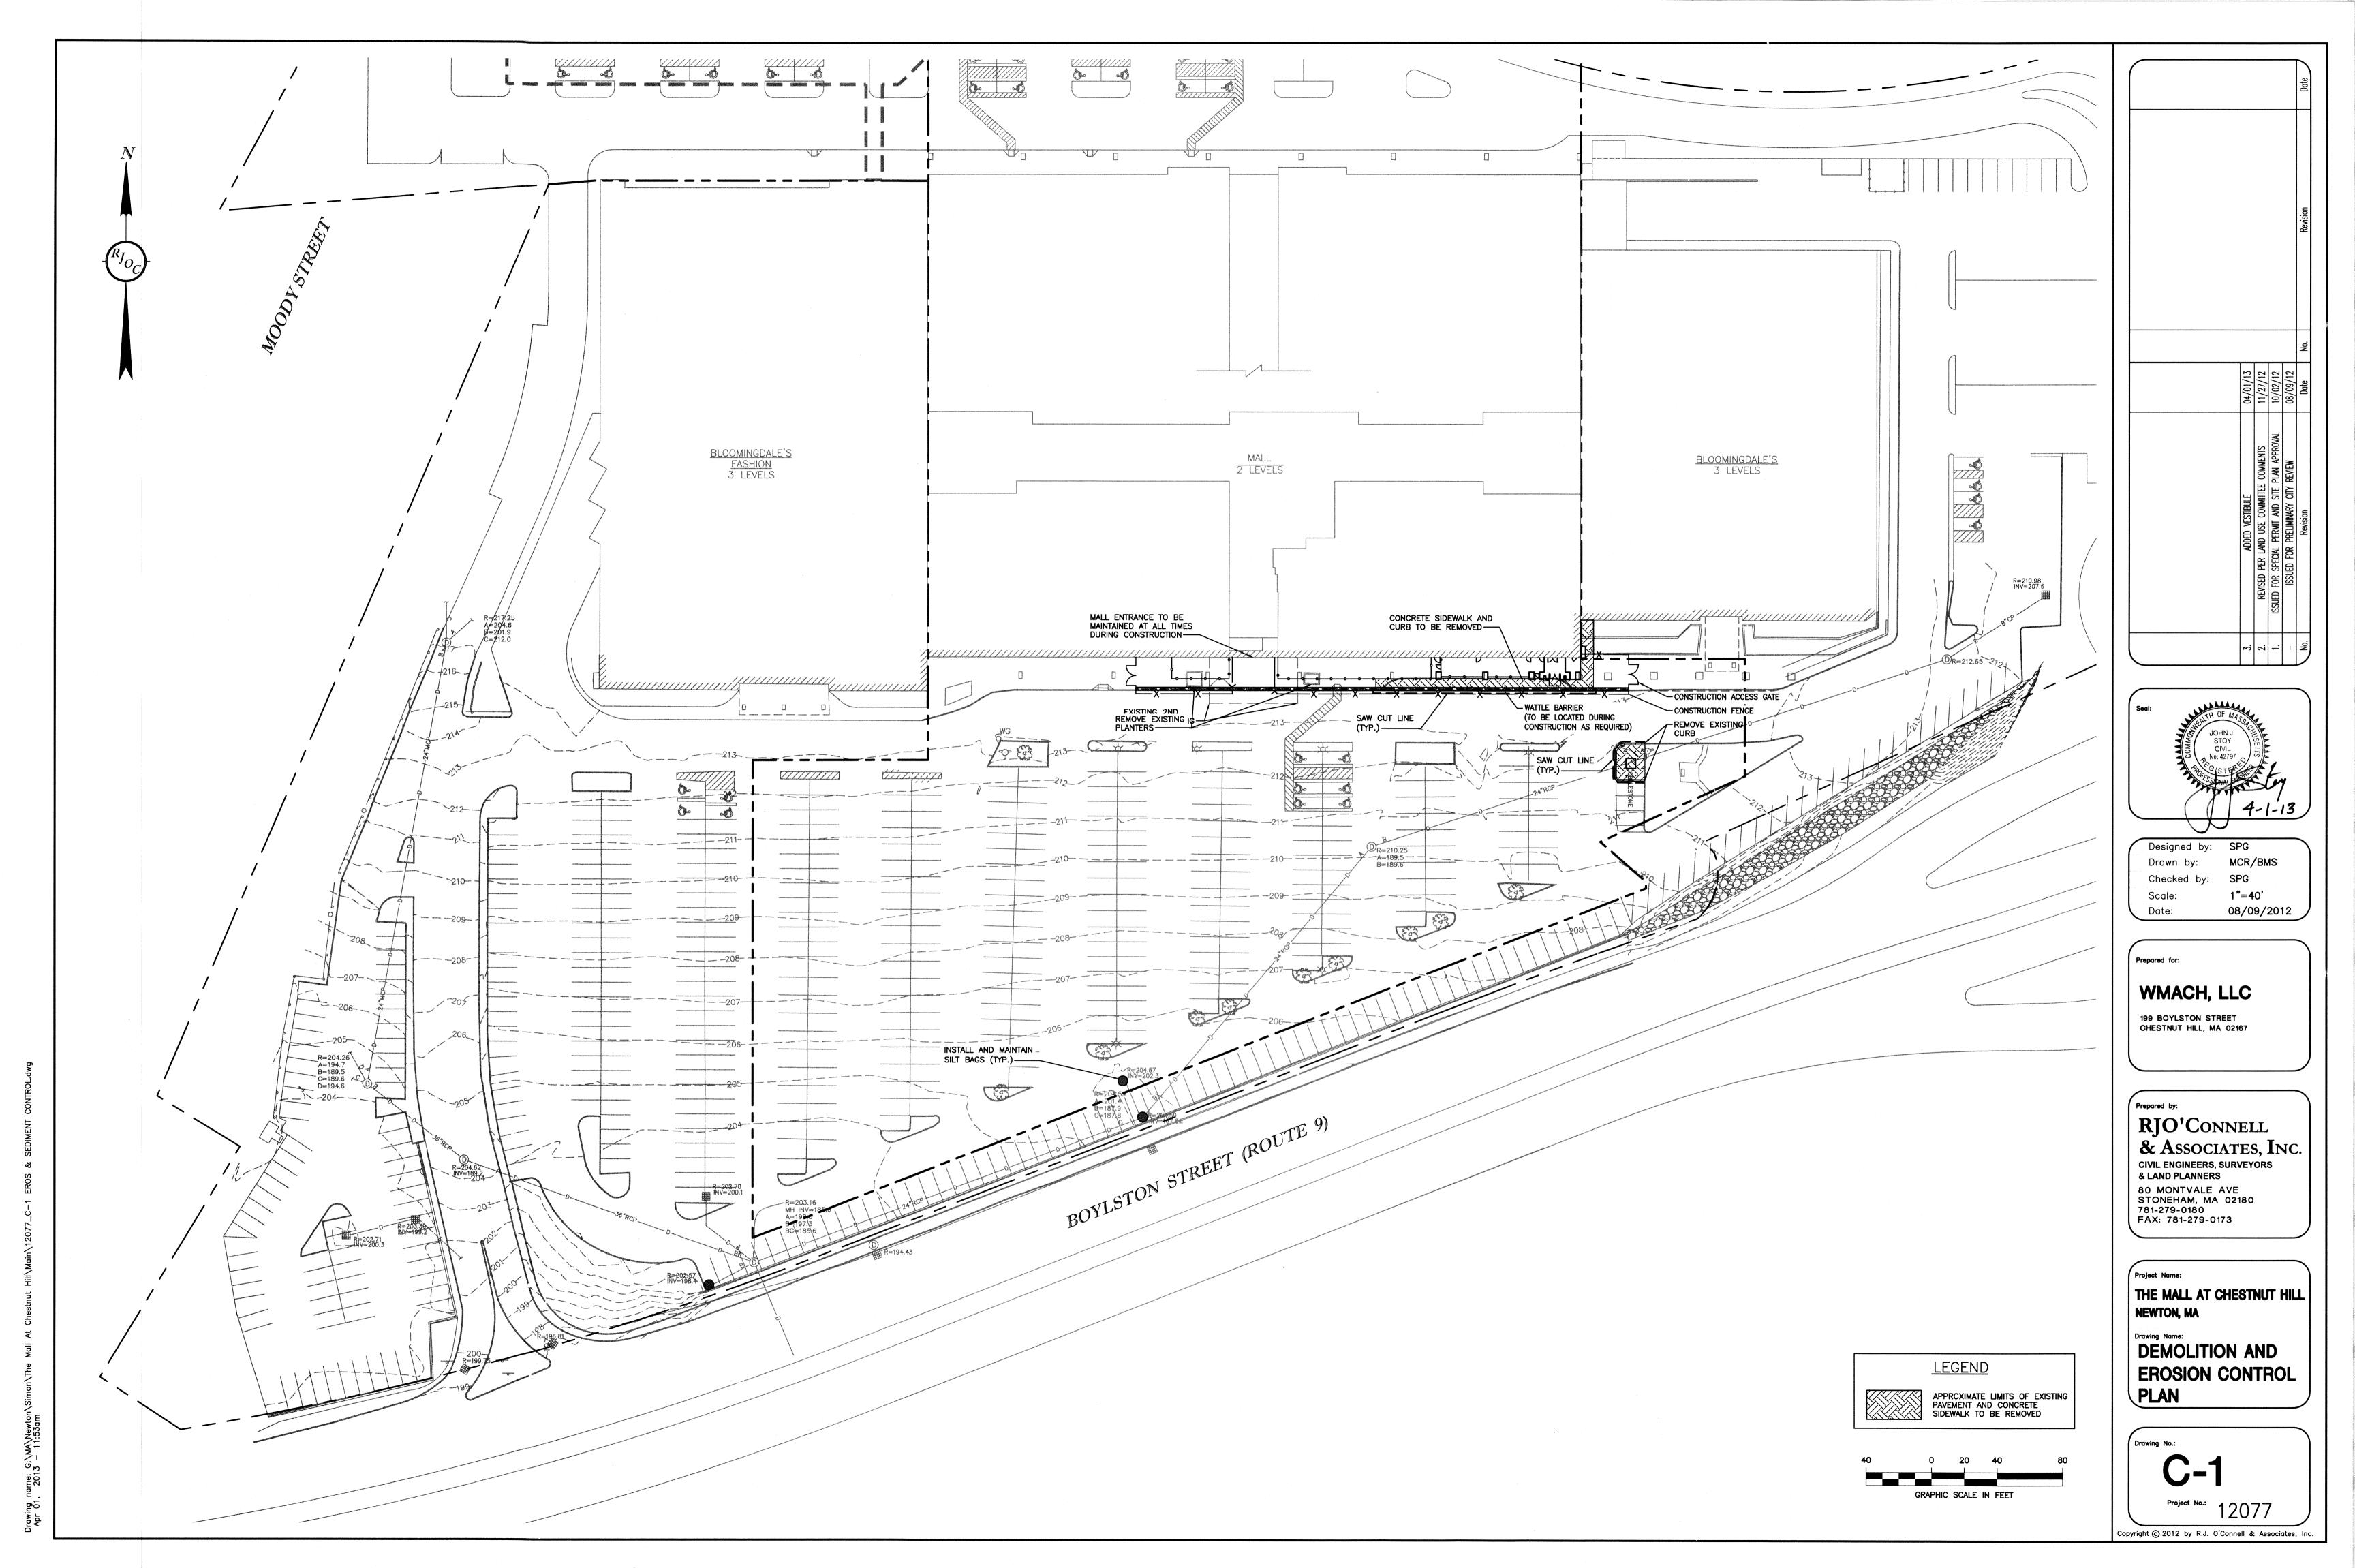

name: G:\MA\Newton\Simon\The Mall At Chestnut Hill\Main\12077\_C-2 GRADE & DRAINAG 2013 - 15:37pm

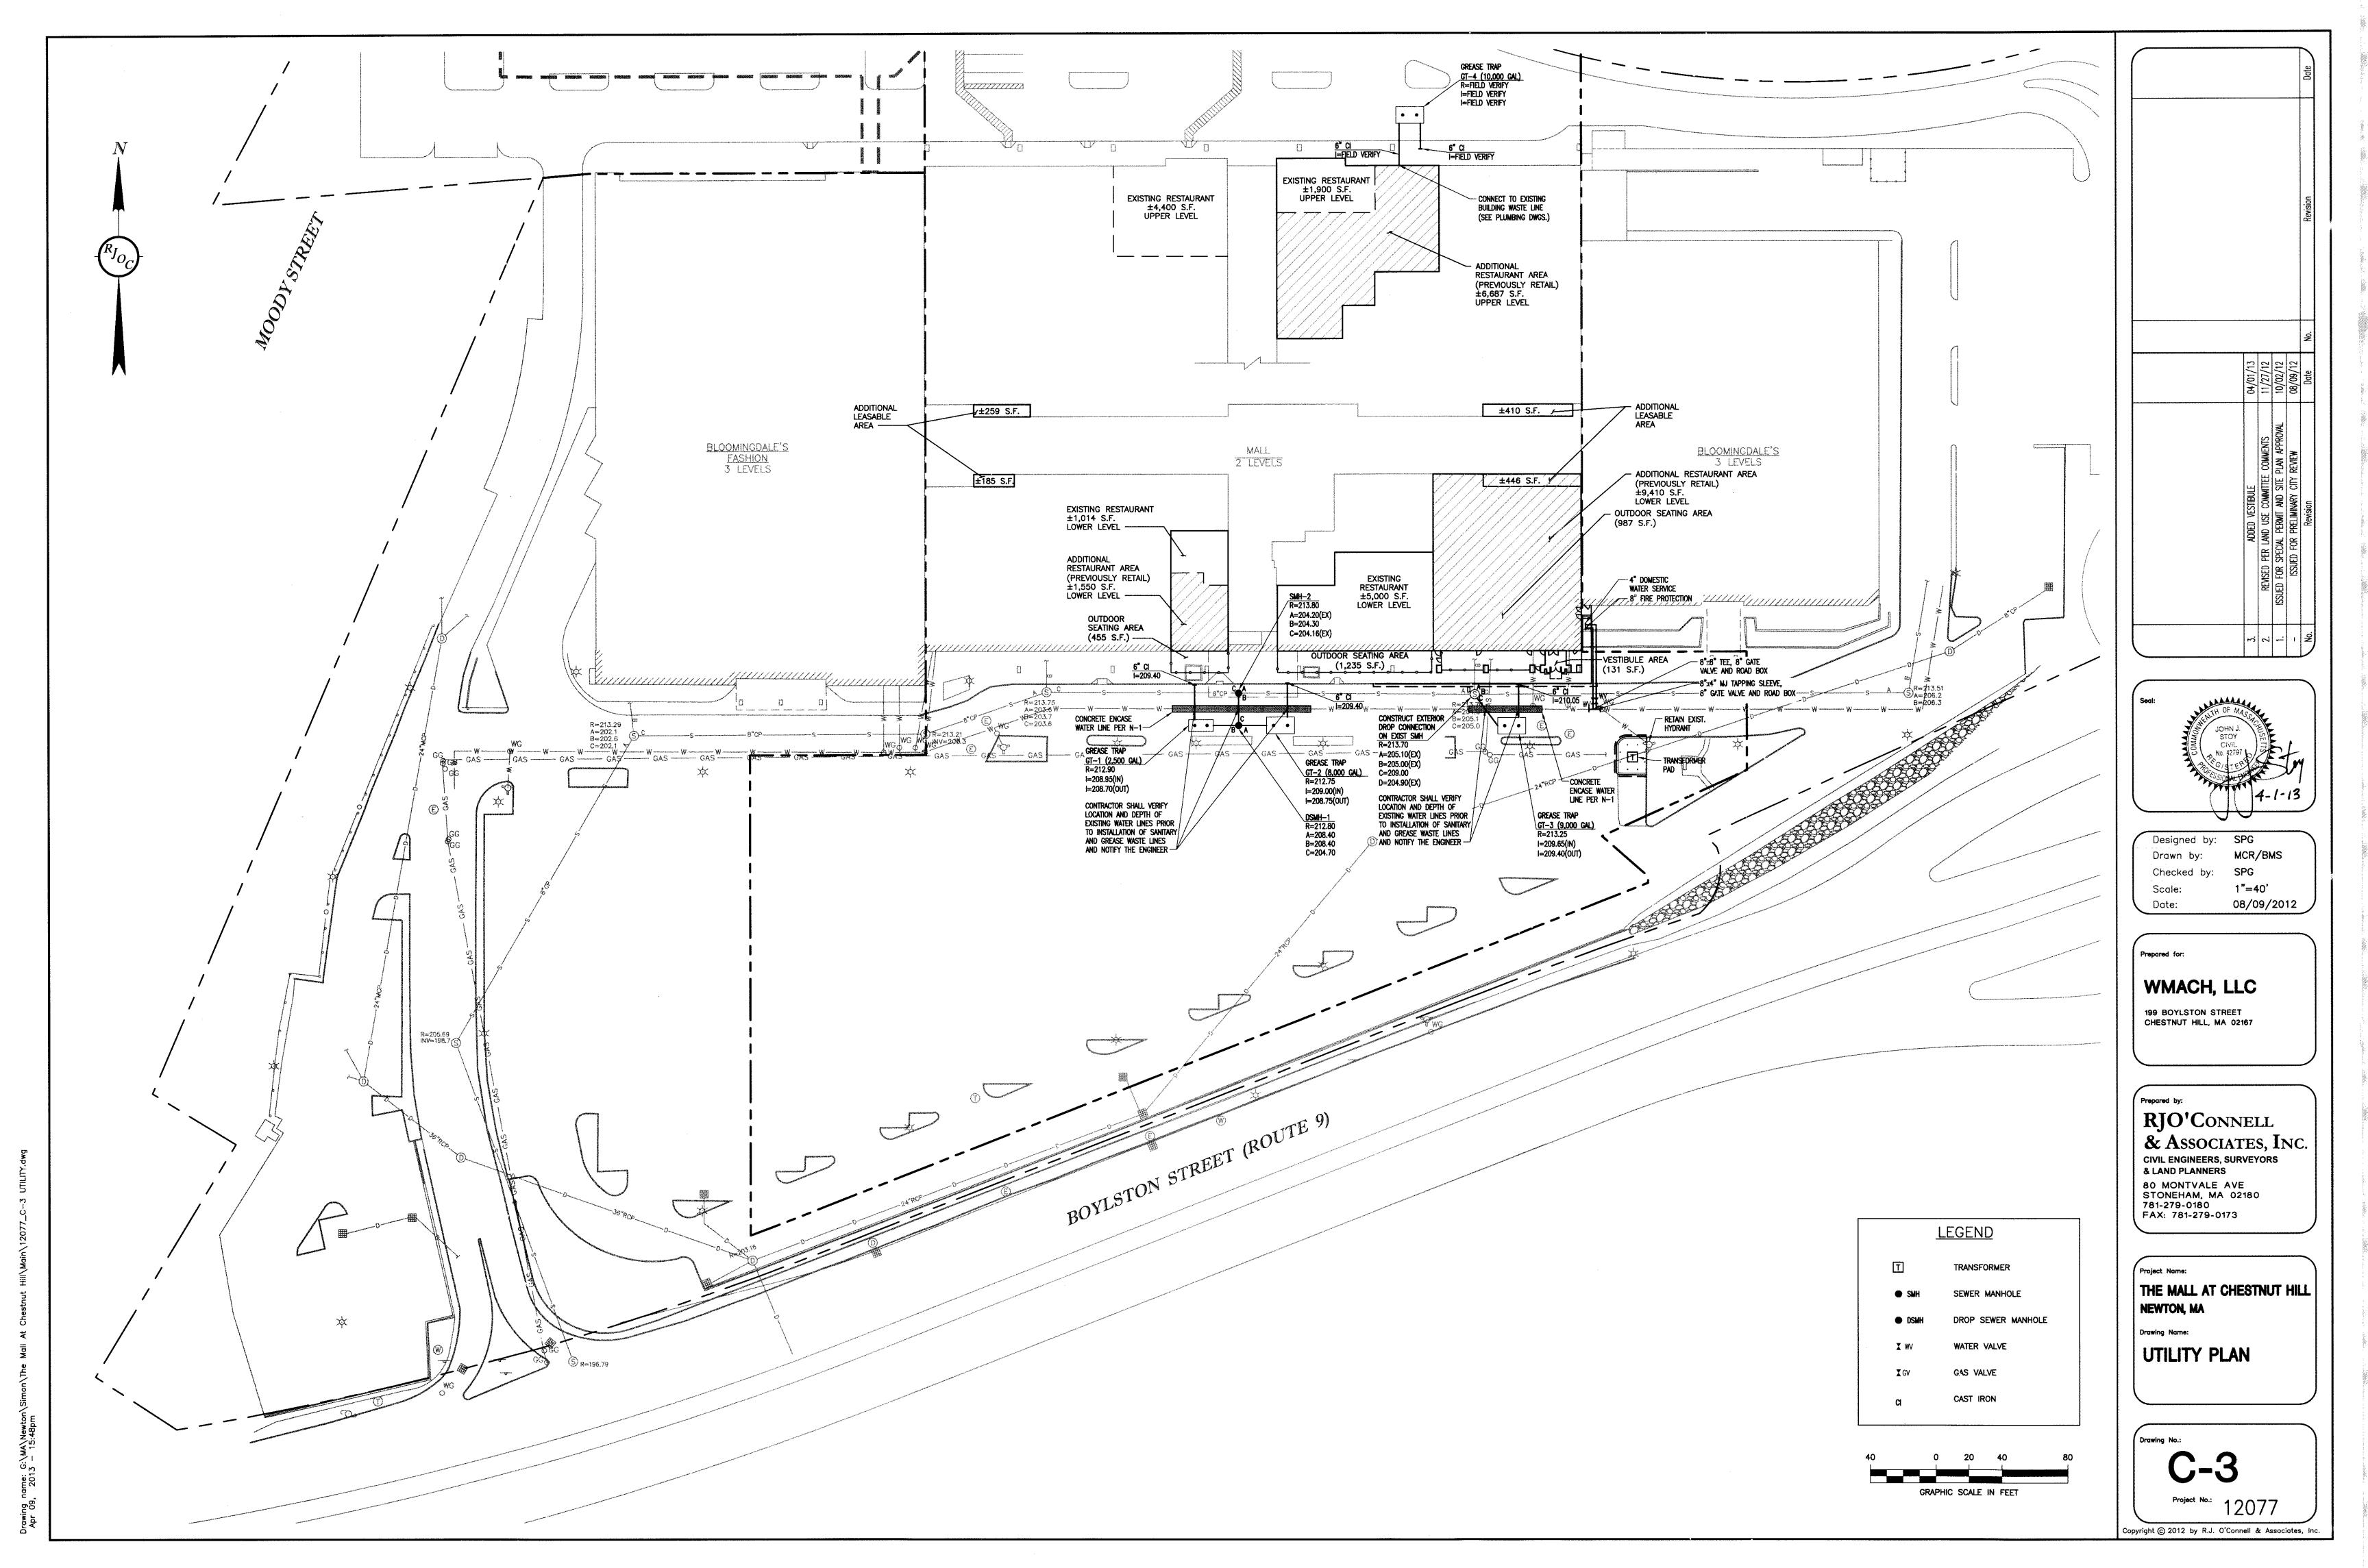


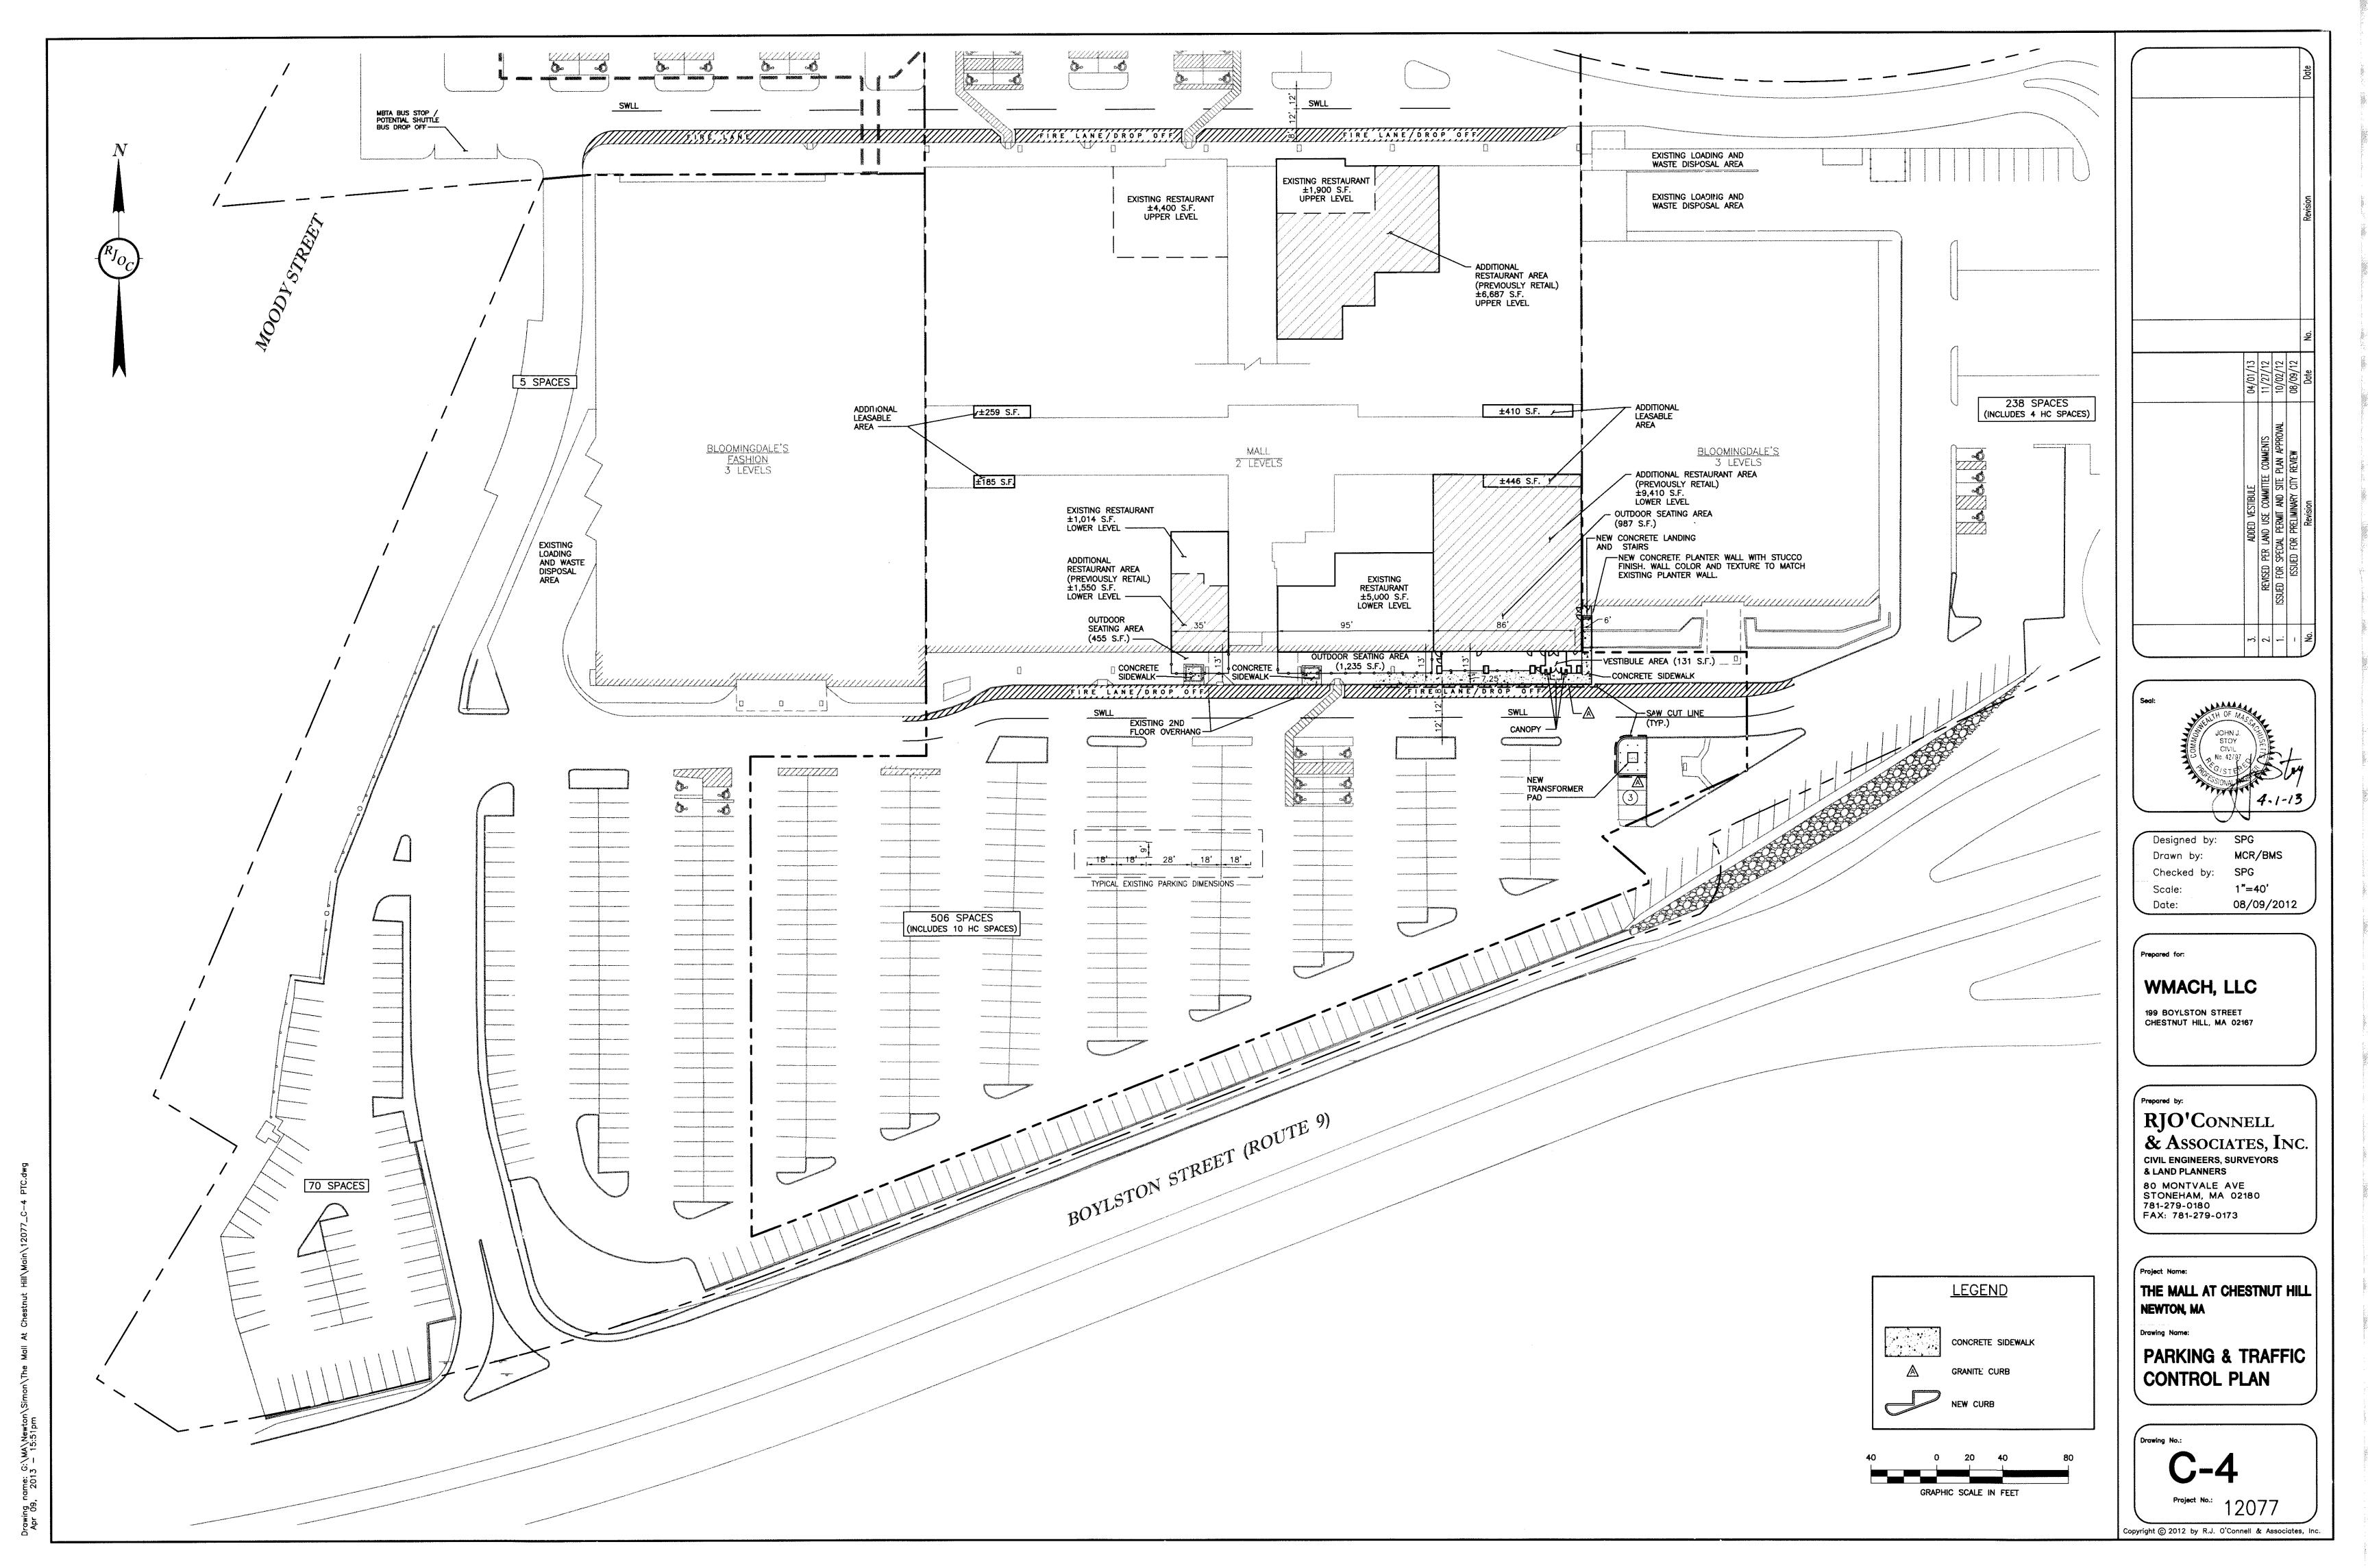

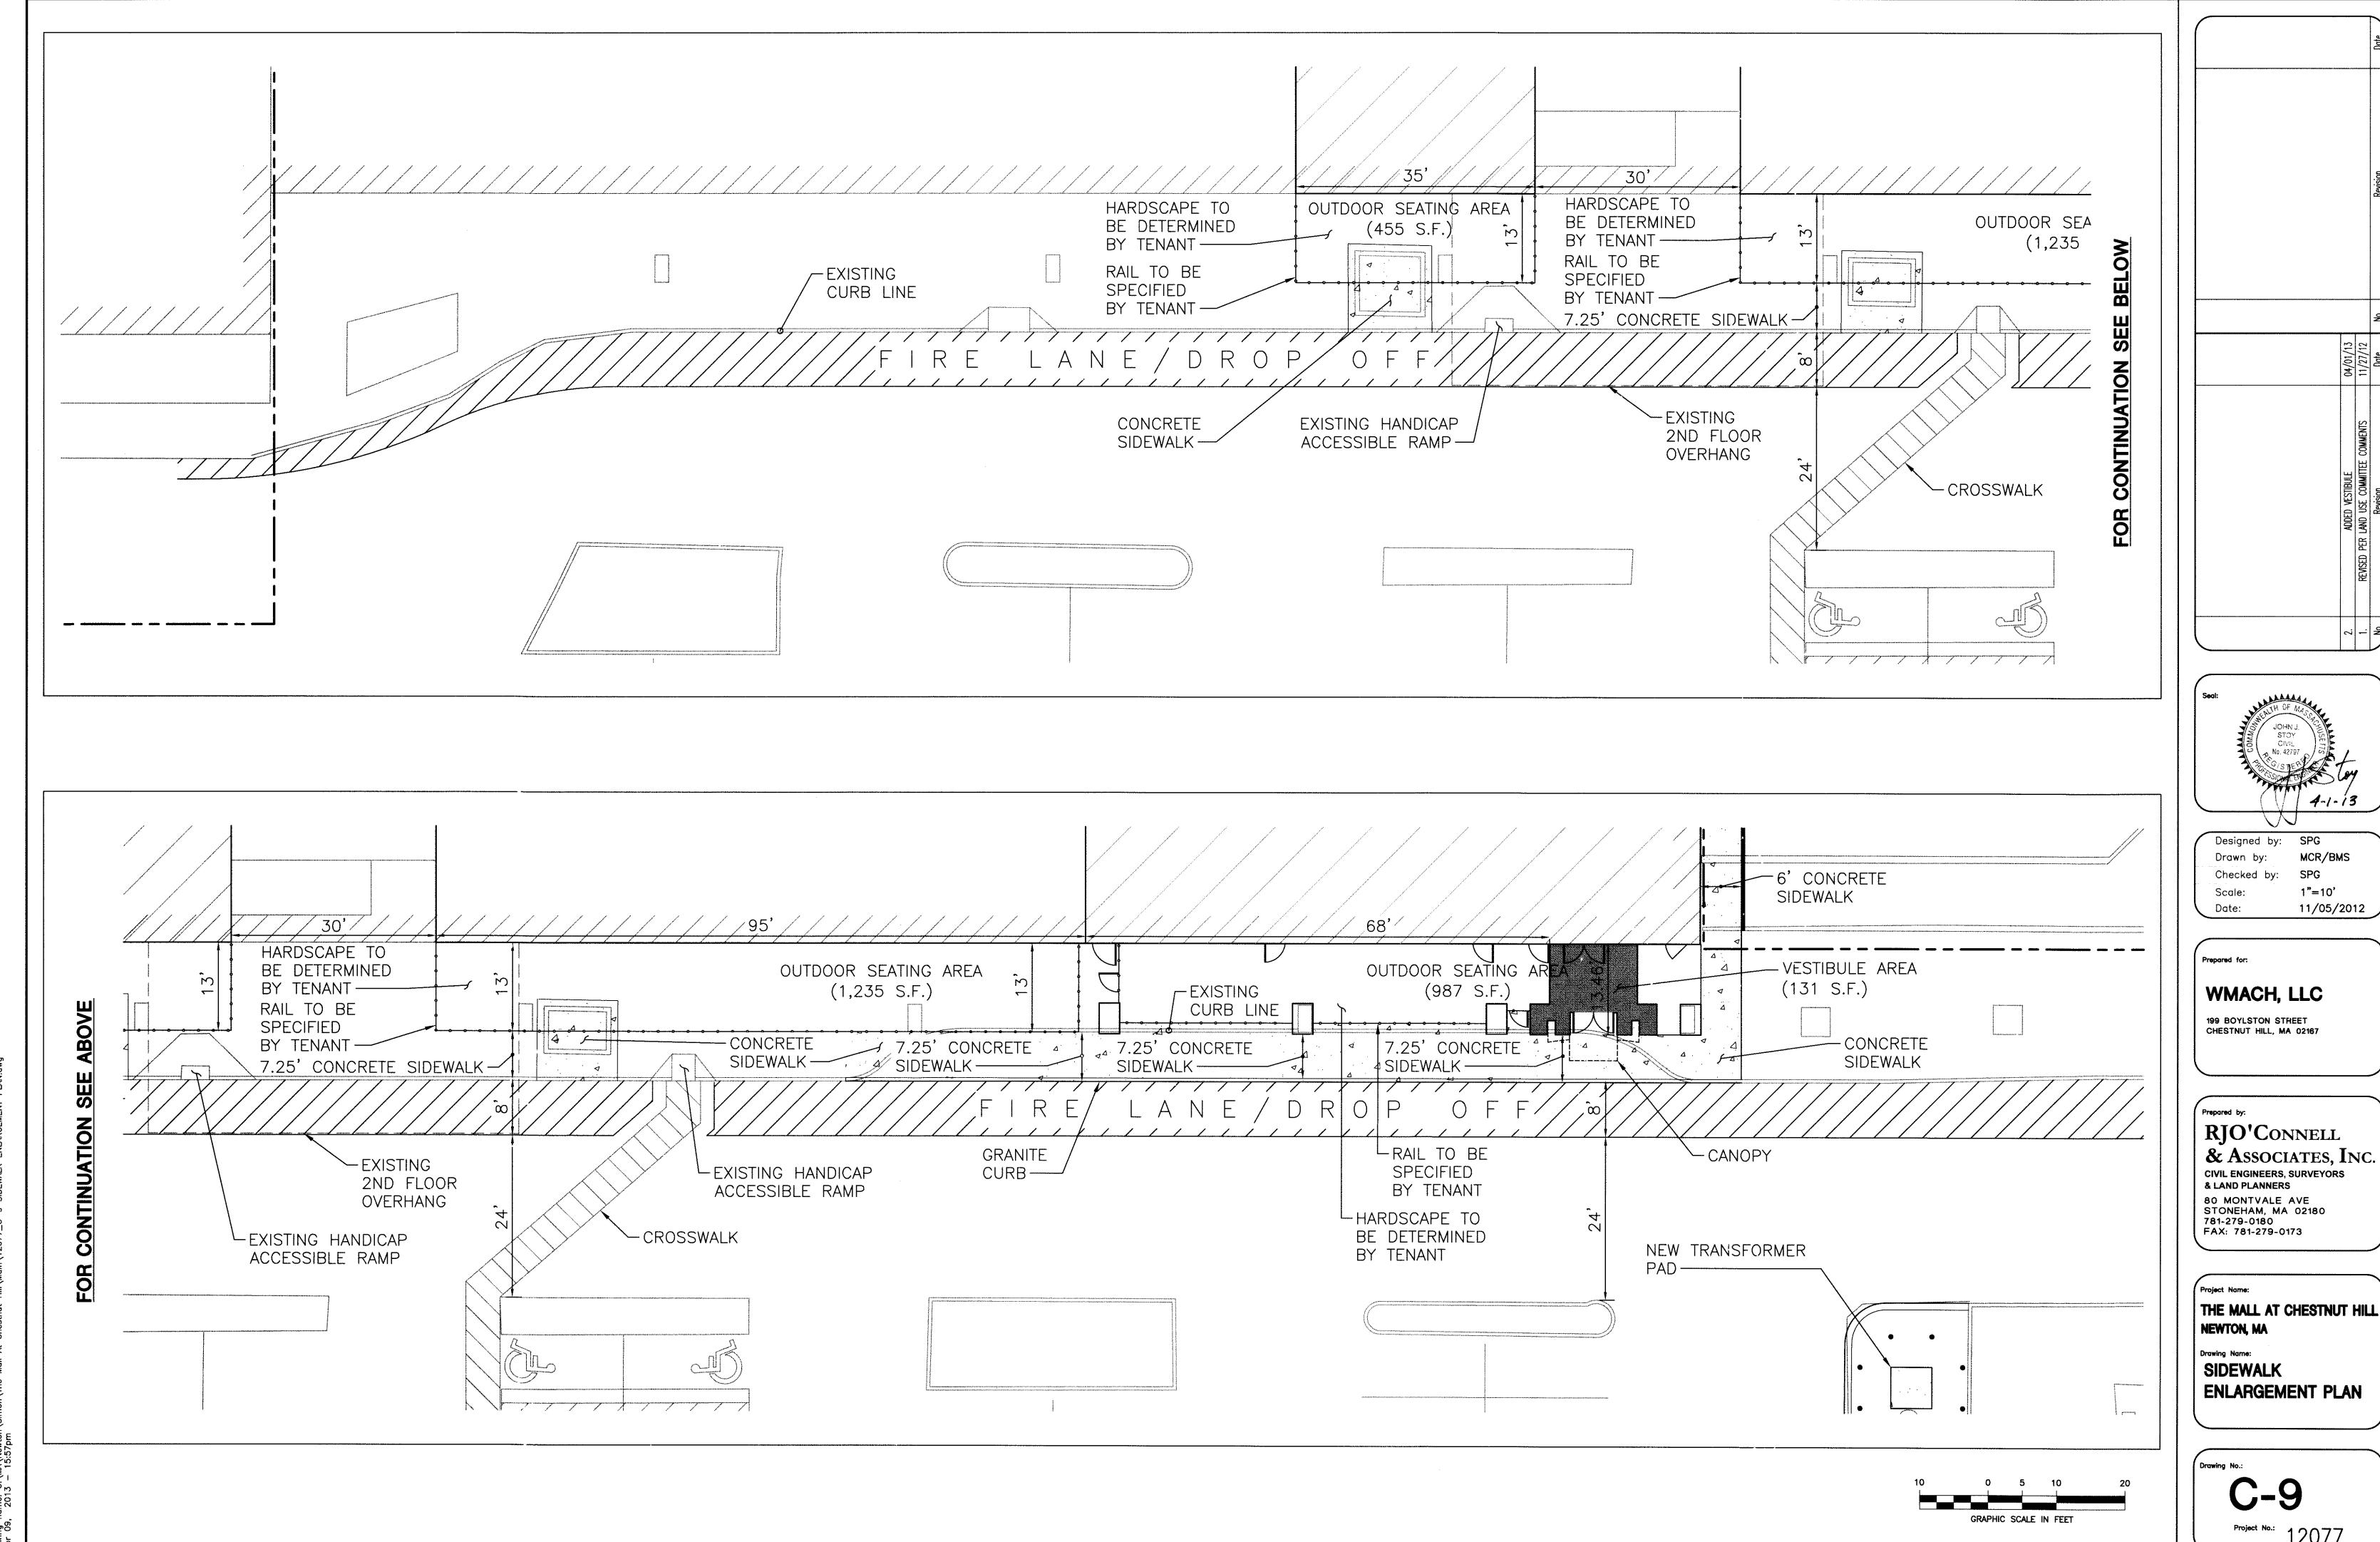

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Drawing name: G:\MA\Newton\Simon\The Mall At Chestnut Hill\Main\12077\_C-9 SIDEWALK ENLARGEMENT PLAN.c



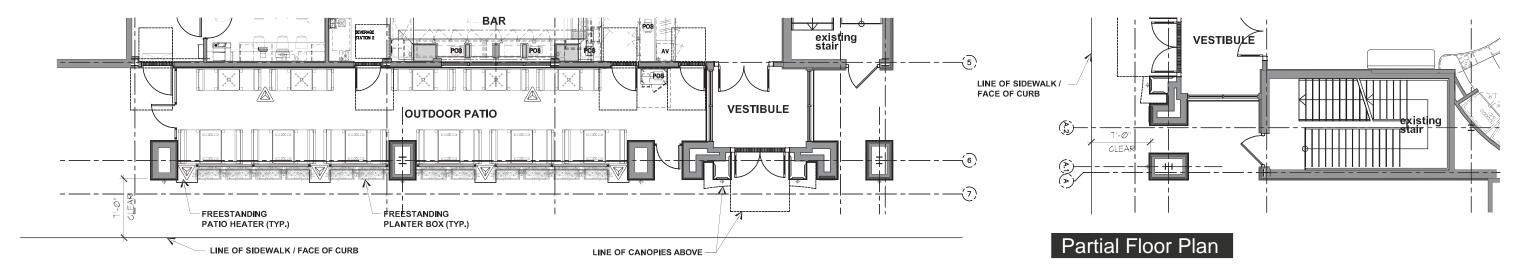

PROJECT DATA:

AREA:

Outdoor Patio Area: 987 s.f.
Vestibule Area: 131 s.f.

RESTAURANT SEATING:

Indoor Patio:28 seatsOutdoor Patio:36 seatsRestaurant:193 seatsTOTAL257 seats

RESTAURANT EMPLOYEES:

At Highest Shift: 4


1. Front - South Elevation

2. Side - East Elevation

### **PRELIMINARY ELEVATIONS**

March 29, 2013




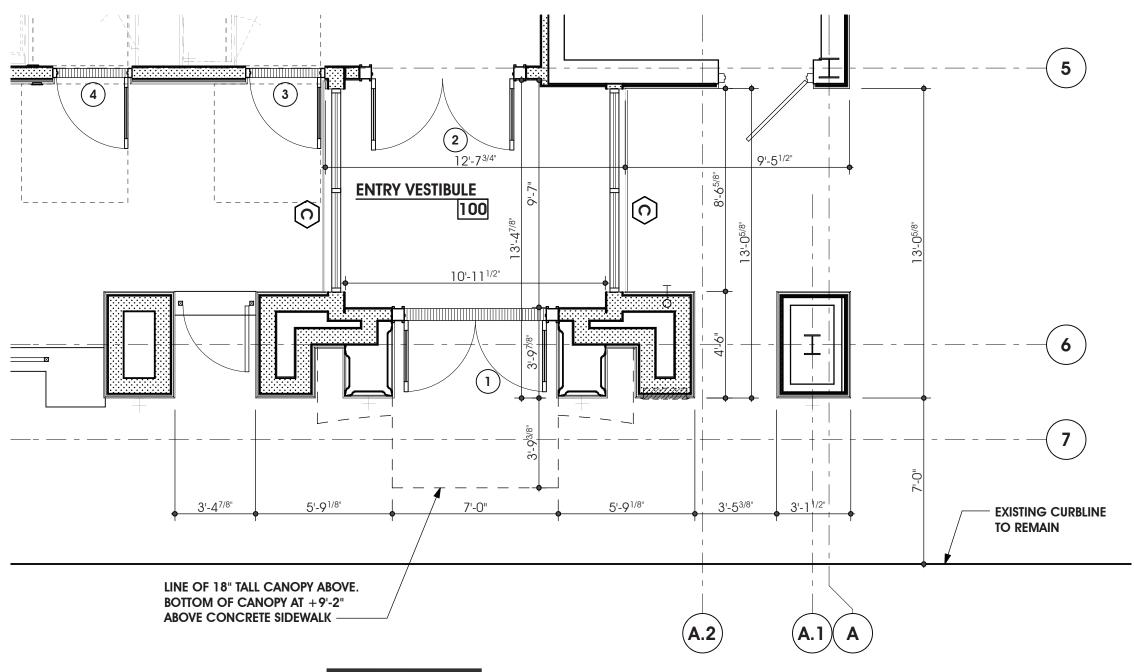


Vestibule Plan

### Enlarged Vestibule Plan March 29, 2013



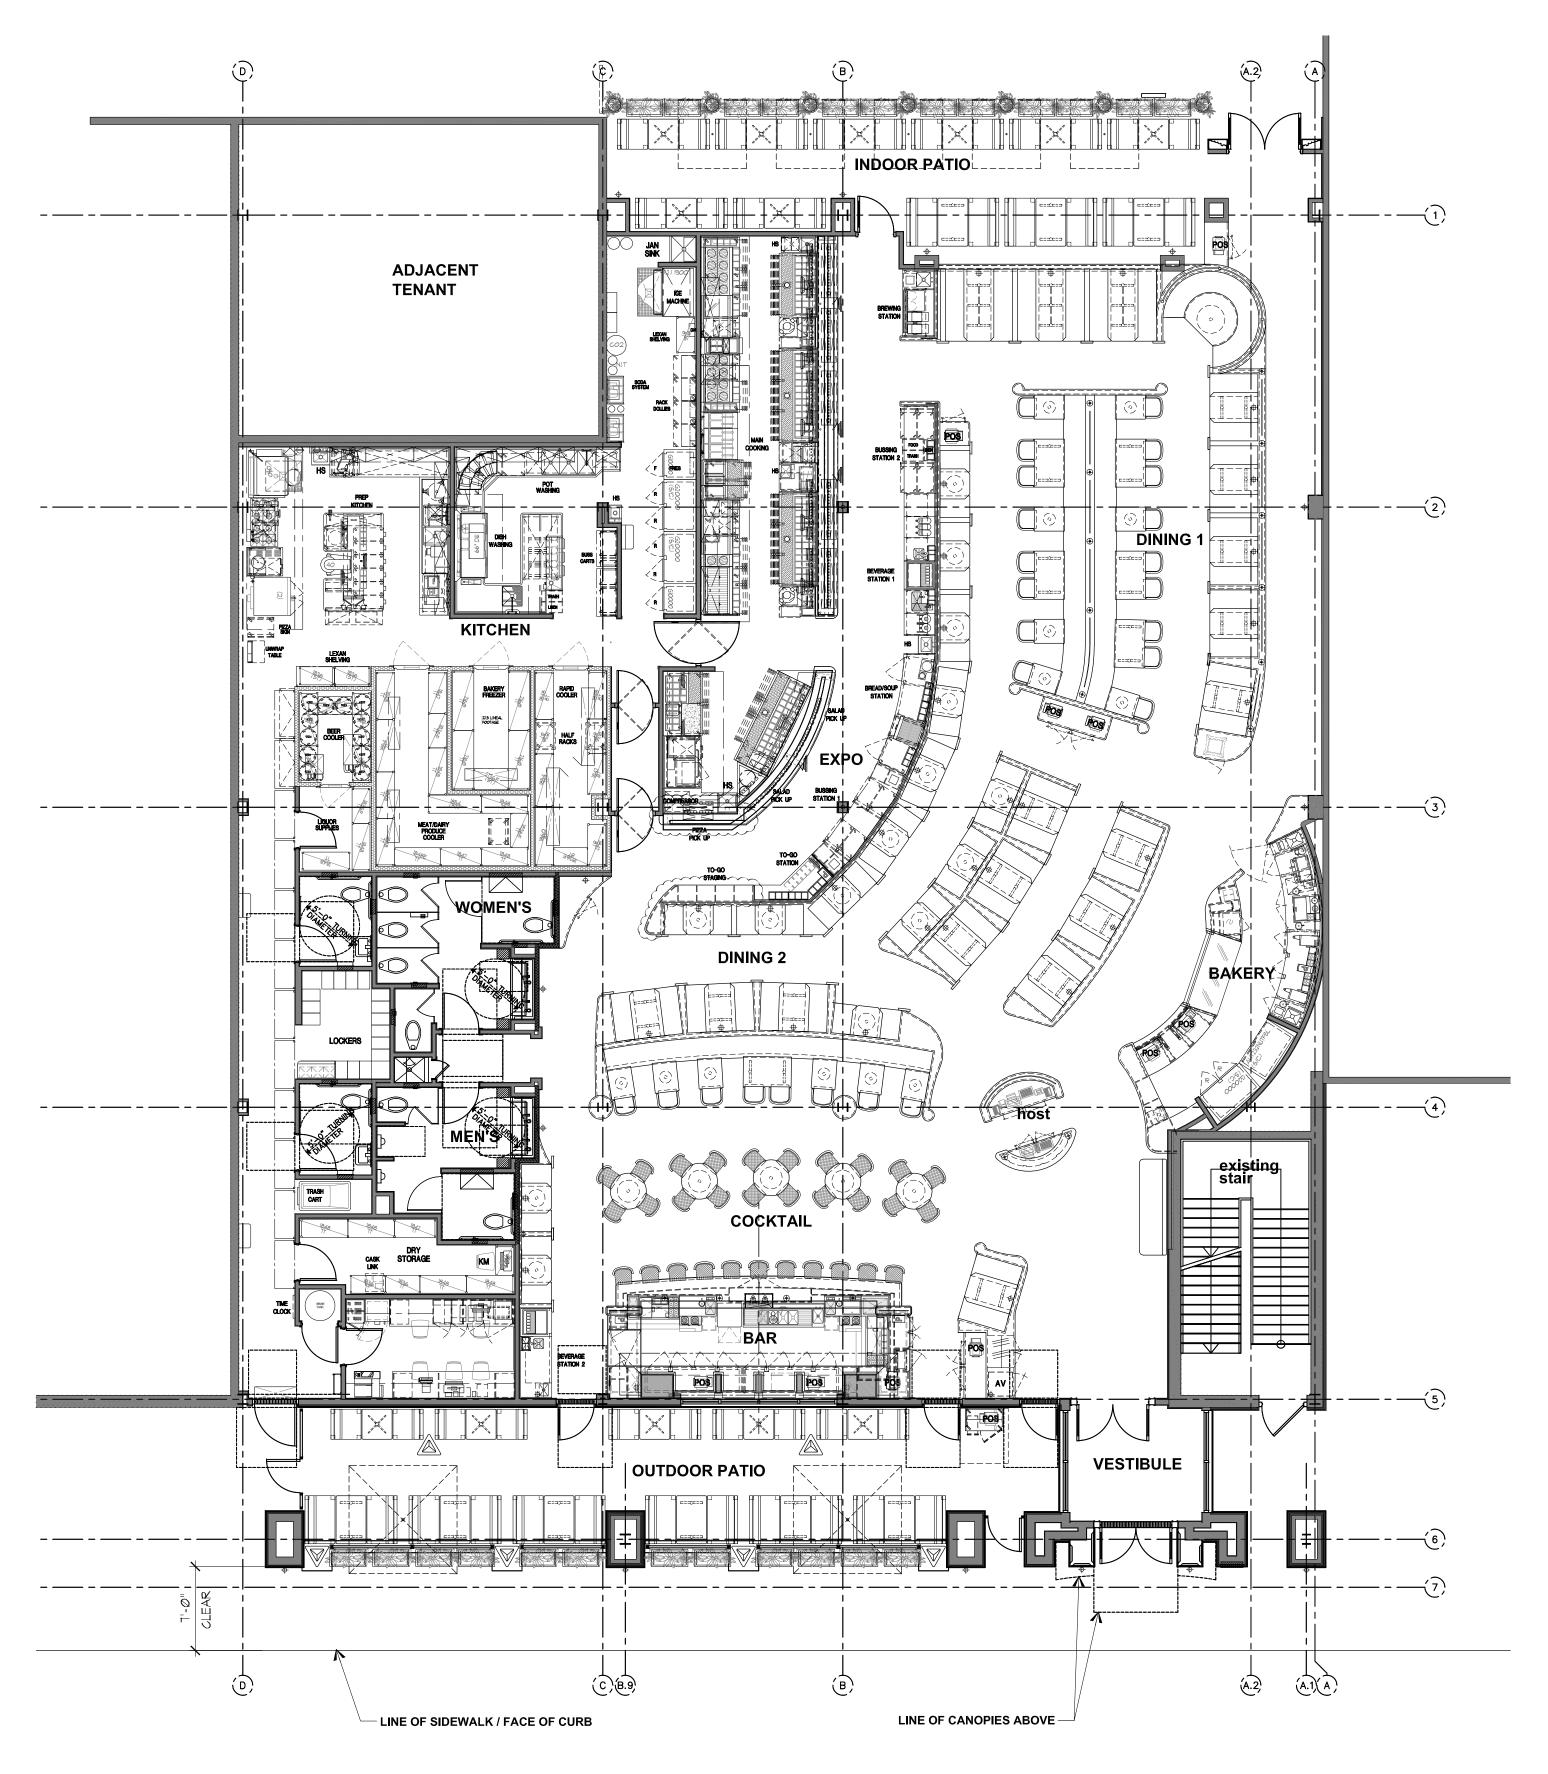


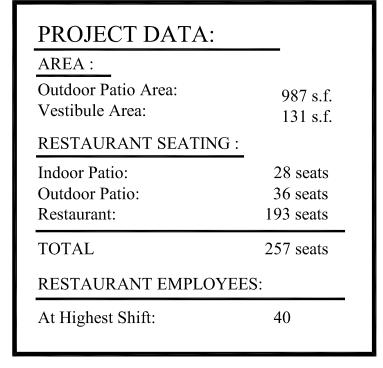



March 29, 2013

# PRELIMINARY FLOOR PLAN Scale: 1/8" = 1'-0"

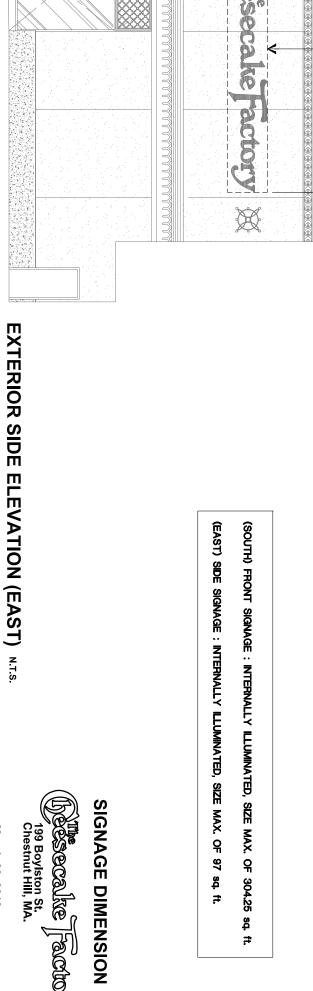


X

**SIGN C** 97 sq. †t. (ACTUAL)

24'-4"

# EXTERIOR FRONT ELEVATION (SOUTH)

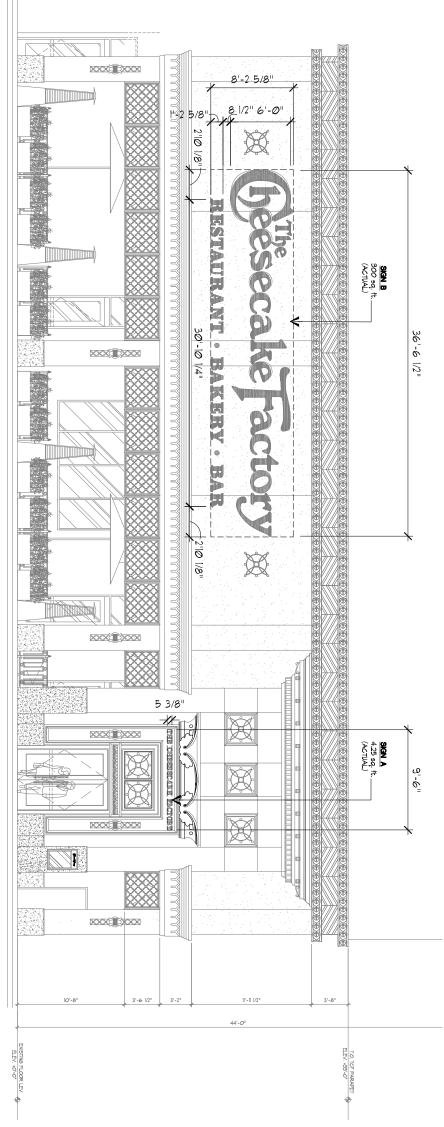

The especative Factory

199 Boylston St.
Chestnut Hill, MA.



MANUFACTURE & INSTALL 1 SET OF INTERNALLY ILLUMINATED CHANNEL LETTERS / SIGN TYPE CL72RBB / 300 SQ.FT.

SCALE: 3/16" = 1'-0"

FACES: 2793 RED PLEX.

RETURNS: 5" DEEP, PRE-FINISHED GLOSS BLACK ALUMINUM W/ MATCHING TRIMCAP.

INTERNAL ILLUMINATION: RED L.E.D. UNITS POWERED BY REMOTE 12 VOLT POWER SUPPLIES.

MOUNTING: LETTERS TO BE FLUSH MOUNTED TO FASCIA.

20V-20 AMP CIRCUIT ELECTRICAL PRIMARY TO WITHIN 5' OF SIGN LOCATION NUMBER OF CIRCUITS PER SIGN TO BE PER FEDERAL HEATH SIGN REQUIREMENTS

ALL (ELECTRICAL) SIGNS SHALL CONFORM TO THE REQUIREMENTS OF ARTICLE 600 OF THE N.E.C. AND U.L. 48 ALONG WITH OTHER APPLICABLE STATE & LOCAL CODE REQUIREMENTS. THIS INCLUDES PROPER GROUNDING AND BONDING OF THE SIGN.

### **ELECTRICAL REQUIREMENTS**

Total: T.B.D. Amps

# of 120V, 20A Circuits Reg'd T.B.D.

ALL BRANCH CIRCUITS SHALL BE DEDICATED TO SIGNS (INCLUDING GROUND AND NEUTRAL) AND SHALL NOT BE SHARED WITH OTHER LOADS.

ADEQUATE BEHIND THE WALL BACKING AND ACCESS IS REQUIRED FOR THE INSTALLATION OF NEW SIGNAGE. CUSTOMER TO FORWARD APPROVED SIGNAGE DRAWINGS TO THE ON SITE CONTACT TO INSURE THAT THE REQUIRED PROVISIONS ARE MADE DURING CONSTRUCTION. PRIOR TO THE SIGN INSTALLATION

**NEW & REMODEL CONSTRUCTION** 

### **NSTALLER REQUIREMENTS FOR FIFS WALL**

IT IS THE RESPONSIBILITY OF THE INSTALLATION CONTRACTOR TO PROVIDE ANY WALL SPACERS REQUIRED TO KEEP EIFS WALL MATERIAL FROM BEING COMPACTED DURING INSTALLATION OF ANY MOUNTING BOLTS REQUIRED FOR SIGNAGE.

INSTALLER SHALL VERIFY WALL CONDITION IN THE FIELD. TYPE, SIZE AND NUMBER OF FASTENERS TO BE DETERMINED •ALL BOLT HOLES TO BE DRILLED OR PUNCHED.
•ISOLATE ALL ALUMINUM FROM STEEL.

### **CUSTOMER TO PROVIDE DEDICATED BRANCH CIRCUITS FOR SIGNS ONLY PER NEC CODE 600.5**

ALL BRANCH CIRCUITS SHALL BE DEDICATED TO SIGNS (INCLUDING GROUND AND NEUTRAL) AND SHALL NOT BE SHARED WITH OTHER LOADS. PROPERLY SIZED GROUND WIRE THAT CAN BE TRACED BACK TO BREAKER PANEL IS REQUIRED.

### **INSTALLER REQUIREMENTS**

ALL MOUNTING HARDWARE, SECONDARY WIRING AND CONDUITS ARE TO BE PROVIDED BY THE INSTALLATION CONTRACTOR. ALL PENETRATIONS IN THE WALL ARE TO BE SEALED WITH SILICONE AND TO BE WATERTIGHT.

ANY DEVIATION FROM FEDERAL HEATH REQUIREMENTS MAY RESULT IN DAMAGE TO OR IMPROPER OPERATION OF SIGNAGE, CAUSING DELAYS AND ADDITIONAL COSTS.

## 24'-4 1/8" Perimeter = 166,29ft cake



MANUFACTURE & INSTALL 1 SET OF INTERNALLY ILLUMINATED CHANNEL LETTERS / SIGN TYPE CL48 / 97 SQ.FT.

Revisions

FACES: 2793 RED PLEX.

RETURNS: 5" DEEP, PRE-FINISHED GLOSS BLACK ALUMINUM W/ MATCHING TRIMCAP. INTERNAL ILLUMINATION: RED L.E.D. UNITS POWERED BY REMOTE 12 VOLT POWER SUPPLIES.

MOUNTING: LETTERS TO BE FLUSH MOUNTED TO FASCIA.

SCALE: 1/4" = 1'-0"

SIGN COMPANY www.FederalHeath.com

4602 North Avenue Oceanside, CA 92056 (760) 941-0715 Fax (760) 631-5065

Manufacturing Facilities Oceanside, CA - Euless, TX - Jacksonville, TX - Delaware, OH Office Locations Oceanside, CA - Las Vegas, NV - Laughlin, AZ Idaho Falls, ID - Euless, TX - Jacksonville, TX - San Antonio, TX Houston, TX - Corpus Christi, TX - Indianapolis, IN Willowbrook, IL - Tunica, MS - Atlanta, GA

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| Colors Depicted In This Rendering May Not Match Actual Finished Material | s. Refer To Product Samples For Exact Color Match. |
|--|--|
| Client Approval/Date:  |  |
| Landlord Approval/Date:  |  |

Account Rep: House - Key Account

Project Manager: Sandra Ramirez

Drawn By:

Underwriters Laboratories Inc.

Underwriters COMPONENTS AND SHALL MEET ALL N.E.C. STANDARDS ALL ELECTRICAL SIGNS ARE TO COMPLY WITH U.L. 48 AND ARTICLE 600 OF THE N.E.C. STANDARDS, INCLUDING THE PROPER GROUNDING AND RONDING OF ALL SIGNS.

C. Adachi

Project / Location:

NOTE: VERIFY ACTUAL WALL CONDITIONS

1" PVC Pipe (By Sign Installer) during Pre-Wire

NEMA 3R or UL listed for wet location

hèesecake factory

199 Boylston Street Chestnut Hill, MA 02467


23-17466-10 Job Number:

March 27, 2013 Sheet Number:

Design Number: **23-17466-10** 

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(Bare) METAL STUD

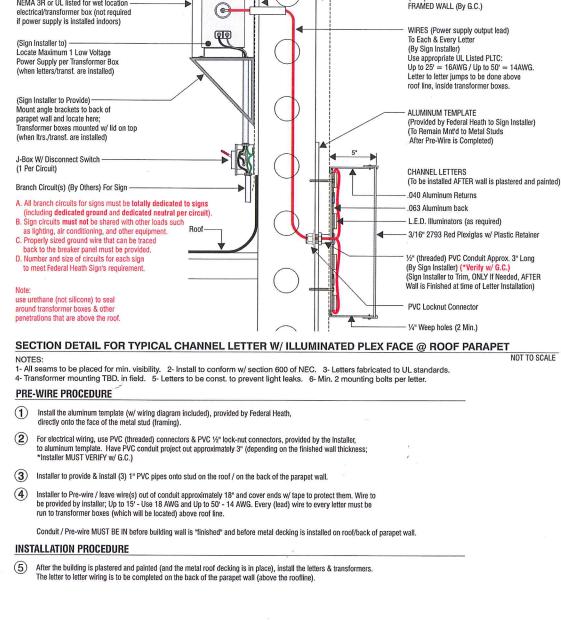

# THE CHEESECAKE FACTORY



### FABRICATE & INSTALL 1 SET OF INTERNALLY ILLUMINATED PUSH THROUGH LETTERS / SIGN TYPE PT.75 / 4.25 SQ.FT.

SCALE: 1" = 1'-0"


GENERAL CONTRACTOR TO PROVIDE & INSTALL LIGHTING BEHIND SIGN PANEL.

PUSH THROUGH COPY TO BE 3/4" THICK, CLEAR ACRYLIC WITH 2500-73 DARK RED VINYL APPLIED TO FACE.

COPY IS TO BE BACKED UP WITH WHITE PLEX (SEPARATE PIECES FOR EACH LETTER).

LETTERS TO BE PUSHED THROUGH ROUTED OUT FIBERGLASS FASCIA. FEDERAL SIGN TO PRODUCE ROUTING TEMPLATE & ROUT OUT OPENINGS IN FIBERGLASS FASCIA TO ACCEPT PUSH THROUGH LETTERS. THIS IS TO BE DONE IN DMI'S SHOP IN SANTA ANA. FEDERAL SIGN IS TO INSTALL PUSH-THROUGH LETTERS IN DMI'S SHOP AT THIS TIME AS WELL.

LETTERS TO BE ATTACHED TO FASCIA W/ PL POLYURETHANE PREMIUM CONSTRUCTION ADHESIVE.

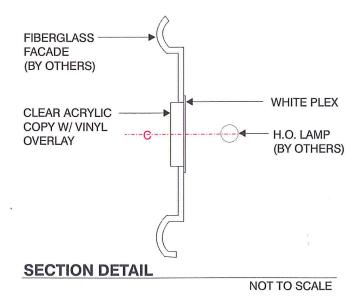



www.FederalHeath.com 4602 North Avenue Oceanside, CA 92056 (760) 941-0715 Fax (760) 631-5065

| oceanside, CA - Euless, IX - Jacksonville, IX - Delaware, OH    |  |
|---|--|
| Office Locations:   |  |
| Oceanside, CA - Las Vegas, NV - Laughlin, AZ                    |  |
| aho Falls, ID - Euless, TX - Jacksonville, TX - San Antonio, TX |  |
| Houston, TX - Corpus Christi, TX - Indianapolis, IN             |  |
| Louisville, KY - Knoxville, TN - Grafton, WI - Delaware, OH     |  |

| Oceanside, CA - Euless, TX - Jacksonville, TX - Delaware, OH  |  |
|---|--|
| Office Locations:<br>Oceanside, CA - Las Vegas, NV - Laughlin, AZ<br>Idaho Falls, ID - Euless, TX - Jacksonville, TX - San Antonio, TX  |  |
| Houston, TX - Corpus Christi, TX - Indianapolis, IN<br>Louisville, KY - Knoxville, TN - Grafton, WI - Delaware, OH<br>Willowbrook, IL - Tunica, MS - Atlanta, GA<br>Tampa, FL - Daytona Beach, FL - Orlando, FL | Colors Depicted In This Rendering May Not Match Actual Finished Materials. Refer To Product Samples For Exact Color Match  Client Approval/Date: |
| Building Quality Signage Since 1901   | Landlord Approval/Date:  |

| -  | Account Rep:              | House - Key Account  |
|----|---------------------------|--|
| -  | Project Manage            | r: Sandra Ramirez  |
|    | Drawn By:                 | C. Adachi  |
| 1. | Underwrite<br>Laboratorie | rs   FELECTRICAL TO USE U.L. LISTED COMPONENTS AND SHALL MEET ALL N.E.C. STANDARDS                           |
|    | ARTICLE 600 OF            | SIGNS ARE TO COMPLY WITH U.L. 48 AND<br>THE N.E.C. STANDARDS, INCLUDING<br>DUNDING AND BONDING OF ALL SIGNS. |


Project / Location:


199 Boylston Street Chestnut Hill, MA 02467


Job Number: **23-17466-10** March 27, 2013 3 of 7

Design Number: **23-17466-10** 

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Designed by: SPG
Drawn by: BMS
Checked by: SPG
Scale: 1"=80'
Date: 08/09/2012

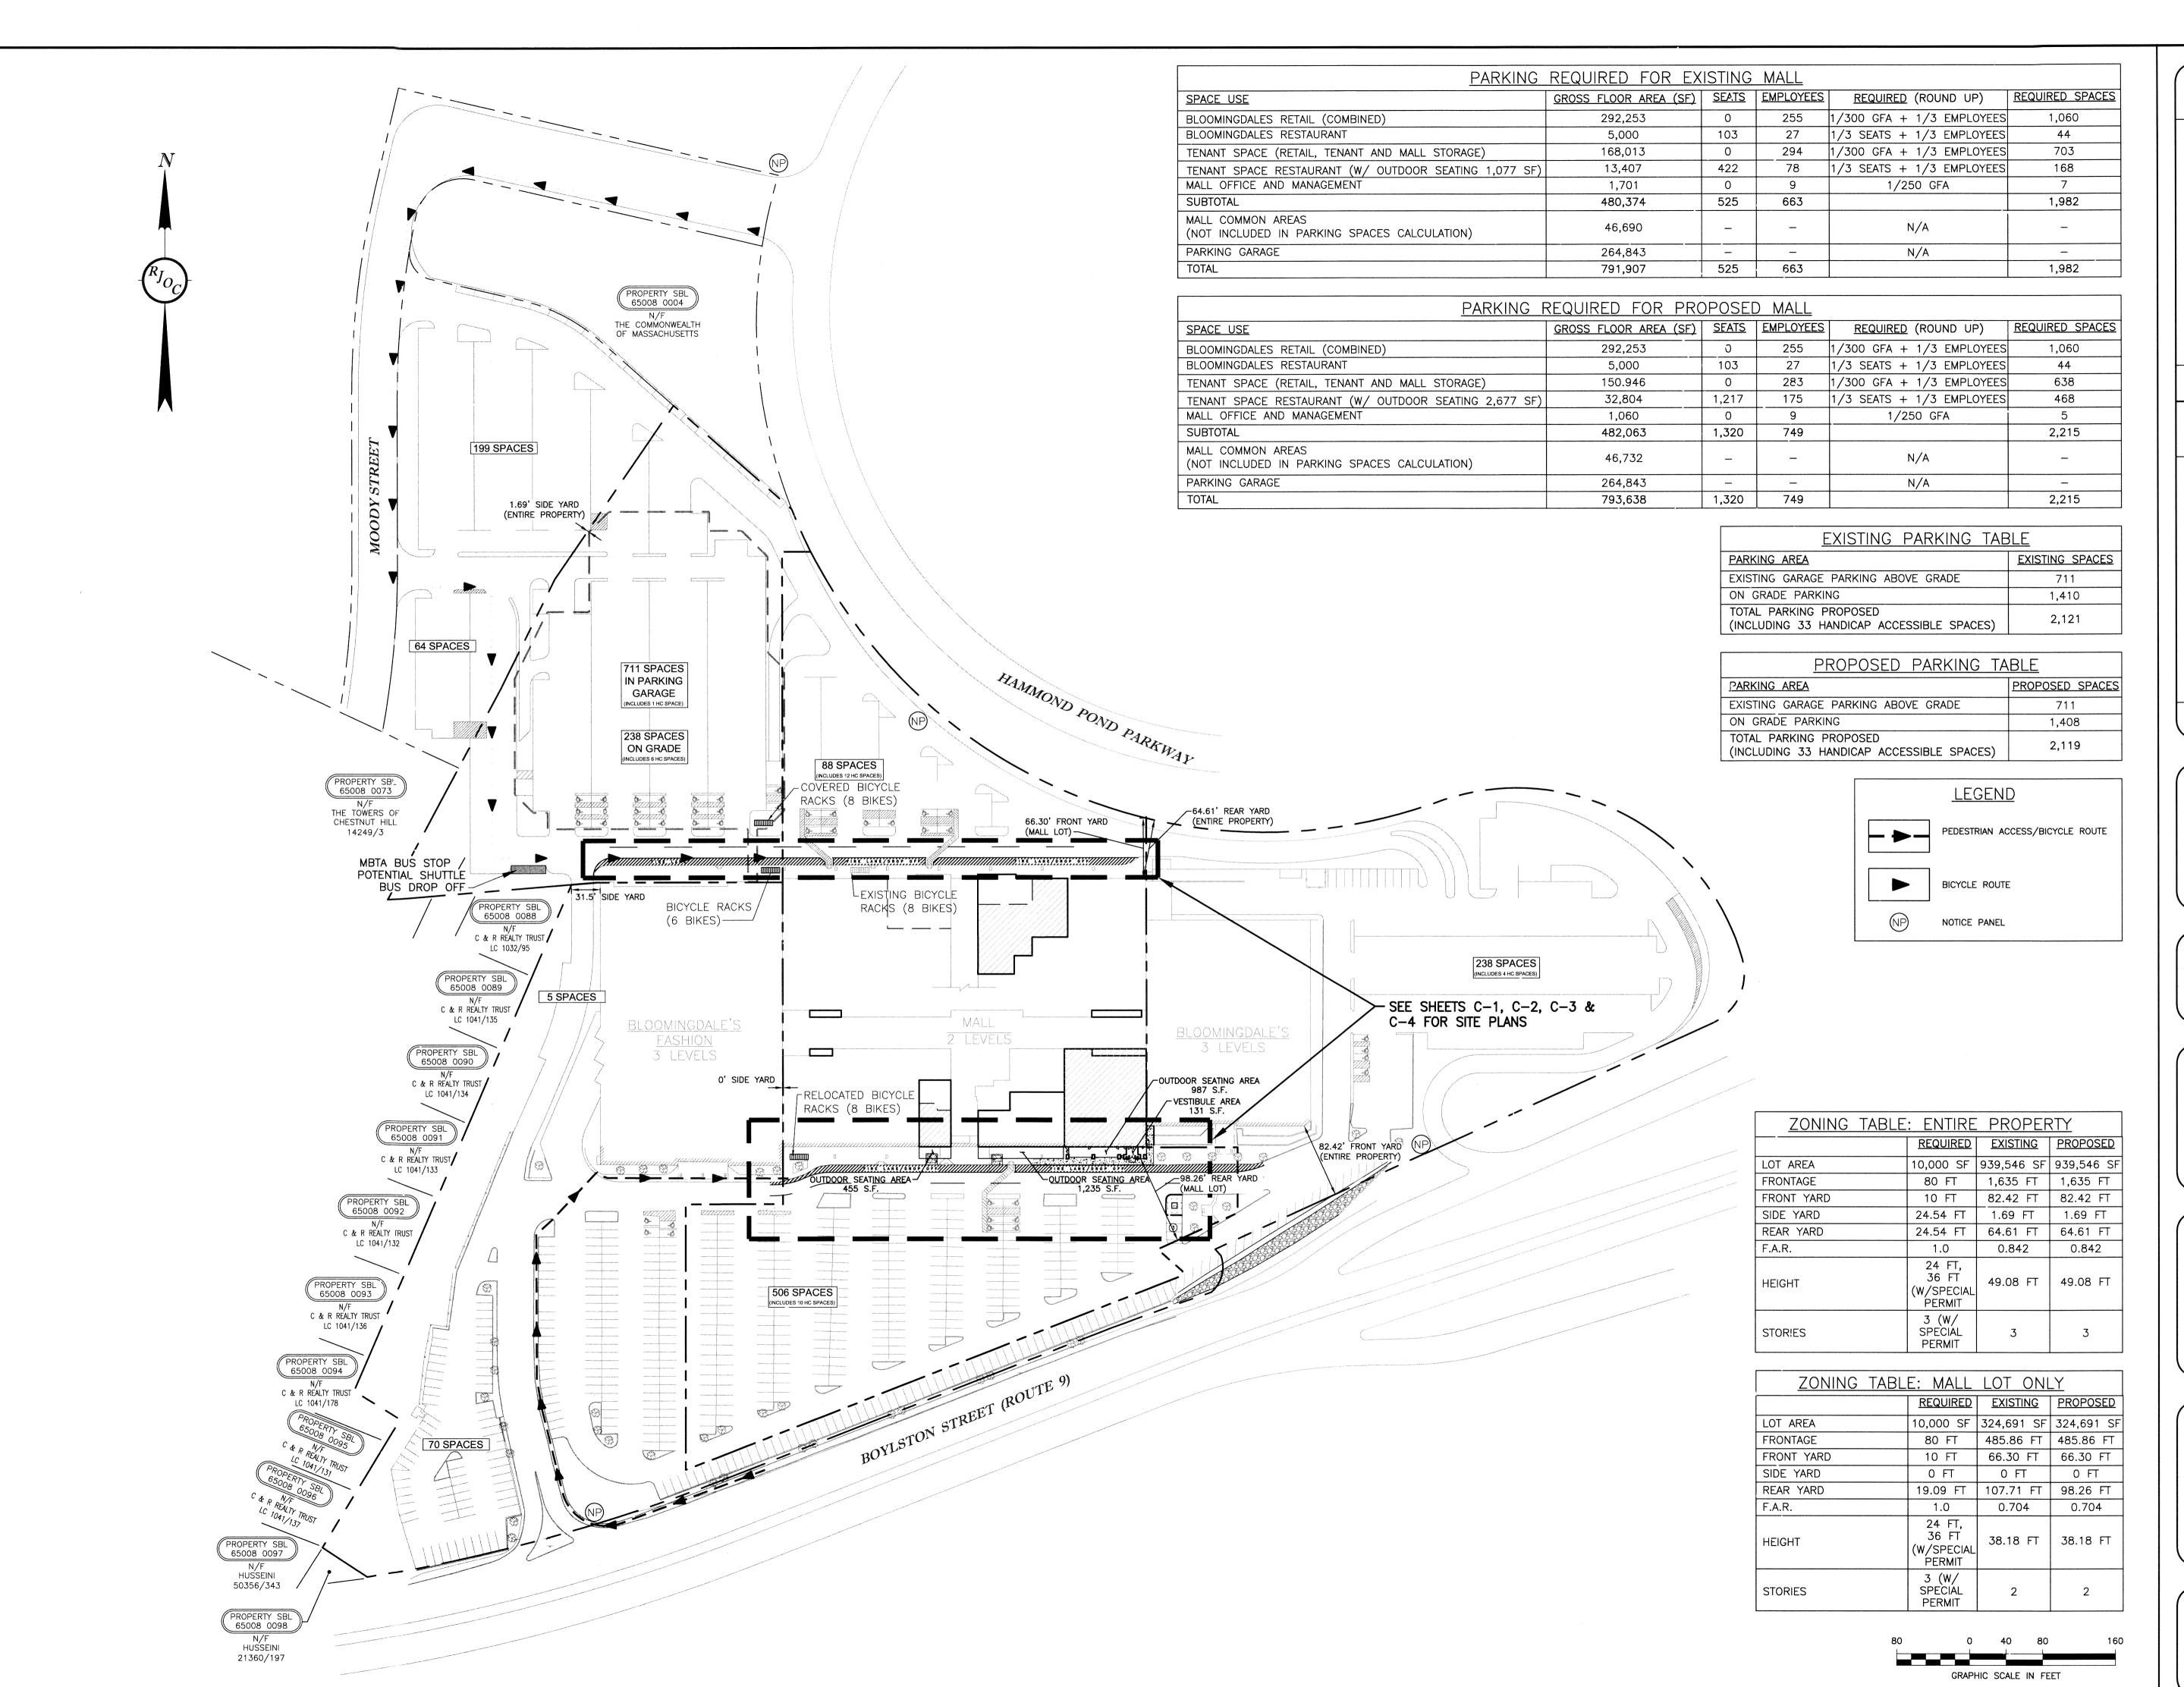Prepared for:

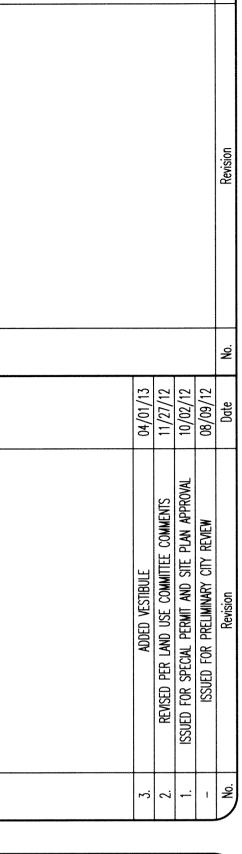WMACH, LLC

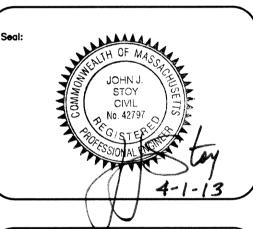199 BOYLSTON STREET CHESTNUT HILL, MA 02167

RJO'CONNELL

& ASSOCIATES, INC.
CIVIL ENGINEERS, SURVEYORS
& LAND PLANNERS

80 MONTVALE AVE
STONEHAM, MA 02180
781-279-0180
FAX: 781-279-0173

Project Name:

THE MALL AT CHESTNUT HILL NEWTON, MA

Drawing Name:

**OVERALL SITE PLAN** 

OSP-1
Project No.: 12077

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