INSULATION 2015 STRETCH CODE GUIDELINES

Code Checklist for Designers - Stretch Code
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© Lighting

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equipment sized using a oversize (ECC 2005 403 6, IRC 1401.3

SEE LATEST VTP ASSOCIATES SURVEY PLAN 386-390 WATERTOWN STREET, NEWTON, MA 02458

LEGEND Minimum Miscellaneous APPROX BD BLDG Not in Contrac EXISTING WALLS/CONSTRUCTION Building CLC Ceiling NEW WALLS CLR COL CONC CONSTR Column Plaster PI P10 NEW Pointed Construction REC Required CONT Continuous EXISTING RO SIM SST STD Rough Opening Corpet Similar Stainless Steel CT CTR DE I Standard BUILDING SECTION STL DIA DISP Diameter Storage SUSP IAG IHK IYP VCB Dispenser Suspended DN DWG ELEC longue & Groove Thick DETAIL SECTION Drawing Liectric(Liectrical) Typical Vinyl Cove Base ΓQ ETR PARTHION TYPE Existing to Remain VPB Veneer Plaster Base EXIST Water closet Finish Floor # NEW DOOR & DOOR NUMBER Gypsum Wall Board **#** Weight WINDOW NUMBER Handicapped HDP High Density Polymer Height Insulation(Insulated) INTERIOR ELEVATION INSUL Maximum Mechanical MAY MECH **LEGEND ABBREVIATIONS**



PARK VIEW BUILDING

386-390 WATERTOWN STREET, NEWTON, MA 02458

LIST OF DRAWINGS

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- A-1a GENERAL NOTES & SPEC.

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- A-8 ELEVATOR & STAIR PLANS

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- A 11 CROSS SECTIONS

- A-12 DETAIL SHEET A-13 EXTERIOR PERSPECTIVES

LA-1 LANDSCAPE PLAN

Architect: Ronald F. Jarek

487 Watertown Street Newtonville, MA 02460 (617) 818-4540





STREET 386-390 WATERTOWN NEWTON, MA 02458

PARK VIEW BUILDING 386-390 WATERTOWN S NEWTON, MA 02458

Architect Ronald F. Jarek, Ard 487 Watertown Street Newtonville, MA 02460

05/08/17 SCALE: CHECKED BY:

GENERAL REQUIREMENTS:

- 1. All work shall comply with Federal, State and Local Codes and Ordinances and shall be done to the highest standards of
- 2. Samples shall be supplied to the Architect of all materials proposed for substitution of specified materials and of workmanship
- 3. Temporary facilities for protection of tools and equipment shall conform to local regulations and shall be the contractor's responsibility
- 4. The contractor shall present the building to the owner for acceptance, clean and ready for occupancy. All glass shall be cleaned and polished, floors swept clean, carpets vacuumed, fixtures washed, with all labels removed and exterior hand raked free of trash and
- Winter protection: Heat and snow removal shall be the contractor's responsibility. All space heating shall be done in a safe, sensible manner, with periodic checks on the systems and shall comply with State Industrial Commission and OSHA regulations.
- The contractor shall carry Builder's Risk "All Risks" Insurance to cover the cost of this work. The Architect shall be presented with certificates of contractor's insurance and Owner's fire extended coverage at the time of signing of the contract.
- 7. Rental charges, safety, protection and maintenance of rented equipment shall be the contractor's responsibility
- 8. Contractor shall maintain the job clear of trash and debris. All waste material shall be removed from site prior to substantial completion and prior to final acceptance.
- 9. Cost for Building Permits, taxes, sales tax and other charges relative to construction of this project shall be included in the contract
- 10. These documents do not include the necessary components for construction safety. Safety, care of adjacent properties during construction, compliance with state and federal regulations regarding safety shall be the Contractor's response
- 11. Contractor shall visit the site and become familiar with all conditions prior to submitting his proposal. Contractor shall verify all dimensions and conditions shown on these drawings with those at the site. Any variation which requires physical change shall be brought to the attention of the Architect.
- 12. All materials and workmanship shall be guaranteed for one year after completion and move-in. Any defects shall be promptly
- 13. No liability shall result from delay in performance or nonperformance caused by circumstances beyond the Owner's control including, but not limited to, Acts of God, fire, flood, war, government action (Local, State and Federal), accident, labor trouble, or shortage, inability to obtain material, equipment or transportation. Materials so affected may be eliminated from the contract without liability providing that suitable replacements are procured and mutually agreed upon.
- 14. The contractor shall provide and maintain temporary electric and telephone at the site during construction at his expense.
- 15. It is intended by the representations on the drawings and in the specifications that the work will be performed exactly as shown and specified. Should field conditions encountered in the course of the work require modifications to dimensions or relationships of parts of materials from what is shown or specified, the contractor at no additional cost to the Owner, and with express consent of the Architect in each case, shall make such modifications to the work as may be necessary to complete the work in accordance with the intent of the Contract Documents and prior to the fabrication and/or installation of the work or any piece thereof, report to the Architect in writing all discrepancies between the existing conditions and the Contract Documents which would require any modification as given above.
- 16. Shelter and Protection of Materials: Provide adequate storage facilities for materials and equipment as required for the work. The facilities shall be enclosed, heated and provided with moisture control, as required, to provide adequate protection.
- 17. Temporary Dust proof Partitions: Temporary dust proof partitions, where required, shall be erected before demolition work or wrecking is started and shall be removed at completion of entire work or when directed by Owner
- 18. Contractor is hereby required to take all precautions and so schedule the work as to minimum discomfort, annoyance and interference in the routine daily operations in and around the building by the Owner and such other contractors who may be engaged to
- 19. Dust Control: Thoroughly wet down all work being demolished and all trucking ways as necessary to prevent spreading dust. Provide
- 20. Protection of Property: Protect existing buildings and grounds, public streets, sidewalks and existing utilities. If damage is done to these areas, the contractor shall make all repairs to same at no additional expe
- 21. Prior to construction, the Owner shall review and approve a list of Sub-Contractors that the General Contractor will employ during the construction process. If the Owner disapproves of any Sub-contractor, the General Contractor will provide an approved alternate to complete that part of work.
- 22. Refer to General Requirements for additional information as part of the contract documents

NOTE - DIMENSION

ALL DIMENSIONS ARE APPROXIMATE. CONTRACTOR MUST VERIFY ALL EXISTING DIMENSIONS AND PREPARE A LAYOUT DRAWING WITH ALL EXISTING CONDITION PRIOR TO PROCEEDING WITH ANY NEW WORK.

PRODUCTS
SEE ATTACHED 'ON THE DRAWING SHEET A-1a" SPEC FOR PRODUCTS AND/OR FINISHES

®⊕@

=SMOKE HEAT OR C.O. DECTORS

General Notes:

- 1. All dimensions are to the outside face of STUD partition unless otherwise noted.
- 2. Written dimensions supersede scaled drawings.
- 3. Align new GWB. partitions with existing partitions as shown. Patch and plaster to appear smooth and contiguous to existing wall without cracks, flaws or imperfections. Prepare new or repaired surfaces to receive new finishes. See finish schedule, notes and/or
- 4. Paint all columns as required for smooth surface.
- 5. Paint new surfaces and contiguous existing surfaces as required to maintain a uniform color and surface appearance.
- 6. Paint for drywall or VPB shall consist of a first coat of alkyd primer and two coats of alkyd eggshell finish paint. Painted wood shell consist of a first coat of alkyd primer sealer, a second coat of enamel undercoater and a third coat of alkyd semigloss enamel. Ferrous metal shall be shop primed if new with a first coat of enamel undercoater and a second coat of alkyd eggshell enamel. See finish schedule on drawings, elevations and door schedule for manufacture specification. Apply additional coats where undercoats, stains or other conditions show through final paint coat. (SEE PAINTING SPECIFICATION THIS SHEET FOR ADDITIONAL
- 7. Provide blocking as required for shelving, toilet accessories and cabinets.
- 8. All work shall comply with all state and local codes, including the Commonwealth of Massachusetts Building Codes OSHA and NFPA Regulations and City Ordinances.
- 9. The Contractor shall notify Architect of any discrepancies between drawings, specifications and field conditions or dimensions
- 10. The contractor shall furnish field progress schedules of all phases of work to the Architect and shall coordinate the work with the
- 11. The Contractor shall provide the Architect with cut sheets of all fixtures and equipment, fabrication shop drawings for all custom built items and samples of all finishes, prior to installation. The Contractor shall secure the Architects approval on any material substitutions or changes to work.
- 12. The Contractor shall remove all rubbish and waste accumulated on site from work by Sub Contractors and employees
- 13. All Insurance, Building Permits, Stamps and Certificates of Occupancy connected with this work shall be secured and paid for by the
- 14. The contractor shall prevent the spread of dust and debris outside the construction area and shall take precautions to secure the construction area so as to prevent injury to persons and property. All work shown on drawings shall be by the General Contractor unless noted otherwise by others or abbreviated N.I.C. (NOT IN CONTRACT).
- 15. The Contractor shall field verify all existing conditions, dimensions and coordination of all new work as shown prior to beginning work. The General Contractor shall report all discrepancies to the Architect and await their direction before proceeding with the work

GENERAL NOTES STRUCTURAL

- 1. ALL WORK SHALL COMPLY WITH THE STATE OF MASSACHUSETTS BUILDING CODE, REQUIREMENTS OF THE CITY OF
- NEWTON, AND ALL OTHER LOCAL, STATE AND FEDERAL STANDARDS AND REGULATIONS.

 2. DO NOT SCALE THIS DRAWING. REFER TO ARCHITECTURAL DRAWINGS FOR DIMENSIONS, LIMITS AND LOCATIONS REGARDING LAYOUT OF ALL STRUCTURAL FRAMING MEMBERS AND COMPONENTS. REFER TO ARCH. DWGS. FOR ALL

- ELEVATIONS.

 3. THE STRUCTURAL DRAWINGS SHALL BE USED IN CONJUNCTION WITH THE ARCHITECTURAL, and DESIGN BUILD MECHANICAL AND ELECTRICAL AND PLUMBING DRAWINGS AND THESE DRAWINGS SHALL BE REFEREED TO FOR SIZE AND LOCATION OF APPURITENANCES.

 4. DIMENSIONS SHOWN ON THE DRAWINGS MUST BE COORDINATED WITH ARCHITECTURAL DRAWINGS PRIOR TO DETAILING, FABRICATION AND ERECTION OF ALL STRUCTURAL MEMBERS.

 5. EXISTING LAYOUT, ITEMS AND CONDITIONS MAY DIFFER FROM AS SHOWN. ALL EXISTING CONDITIONS AND DIMENSIONS MUST BE VERIFIED IN FIELD PRIOR TO COMMENCING THE WORK. ANY DISCREPANCIES FOUND SHALL BE BROUGHT TO THE ATTENTION OF THE OWNER BEFORE PROCEEDING WITH THE AFFECTED PART OF THE WORK.

 6. IT IS THE BUILDER'S RESPONSIBILITY TO VERIFY ALL DIMENSIONS AND EXISTING CONDITIONS AT THE SITE PRIOR TO BIDDING. FAILURE TO SO EXAMINE THE SITE AND THE CONTRACT DOCUMENTS WILL NOT RELIEVE THE BUILDER FROM ANY OBLIGATION UNDER THE BID AS SUBMITTED. ANY OBLIGATION UNDER THE BID AS SUBMITTED
- ANY OBLIGATION UNDER THE BID AS SUBMITTED.

 7. FABRICATIOR FOR EACH STRUCTURAL TRADE SHALL PREPARE SHOP DRAWINGS SHOWING LOCATION, LIMITS, DIMENSIONS AND EXTENT OF ALL MEMBERS, CONNECTIONS AND DETAILS TO BE SUBMITTED FOR APPROVAL. NO ERECTION SHALL BE PERFORMED WITHOUT THE APPROVAL OF SHOP DRAWINGS.

 8. THE CONTRACTOR SHALL TAKE ADEQUATE PRECAUTIONS AT ALL TIMES TO PROTECT ADJOINING PROPERTY FROM DAMAGE. ALL ABUTTING WORK SHALL BE RESTORED TO PRESENT CONDITION.
- 9. CONTRACTOR SHALL SUBMIT SHOP DRAWINGS FOR ALL ITEMS FOR APPROVAL

SQUARE FEET CALCULATION

AREA	380-396 WATERTOWN STREET		TOTAL S.F. ALLOWED @	TOTAL S.F.
	BUSINESS (GROUND FLOOR)	RESIDENTIAL (LEVELS 2 & 3)	1.5 FAR = 14,313sf	PROVIDED 14,204sf
BASEMENT				
PARKING	SURFACE 4 SPACES	SURFACE 12 SPACES		
FIRST FLOOR	2,716 SF.	****		
SECOND FLOOR	***	5,895 SF.		
THIRD FLOOR		5,595 SF.		
TOTAL SQ. FT.	2,714 SF.	11,490 SF.	14,313 SF.	14,204 SF.



NOTES,


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STREET

STREET PARK VIEW BUILDING 386-390 WATERTOWN (NEWTON, MA 02458 vner: JLM REALTY 6-390 WATERTOWN (WTON, MA 02458 Own 386-

> Architect Street 02460 Ronald F. Jarek, 1 487 Watertown Street Newtonville, MA 0246 ш.

SCALE: CHECKED BY



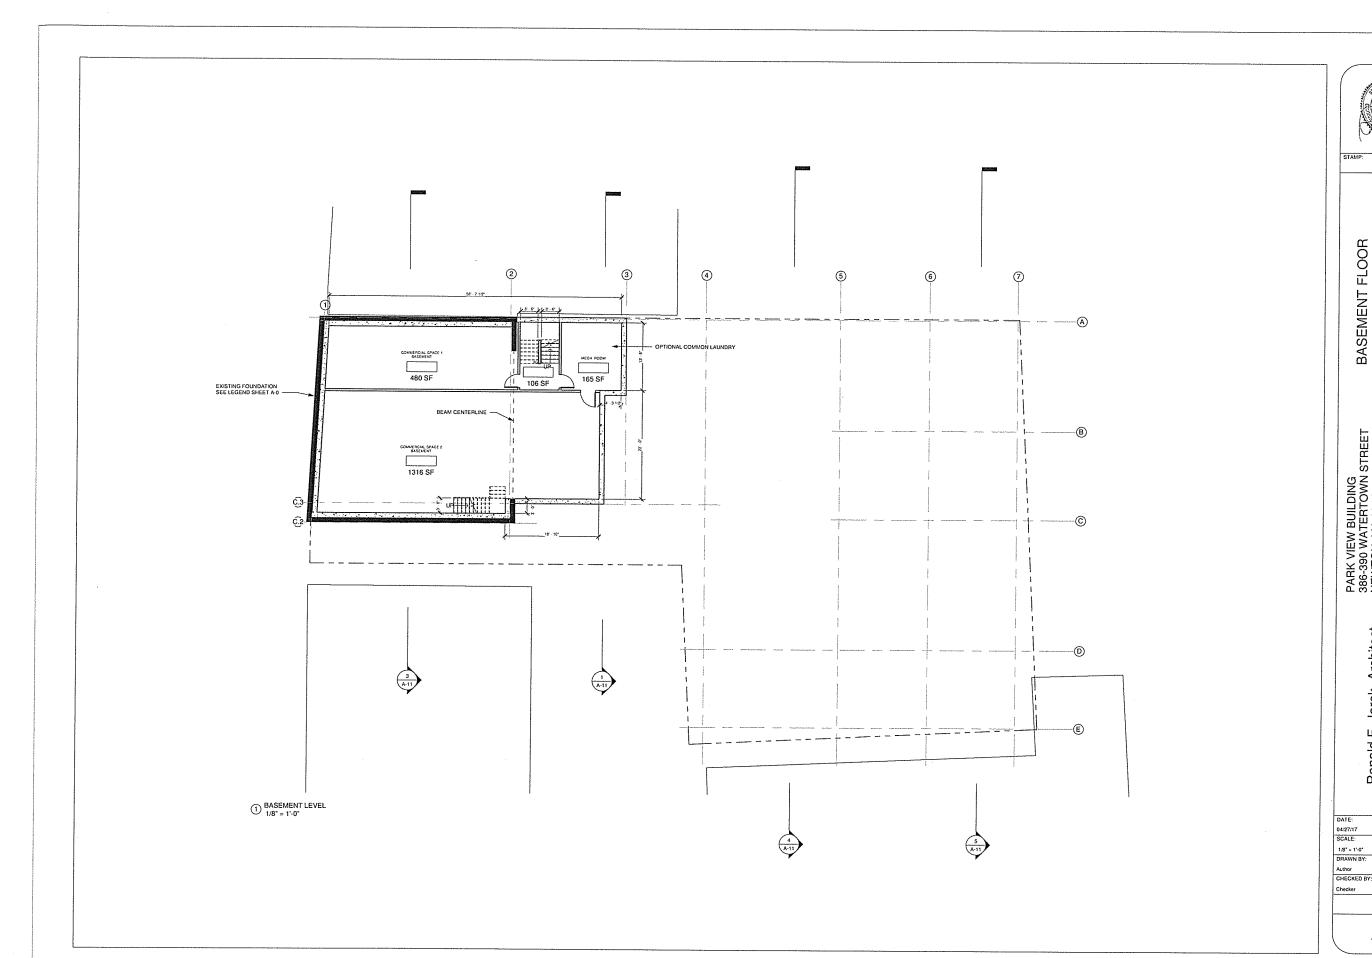


BASEMENT FLOOR


386-390 WATERTOWN STREET NEWTON, MA 02458

Ronald F. Jarek, Architect 487 Watertown Street Newtonville, MA 02460

A-2

PARK VIEW BUILDING 386-390 WATERTOWN STREET NEWTON, MA 02458 Owner: JLM REALTY 386-390 WATERTOWN STREET NEWTON, MA 02458

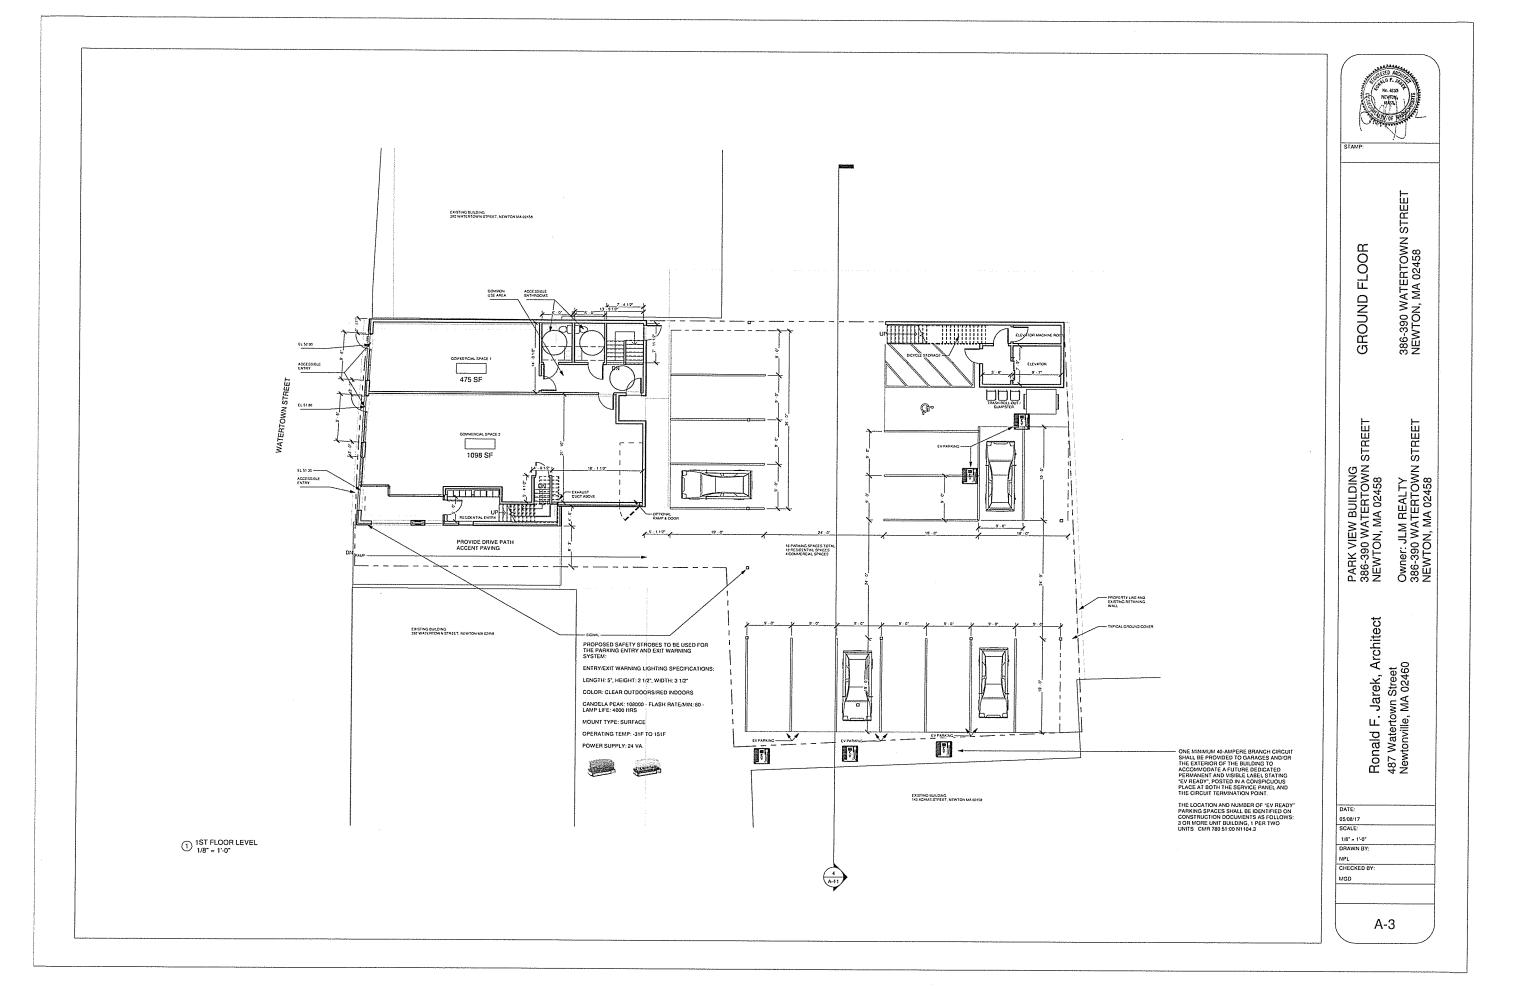

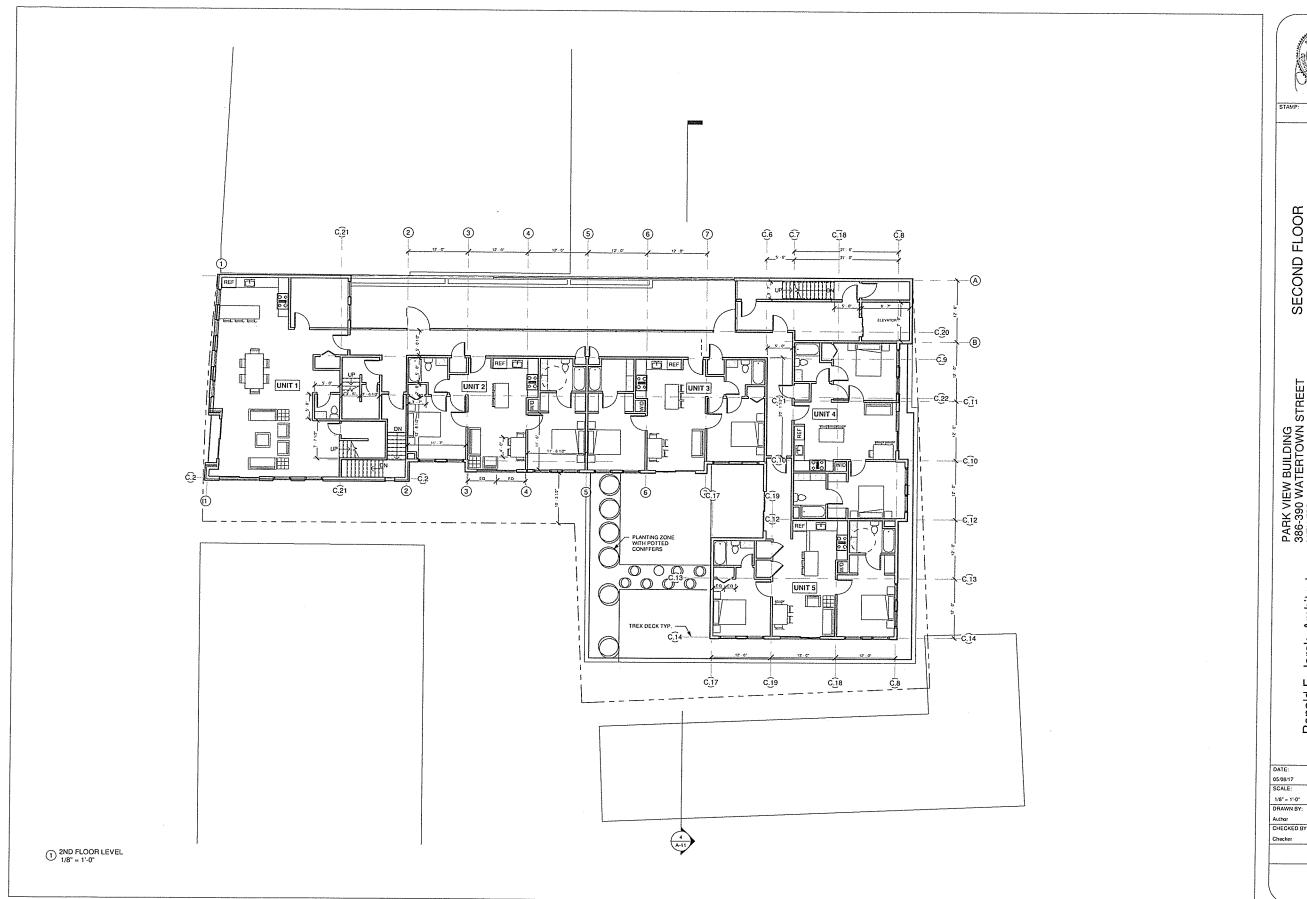




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A-4

SECOND FLOOR

386-390 WATERTOWN STREET NEWTON, MA 02458



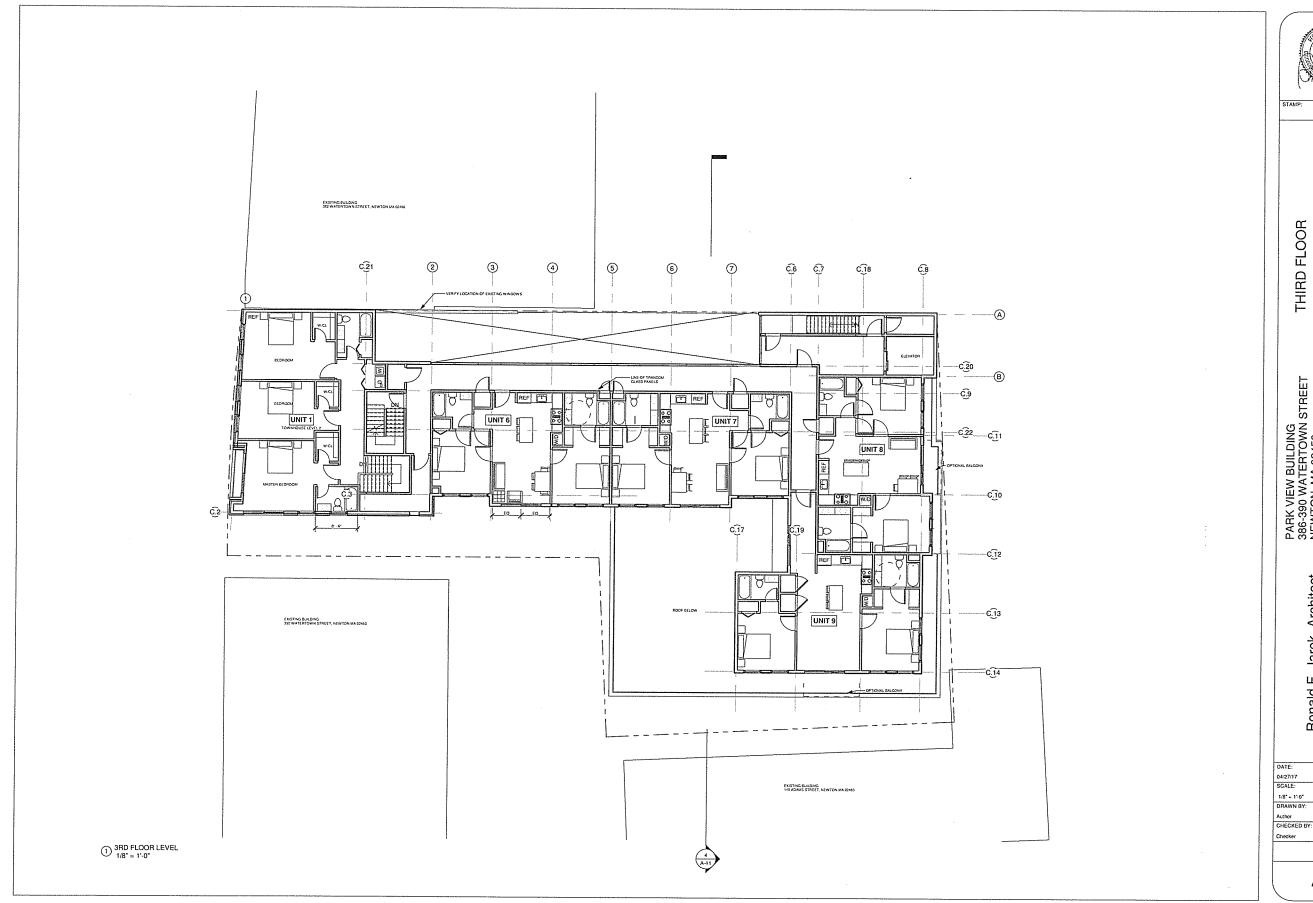

THIRD FLOOR


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386-390 WATERTOWN STREET NEWTON, MA 02458

Ronald F. Jarek, Architect 487 Watertown Street Newtonville, MA 02460

A-5

1/8" = 1":0" DRAWN BY:



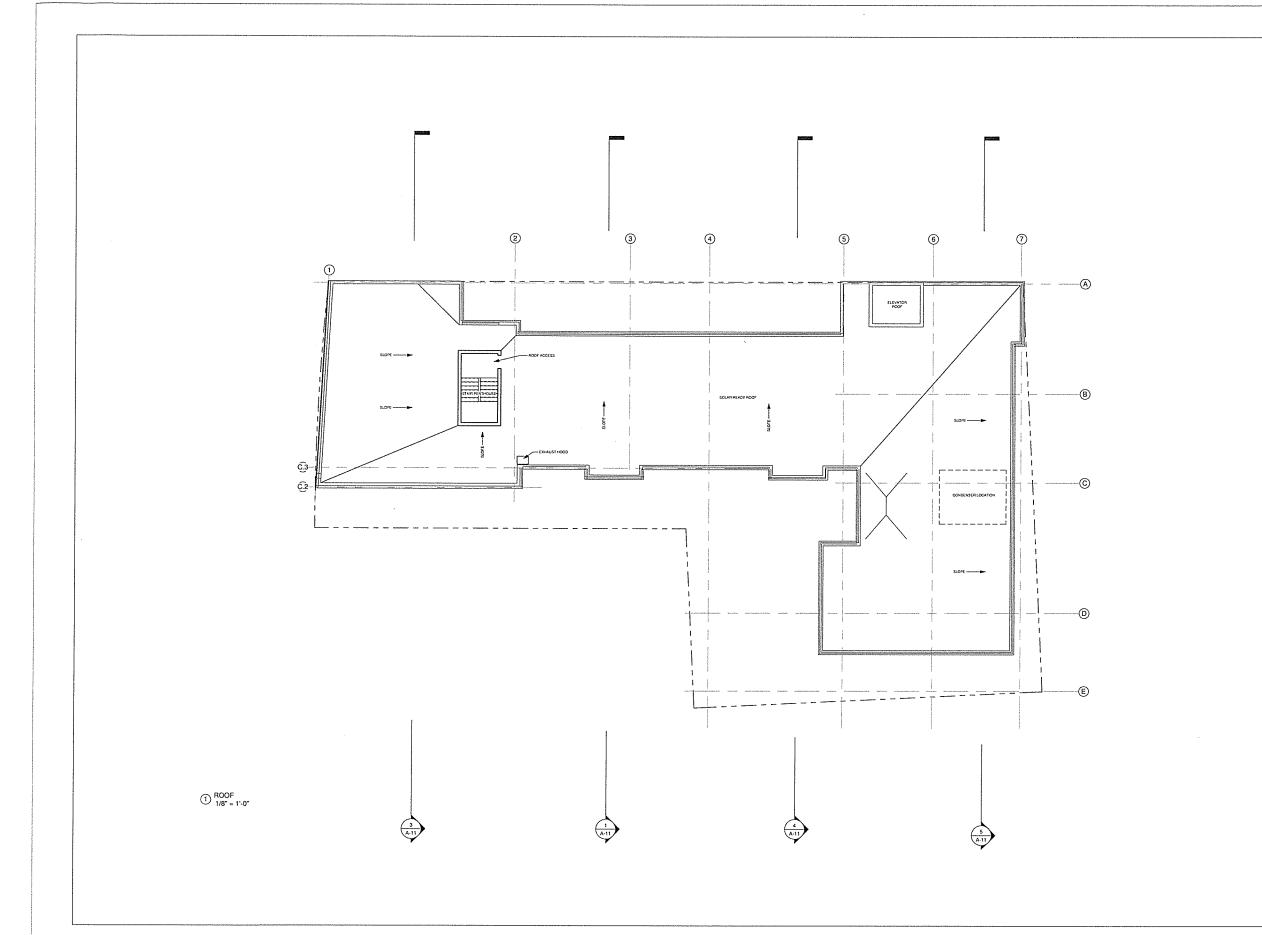

ROOF PLAN

386-390 WATERTOWN STREET NEWTON, MA 02458

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Ronald F. Jarek, Architect 487 Watertown Street Newtonville, MA 02460 DATE: 04/27/17 SCALE: 1/8" = 1'-0" DRAWN BY: Author CHECKED BY:



CC.22 C.9 BC.20

T.O. TOWER 87' - 6"

T.O. ROOF <u>COPING</u> 84' - 6"

3RD FLOOR 74' - 0"

2ND FLOOR 64' - 0"

1ST FLOOR LEVEL 52' - 0"

A

C.C.232.10

C.12

C.14


2 A-10 - 1/8 Rear Elevation 1/8" = 1'-0"

C.13

Ronald F. Jarek, Architect 487 Watertown Street Newtonville, MA 02460

PARK VIEW BUILDING 386-390 WATERTOWN S NEWTON, MA 02458

Owner: JLM REAL 386-390 WATERT NEWTON, MA 024

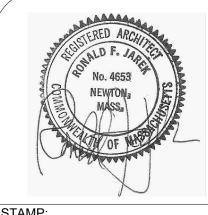

A-9

DATE: 04/27/17 SCALE:


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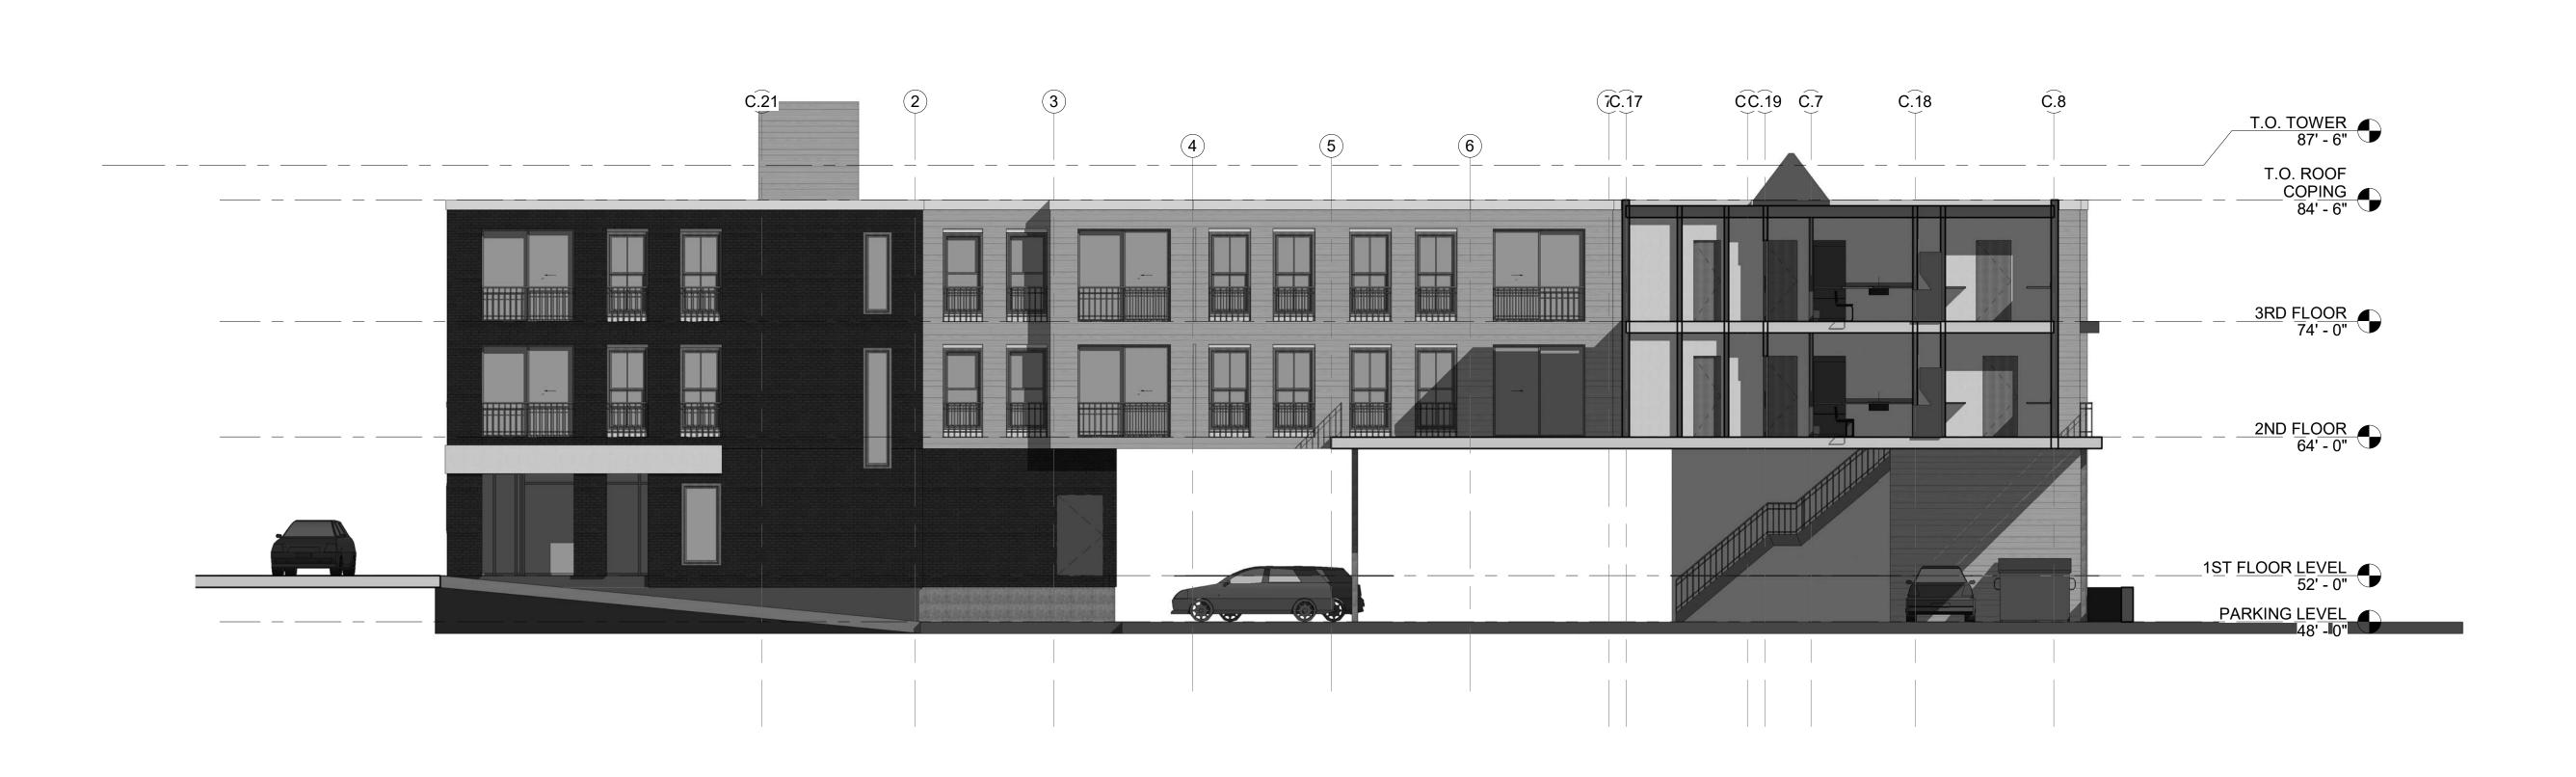
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1 A-10 - 1/8 West St Elevation 1/8" = 1'-0"

3 A-10 - 1/8 Alley Elevation 1/8" = 1'-0"



STREET PARK VIEW BUILDING 386-390 WATERTOWN S NEWTON, MA 02458

ELEVATIONS

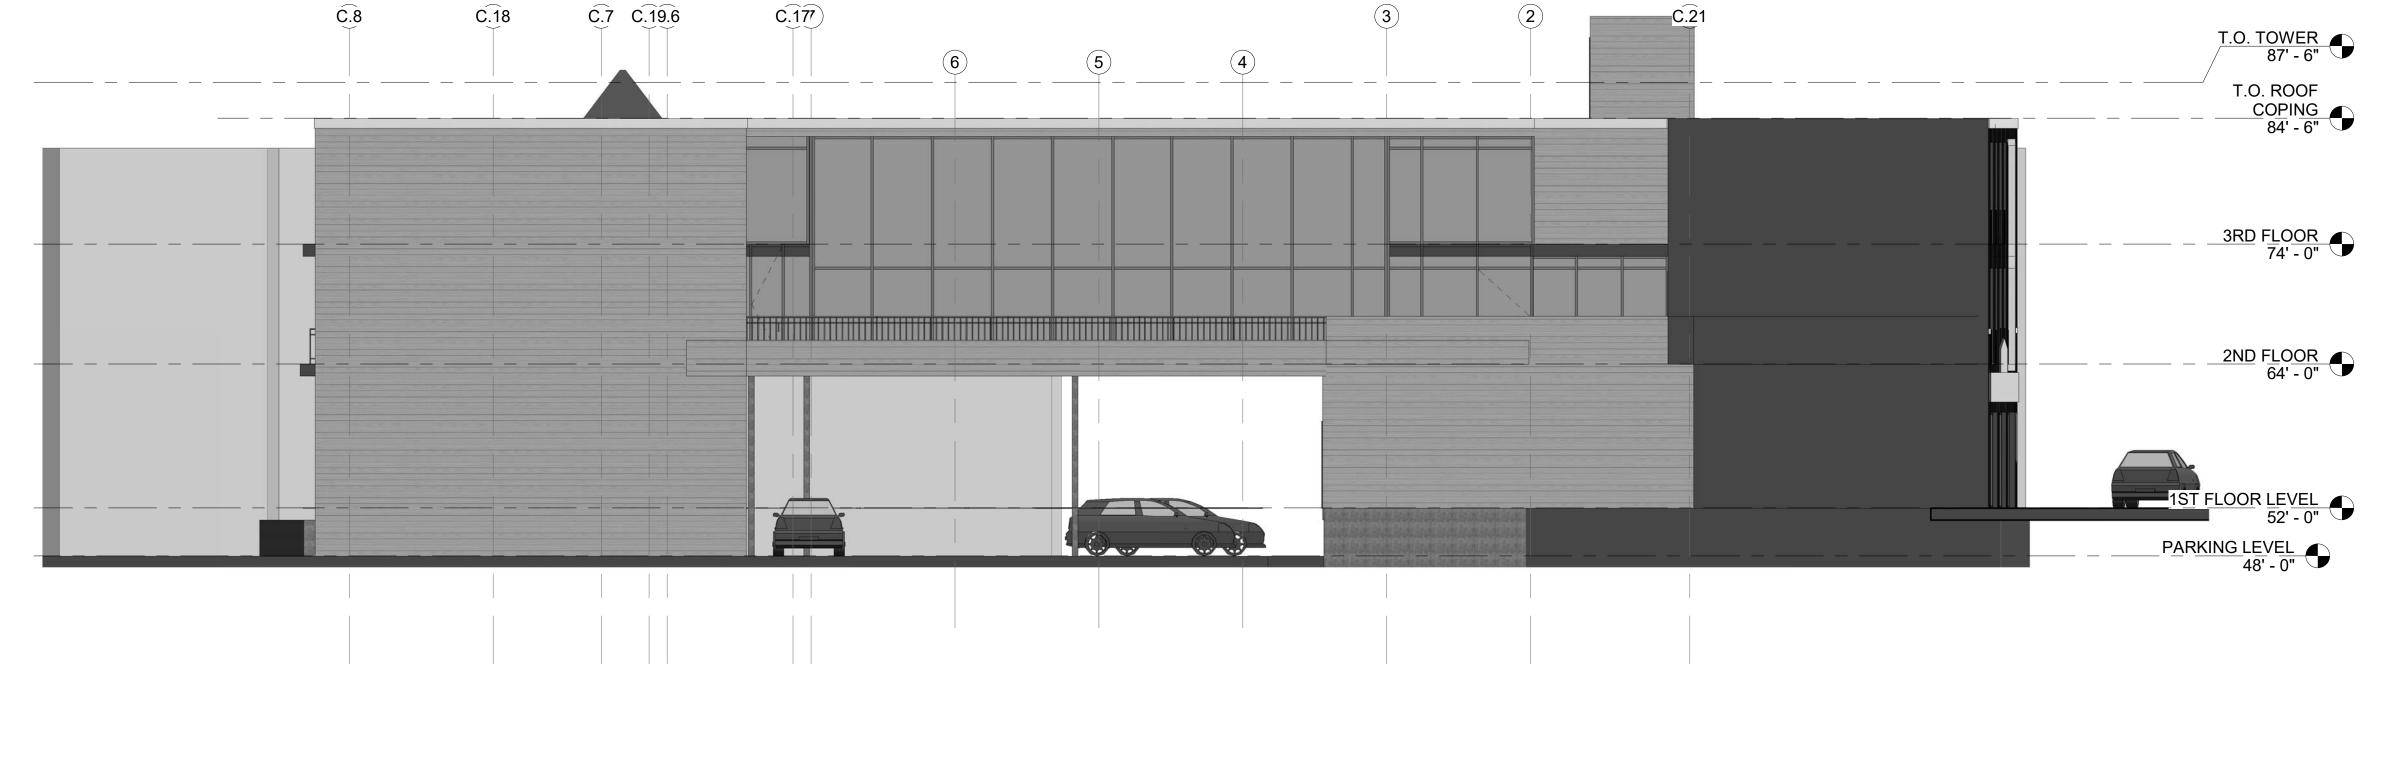Owner: JLM REAL 386-390 WATERT NEWTON, MA 024

386-390 WATERTOWN STREE NEWTON, MA 02458

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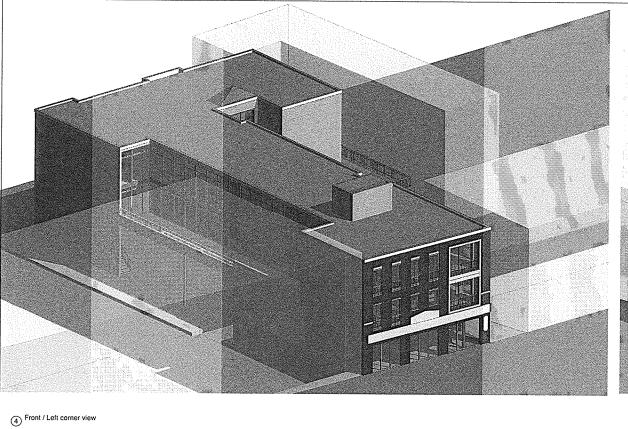
1/8" = 1'-0" DRAWN BY:

CHECKED BY:

Author

Checker

Ronald F. Jarek, Architect 487 Watertown Street Newtonville, MA 02460



1 Exterior Alley View

2 Rear View



3 Side View

Ronald F. Jarek, Architect 487 Watertown Street Newtonville, MA 02460

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3D VIEWS

386-390 WATERTOWN STREET NEWTON, MA 02458.



A-13

DATE: 05/04/17 SCALE:

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1 Street View



3D STREET VIEW

386-390 WATERTOWN STREET NEWTON, MA 02458

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Ronald F. Jarek, Architect 487 Watertown Street Newtonville, MA 02460

06:02/17 SCALE:

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