
VILLAGE OF CHESTNUT HILL, MASSACHUSETTS THE STREET REDEVELOPMENT 55 BOYLSTON STREET SPECIAL PERMIT PLANS DECEMBER 22, 2016

LIST OF DRAWINGS							
SHEET NO.	SHEET TITLE	LAST REVISED					
	COVER SHEET	12/22/2016					
C-101	55 BOYLSTON STREET EXISTING CONDITIONS/ DEMOLITION PLAN	12/22/2016					
C-102	55 BOYLSTON STREET SITE PLAN	12/22/2016					
C-103	55 BOYLSTON STREET GRADING, DRAINAGE & EROSION CONTROL PLAN	12/22/2016					
C-104	55 BOYLSTON STREET UTILITIES PLAN	12/22/2016					
L-101	LANDSCAPE SITE PLAN 55 BOYLSTON STREET	07/28/2016					
G-501	EROSION CONTROL NOTES & DETAILS SHEET	12/22/2016					
G-502	DETAILS SHEET	12/22/2016					

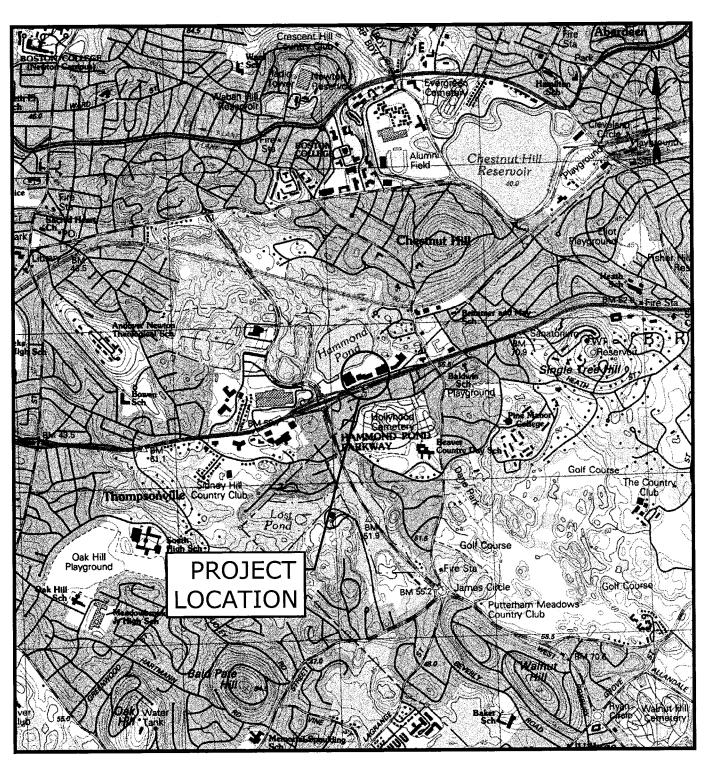

LOCATION MAP SCALE: 1" = 2,000'





APPLICANT:

Chestnut Hill Shopping Center LLC C/o WS Development Associates LLC 33 Boylsyton Street, Suite 3000 Chestnut Hill, Masschusetts 02467

ARCHITECT:

LTL ARCHITECTS 227 W 29th 7th Floor New York, New York 10001


SURVEY CONSULTANT:

Feldman Professional Land Surveyors Harry R Feldman, Inc. 112 Shawmut Avenue, 4th Floor Boston, Massachusetts 02115

LANDSCAPE ARCHITECT:

MATHEWS NIELSEN 120 Broadway, Suite 1040 New York, New York 10271




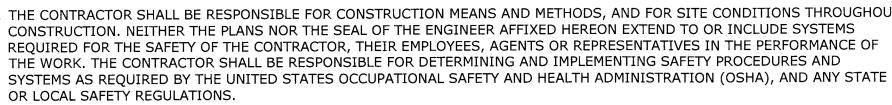





C-101

GRAPHIC SCALE

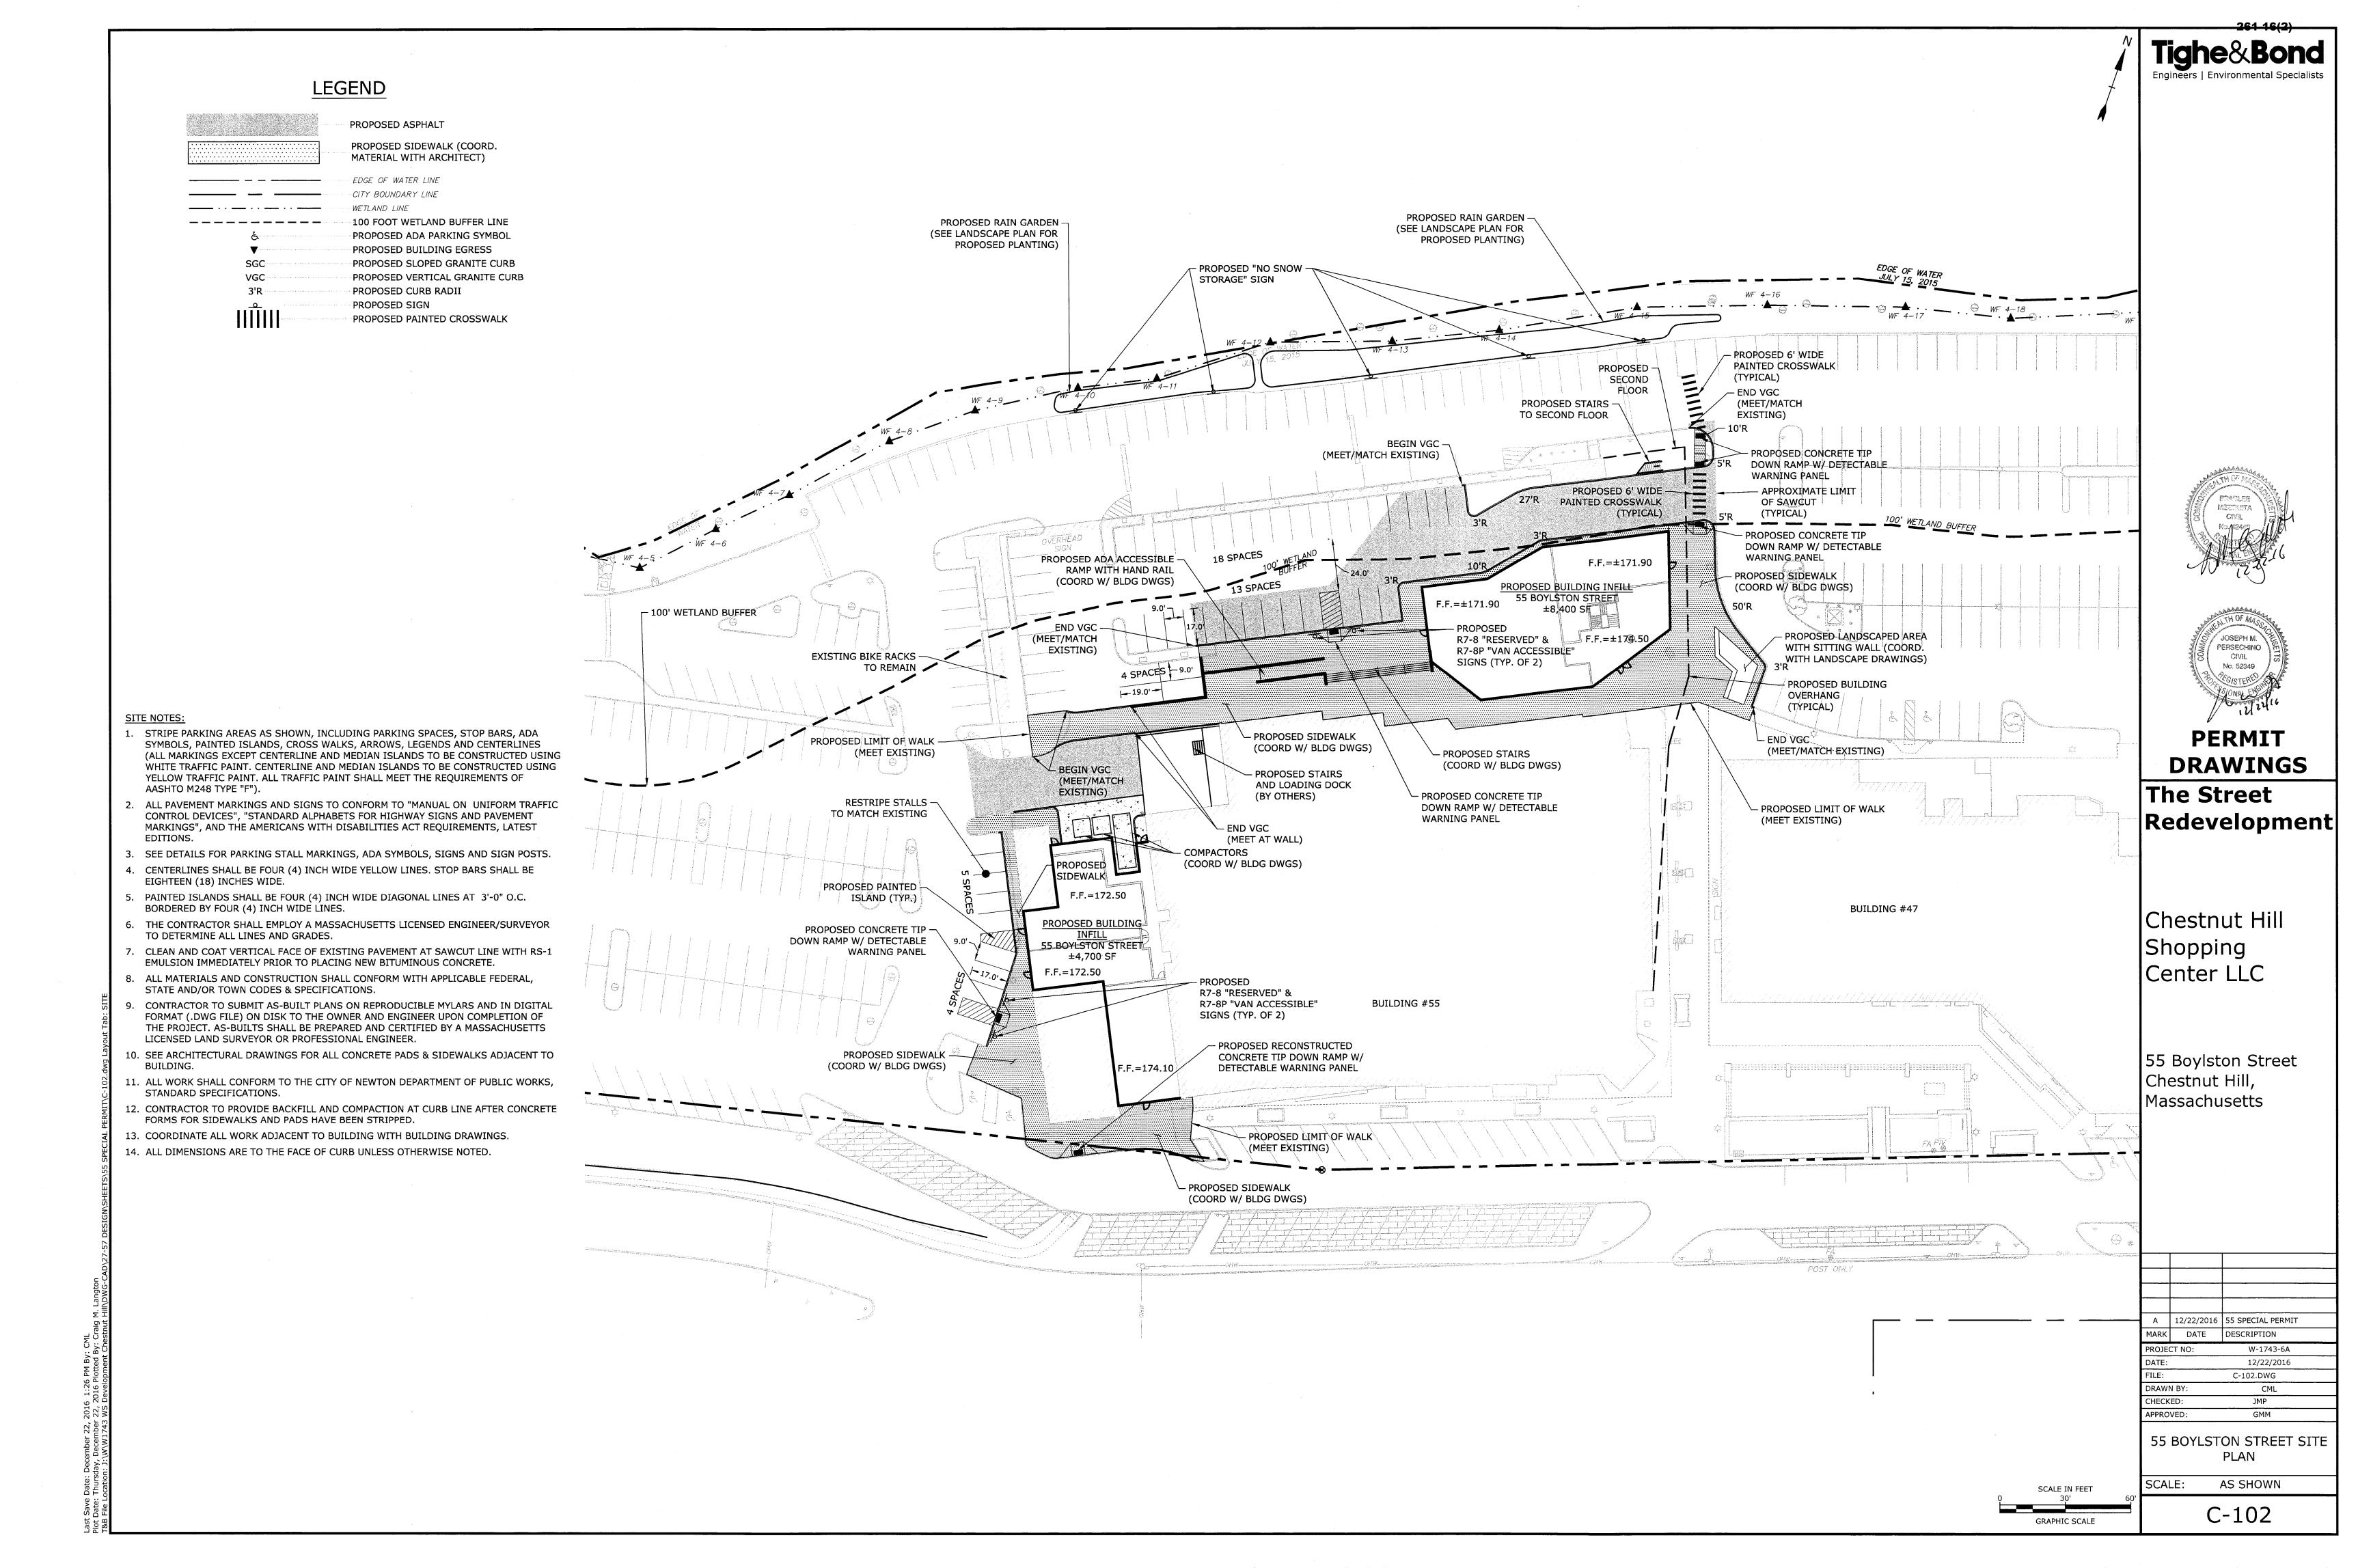

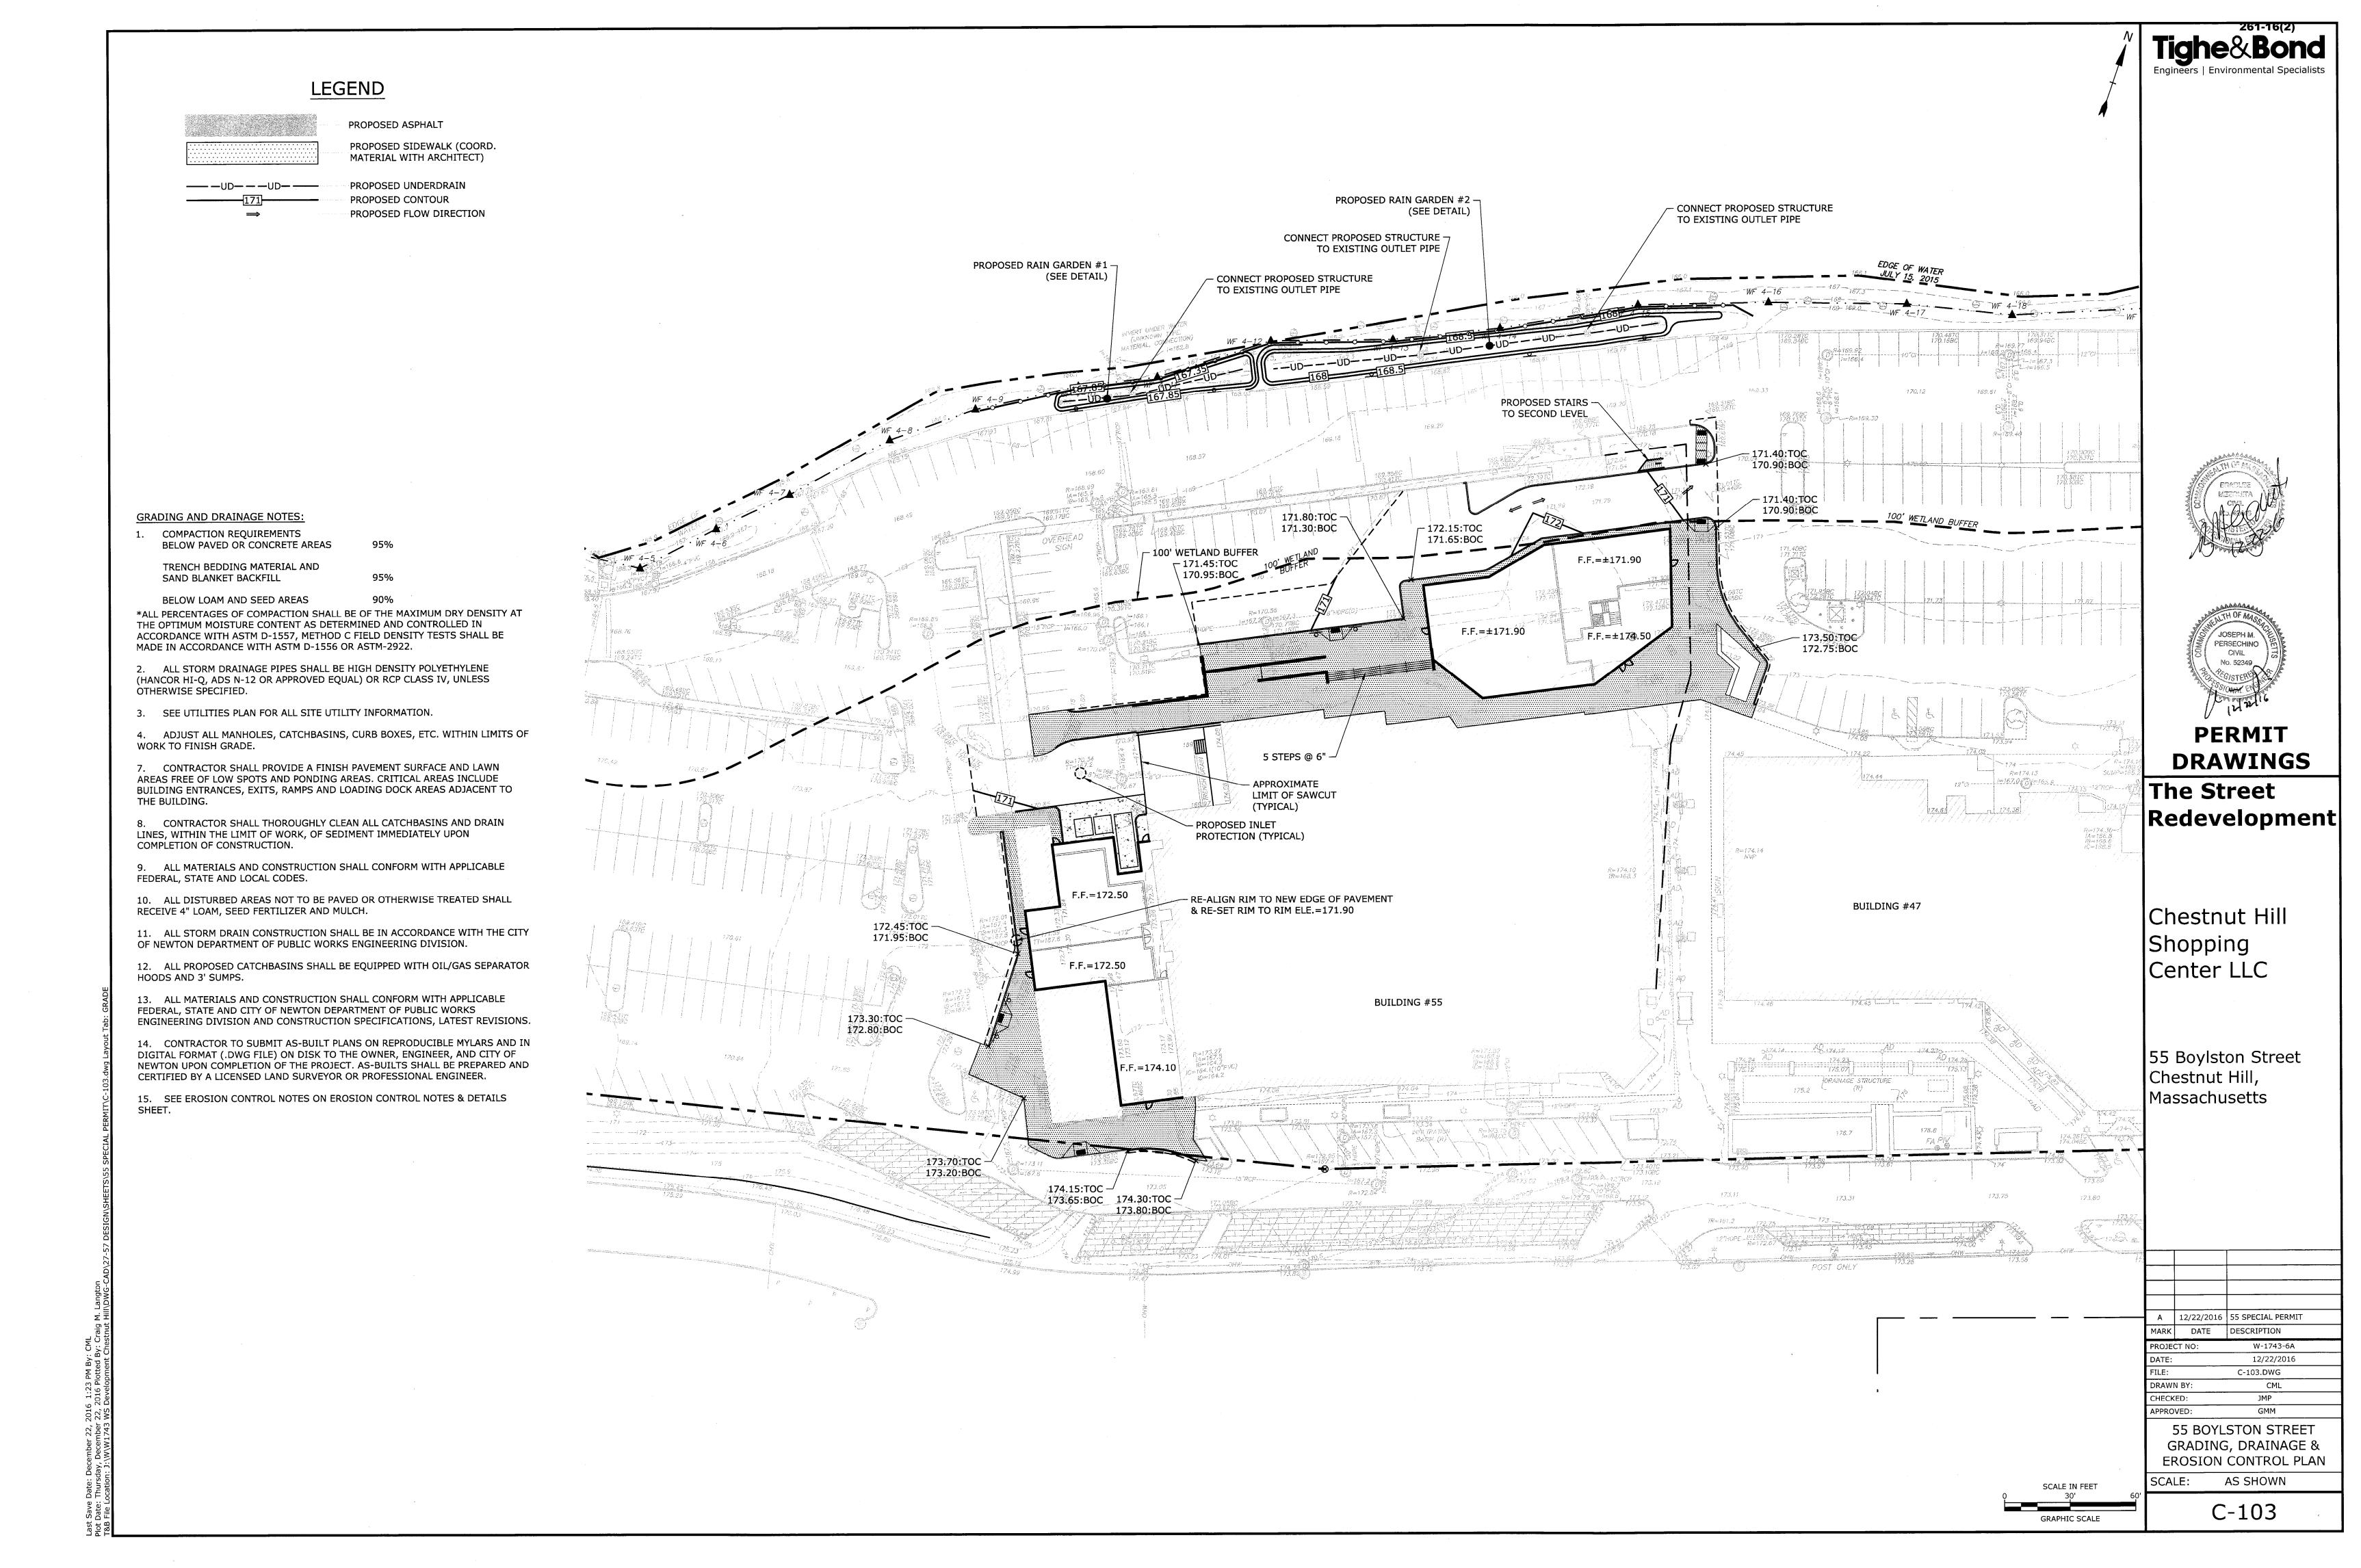

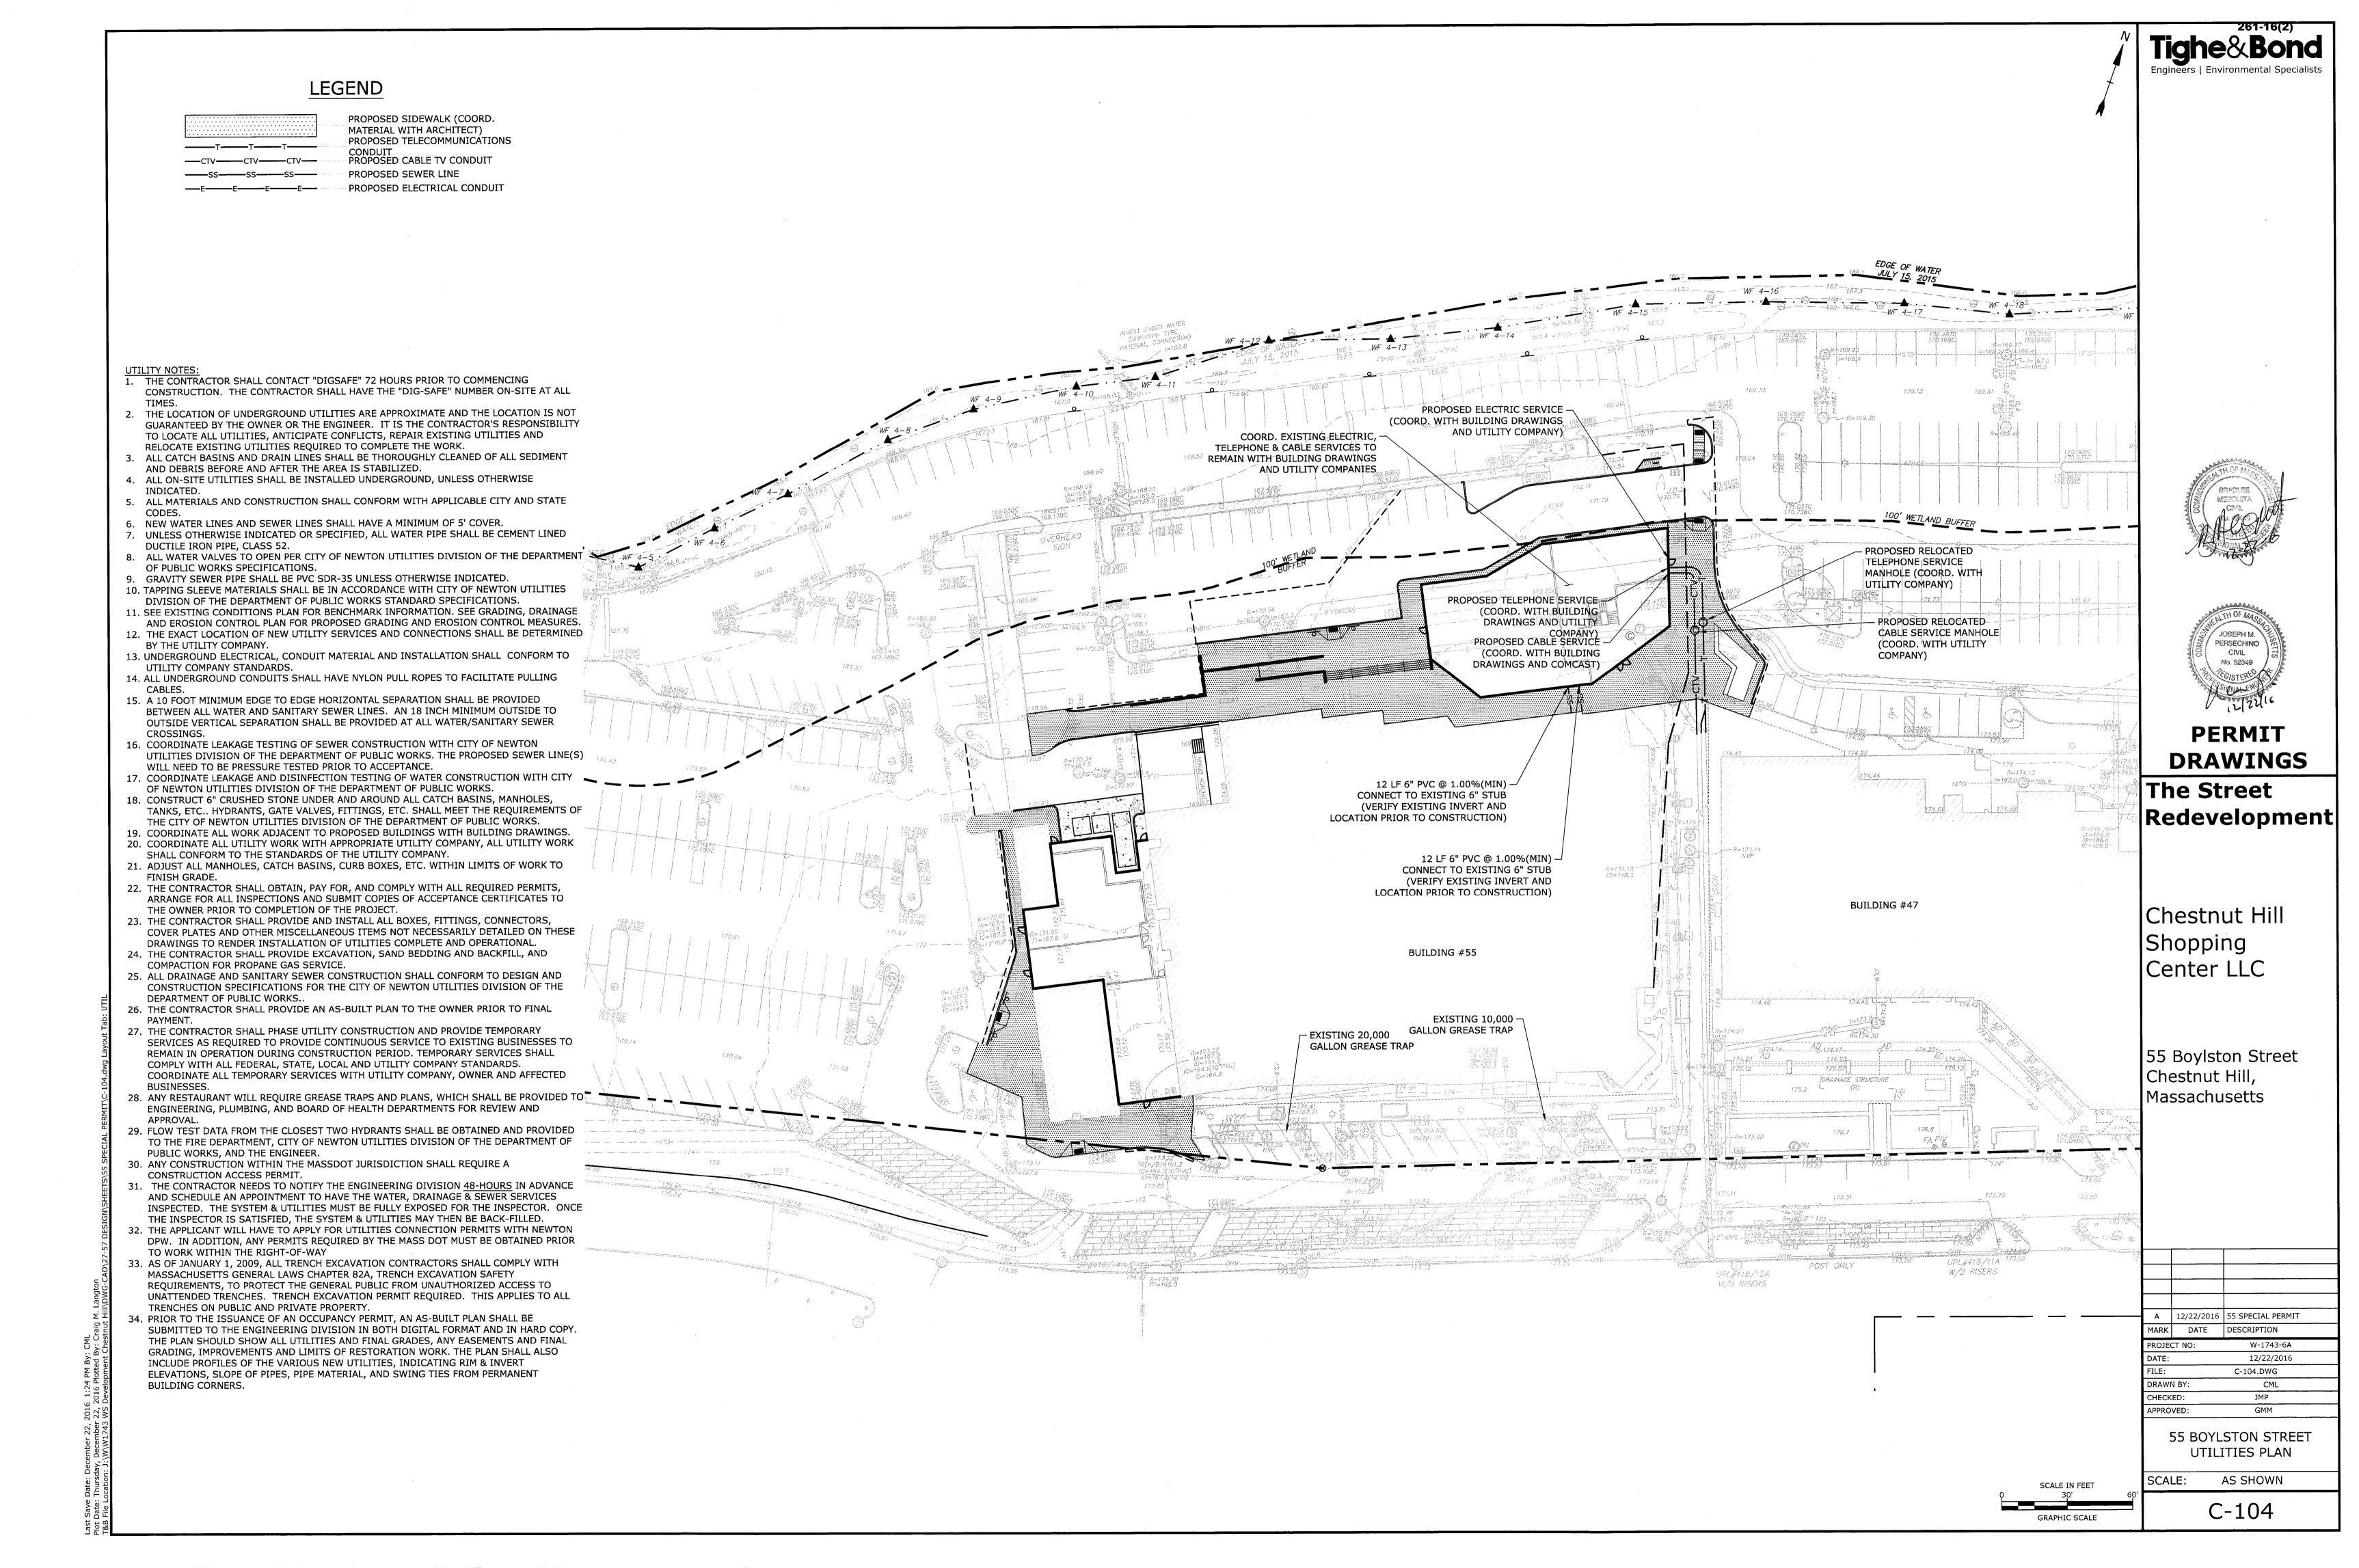

TREE PLANTING SCHEDULE

QTY.	ABBR.	SCIENTIFIC NAME	COMMON NAME	CONT.	SIZE	SPACING	SPACING
	GT	Gleditsia triacanthos var. inermis 'Skyline'	Skyline Honey Locust	B&B	3.5"-4.0"	AS SHOWN	LIMBED UP TO 7'

HAMMOND'S POND RAIN GARDEN PLANTING -APPROXIMATE LIMIT OF WORK —— AT POND EDGE GRANITE PAVING, TYP. PROPOSED BUILDING ADDITION 55 BOYLSTON STREET BUILDING OVERHANG, TYPICAL CONCRETE PAVING, TYP. ---55 BOYLSTON STREET EXISTING TREE TO — REMAIN

<u>LEGEND</u>

GRANITE PAVING

BRICK PAVING

CONCRETE PAVING

RAIN GARDEN PLANTING

PLANTING AREA

EXISTING TREE

• PROPOSED TREE

--- APPROXIMATE LIMIT OF WORK

--- 100' WETLAND BUFFER

THE STREET-CHESTNUT HILL 55 BOYLSTON ADDITION

This drawing is an instrument of professional service and shall remain the property of LTL.

Architects, whether the project for which it is prepared is executed or not. No changes, alterations,
or deletions may be made except by LTL Architects. This drawing shall not be used or reproduced
by anyone on other projects, for additions to this project or for completion of this project by others
without written consent. Copyright 2016 LTL Architects.

ARCHITECT

Lewis.Tsurumaki.Lewis

227 West 29th Street, 7th Fir.

New York, NY 10001

t: 212 505-5955
f: 212 505-1648

ROBERT SILMAN ASSOCIATES

111 Devonshire Street Boston, MA 02109 t: 617 695-6700

MECHANICAL, ELECTRICAL & PLUMBING ENGINEER

ME Engineers 29 West 38th Street, 5th Fir. New York, NY 10018

LANDSCAPE ARCHITECTS

Mathews Nielsen Landscape Architects 120 Broadway, Suite 1040 New York, NY 10271

SCALE: 1" = 30'

DRAWN:

DATE: JULY 28, 2016

JOB: 15-867

LANDSCAPE SITE PLAN 55 BOYLSTON STREET

SHEET NUMBER

TITLE:

L-101

EAL

NOT FOR CONSTRUCTION

0 30' 60' 90'

SPILLS OF TOXIC OR HAZARDOUS MATERIAL SHALL BE REPORTED TO THE APPROPRIATE LOCAL, STATE OR FEDERAL THE SITE SUPERINTENDENT RESPONSIBLE FOR DAY-TO-DAY SITE OPERATIONS SHALL BE THE SPILL PREVENTION AND CONTRACTOR SHALL MAKE AN EFFORT TO PERFORM EQUIPTMENT/VEHICAL FUELING AND MAINTENANCE AT AN OFF-SITE CONTRACTOR SHALL PROVIDE AN ON-SITE FUELING AND MAINTENANCE AREA THAT IS CLEAN AND DRY. CONTRACTOR SHALL VEHICLES SHALL BE INSPECTED REGULARLY FOR LEAKS AND DAMAGE CONTRACTOR SHALL USE DRIP PANS, DRIP CLOTHS, OR ABSORBENT PADS WHEN REPLACING SPENT FLUID. EROSION CONTROL OBSERVATIONS AND MAINTENANCE PRACTICES
THIS PROJECT DOES EXCEED ONE (1) ACRE OF DISTURBANCE AND THUS DOES REQUIRE A SWPPP. THE SWPPP SHALL BE PREPARED PRIOR TO CONSTRUCTION. THE CONTRACTOR SHALL BE FAMILIAR WITH THE SWPPP AND KEEP AN UPDATED COPY THE FOLLOWING REPRESENTS THE GENERAL OBSERVATION AND REPORTING PRACTICES THAT SHALL BE FOLLOWED AS PART OBSERVATIONS OF THE PROJECT FOR COMPLIANCE WITH THE SWPPP SHALL BE MADE BY THE ENGINEER (CONTRACTOR) AT LEAST ONCE A WEEK OR WITHIN 24 HOURS OF A STORM 0.25 INCHES OR GREATER. AN OBSERVATION REPORT SHALL BE MADE AFTER EACH OBSERVATION AND DISTRIBUTED TO THE ENGINEER, THE A REPRESENTATIVE OF THE SITE CONTRACTOR, SHALL BE RESPONSIBLE FOR MAINTENANCE AND REPAIR ACTIVITIES. IF MORE THAN 5000 CUBIC YARDS ARE TO BE BLASTED A BLASTING PLAN SHALL BE PROVIDED. BLASTING PLAN SHALL A. LOCATION AND IDENTIFICATION OF DRINKING WATER WELLS LOCATED WITHIN 2000 FEET OF THE PROPOSED B. A GROUNDWATER QUALITY SAMPLING PROGRAM, APPROVED BY NHDES PRIOR TO INITIATING BLASTING, TO MONITOR FOR NITRATE AND NITRITE EITHER IN THE DRINKING WATER SUPPLY WELLS OR IN OTHER WELLS THAT ARE REPRESENTATIVE OF THE DRINKING WATER SUPPLY WELLS IN THE AREA. 1. THE GROUNDWATER SAMPLING PROGRAM MUST BE IMPLEMENTED ONCE APPROVED BY NHDES 2. THE FOLLOWING BEST MANAGEMENT PROCEDURES FOR BLASTING SHALL BE COMPLIED WITH: THE FOLLOWING BLASTHOLE LOADING PRACTICES TO MINIMIZE ENVIRONMENTAL EFFECTS SHALL BE FOLLOWED: DRILLING LOGS SHALL BE MAINTAINED BY THE DRILLER AND COMMUNICATED DIRECTLY TO THE BLASTER. THE LOGS SHALL INDICATE DEPTHS AND LENGTHS OF VOIDS, CAVITIES, AND FAULT ZONES OR OTHER WEAK ZONES EXPLOSIVE PRODUCTS SHALL BE MANAGED ON-SITE SO THAT THEY ARE EITHER USED IN THE BOREHOLE, RETURNED TO THE DELIVERY VEHICLE, OR PLACED IN SECURE CONTAINERS FOR OFF-SITE DISPOSAL. SPILLAGE AROUND THE BOREHOLE SHALL EITHER BE PLACED IN THE BOREHOLE OR CLEANED UP AND RETURNED TO AN APPROPRIATE VEHICLE FOR HANDLING OR PLACEMENT IN SECURED CONTAINERS FOR OFF-SITE DISPOSAL. LOADED EXPLOSIVES SHALL BE DETONATED AS SOON AS POSSIBLE AND SHALL NOT BE LEFT IN THE BLASTHOLES OVERNIGHT, UNLESS WEATHER OR OTHER SAFETY CONCERNS REASONABLY DICTATE THAT DETONATION SHOULD BE LOADING EQUIPMENT SHALL BE CLEANED IN AN AREA WHERE WASTEWATER CAN BE PROPERLY CONTAINED AND HANDLED IN A MANNER THAT PREVENTS RELEASE OF CONTAMINANTS TO THE ENVIRONMENT EXPLOSIVES SHALL BE LOADED TO MAINTAIN GOOD CONTINUITY IN THE COLUMN LOAD TO PROMOTE COMPLETE DETONATION. INDUSTRY ACCEPTED LOADING PRACTICES FOR PRIMING, STEMMING, DECKING AND COLUMN RISE NEED THE FOLLOWING BMPS SHALL BE FOLLOWED TO REDUCE THE POTENTIAL FOR GROUNDWATER CONTAMINATION EXPLOSIVE PRODUCTS SHALL BE SELECTED THAT ARE APPROPRIATE FOR SITE CONDITIONS AND SAFE BLAST EXPLOSIVE PRODUCTS SHALL BE SELECTED THAT HAVE THE APPROPRIATE WATER RESISTANCE FOR THE SITE CONDITIONS PRESENT TO MINIMIZE THE POTENTIAL FOR HAZARDOUS EFFECT OF THE PRODUCT UPON GROUNDWATER. PREVENTION OF MISFIRES. APPROPRIATE PRACTICES SHALL BE DEVELOPED AND IMPLEMENTED TO PREVENT MUCK PILES (THE BLASTED PIECES OF ROCK) AND ROCK PILES SHALL BE MANAGED IN A MANNER TO REDUCE THE POTENTIAL FOR CONTAMINATION BY IMPLEMENTING THE FOLLOWING MEASURES: MANAGE THE INTERACTION OF BLASTED ROCK PILES AND STORMWATER TO PREVENT CONTAMINATION OF WATER SPILL PREVENTION AND SPILL MITIGATION MEASURES SHALL BE IMPLEMENTED TO PREVENT THE RELEASE OF FUEL AND OTHER RELATED SUBSTANCES TO THE ENVIRONMENT. THE MEASURES SHALL INCLUDE AT A MINIMUM: STORAGE OF REGULATED SUBSTANCES ON AN IMPERVIOUS SURFACE; WHEREVER POSSIBLE, KEEP REGULATED CONTAINERS THAT ARE STORED OUTSIDE MORE THAN 50 FEET FROM SURFACE WATER AND STORM DRAINS, 75 FEET FROM PRIVATE WELLS, AND 400 FEET FROM SECONDARY CONTAINMENT IS REQUIRED FOR CONTAINERS CONTAINING REGULATED SUBSTANCES STORED OUTSIDE, EXCEPT FOR ON PREMISE USE HEATING FUEL TANKS, OR ABOVEGROUND OR a EXCEPT WHEN IN USE, KEEP CONTAINERS CONTAINING REGULATED SUBSTANCES CLOSED AND SEALED;

VEHICLE FUELING AND MAINTENANCE PRACTICE:

LOADING PRACTICES.

WHEN EXPLOSIVES ARE USED

SECURE STORAGE AREAS AGAINST UNAUTHORIZED ENTRY;

UNDERGROUND STORAGE TANKS OTHERWISE REGULATED.

PLACE DRIP PANS UNDER SPIGOTS, VALVES, AND PUMPS;

HAVE SPILL CONTROL AND CONTAINMENT EQUIPMENT READILY AVAILABLE IN ALL WORK AREAS;

d. USE FUNNELS AND DRIP PANS WHEN TRANSFERRING REGULATED SUBSTANCES; AND

PERFORM TRANSFERS OF REGULATED SUBSTANCES OVER AN IMPERVIOUS SURFACE.


COVER REGULATED CONTAINERS IN OUTSIDE STORAGE AREAS,

LABEL REGULATED CONTAINERS CLEARLY AND VISIBLY;

INSPECT STORAGE AREAS WEEKLY;

MUCK PILE MANAGEMENT

FULL
DRIVE WIDTH
(10' MIN.) PAVEMENT PLAN VIEW 3" CRUSHED STONE (MIN. (MIN.) "(MIN.) PAVEMENT ─ MIRAFI FW-700 OR EQUAL 1. THE ENTRANCE SHALL BE MAINTAINED IN A CONDITION WHICH WILL PREVENT TRACKING OF SEDIMENT FROM THE SITE. WHEN WASHING IS REQUIRED, IT SHALL BE DONE SO RUNOFF DRAINS INTO AN APPROVED SEDIMENT TRAPPING DEVICE. ALL SEDIMENT SHALL BE PREVENTED FROM ENTERING STORM DRAINS, DITCHES, OR WATERWAYS STABILIZED CONSTRUCTION ENTRANCE

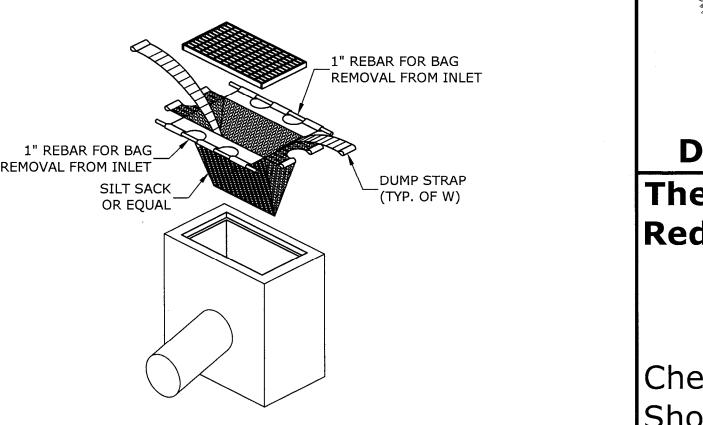



No. 52349

The Street |Reaevelopment

Chestnut Hill Shopping Center LLC

55 Boylston Street Chestnut Hill Massachusetts

A | 12/22/2016 | 55 SPECIAL PERMIT MARK DATE DESCRIPTION PROJECT NO: 12/22/2016 05_DETAILS.DWG DRAWN BY CML CHECKED JMP APPROVED:

EROSION CONTROL NOTES & DETAILS SHEET

AS SHOWN

SCALE:

G-501

HE CONTRACTOR SHALL CONSTRUCT STABILIZED CONSTRUCTION ENTRANCE(S) PRIOR TO ANY EXCAVATION ACTIVITIES.

STAKE ON 10' LINEAL SPACING 2" X 2" WOODEN STAKE— SILT SOCK— (12" TYPICAL) AREA TO BE PROTECTED **WORK AREA** AREA TO BE PROTECTED WATER FLOW **WORK AREA**

