#### Tsao Residence Zoning Review Set **Residential Renovation & Addition** 1771 Washington Street Newton, ma. 02466 A0.0 TITLE SHEET A2.0 EXTERIOR ELEVATION: SMALL SCALE E A2.1 EXTERIOR ELEVATION: WEST & EAST PA A0.1 SITE PLAN A2.2 EXTERIOR ELEVATION: NORTH & SOUTH A0.2 NOTES A3.0 BUILDING SECTION: WEST SECTION 1 D1.0 BASEMENT DEMOLITION PLAN -A3.1 BUILDING SECTION: WEST SECTION 2 D1.1 FIRST FLOOR DEMOLITON PLAN A3.2 BUILDING SECTION: SOUTH SECTION D1.2 ATTIC/ROOF DEMOLITION PLAN -A3.3 BUILDING SECTION: X/X SECTION D2.0 DEMOTION EXTERIOR ELEVATIONS -A4.0 ENLARGED PLAN: KITCHEN PARTIAL PL A1.0 FLOOR PLANS: SMALL SCALE PLANS A4,1 ENLARGED PLAN: M.SUITE PARTIAL PL A1.1 FLOOR PLAN: BASEMENT FLOOR PLAN A1.2 FLOOR PLAN: FIRST FLOOR PLAN A5.0 INTERIOR ELEVATIONS: KITCHEN A1.3 FLOOR PLAN: ATTIC FLOOR PLAN A5.1 INTERIOR ELEVATIONS: FAMILY ROOM A1.4 FLOOR PLAN: ROOF PLAN A5.2 INTERIOR ELEVATIONS: MISC. 1ST FLOO A1.5 REFLECTED CEILING PLAN: BASEMENT PLAN A5.3 INTERIOR ELEVATIONS: M.BATH ELEVA A1.6 REFLECTED CEILING PLAN: FIRST FLOOR PLAN -A5.4 INTERIOR ELEVATIONS: M.BEDROOM A1.7 REFLECTED CEILING PLAN: ATTIC FLOOR PLAN A5.5 INTERIOR ELEVATIONS: M.BEDROOM & CLOSET

CLIENT

Hensin & Sandy Tsao 1771 Washington Street Newton, Ma 02466

hensintsao@gmail.com

ARCHITECT

a+sl Studios inc., Architects 54 Carver Road Newton, MA 02461 (617) 454-4665 http://www.aslstudios.com

Anne Snelling-Lee




Architects, inc. NCARB, LEED\_AP BD+C

## THESE DRAWINGS ARE COPYRIGHT AND THE PROPERTY OF a+sl studios, inc. DRAWINGS AND OTHER MATERIALS ARE PROTECTED BY THE COPYRIGHT PROTECTION ACT.

FURTHER COPIES MUST NOT BE MADE WITHOUT PERMISSION.

a+sl studios, inc. SHALL ACCEPT NO LIABILITY FOR ANY USE MADE OF THE DRAWINGS OTHER THAN THAT FOR WHICH THEY WERE PREPARED.

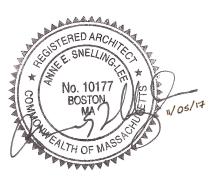

DIGITAL COPY - FOR BLDG. DEPT. RECORD ONLY. NOT TO BE REPRODUCED

ELEVATIONS	<del>- A6.0 -</del>	
PARTIAL ELEVATIONS	<del>- A6.1 -</del>	-DOORS 1
JTH PARTIAL ELEVATIONS	<del>- A6.2 -</del>	
1 2	<del>- A7.0</del>	DETAILS
2 \	S1.0	STRUCTURAL: FOUNDATION PLAN
	S1.1	STRUCTURAL: FIRST FLOOR FRAMING PLAN
	S1.2	STRUCTURAL: ATTIC / ROOF FRAMING PLAN
PLAN-	S1.3	STRUCTURAL ROOF FRAMING PLAN
PLAN		
	<del>- E1.0 -</del>	ELECTRICAL: BASEMENT PLAN
	<del>-E1.1</del> -	ELECTRICAL: FIRST FLOOR PLAN
M & MUDROOM	<del>-E1.2</del>	ELECTRICAL: ATTIC PLAN
OOR ELEVATIONS		
/ATIONS		
A		
A & CLOSET		

Tsao Residence

Residential Renovation & Addition 1771 Washington Street Newton, ma. 02466

	SCRIPTION / DATE
" "	
SCALE	N/A
DATE	02/08/17
DRAWN BY	ASL
PROJECT NO.	0716

Title Sheet

A0.0


© 2017 a+sl studios, inc.

LAND SURVEYOR Snelling & Hamel Associates, Inc. 10 Lewis Street Lincoln, MA. 01773

snellingandhamel@aol.com 781-249-9208

CONTRACTOR

T.B.D.

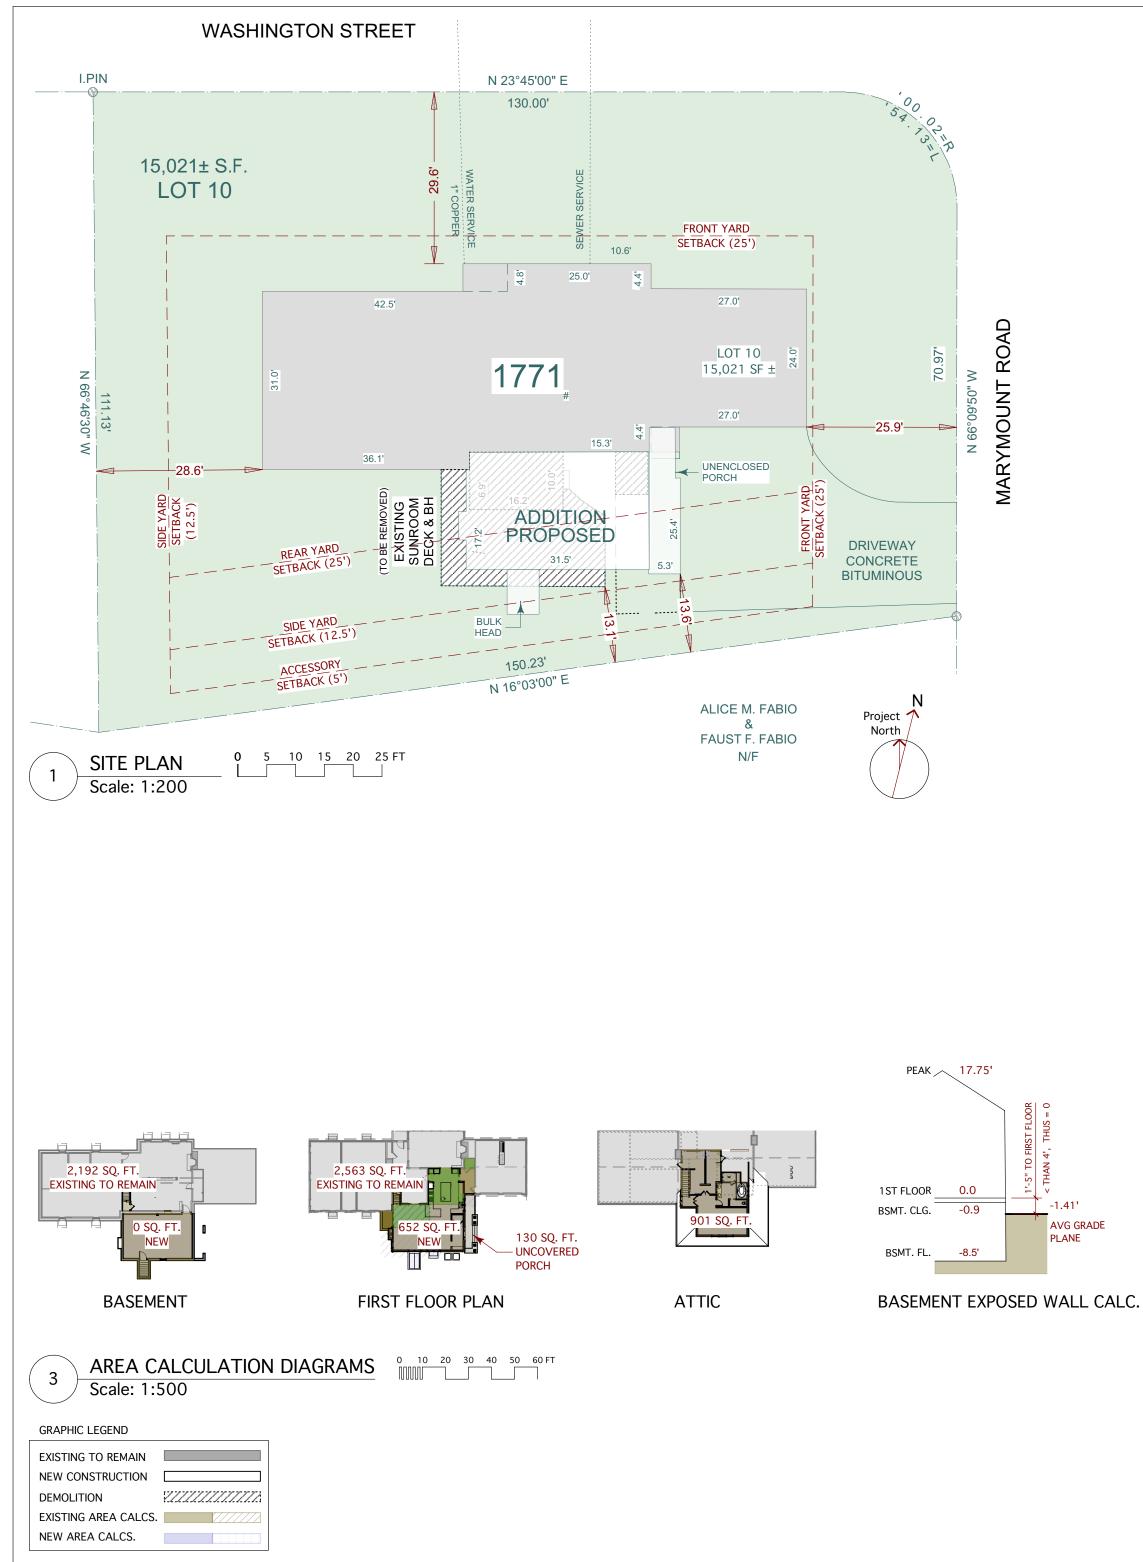



Architects, inc. NCARB, LEED\_AP BD+C

THESE DRAWINGS ARE COPYRIGHT AND THE PROPERTY OF a+sl studios, inc. DRAWINGS AND OTHER MATERIALS ARE PROTECTED BY THE COPYRIGHT PROTECTION ACT.

FURTHER COPIES MUST NOT BE MADE WITHOUT PERMISSION.

WHICH THEY WERE PREPARED.

a+sl studios, inc. SHALL ACCEPT NO LIABILITY FOR ANY USE MADE OF THE DRAWINGS OTHER THAN THAT FOR



DIGITAL COPY - FOR BLDG. DEPT. RECORD ONLY. NOT TO BE REPRODUCED

Tsao Residence

Residential Renovation & Addition 1771 Washington Street Newton, ma. 02466

 # DE	ESCRIPTION / DATE
SCALE	As Noted
DATE	02/08/17
DRAWN BY	ASL
PROJECT NO.	0716

#### SITE INFORMATION

Site Plan



REQUIREMEN Lot Area (Mi FAR - Floor A Lot Width (M Height (Max) Max. # of Sto		SR-1 REQ'D.	**EXISTING	PROPOSED
FAR - Floor A Lot Width (M Height (Max)	n)		LAISTING	PROPOSED
FAR - Floor A Lot Width (M Height (Max)	,	15,000 SF	15,021 SF	No Change
Lot Width (M Height (Max)	rea Ratio (Max)	.31 (4,653 SF Max.)	.19 (2,897 SF)	.29 (4,287 SI
		100' Min.	75'	No Change
	,	36' (2.5 Stories Max.)	17.875'	25.8'
		2.5	1.5	1.5
Front Yard (N	Min)	25'	27/36'/29.8'	No Change
Side Yard (M	in)	12.5'	28.20'	15.64'
Rear Yard (M	in)	25'	27.68'	No Change
Max. Building	Lot Coverage	20 %	20.1 %	23.8 %
Min. Amount	of Open Space	65 %	70 %	67.6 %
<b>Build Factor</b>	(only for newer lo	ts) n/a	n/a	n/a
2,897 SF 0 SF	1st Floor (Includi Attic (per Floor	oor Area of Mass = 0 SF ng Attached Garage = 533 Area Definition: Ch.30-Pag ea below 5' boriz plane 7' mi	je 6)	
2,897 SF		ROSS SQUARE FOOTAGE	n horiz. dim., min. 7' clg., ł	neight and over 70 SF
•	TOTAL HOUSE G	ROSS SQUARE FOOTAGE		C C C C C C C C C C C C C C C C C C C
2 <b>,897 SF</b> 0 SF 0 SF	<b>TOTAL HOUSE GF</b> Front Covered En	• •	re not included) = 45 Sl	F

SECTION 30-15, TABLE 1: DENISITY & DIMENSIONAL CONTROLS IN RESIDENCE DISTRICTS

SINGLE RESIDENCE ZONE 1 (SR-1): Single Dwelling Unit - House Built 1952; therefore, Lot created before 12/7/53

-0 SF	Existing Attic
0 SF	New Finished Basement Mass (the Lesser of two methods below per Ch.30-Page 7) 50% of Floor Area below 1st floor = $2,878/2 = 1,439$ SF (X/Y * Floor Area = $(0/250') * 2,878 = 0$ SF $X = 0$ (width of exposed wall with exterior height of $\ge 4'$ ) Y = XXX' per Proposed Plans Floor Area of Mass = 0 SF
+ 652 SF	New 1st Floor Addition (Does not include 130 SF of unenclosed porch)
+ 901 SF	New Attic (per Floor Area Definition: Ch.30-Page 6)
	Area below 5' horiz. plane, 7' min horiz. dim., min. 7' clg., height and over 70 SF)
+ 0 SF	Cathedral Clg.
	0' Clg. = 0' above 12'= <b>0</b>
	0 SF area above 12'
	<u>(0'/12)x0=0 SF</u>

1,553 SF Total New Space 4,287 SF TOTAL PROPOSED HOUSE SIZE




ISION 1 -GENERAL REQUIREMENTS AND NOTES	DIVISION 3 - CONCRETE	DIVISION 9- FINISHES	DIVISION 15- MECHANICAL AND PLUMBING
DRAWINGS REPRESENT DESIGN SERVICES ONLY. ADDITIONAL ROFESSIONAL SERVICES REQUIRED FOR THE ENGINEERING AND VERMITING OF WORK SHALL BE COORDINATED BY CONTRACTOR.	1. EXTENT OF CONCRETE WORK INCLUDES THE FURNISHING AND PLACING OF ALL CONCRETE AS SHOWN INCLUDING FOUNDATIONS, FOOTINGS, REINFORCING, DOWELS, ANCHORS, FORMWORK AND SLABS.	1. WALLS AND CEILING TO BE 1/2" PLASTERBOARD WITH SKIMCOAT PLASTER.	1. SYSTEM SHALL BE DESIGNED BY THE CONTRACTOR'S HVAC SUBCONTRACTOR. CONTRACTOR & SUBCONTRACTOR SHALL EXPLORE WITH ARCHITECT POSSIBILITY OF EXPANDING EXISTING EQUIPMENT TO
DESIGNER RESERVES THE RIGHT TO REVIEW AND APPROVE ALL INGINEERING CALCULATIONS AND DRAWINGS.	2. ALL SLABS AND EXTERIOR FOUNDATION WALLS TO BE INSULATED AND	2. INTERIOR PAINTING: ECO-SPEC WATER BASED PAINTS. WORK SHALL BE THOROUGHLY PREPARED FOR PAINTING BY PROPER WALL	ACCOMMODATE ADDITION VERSUS ADDING A SEPARATE AIR HANDLER & CONDENSER.
HE WORK CONSISTS OF FURNISHING ALL MATERIAL, LABOR &	WATERPROOFED PER CODE.	PREPARATION & SANDING IN ACCORDANCE WITH INDUSTRY STANDARDS. WOOD CASINGS SHALL BE MADE LEVEL AND TRUE WITH PROPER MITER JOINTS, ETC. AND MADE FLUSH PRIOR TO ANY	2. SYSTEM MUST INCLUDE ALL NECESSARY EQUIPMENT, CONTROLS, ETC., FOR A COMPLETE OPERATIONAL HEATING/COOLING FORCED AIR
ENDERS OF EVENT DESCRIPTION NECESSART TO COMPLETE THE ESIDENTIAL ADDITION & RENOVATION AT 1771 WASHINGTON TREET, NEWTON, MA	DIVISION 6 – CARPENTRY 1. LUMBER TO BE SOUND STOCK, NEW, STRAIGHT, FREE FROM DEFECTS,	PAINTING. ALL PLASTER CRACKS, HOLES, SPRAWLS, AND IMPERFECT CORNERS TO BE FILLED, TAPED, FLOATED AND SANDED PRIOR TO	SYSTEM. REVIEW OF PROPOSAL SHALL BE MADE BY THE ARCHITECT PRIOR TO ANY INSTALLATION. SYSTEM SHALL MEET ALL LOCAL
ESIGN AND DRAWINGS SHALL NOT BE REVISED WITHOUT PRIOR	OF CONSISTENT SIZE, AND KILN DRIED. EXPOSED WOOD MEMBERS, SHALL BE SELECTED FOR BEST POSSIBLE APPEARANCE. LUMBER	ANY PAINTING. WALL & CEILING COLORS SELECTION BY ARCHITECT.	CODES AND ORDINANCES.
WRITTEN APPROVAL OF THE ARCHITECT.	SHALL BE SURFACED FOUR SIDES AND SHALL BE FURNISHED IN LONGEST PRACTICAL LENGTH.	3/ EXTERIOR PAINTING: PAINT ALL PRE-PRIMED CEDAR SHINGLES	3. BATH FANS: 'FANTECH' INLINE, BACK DRAFT HOUSINGS, REMOTE MOTOR.
DO NOT SCALE DRAWINGS. ALL WORK REQUIRING MEASURING SHALL BE DONE IN ACCORDANCE TO FIGURES ON DRAWINGS. ANY MISSING	2. PROVIDE SOLID BLOCKING AT WALL ATTACHMENTS, BATH & MUDROOM	4. FLOORING:	4. DOMESTIC WATER PIPING SHALL BE TYPE "PEX-C" APPROVED FOR
DIMENSIONS WILL BE FURNISHED UPON REQUEST.	ACCESSORIES, KITCHEN CABINETS AND ALL AREAS INDICATED ON DRAWINGS.	NEW WOOD FLOORING: TO MATCH EXISTING AT ALL ADDITION AREAS (EXCEPT BASEMENT & MASTER BATH)	POTABLE WATER. ALL PIPING EXPOSED IN BATHROOMS SHALL BE CHROME. PROVIDE SHUT-OFF VALVES FOR ALL SUPPLY LINES AT
QUESTIONS REGARDING DOCUMENTS SHALL BE DIRECTED TO ARCHITECT FOR CLARIFICATIONS. WHERE INCONSISTENCIES EXIST IN	3. GENERAL CARPENTRY MATERIAL SCHEDULE:	AT RENOVATED KITCHEN	POINT OF CONNECTION TO ANY APPLIANCE, FIXTURE OR PIECE OF MECHANICAL EQUIPMENT. ALL HEATING, HOT WATER PIPING AND
THE DRAWINGS, LARGER SCALE DRAWINGS SHALL GOVERN. IF DIMENSIONS ARE INCONSISTENT OR NOT CORRECT, CONTACT	STUD WALL: EXTERIOR 2x6 TYPICAL, INTERIOR 2x4 TYPICAL SHEATHING (EXTERIOR GRADE):	EXISTING WOOD FLOORING: SAND AND REFINISH FIRST FLOOR HALL OUTSIDE STAIR	DUCTWORK SHALL BE INSULATED.
ARCHITECT PRIOR TO CONSTRUCTION.	WALLS 1/2" ZIP WALL ROOF 5/8" CDX	DINING ROOM LIVING ROOM (PATCH AS REQ'D @ NEW KITCHEN OPENING)	5. CONTRACTOR TO PROVIDE ALLOWANCE FOR ALL PLUMBING FIXTURES. ALLOWANCE TO INCLUDE FIXED COST FOR SELECTED FIXTURES.
THE CHARACTER AND SCOPE OF THE WORK ARE ILLUSTRATED BY THE DRAWINGS AND NOTES. TO INTERPRET AND EXPLAIN THE DRAWINGS OTHER INFORMATION DEEMED NECESSARY BY THE	4. 'TANALISED' ECOWOOD TREATMENT, OR EQUAL: ALL LUMBER FOR USE AS WOOD BLOCKINGS, CURBS, CANTS, NAILERS, ETC. IN DIRECT	CERAMIC TILE AT BATHROOMS	REFER TO PROJECT BOOK FOR FIXTURE SELECTIONS CONTRACTOR TO PRIVIDE RADON PIPE AND BASEMENT AT EXISTING
ARCHITECT WILL BE FURNISHED TO THE CONTRACTOR WHEN AND AS REQUIRED BY THE WORK.	CONTACT CONC. FOUNDATION WALLS, OR AT MOISTURE PRONE AREAS.	PORCELAIN TILE AT MUDROOM	6. BASEMENT.
WHERE A DETAIL IS SHOWN FOR ONE CONDITION, IT SHALL ALSO	5. EXTERIOR: PRIMED CEDAR SHINGLES	5. WALL TILE: CERAMIC TILE AT KITCHEN BACKSPLASH	DIVISION 16- ELECTRICAL
APPLY FOR ALL LIKE OR SIMILAR CONDITIONS UNLESS NOTED OTHERWISE.	<ol> <li>INTERIOR TRIM: TO MATCH EXISTING EXCEPT AT BASEMENT. BASEMENT = 1x4 NOMINAL (3/4" x 3 1/2" ACTUAL) FLAT STOCK FOR</li> </ol>	CERAMIC TILE AT M.BATHROOM WALLS/SHOWER/TUB FACE.	1. ALL OUTLETS AND SWITCHES TO BE 'LUTRON', ROCKER PLATE SWITCHES, SLIDING DIMMERS, AND MATCHING PLUGS. GANG SWITCHES
ALL WORK SHALL COMPLY WITH APPLICABLE STATE AND LOCAL	CASINGS. SQUARE EDGE SILLS. REFER TO DETAILS. ALL INTERIOR WOOD TO BE PAINT GRADE.	6. CEMENTICIOUS BACKER BOARD AT ALL AREAS TO RECEIVE TILE.	WHERE POSSIBLE. ALL EXTERIOR OUTLETS TO BE WEATHERPROOF. PROVIDE G.F.I. CIRCUIT BREAKER RECEPTACLES AT WET AREAS.
CODES. CONTRACTOR SHALL OBTAIN ALL NECESSARY PERMITS FOR THE CONSTRUCTION AND SHALL PAY ALL RELATED FEES AND	7. EXTERIOR TRIM: TO MATCH EXISTING:	7. 5/4" GRANITE COUNTERTOP AT KITCHEN AND MASTER BATH.	PROVIDE DIGITAL, PROGRAMMABLE THERMOSTATS. OWNER TO SUPPLY APPLIANCES, CONTRACTOR TO INSTALL. ELECTRICAL
EXPENSES. CONTRACTOR SHALL VERIFY ALL MEASUREMENTS FOR WORK AND	1x NOMINAL CEDAR, PROFILE TO MATCH EXISTING, PAINT GRADE CEDAR WOOD SILLS, PAINT GRADE.	8. KITCHEN CABINETS: RECESSED PANEL RAIL & STILE WITH FAUX INSET LOOK (BY INSTALLING END PANELS) = PAINTED WOOD.	SUBCONTRACTOR TO VERIFY SCHEDULE PART NUMBER AND ANY ASSOCIATED PART COMPONENTS.
MATERIALS AT THE JOB AND BE RESPONSIBLE FOR THE ACCURACY OF SAME BEFORE THE ORDERING OF ANY MATERIALS OR LABOR.	DIVISION 7- MOISTURE PROTECTION	9. MUDROOM HOUSE MANAGEMENT CENTER = PTD. WOOD SHELF, PIN-UP BOARD ON WALL AND SMALL DRAWERS/CUBBIES FOR	2. CONTRACTOR WILL SCHEDULE "ROUGH" WALK-THROUGH WITH OWNER TO VERIFY TYPES, LOCATION & SWITCHING OF ELECTRICAL
EXAMINE ARCHITECTURAL, STRUCTURAL, MECHANICAL & ELECTRICAL	<ol> <li>NEW ASPHALT ROOF TO MATCH EXISTING. METAL GUTTERS AND DOWNSPOUTS TO MATCH EXISTING.</li> </ol>	CELLPHONES AND CHARGERS.	DEVICES/FIXTURE.
FIXTURE DRAWINGS FOR VERIFICATION OF DIMENSIONS AND LOCATIONS SHOWN ON ELECTRICAL AND PLUMBING DRAWINGS	ROOF EDGE & FLASHING TO MATCH EXISTING.	10. M.BEDROOM CLOSET. EXPLORE PRE-FAB CLOSET OPTIONS WITH OWNER. OTHER CLOSETS = CHROME ROD & PTD. WOOD SHELF.	3. THERMOSTATS SHALL BE NEST. OWNER TO PROVIDE & CONTRACTOR TO INSTALL.
PROVIDED BY CONTRACTOR.	2. INSULATION: CEILINGS: R-40 CLOSED-CELL AT ALL CEILINGS - PROVIDE PROPER		4. SPEAKERS & CONTROLS SHALL BE SONOS. OWNER TO PROVIDE
CONTRACTOR TO LEAVE THE PREMISES AT THE END OF THE PROJECT IN A CLEAN CONDITION WITH THE REMOVAL OF ALL DEBRIS AND	VENTILATION.	DIVISION 10 - SPECIAL 1. GAS FIREPLACE = 'COSMO" DIRECT VENT GAS FIREPLACE = PLACE	CEILING SPEAKERS AND SONOS BOXES. CONTRACTOR TO INSTALL RECESSED CEILING SPEAKERS AND RUN SPEAKER WIRE TO BASEMENT &
CONSTRUCTION RELATED EQUIPMENT, CLEAN ALL WINDOWS, ETC.	WALLS: R-20 CLOSED-CELL - PROVIDE PROPER VENTILATION. SLAB-ON-GRADE: EXTEND R-12 WEATHER RESISTANT INSULATION 24"	HOLDER ONLY.	LOCATION AGREED UPON IN FIELD FOR SONOS CONTROLS.
. CONTRACTOR SHALL PROVIDE ADEQUATE WEATHER PROTECTION FOR THE BUILDING AND ITS CONTENTS.	MIN. VERTICALLY & HORIZONTALLY AROUND ENTIRE ON-GRADE PERIMETER.	<b>DIVISION 11 – EQUIPMENT</b> 1. CONTRACTOR TO PROVIDE SEPARATED QUOTE FOR INSTALL LABOR.	ALTNERATE SCOPE TO PRICE SEPARATELY 1. PROVIDE SEPARATE PRICE/ESTIMATE FOR SALVAGING EXISTING RAISED
THE CONTRACTOR SHALL PROVIDE OWNER WITH ALL WARRANTIES, GUARANTEES, AND INSTRUCTIONS ON ALL EQUIPMENT AND	3. PROVIDE DRAIN BOARD, 'ROXUL' OR EQUAL AT PERIMETER OF	REFER TO PROJECT BOOK FOR FIXTURE SELECTIONS	DECK MATERIAL AND INSTALLING DECK AT EAST SIDE OF ADDITION.
APPLIANCES.	FOUNDATION WALL AS REQUIRED BY CODE.	KITCHEN: 30" OVEN & SPEED OVEN 24" DRAWER MICROWAVE	2. PROVIDE ALTERNATE ALLOWANCE FOR REFINISHING EXISTING ALL FIRST FLOOR WOOD FLOORS.
PROVIDE A MIN. 12 MONTH WARRANTY ON ALL NEW CONSTRUCTION, COMMENCING WITH THE FINAL APPROVED APPLICATION FOR	4. INSTALL FLASHING @ ALL EXTERIOR WALL & ROOF PENETRATIONS.	36" COOKTOP & DOWNDRAFT UNDERCABINET HOOD 36" REFRIGERATOR	3. ADDING ZONES TO EXISTING HVAC TO:
PAYMENT. ALSO PROVIDE A SUBCONTRACTORS RELEASE OF LIENS TO THE OWNER WITH THE FINAL APPLICATION OF PAYMENT.	DIVISION 8 - DOORS, WINDOWS, GLASS	24" DISHWASHER 24" BEVERAGE CENTER	SEPARATE ZONE FOR 1ST FLOOR SEPARATE ZONE FOR 2ND FLOOR MASTER BEDROOM SUITE.
ALL TEMPORARY UTILITIES NECESSARY FOR THE PROGRESS OF THE	1. INTERIOR WOOD DOORS: TRU-STILE (OR EQUAL) 1-3/8" PAINT GRADE PINE.	INSINKERATOR "BADGER" GARBAGE DISPOSAL	SEPARATE ZONE FOR BASEMENT FINISHED SPACES.
WORK SHALL BE OBTAINED BY THE CONTRACTOR AND PAID FOR BY THE OWNER.	<ol> <li>EXTERIOR WINDOWS: MARVIN INTEGRITY</li> <li>EXTERIOR DOORS: REFER TO DOOR SCHEDULE RE-USE EXISTING ENTRY BULKHEAD DOOR.</li> </ol>		4. PROVIDE SEPARATE PRICE/ESTIMATE FOR ELEC. RADIANT HEAT AT: MUDROOM M.BATHROOM
. ALL WORK SHALL BE ACCOMPLISHED BY SKILLED MECHANICS WITH GOOD WORKMANSHIP.	4. DOORS SHALL BE PREPARED FOR HARDWARE INSTALLATION PRIOR TO		
	FINISHING. DOORS TO HAVE 3 SETS OF HINGES HAGER OR EQUAL. ALL HARDWARE FOR DOORS AND WINDOWS (INCLUDING HINGES) TO BE		
<u>VISION 2 – SITE WORK</u> OCAHEDNIGL CRPRLRD SRIRNLPPEBH. EPNLP BOEP	BRASS. CONTRACTOR TO PROVIDE AND INSTALL HARDWARE.		
IN A SAFE AND LEGAL MANNER.			
AREAS THAT ARE AFFECTED IN ANY WAY BY THE CONSTRUCTION PROCESS.			
CONTRACTOR TO REMOVE DEAD TREE + LARGE TREE NEAR GROUND			
EXCAVATION AREA.			
			L

# A + SI studios 54 Carver Road newton, ma 02136 t1 617-454-4665 www.aslstudios.com

COPYRIGHT AND THE PROPERTY OF AWINGS AND OTHER MATERIALS COPYRIGHT PROTECTION ACT.

NOT BE MADE WITHOUT

ALL ACCEPT NO LIABILITY FOR ANY WINGS OTHER THAN THAT FOR PARED.

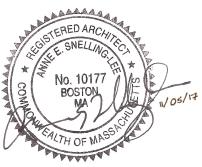


FOR BLDG. DEPT. RECORD TO BE REPRODUCED


# sidence


l Renovation hington Street


Newtor	n, ma.	02466	


RIPTION / DATE 12/08/17 ISL 1716

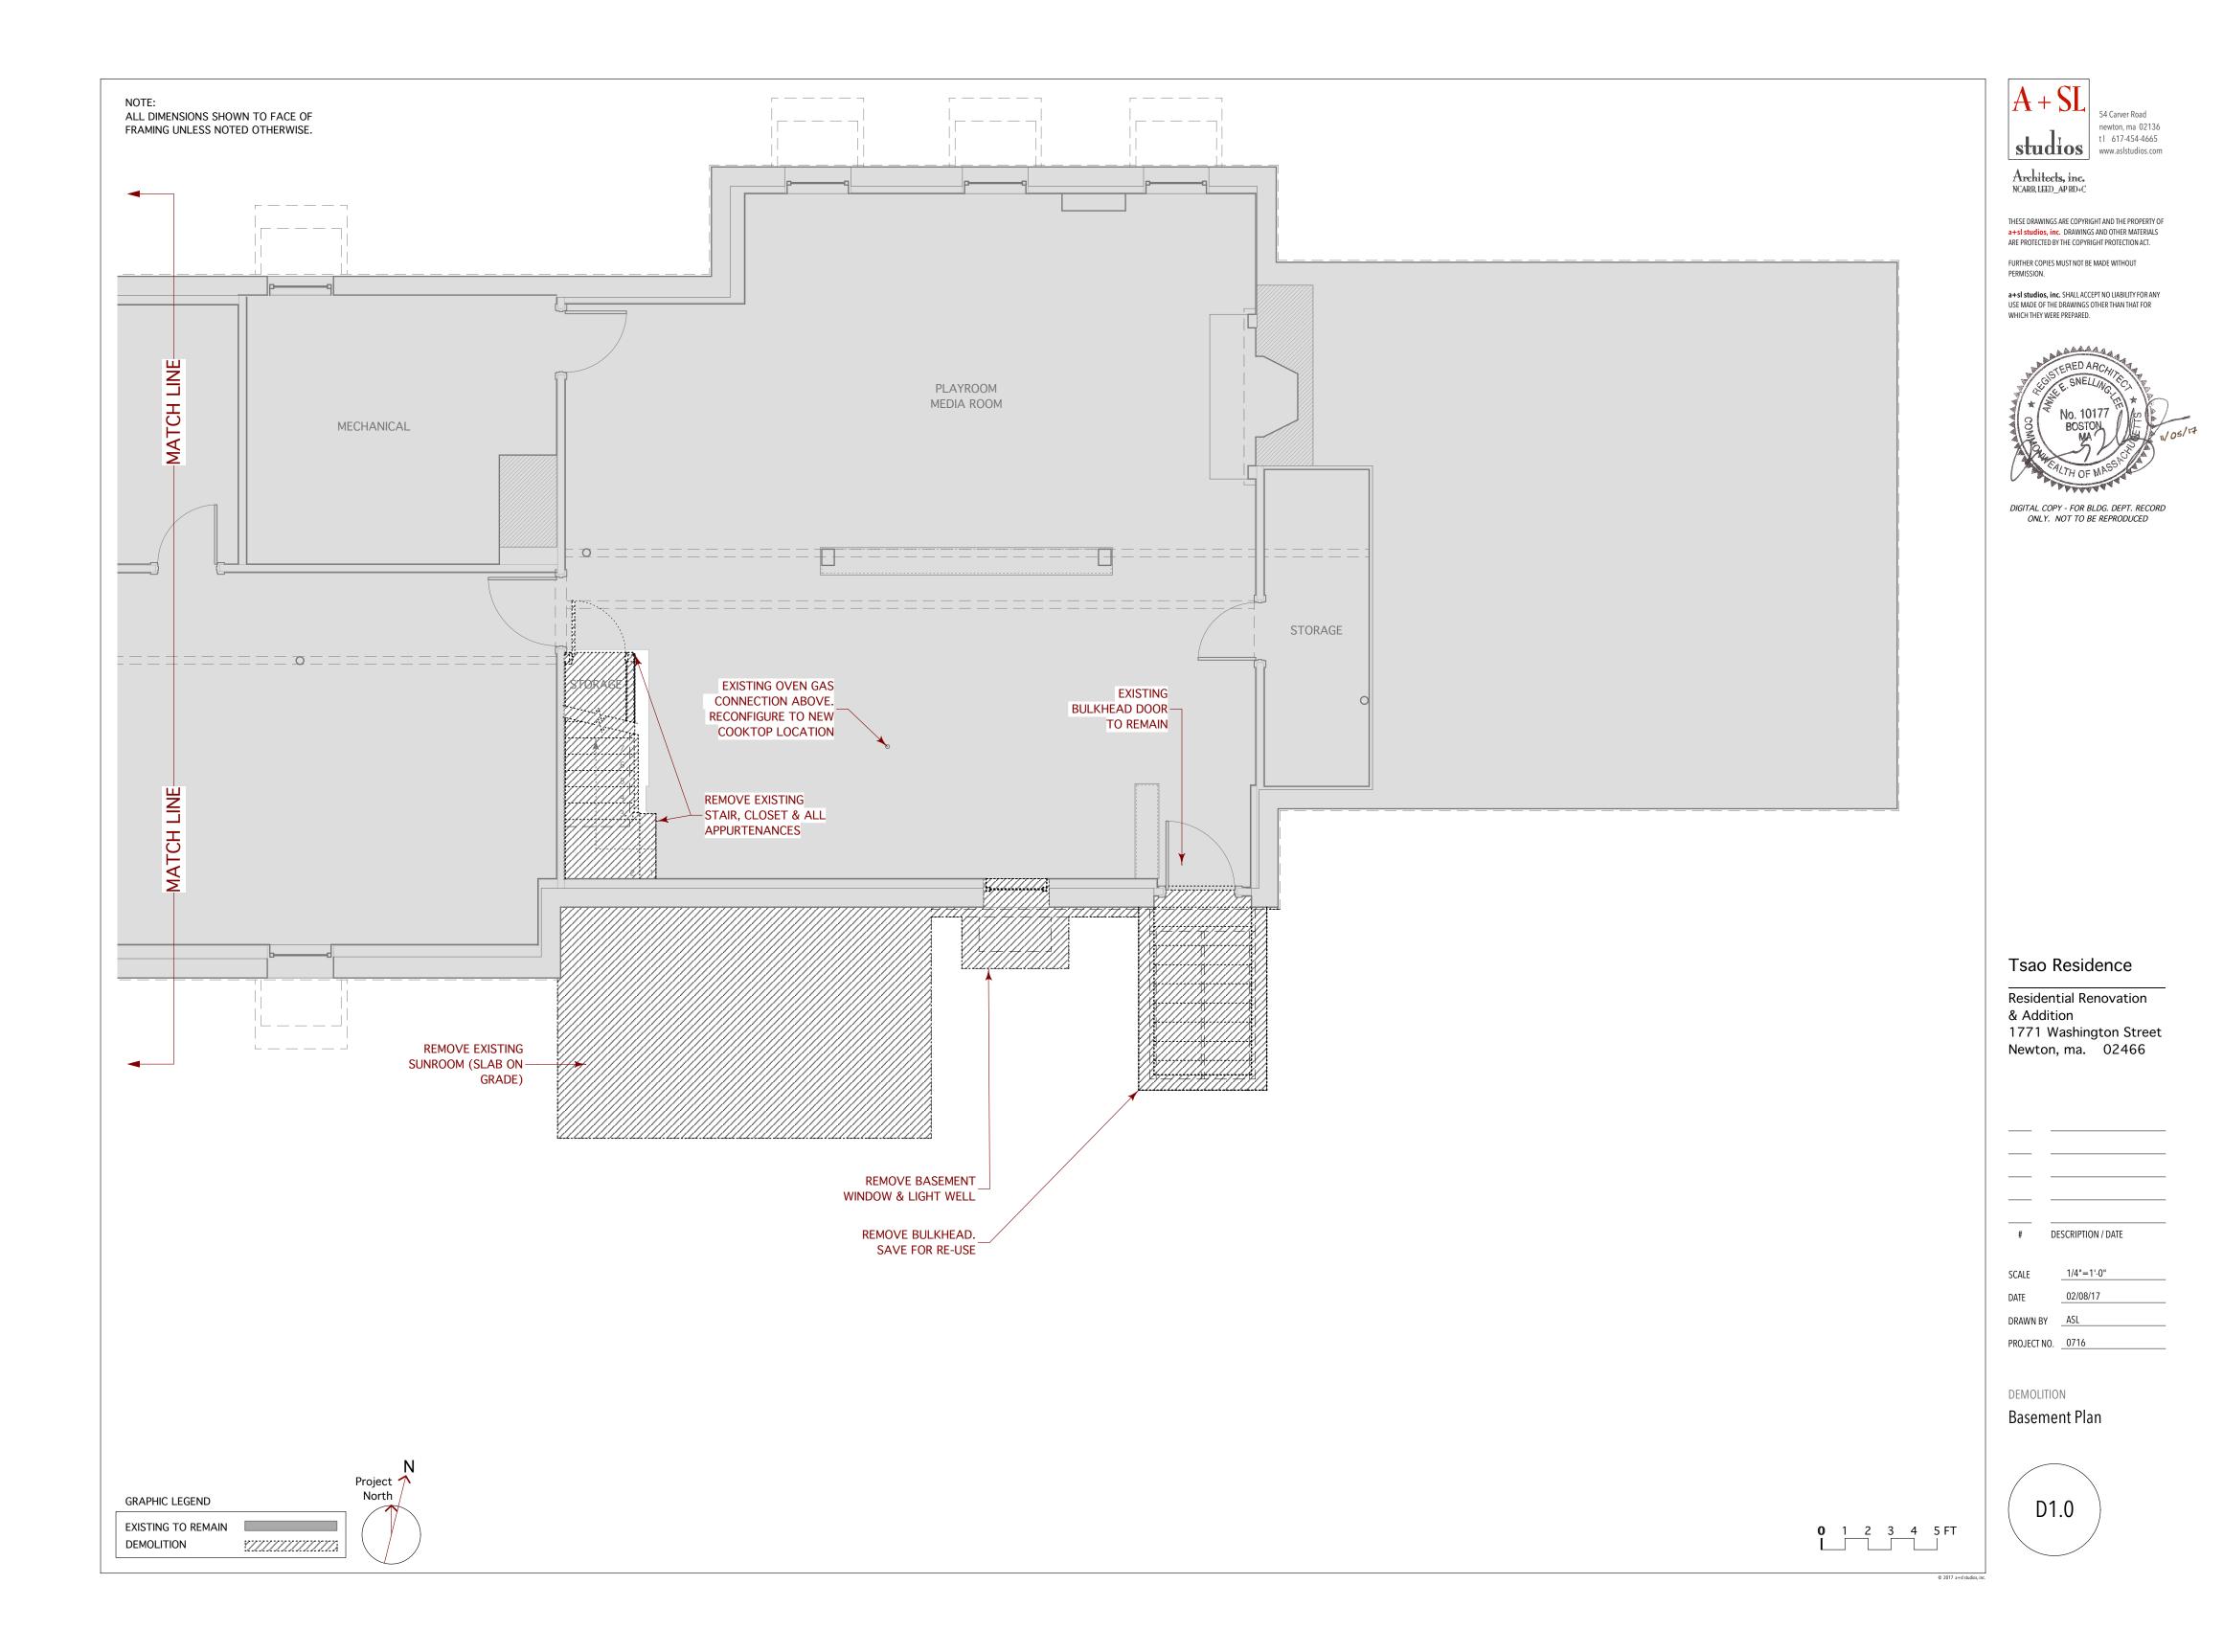

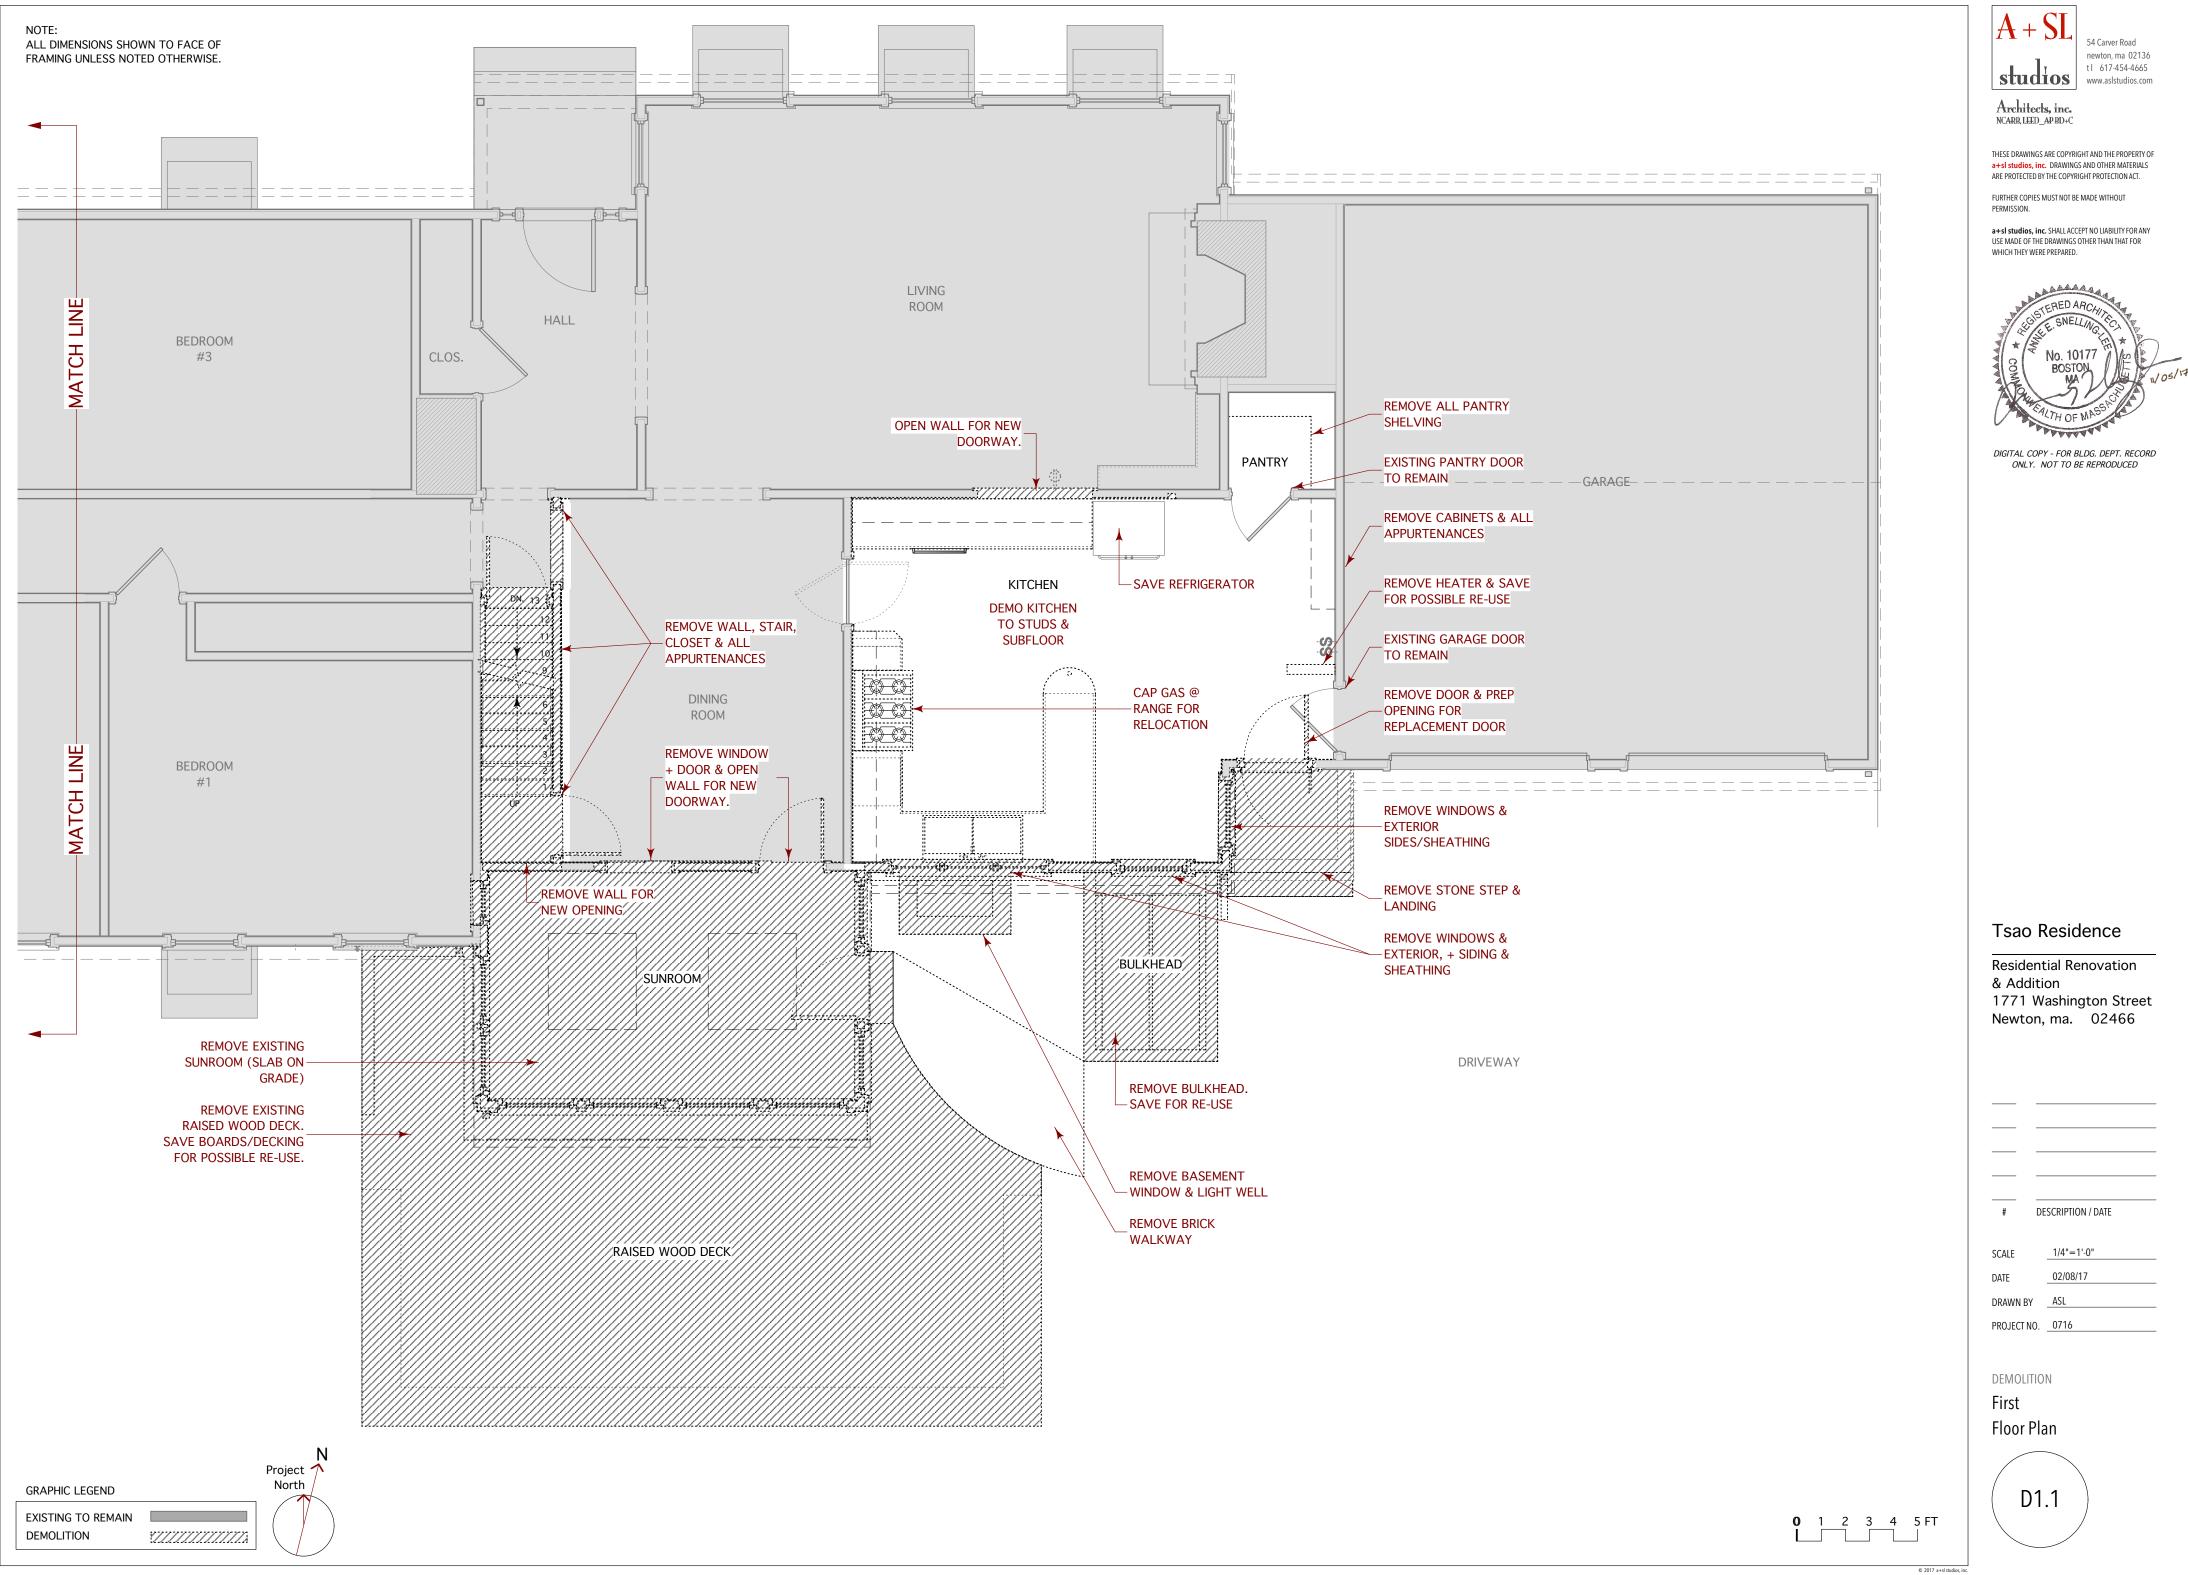

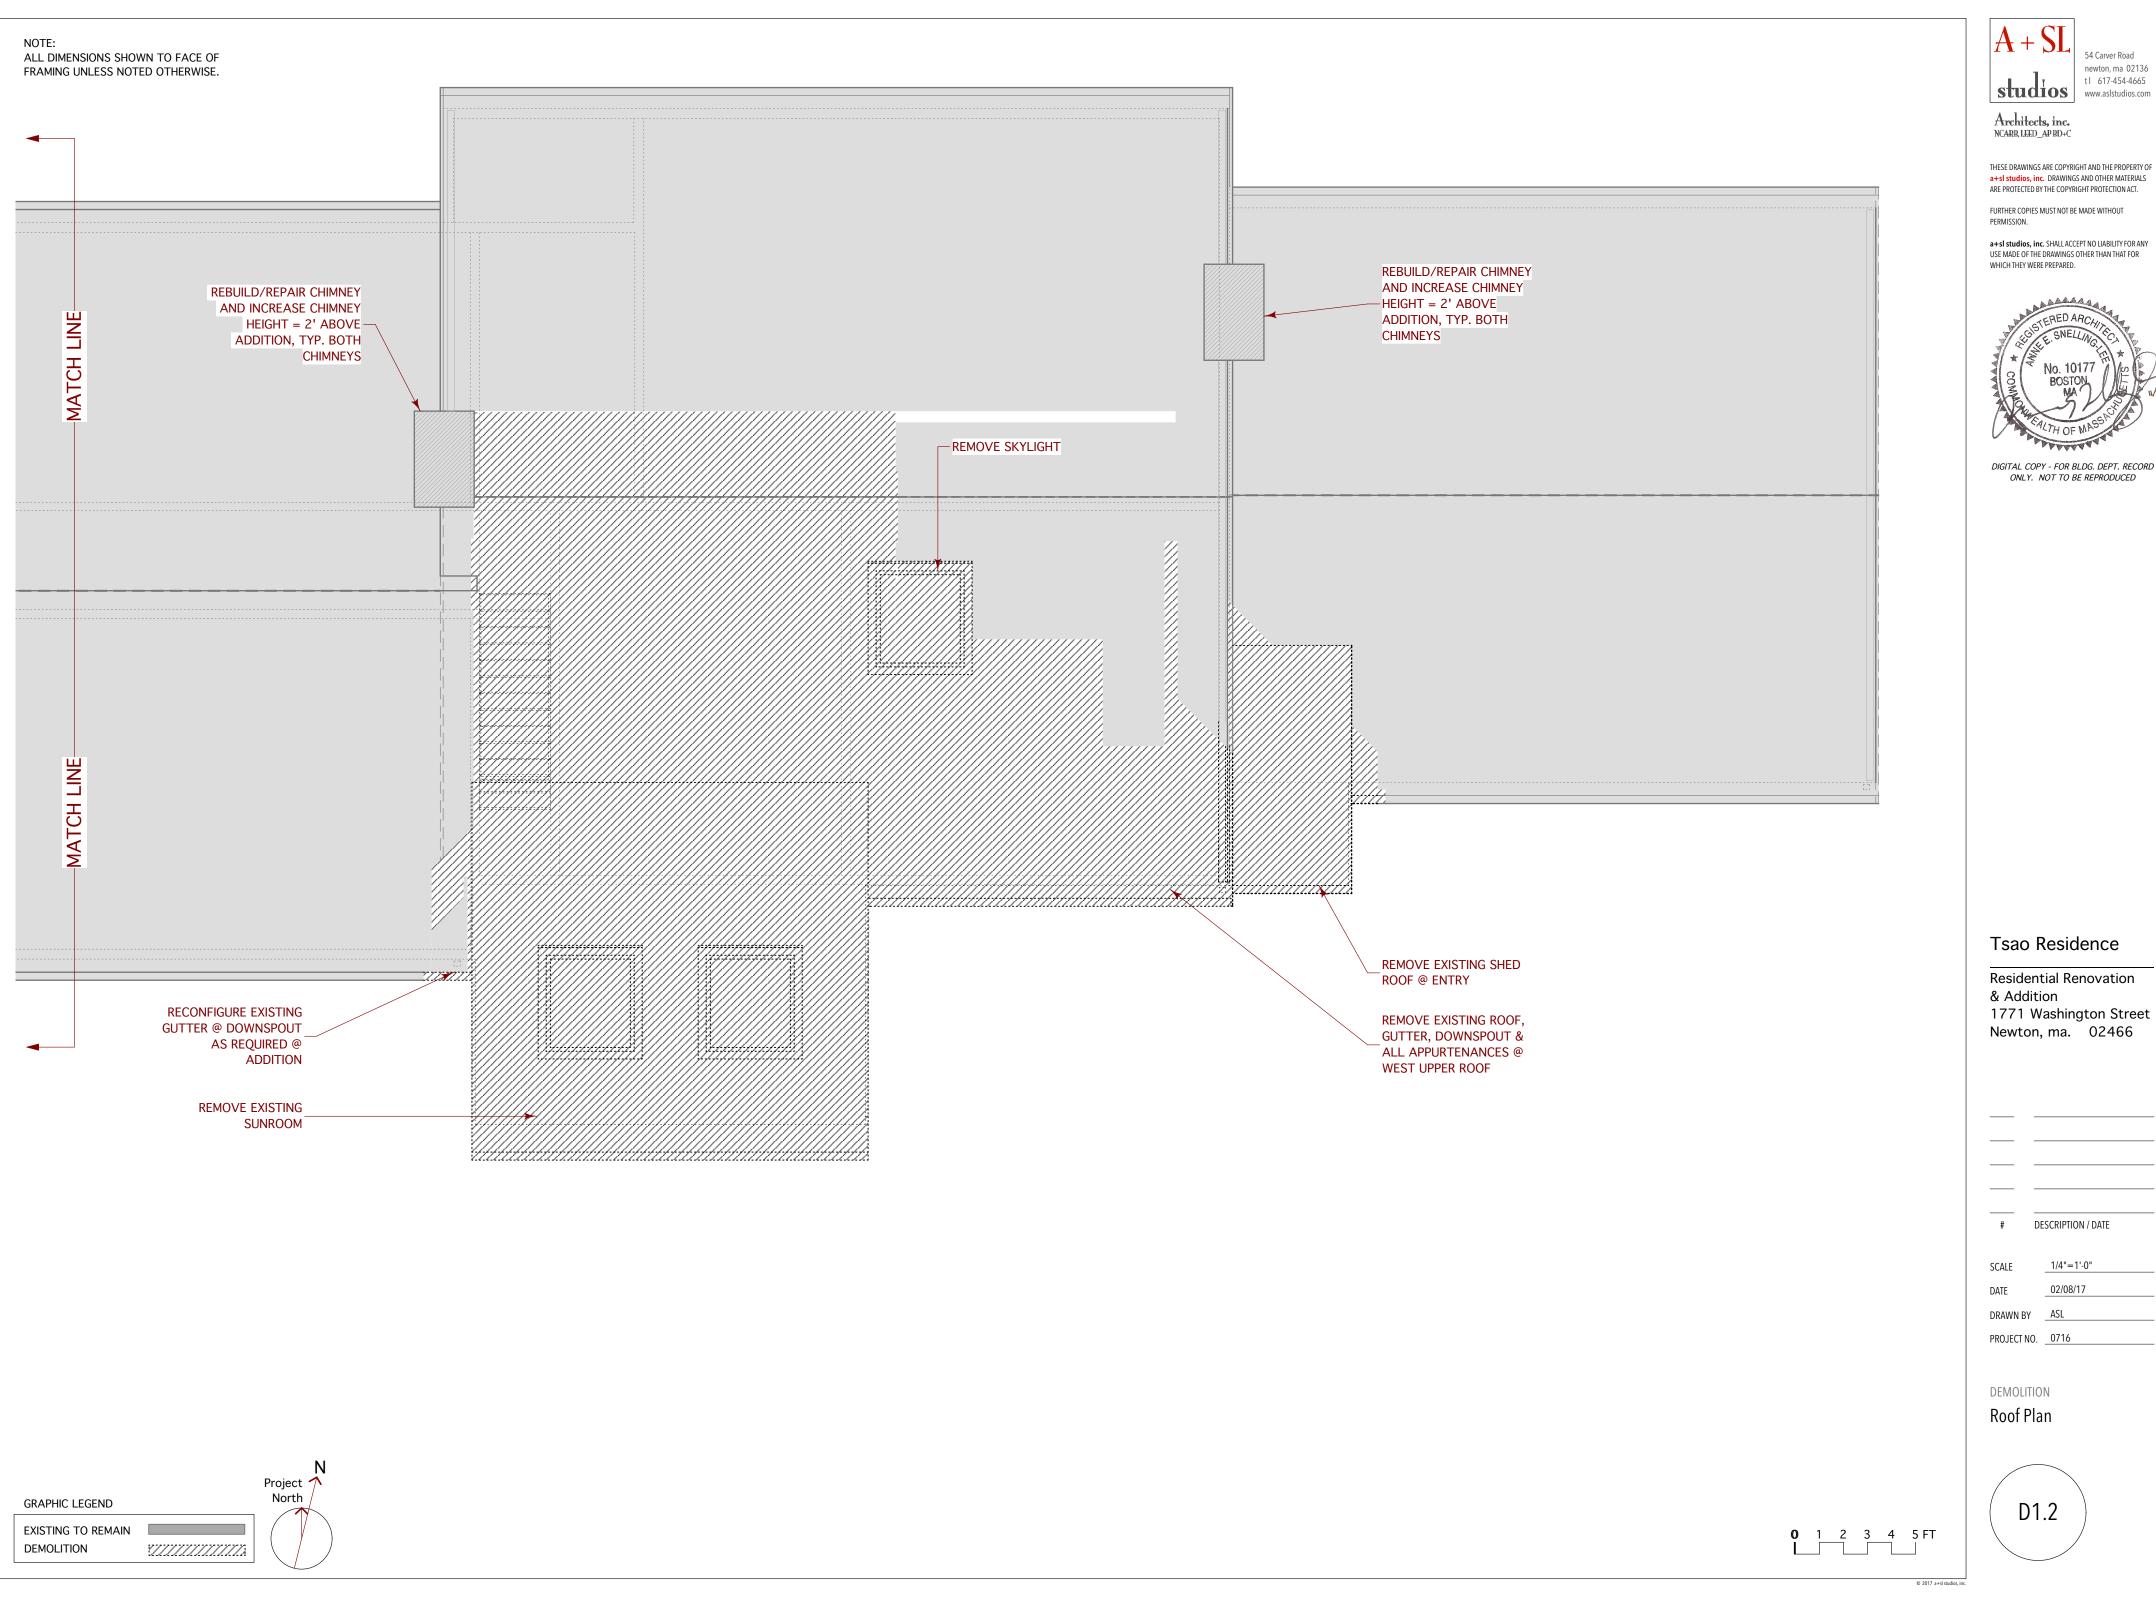

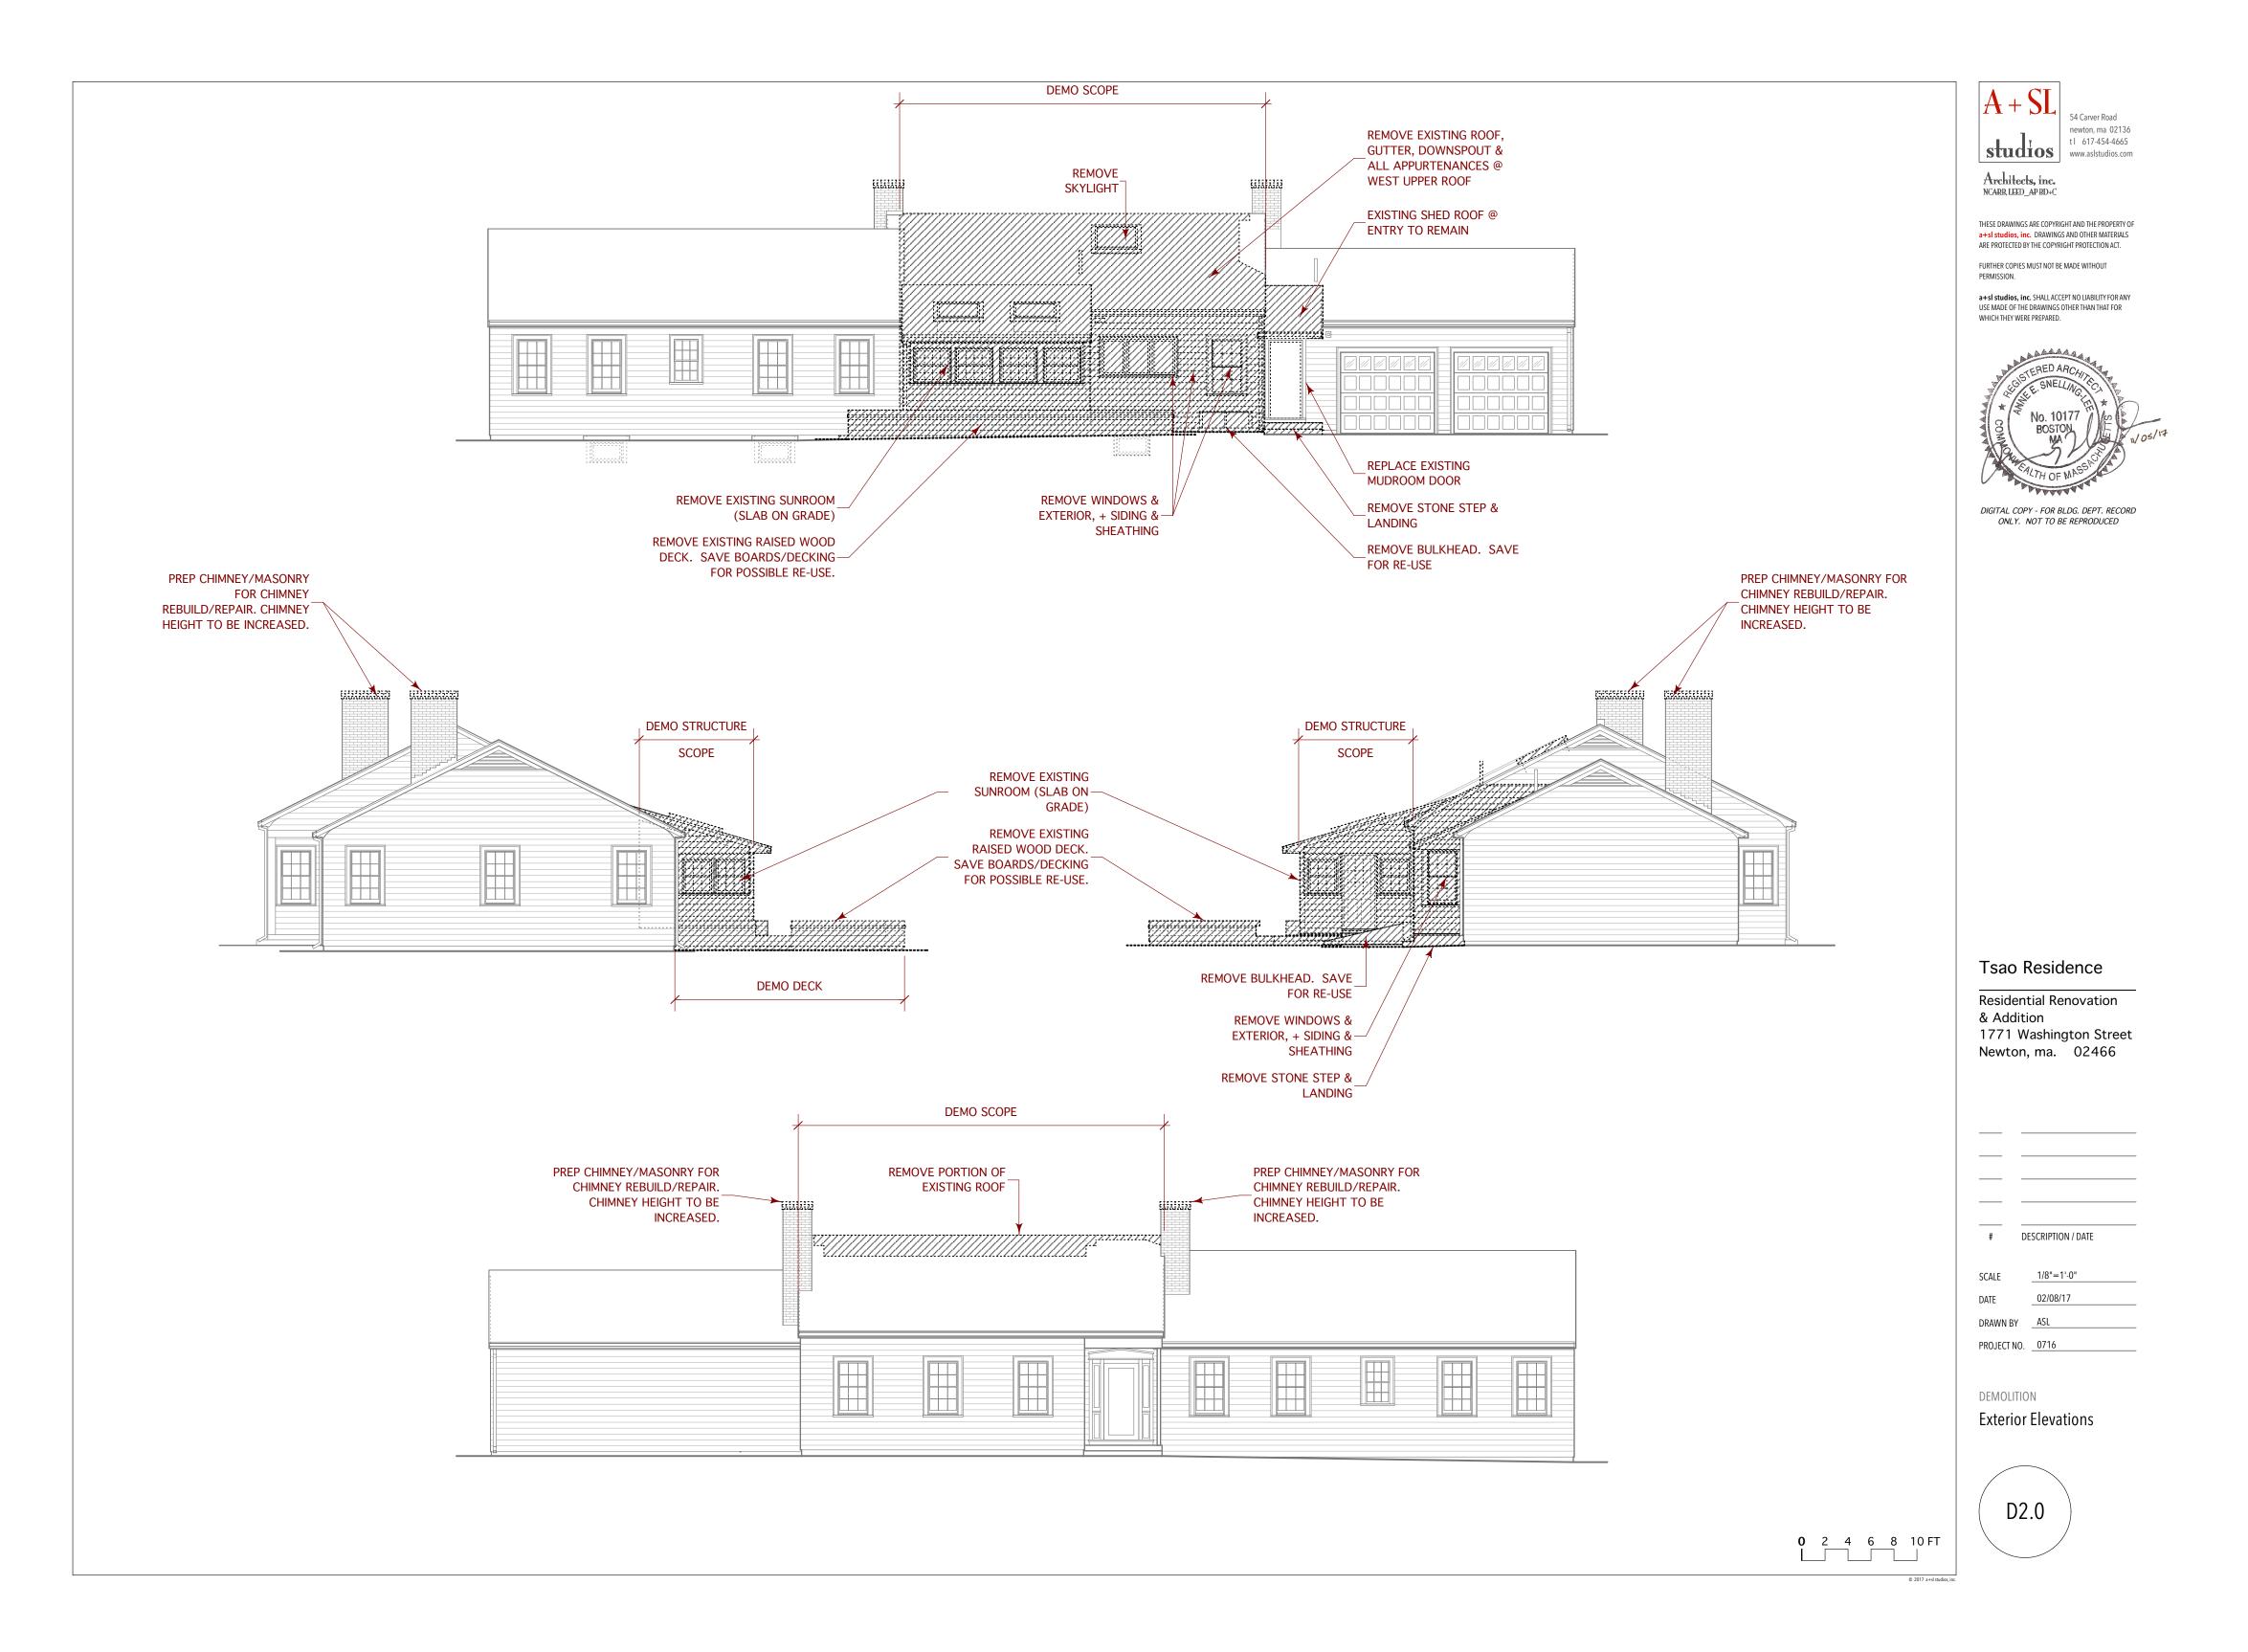

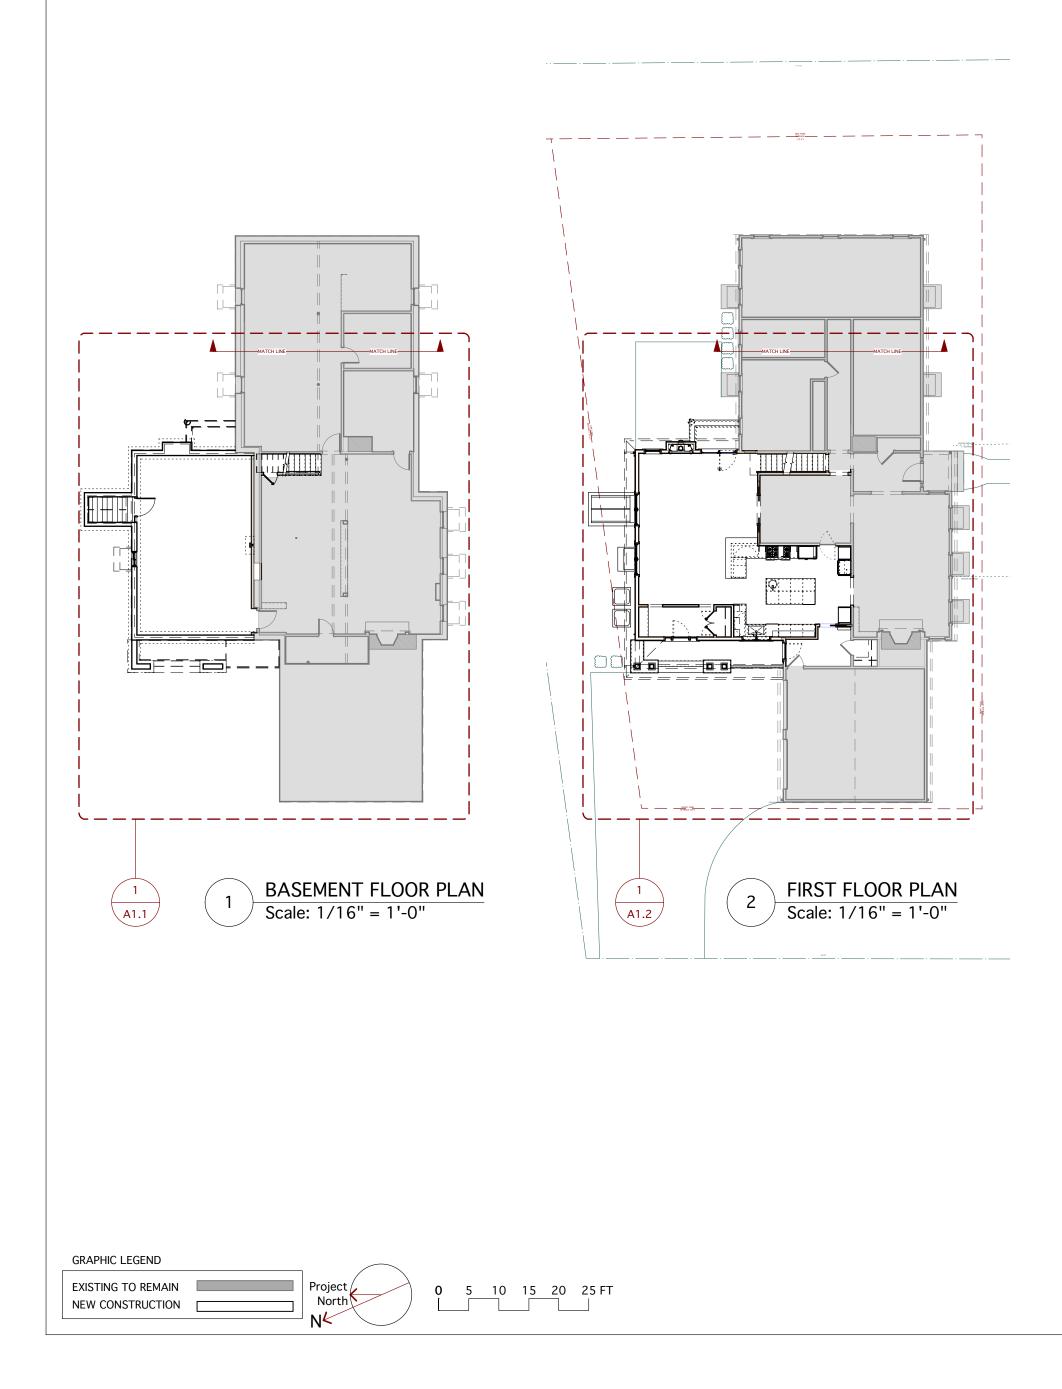





Architects, inc. NCARR, LEED\_AP BD+C


FURTHER COPIES MUST NOT BE MADE WITHOUT PERMISSION.

a+si studios, inc. SHALL ACCEPT NO LIABILITY FOR ANY USE MADE OF THE DRAWINGS OTHER THAN THAT FOR WHICH THEY WERE PREPARED.

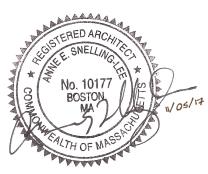

DIGITAL COPY - FOR BLDG. DEPT. RECORD ONLY. NOT TO BE REPRODUCED

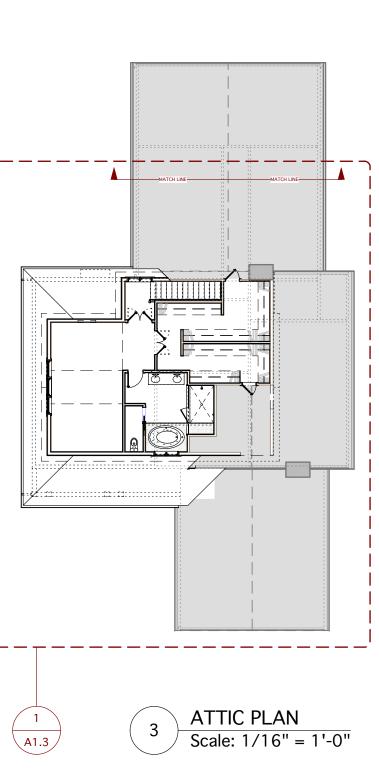

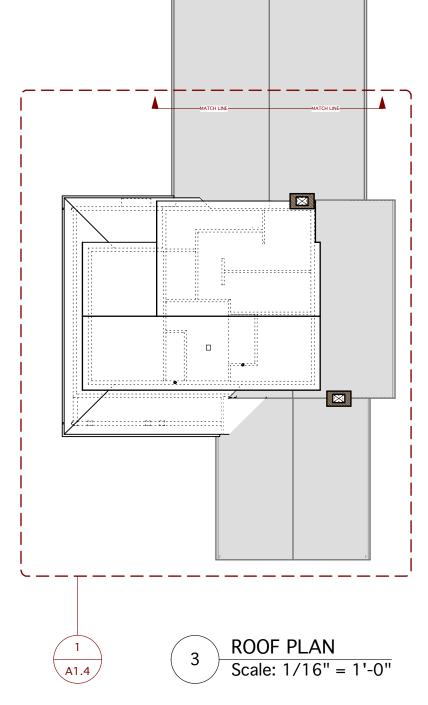

### Tsao Residence

Residential Renovation & Addition 1771 Washington Street Newton, ma. 02466


 # DE	SCRIPTION / DATE
SCALE	1/4"=1'-0"
DATE	02/08/17
DRAWN BY	ASL
PROJECT NO.	0716


FLOOR PLANS Small Scale Plans




© 2017 a+sl studios, inc.


THESE DRAWINGS ARE COPYRIGHT AND THE PROPERTY OF a+sl studios, inc. DRAWINGS AND OTHER MATERIALS ARE PROTECTED BY THE COPYRIGHT PROTECTION ACT.

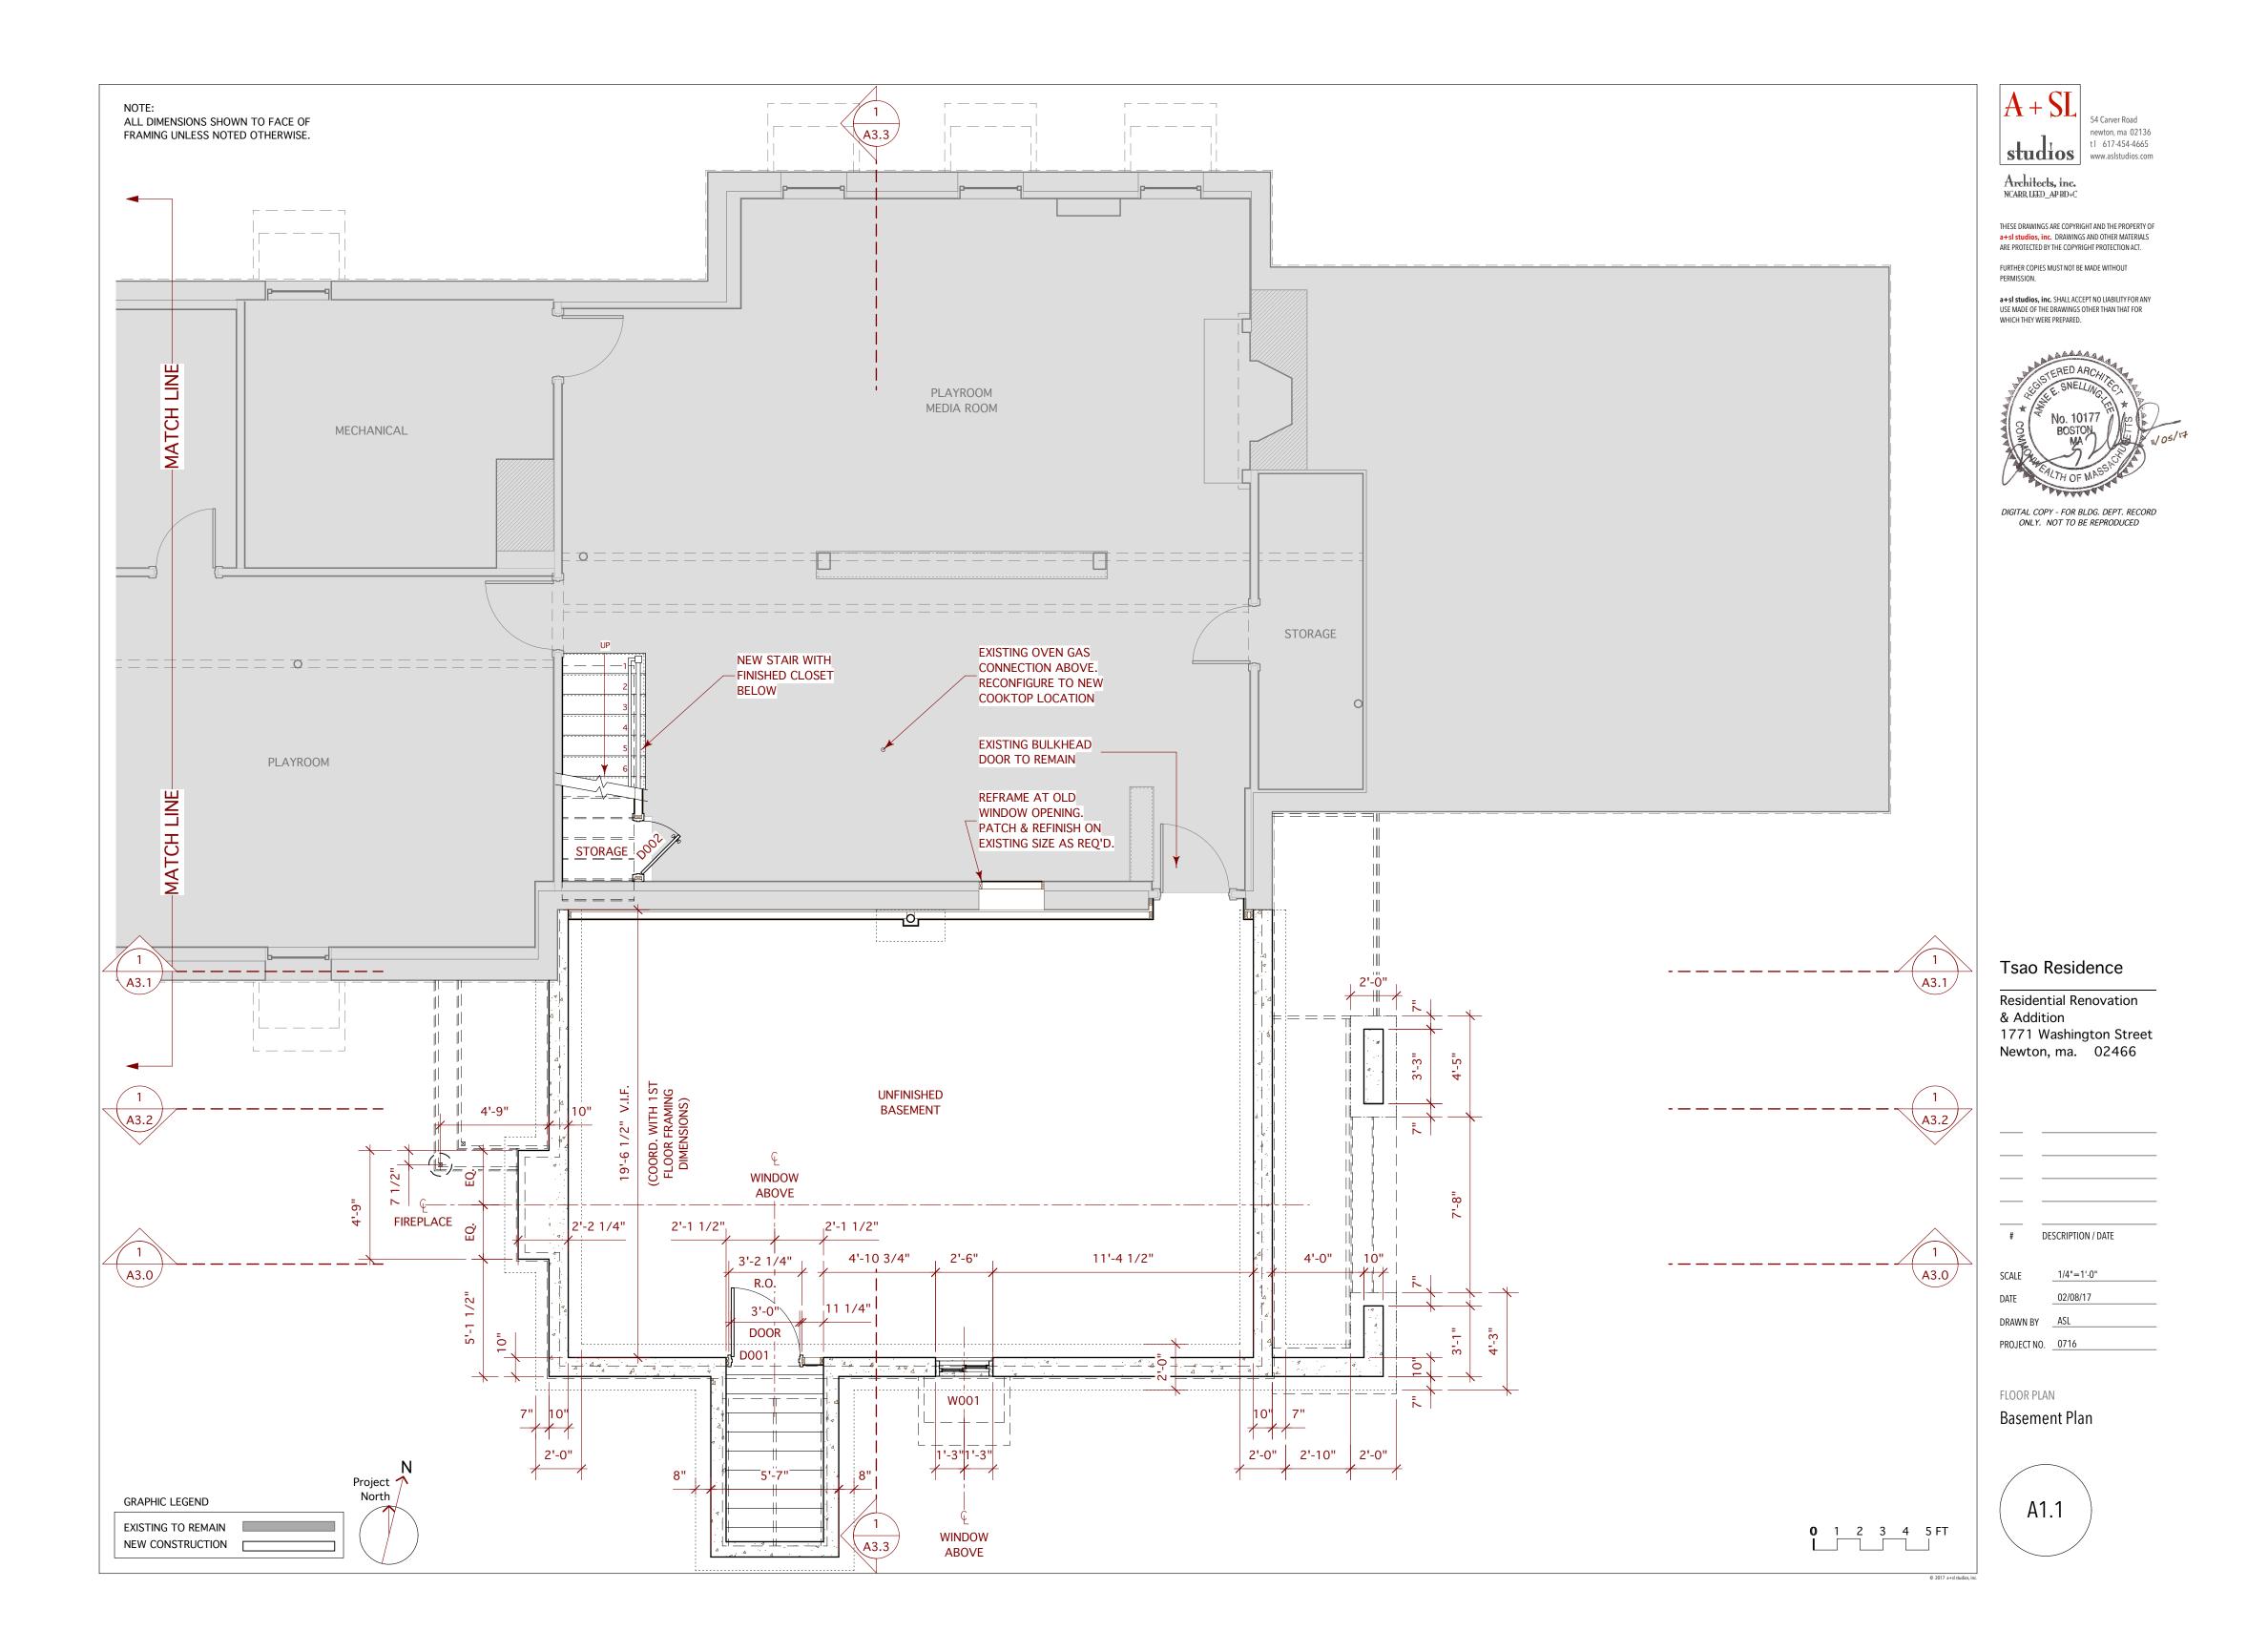


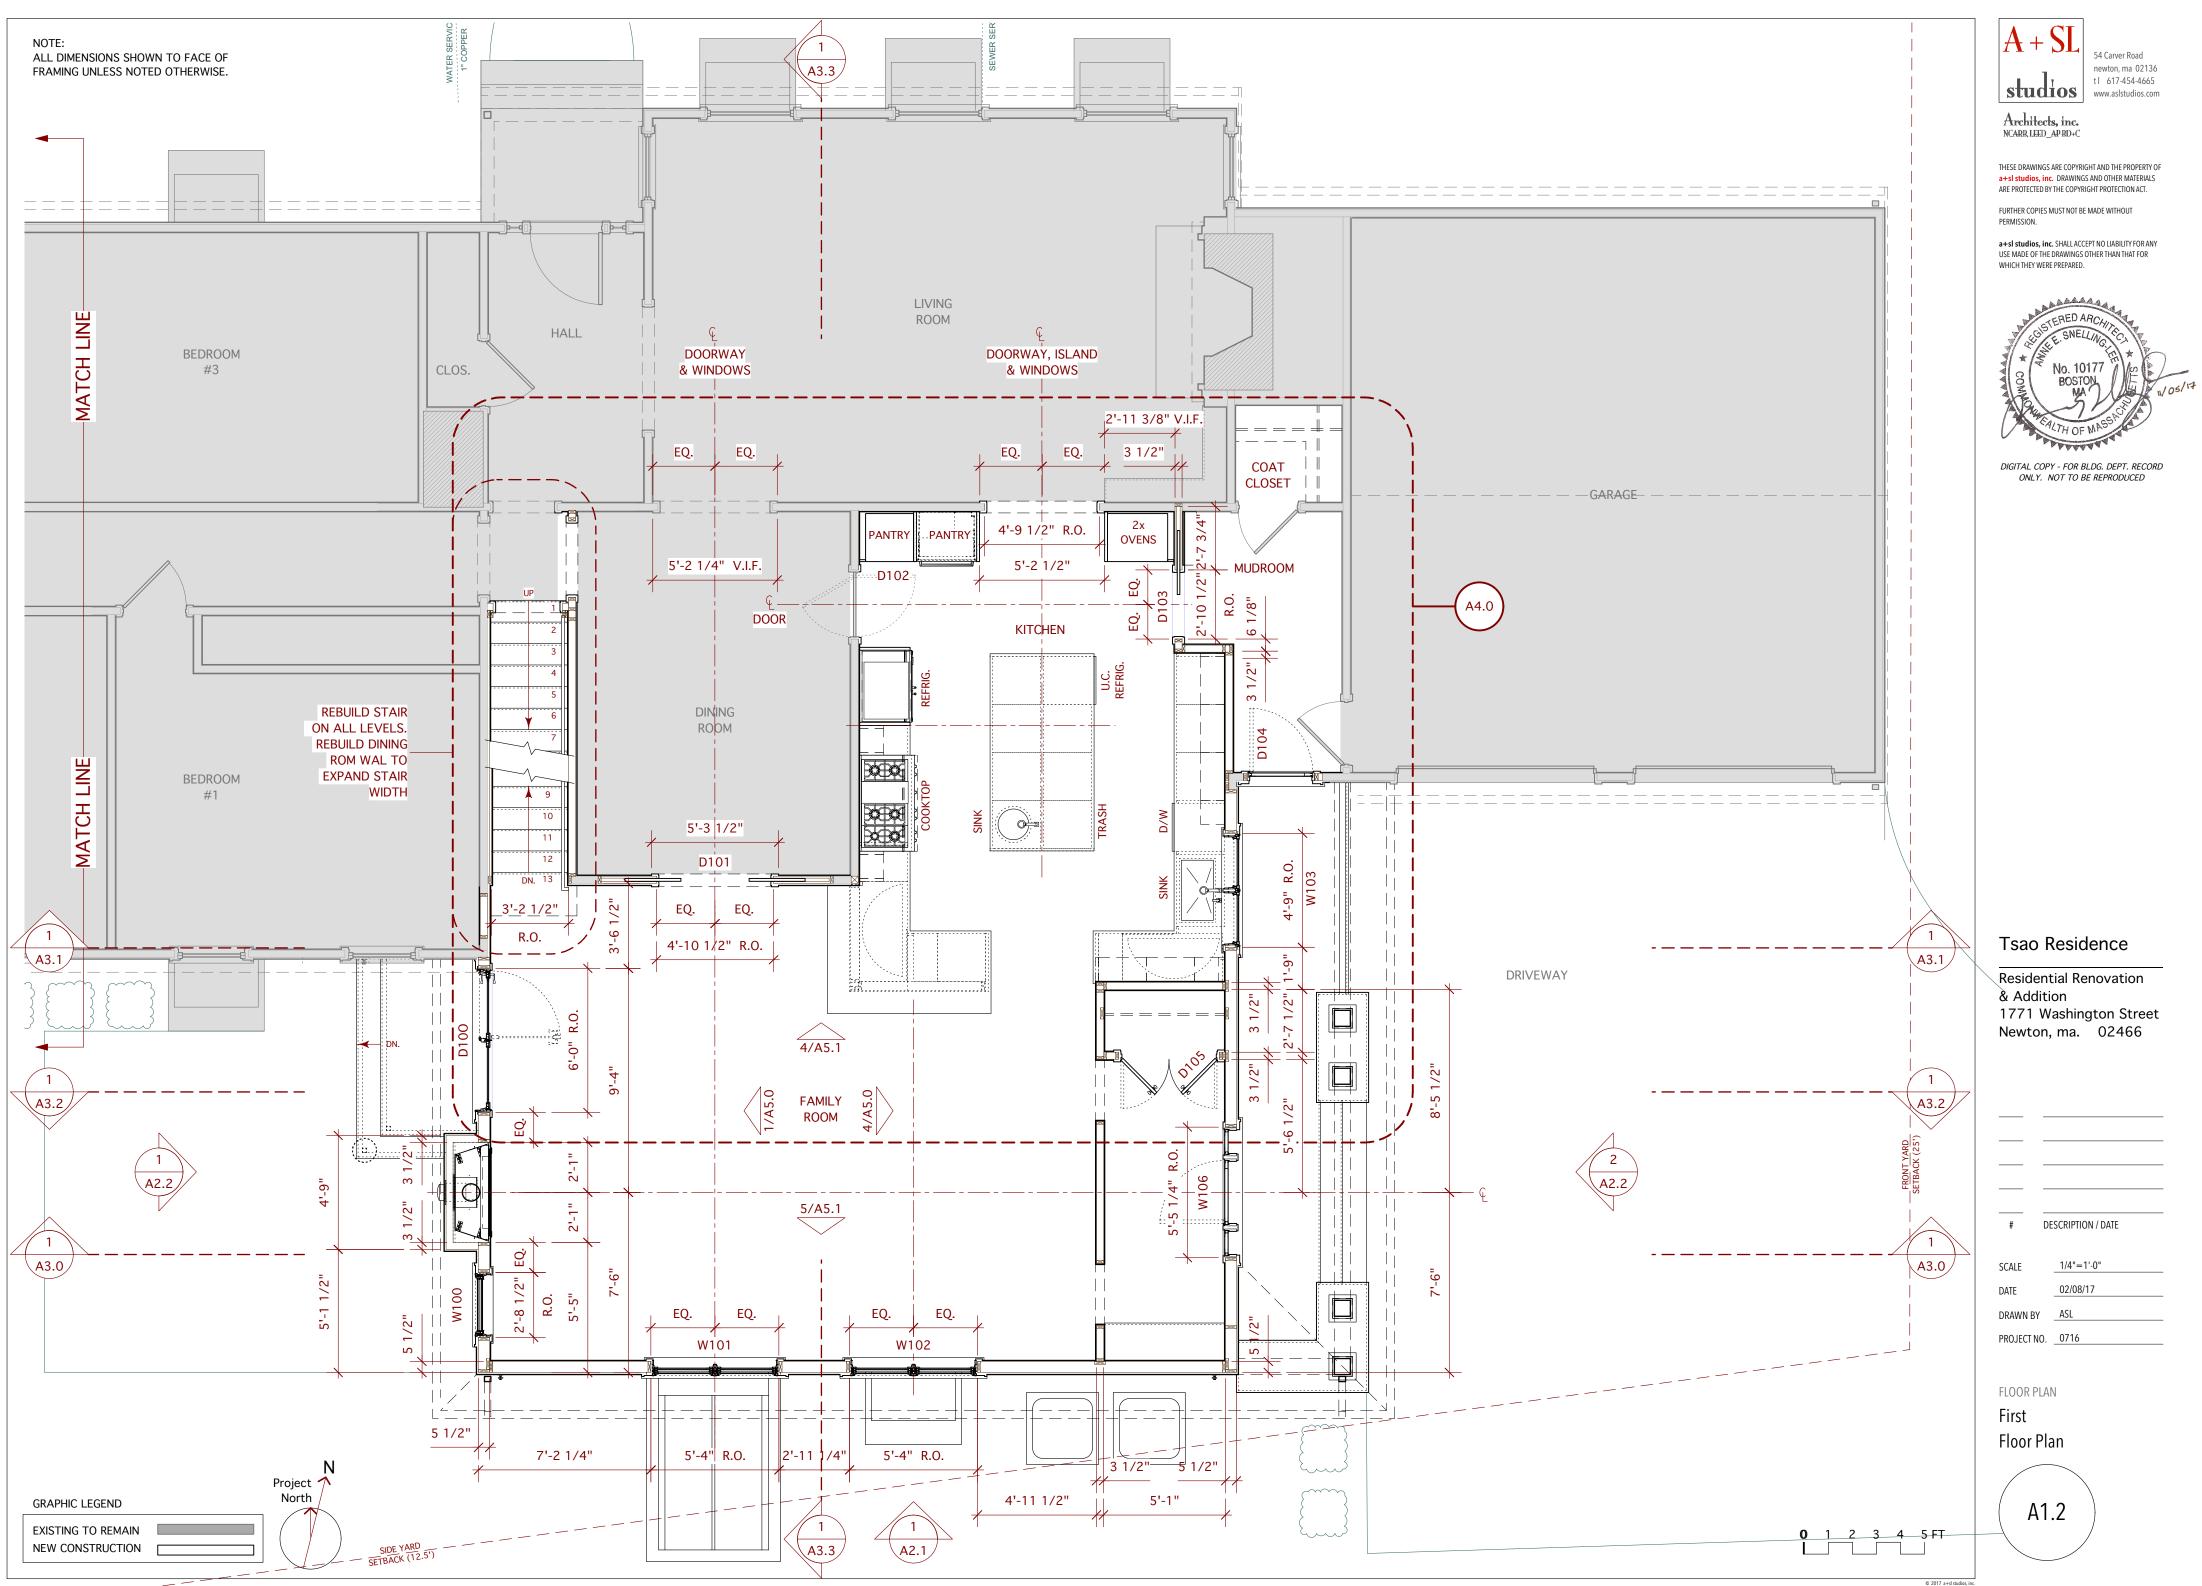



\_\_\_\_

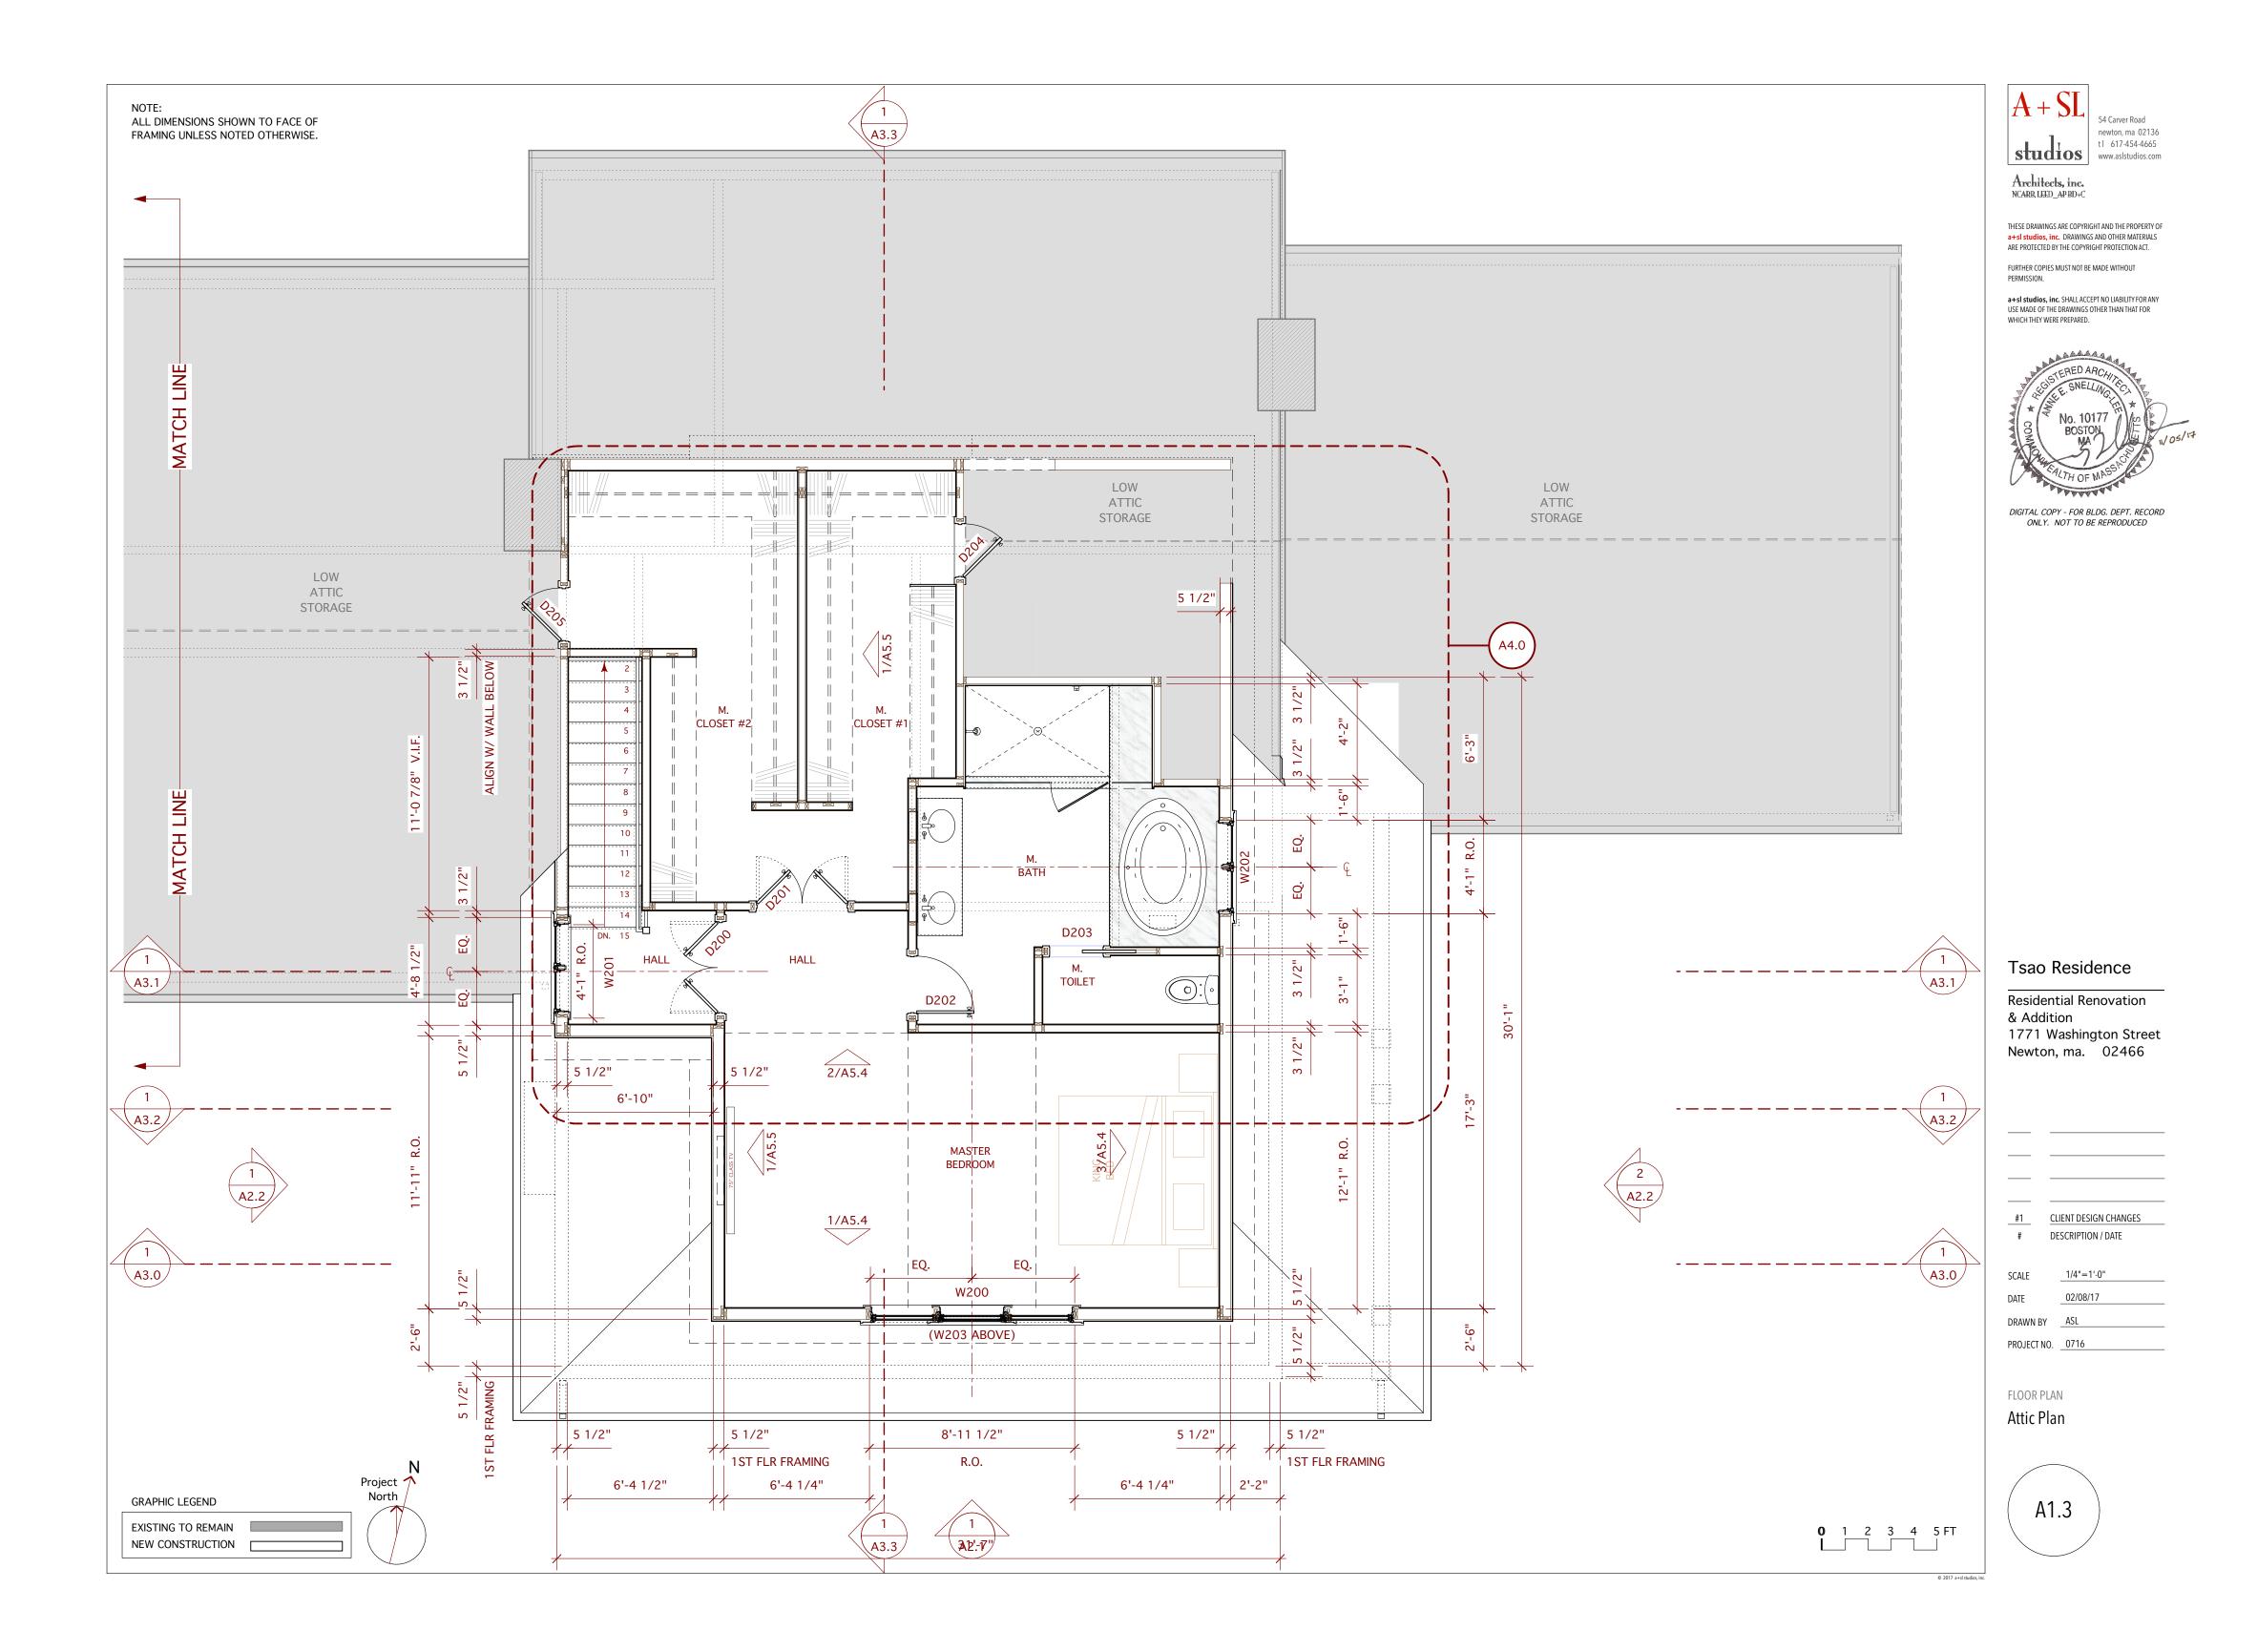


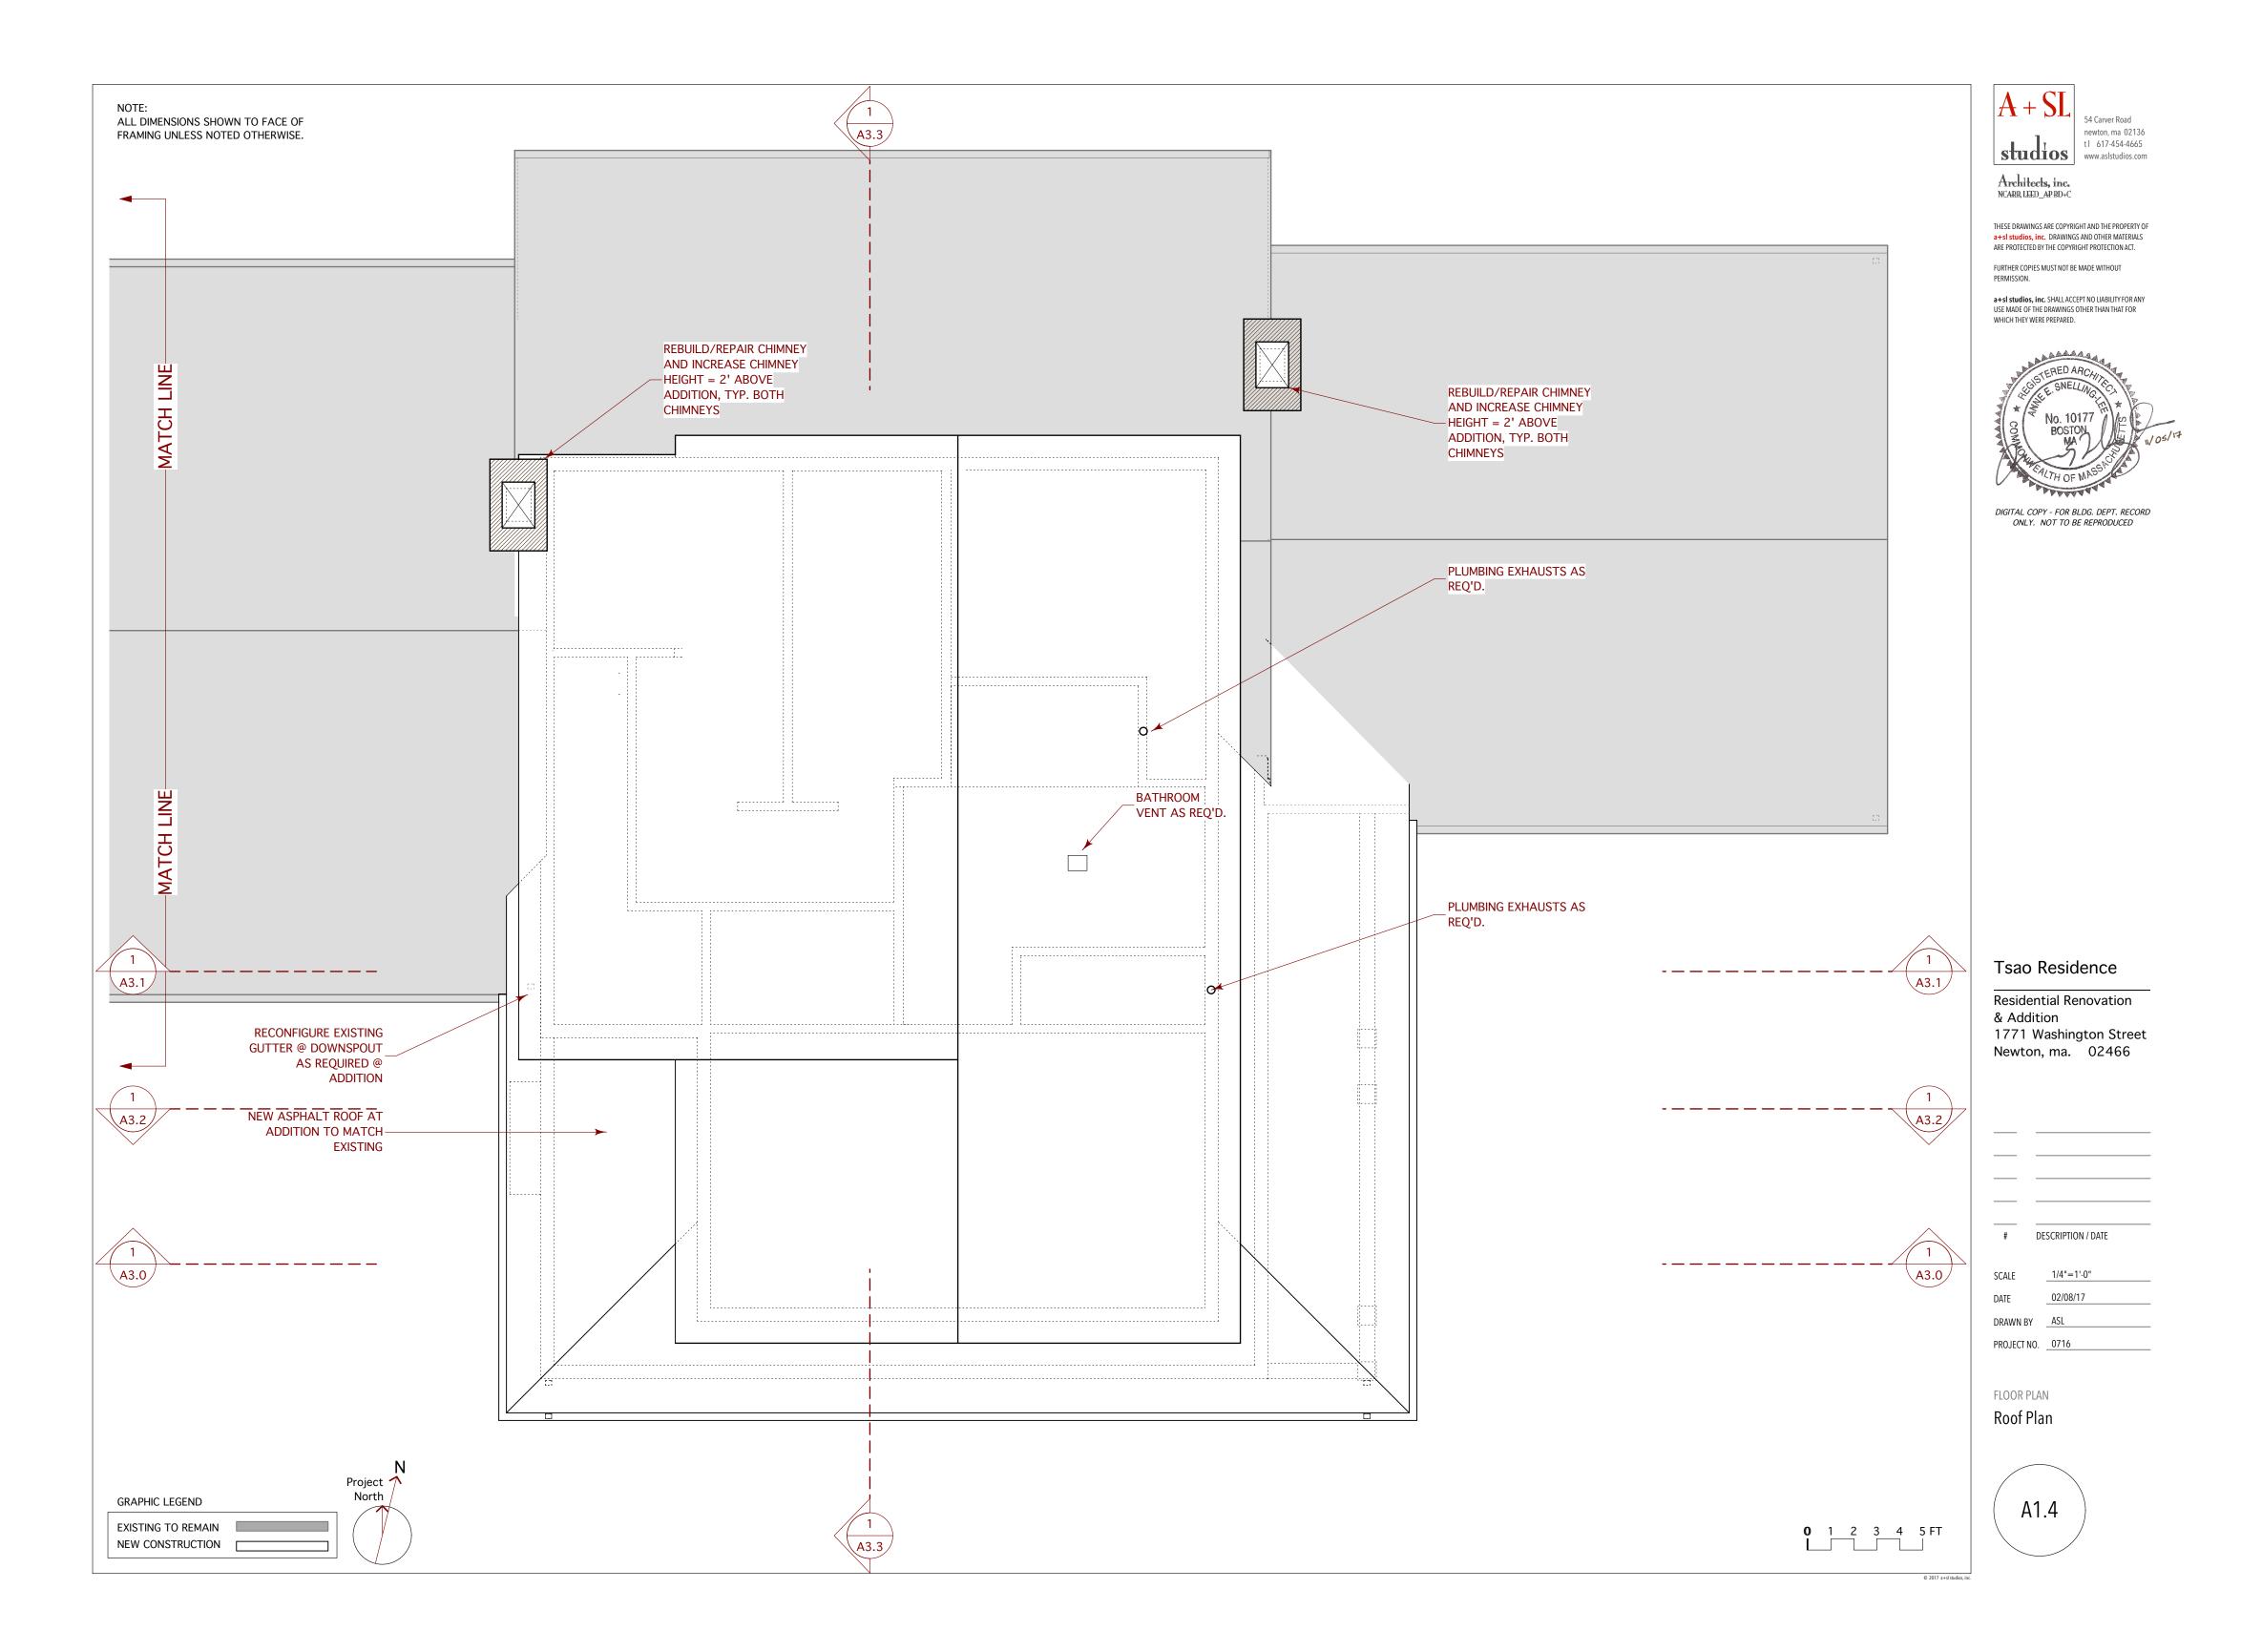


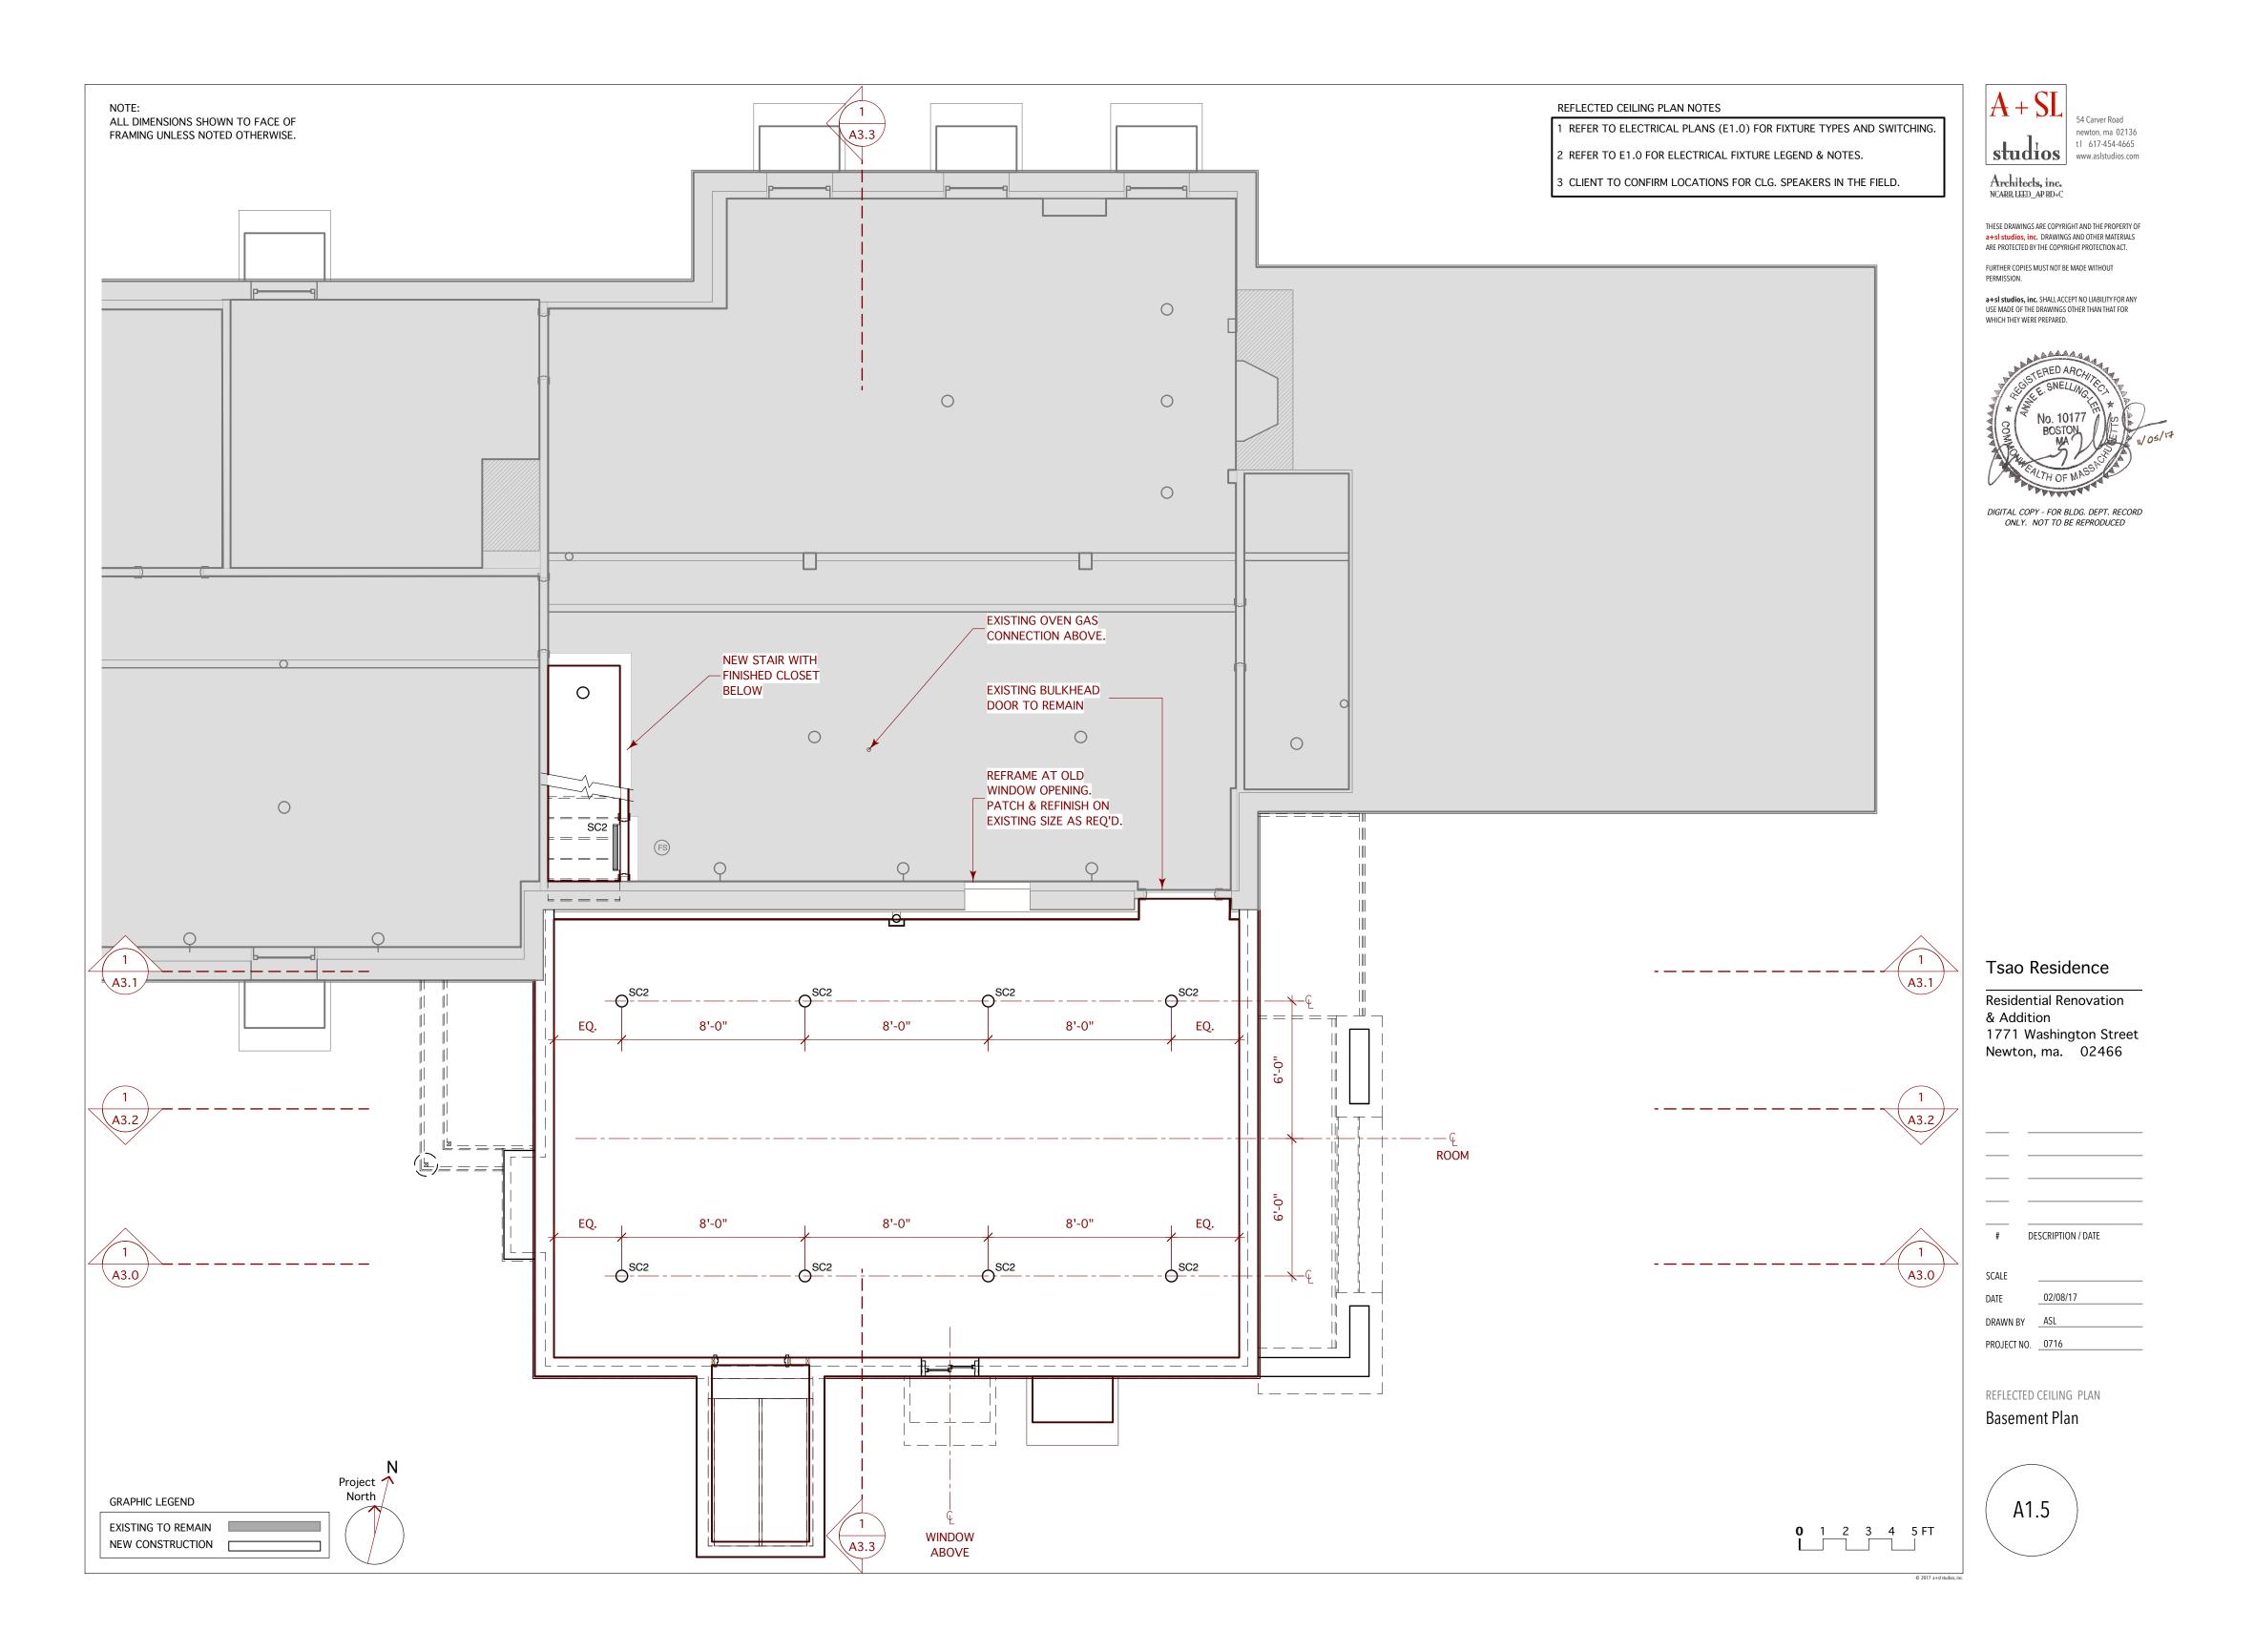


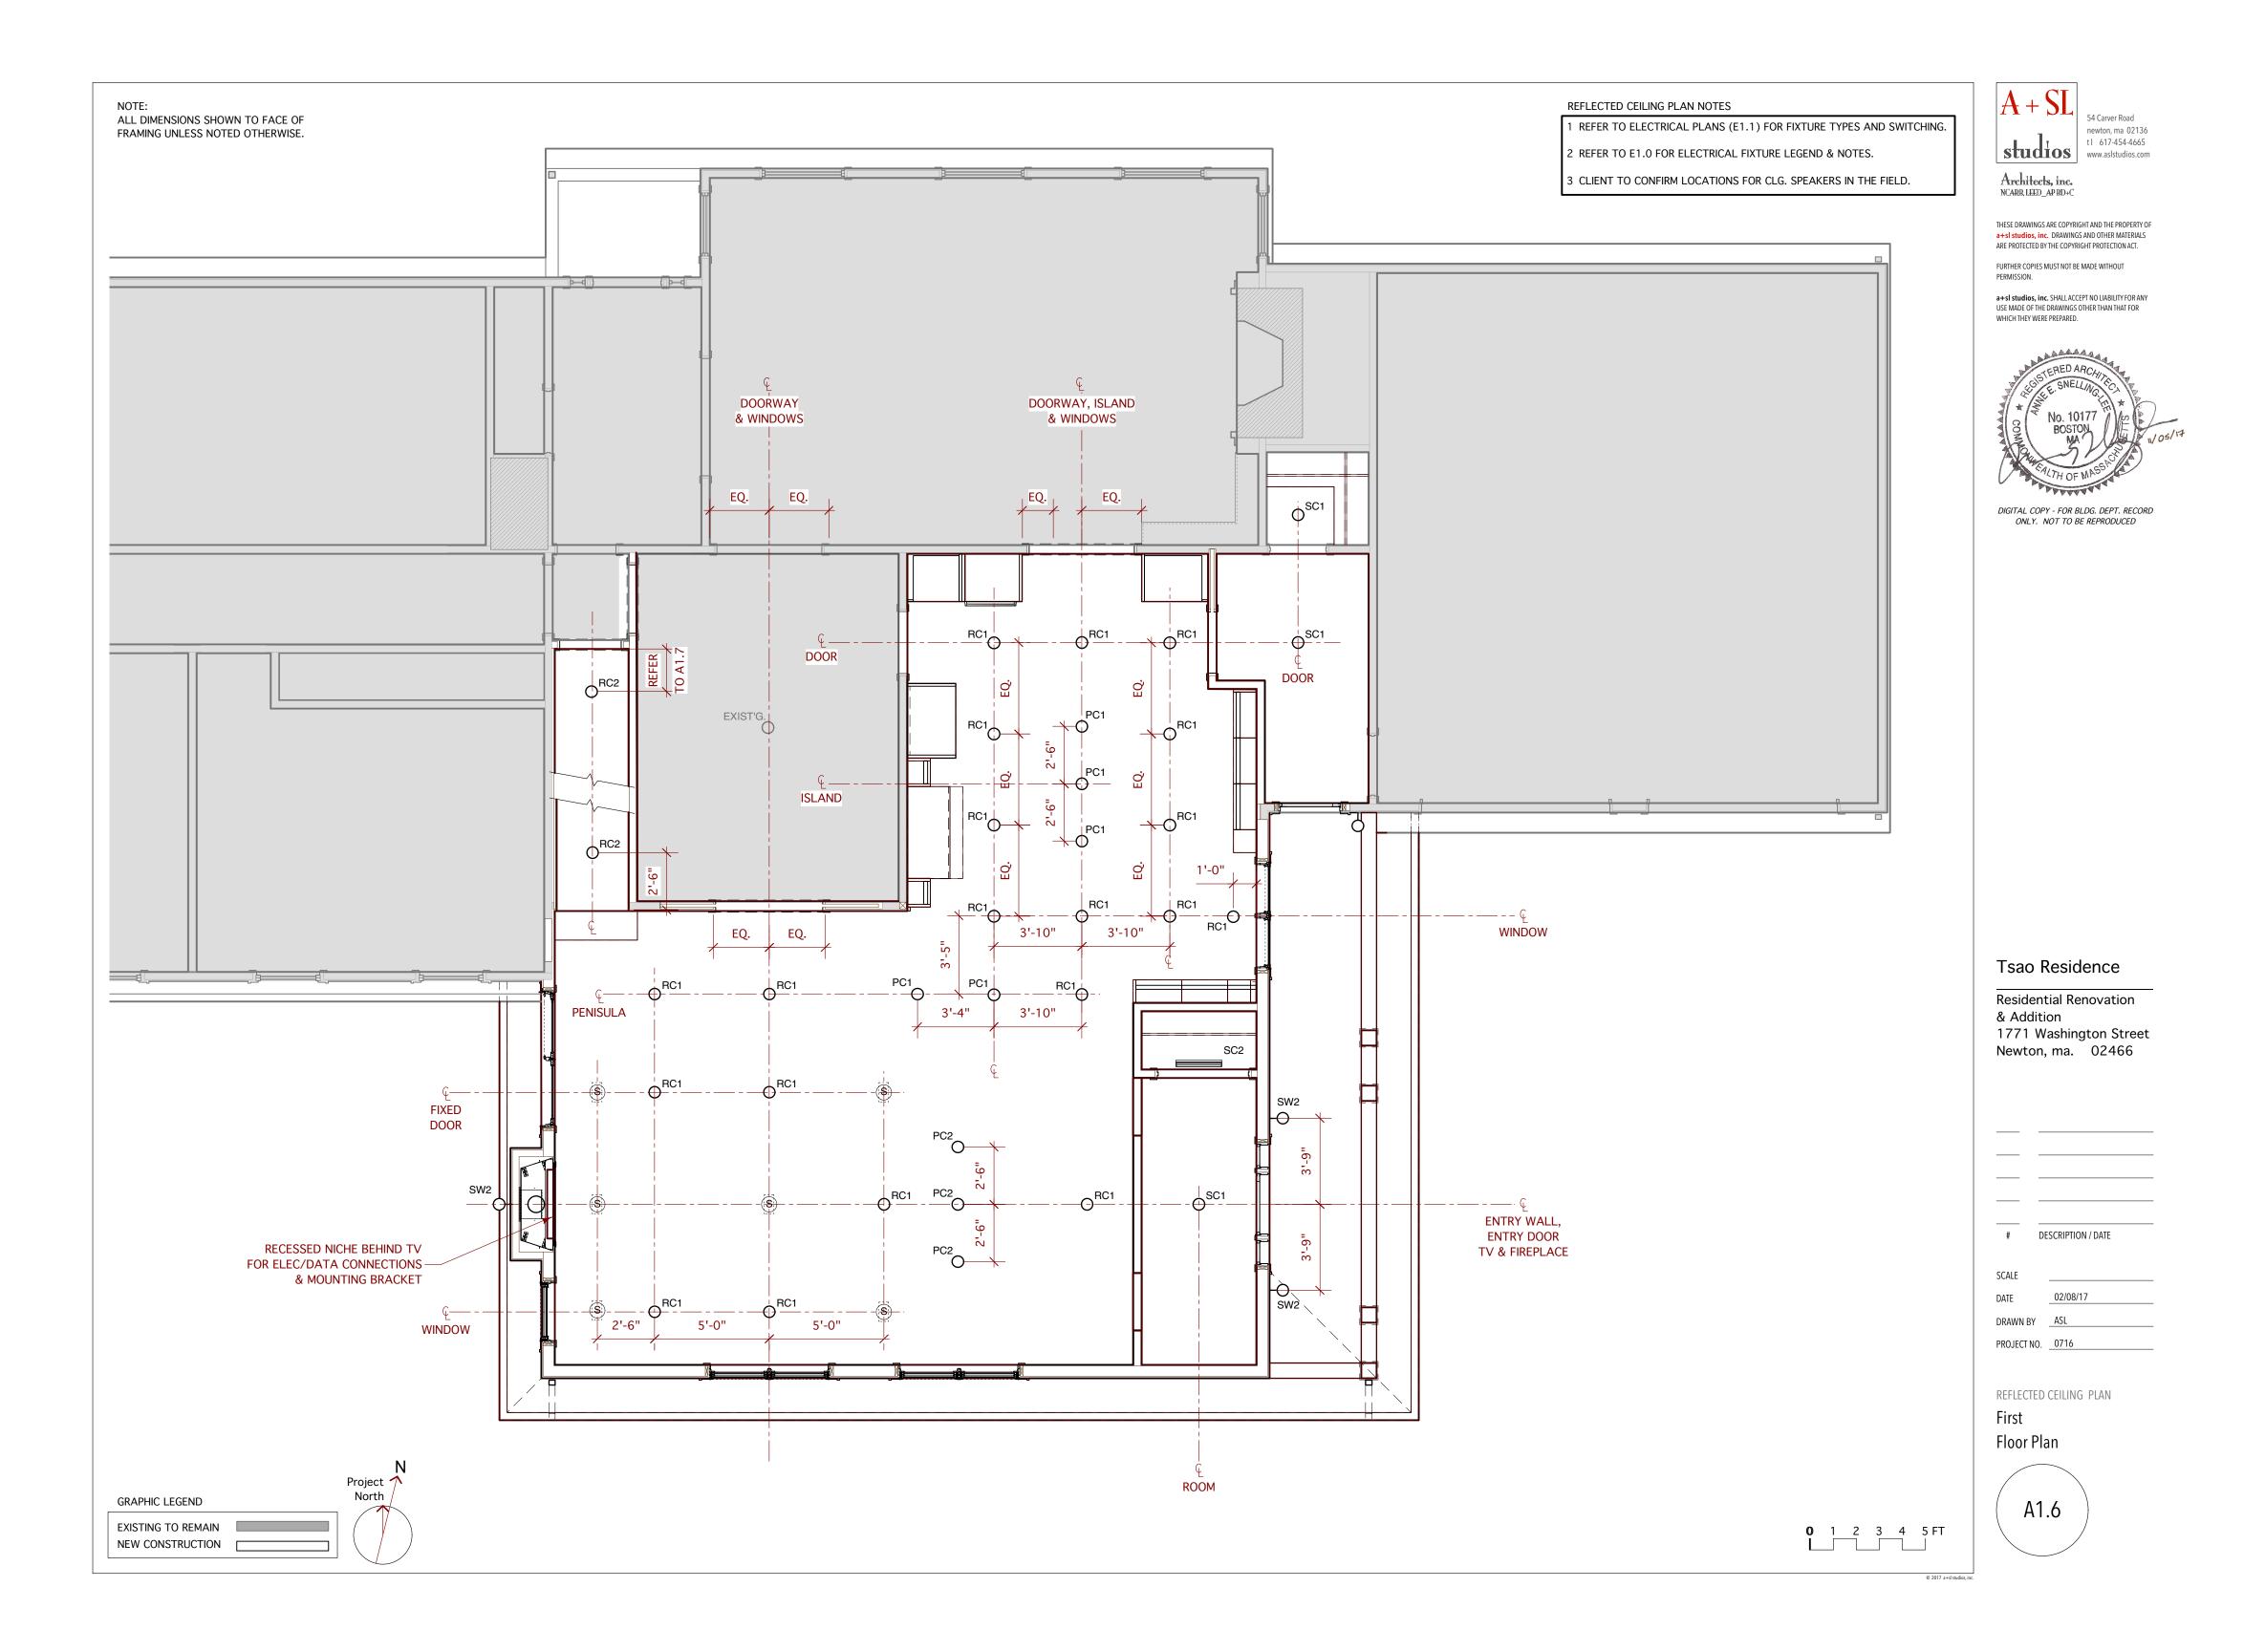

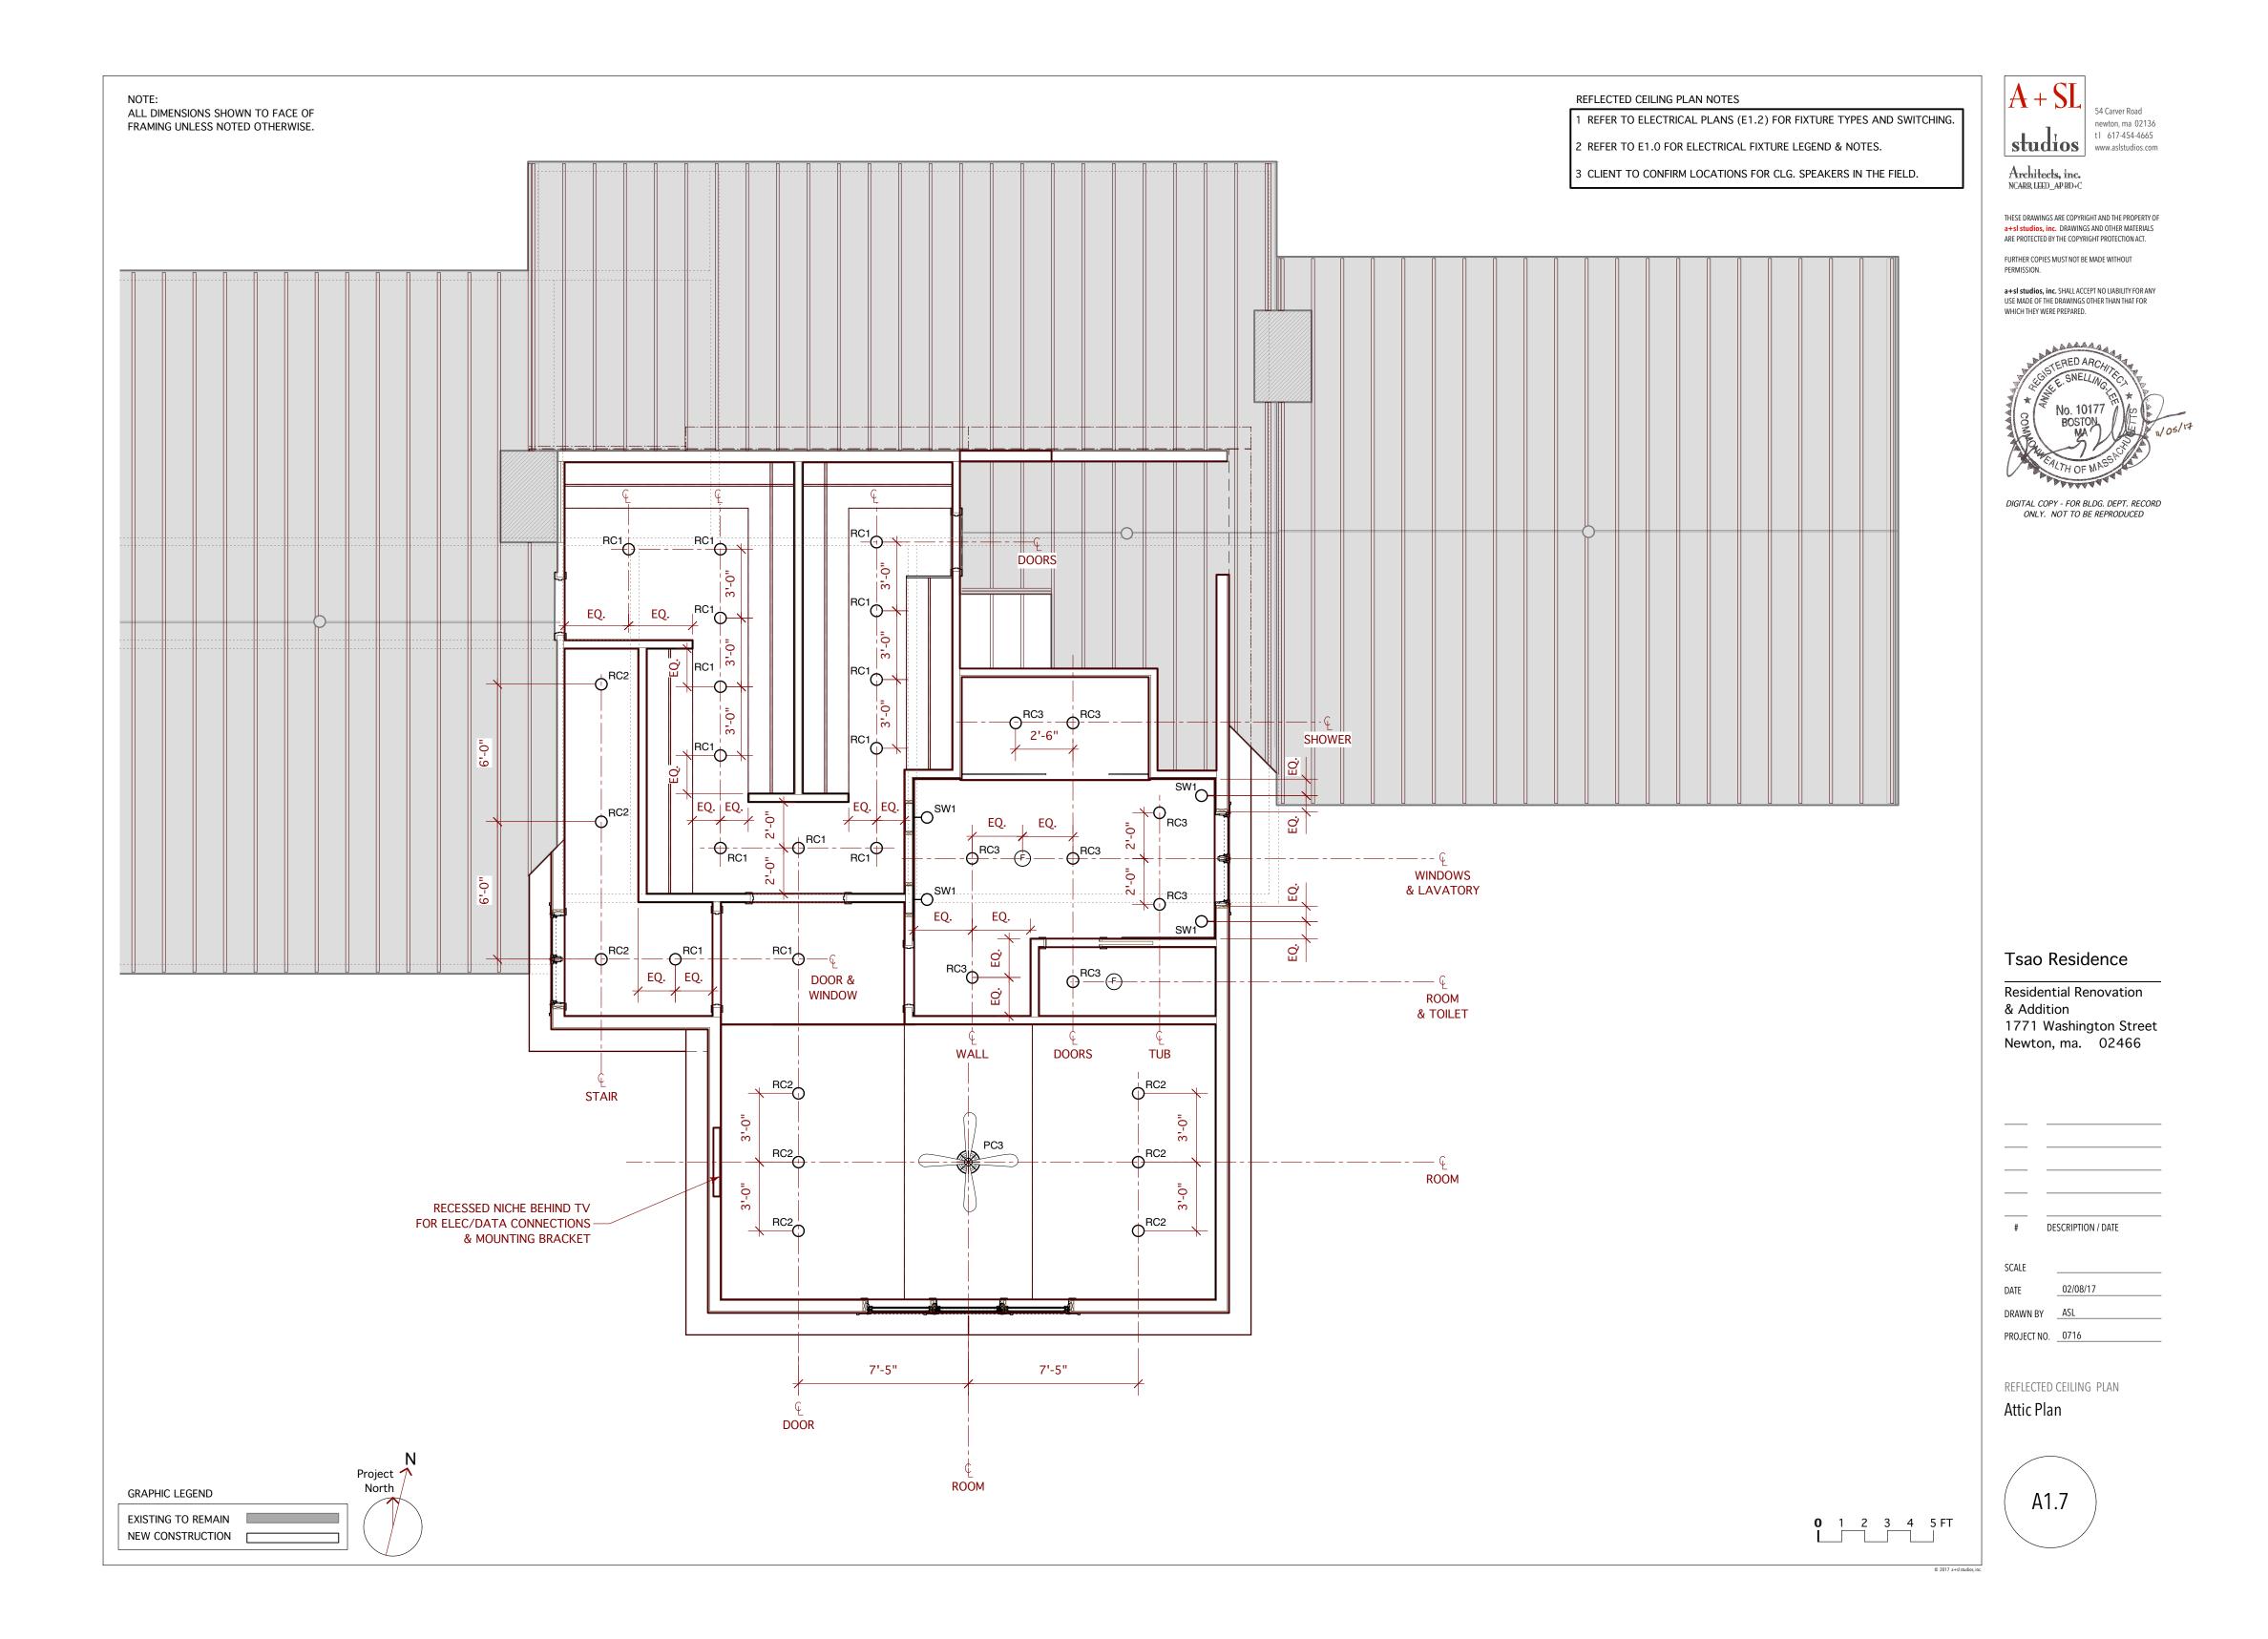

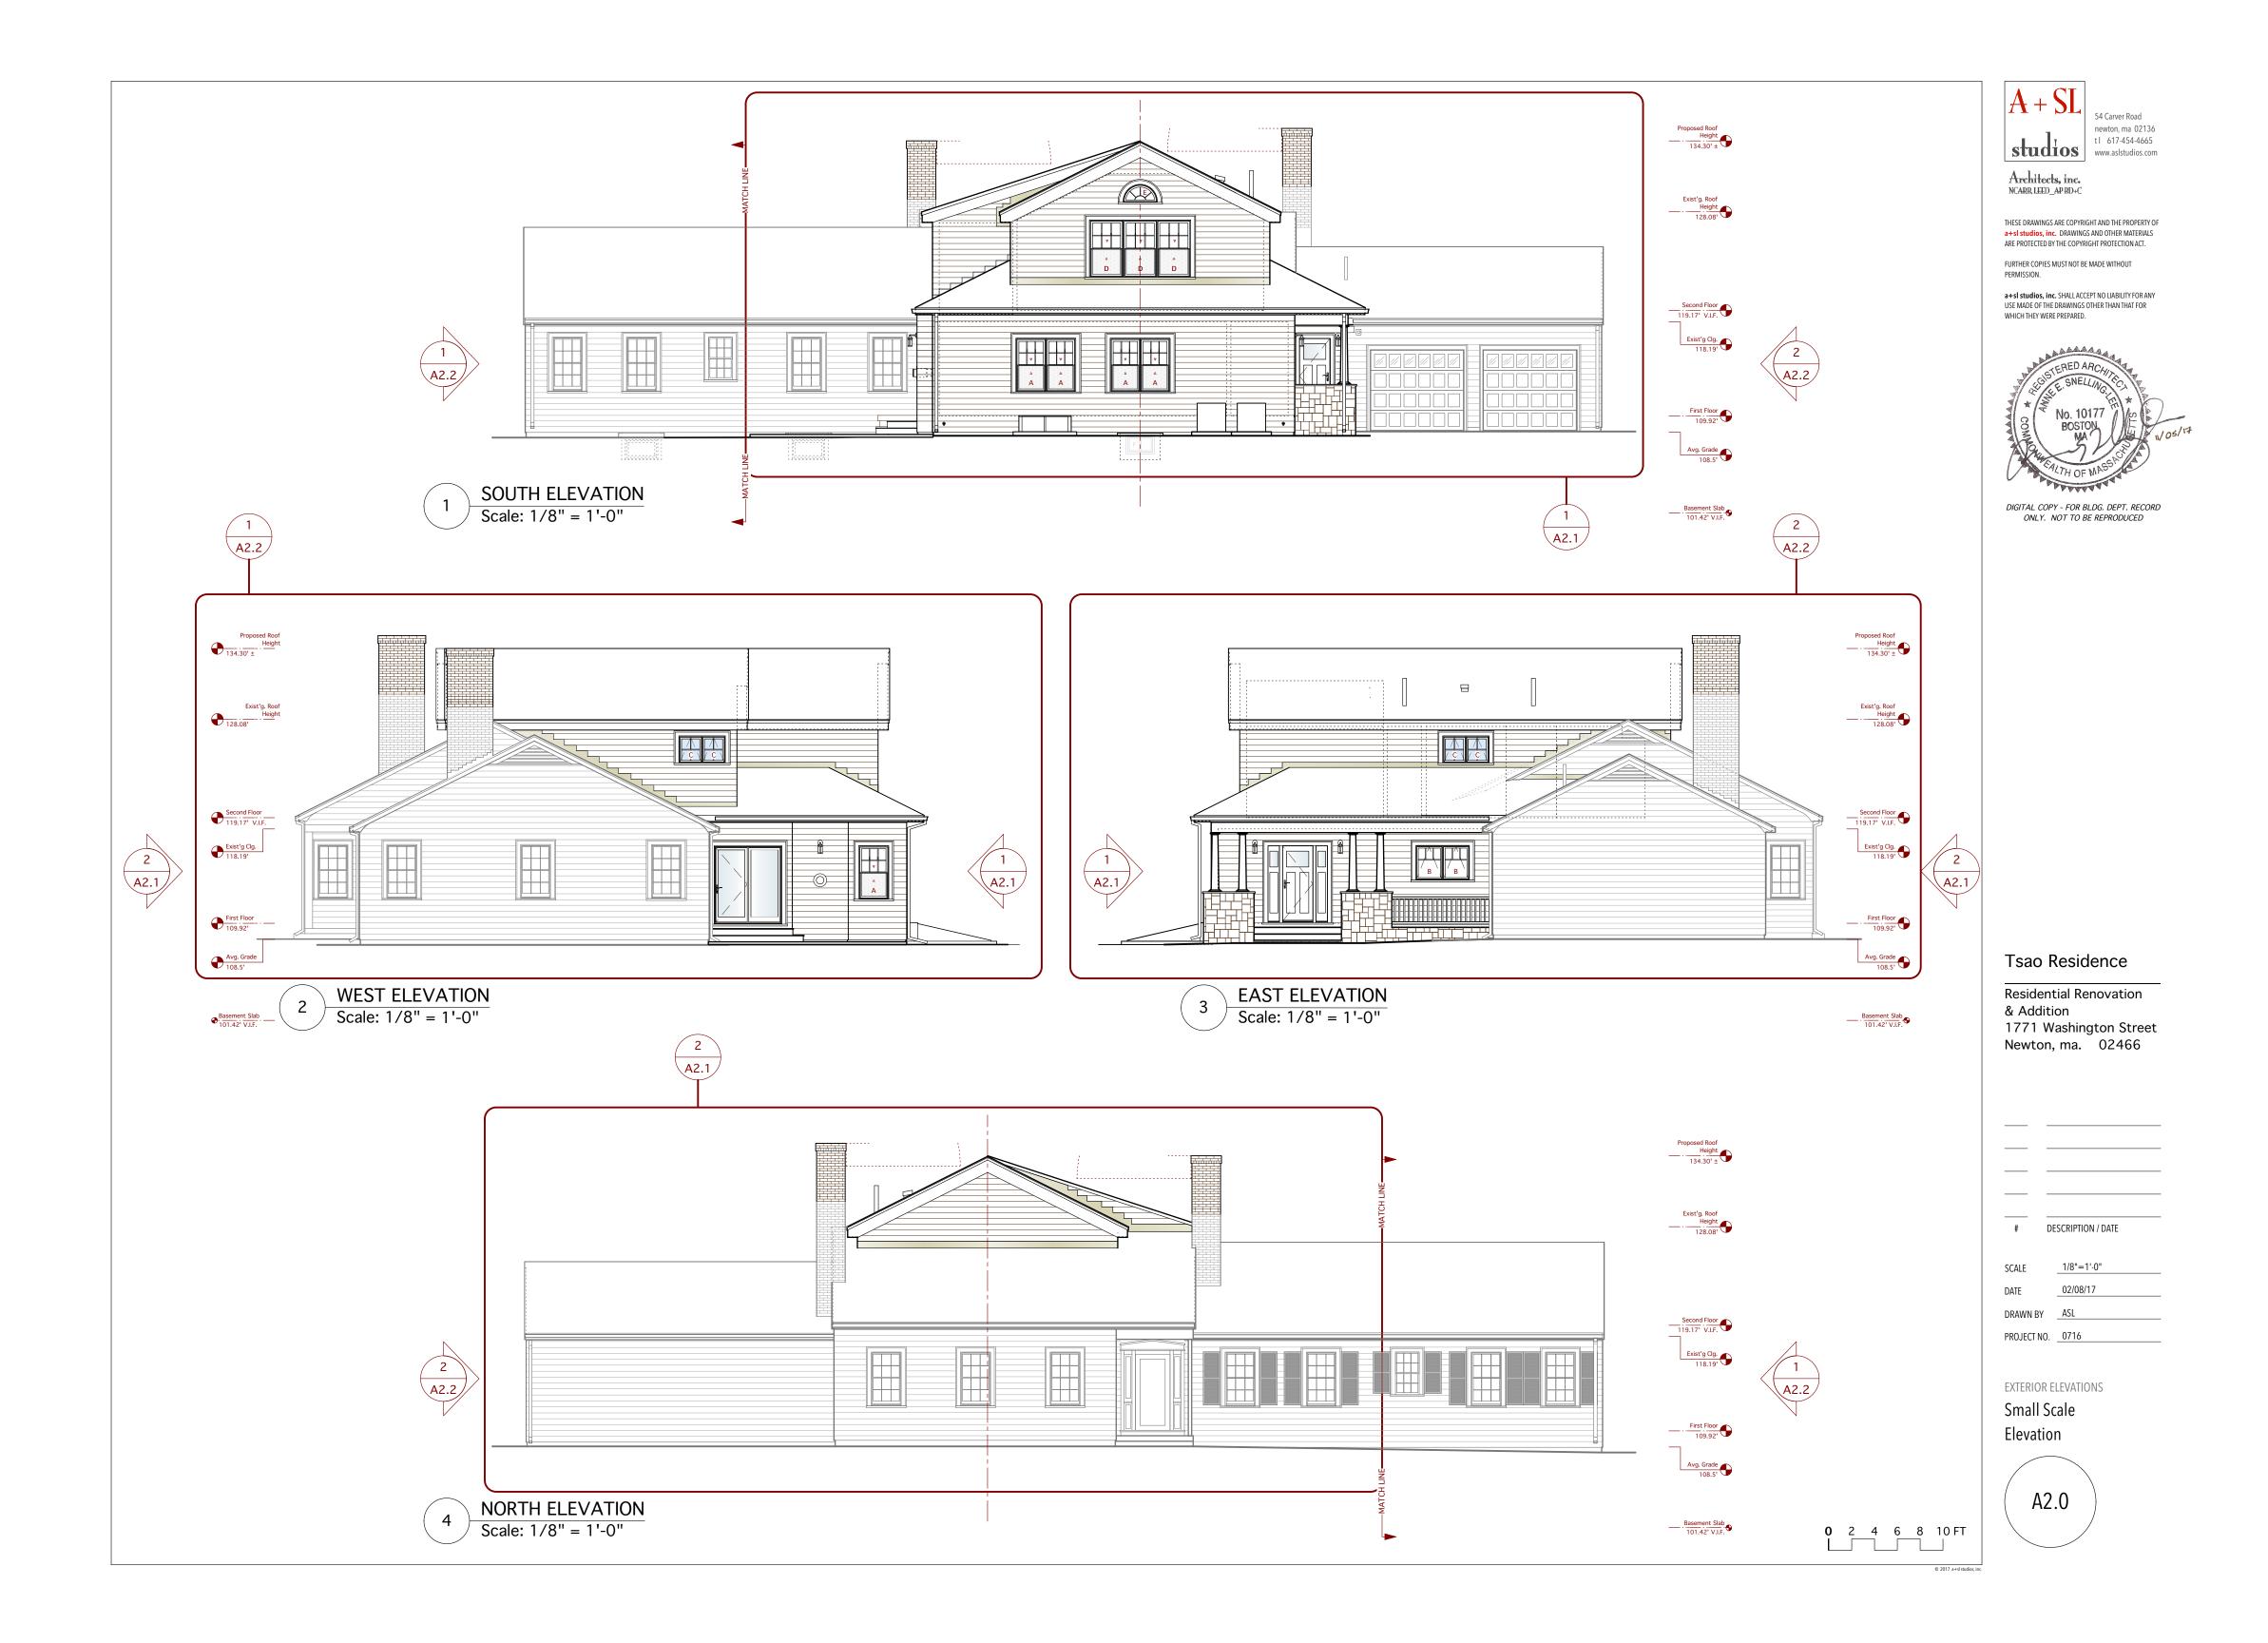

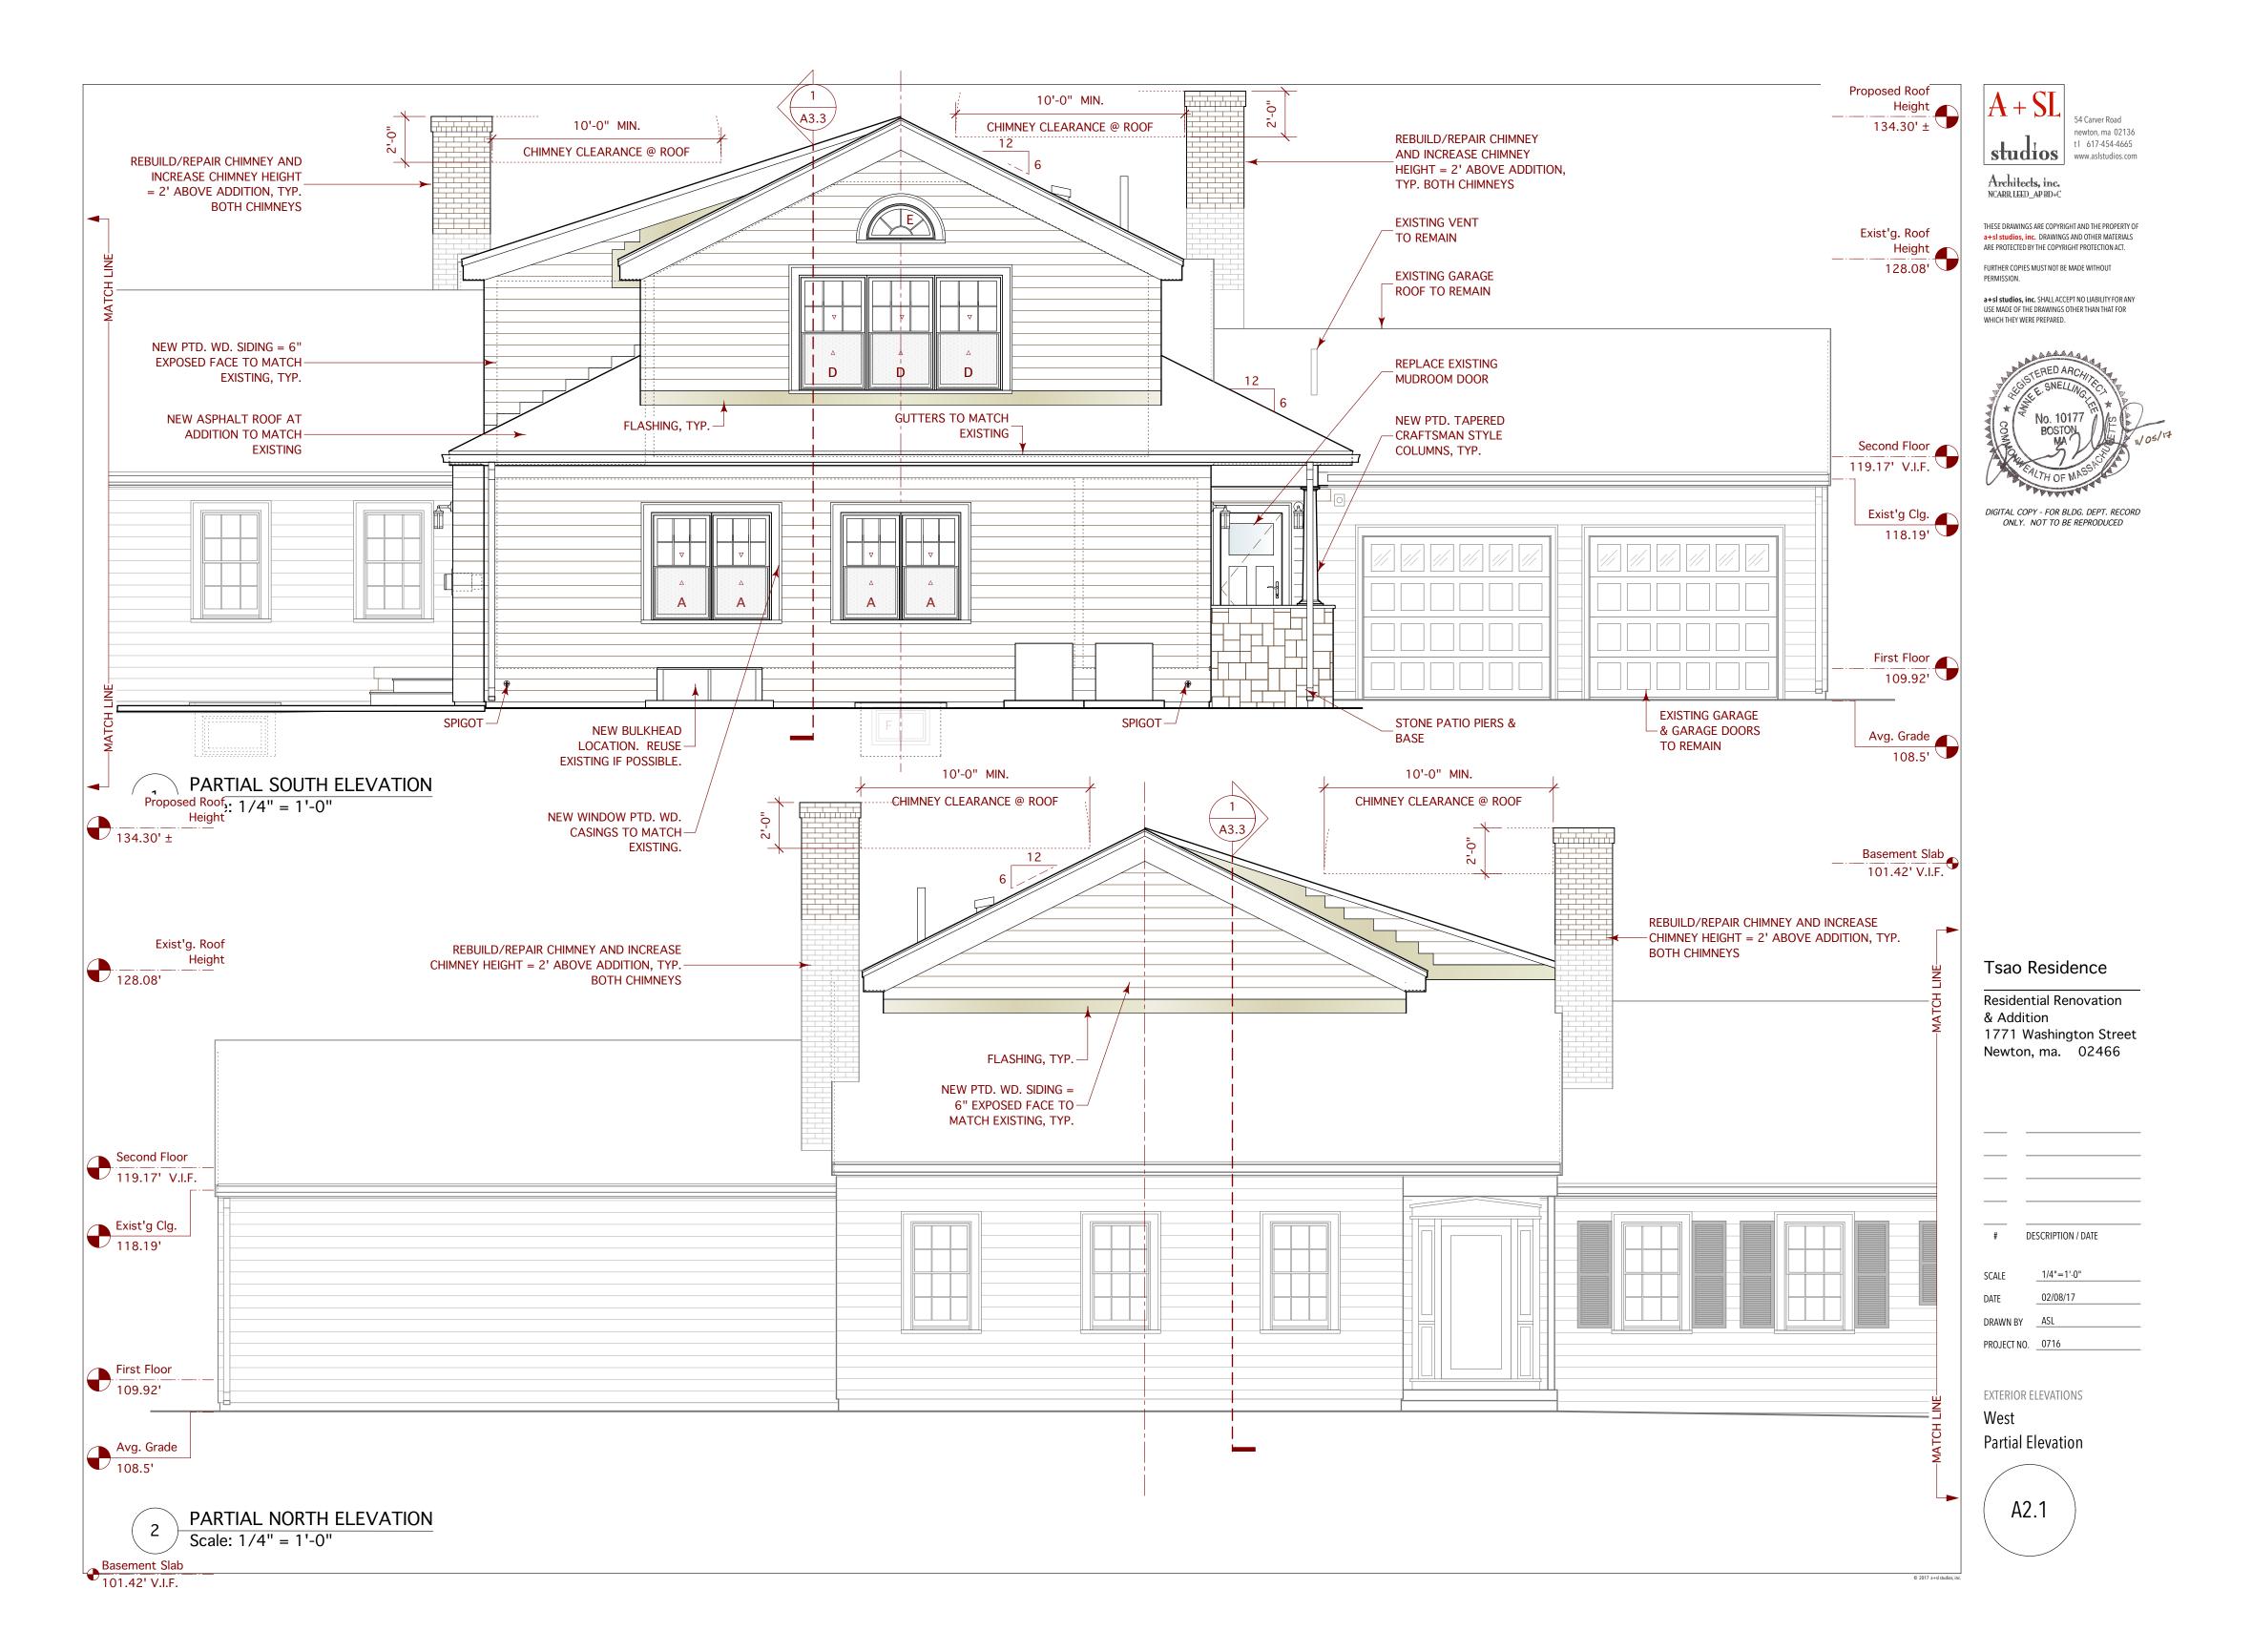

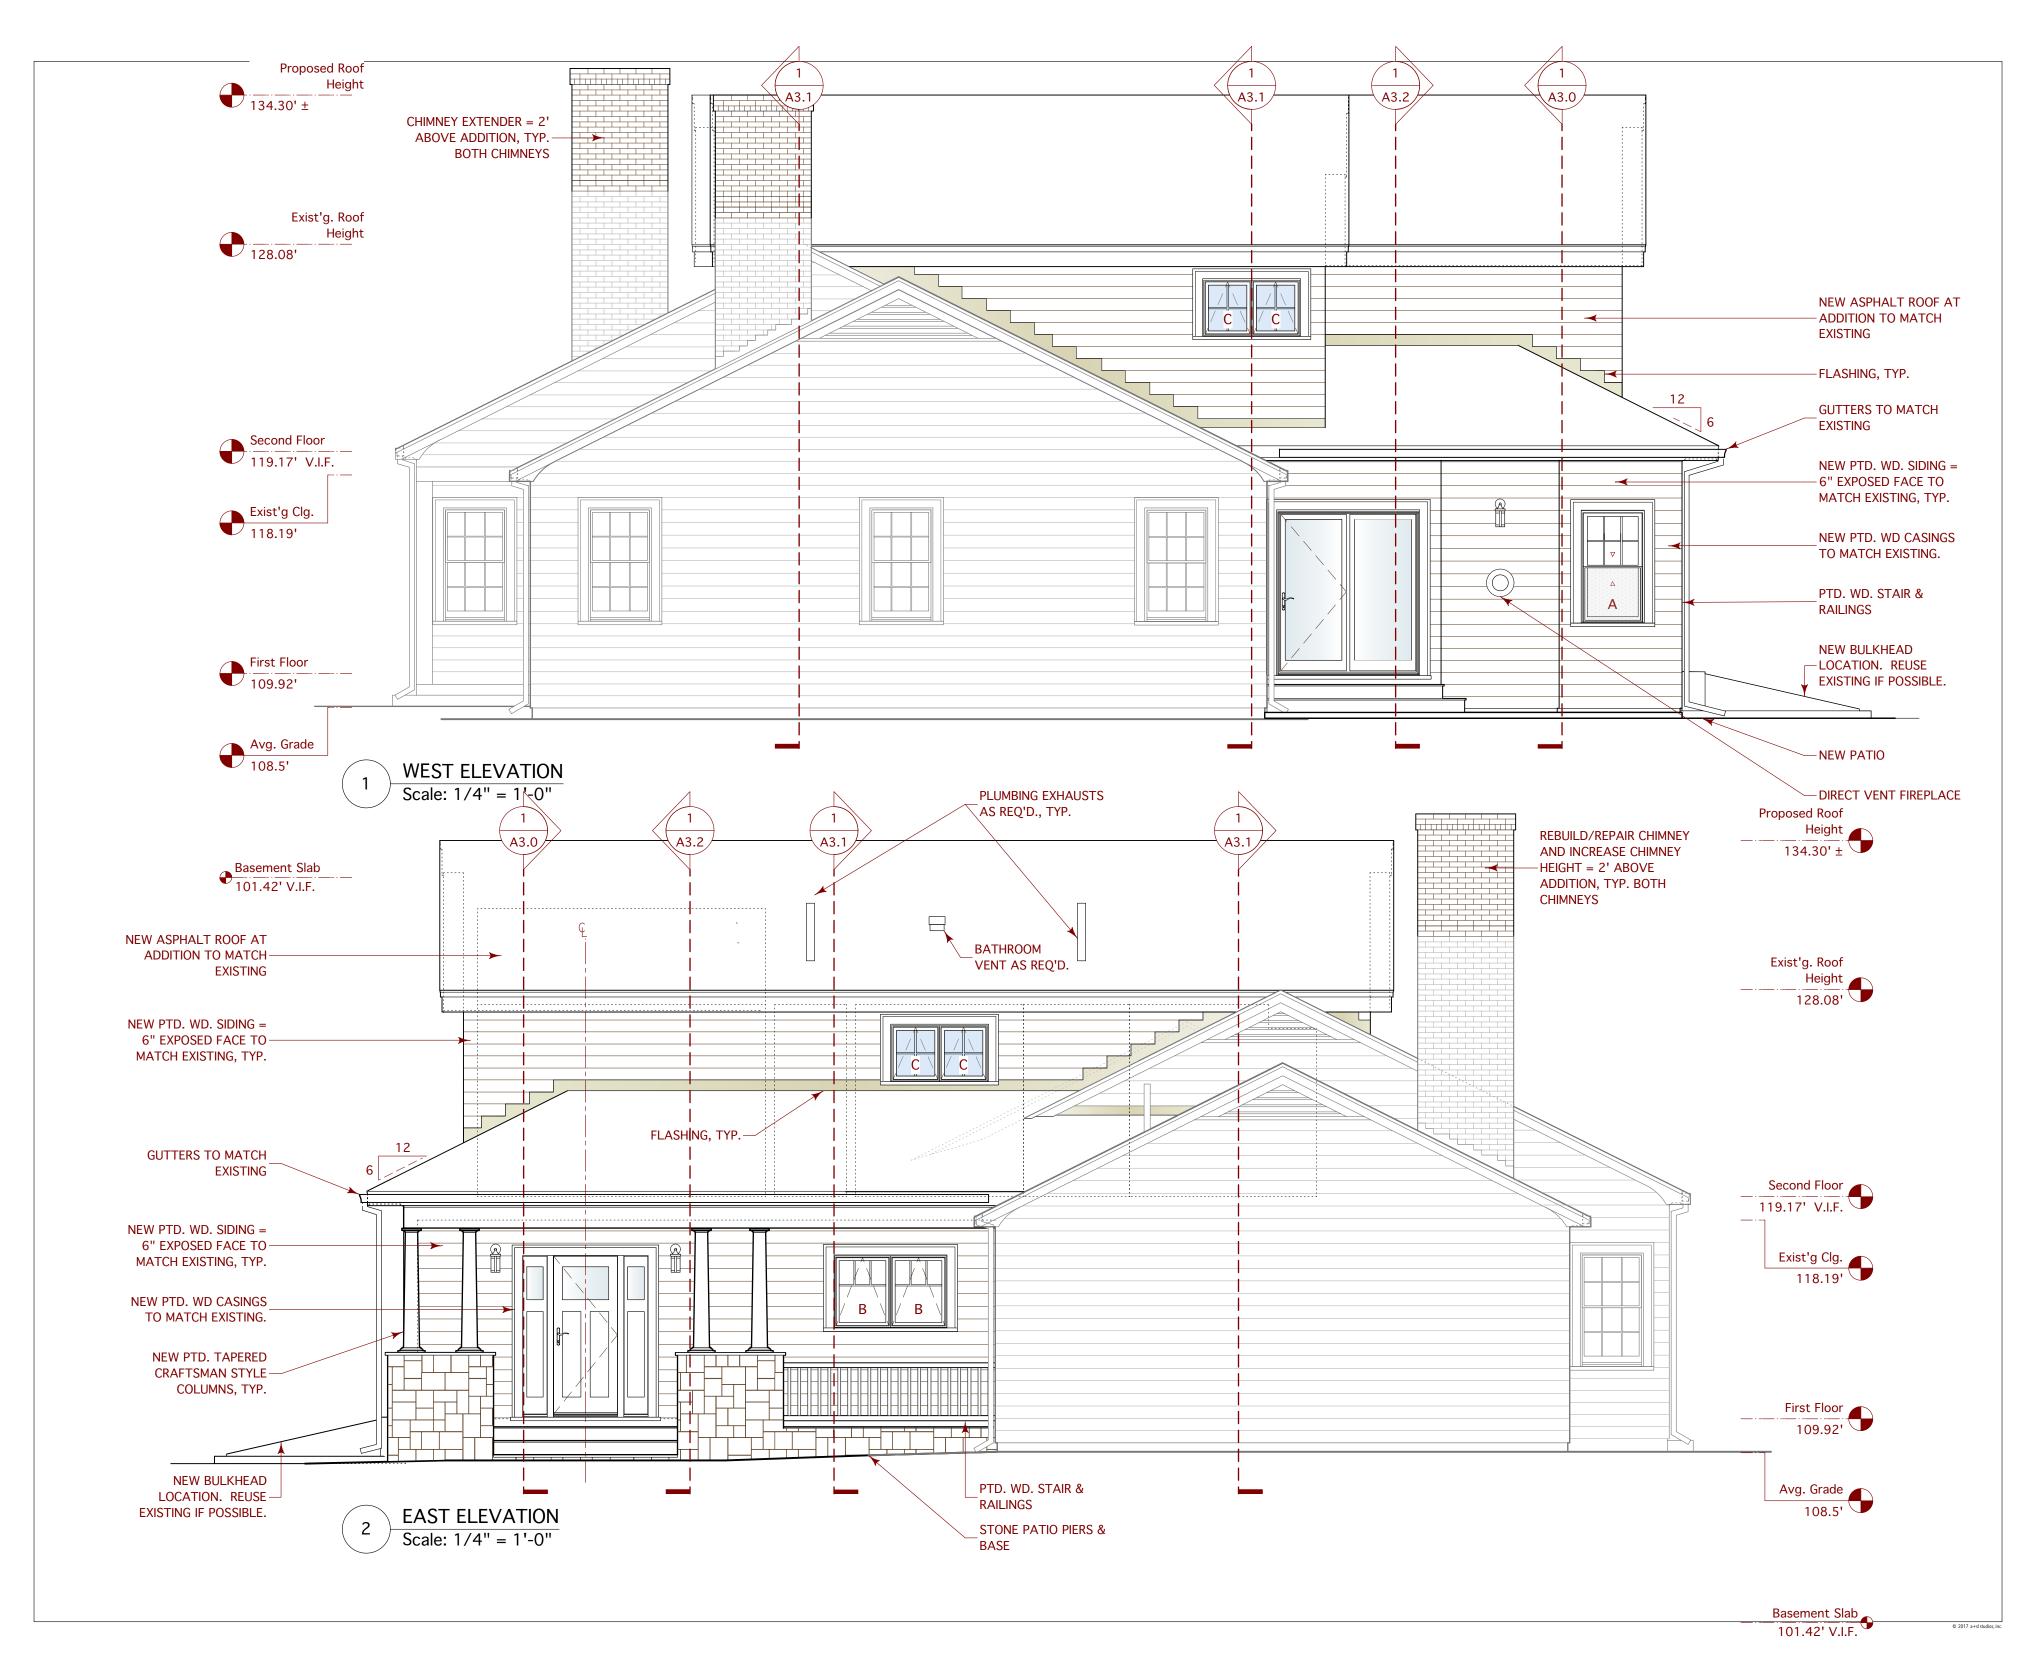


# A + SL studios

Architects, inc. NCARB, LEED\_AP BD+C

THESE DRAWINGS ARE COPYRIGHT AND THE PROPERTY OF a+sl studios, inc. DRAWINGS AND OTHER MATERIALS ARE PROTECTED BY THE COPYRIGHT PROTECTION ACT.

FURTHER COPIES MUST NOT BE MADE WITHOUT PERMISSION.

a+si studios, inc. SHALL ACCEPT NO LIABILITY FOR ANY USE MADE OF THE DRAWINGS OTHER THAN THAT FOR WHICH THEY WERE PREPARED.

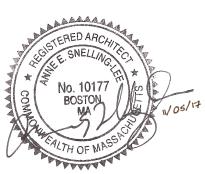


DIGITAL COPY - FOR BLDG. DEPT. RECORD ONLY. NOT TO BE REPRODUCED


Tsao Residence

EXTERIOR ELEVATIONS

North & South Partial Elevations



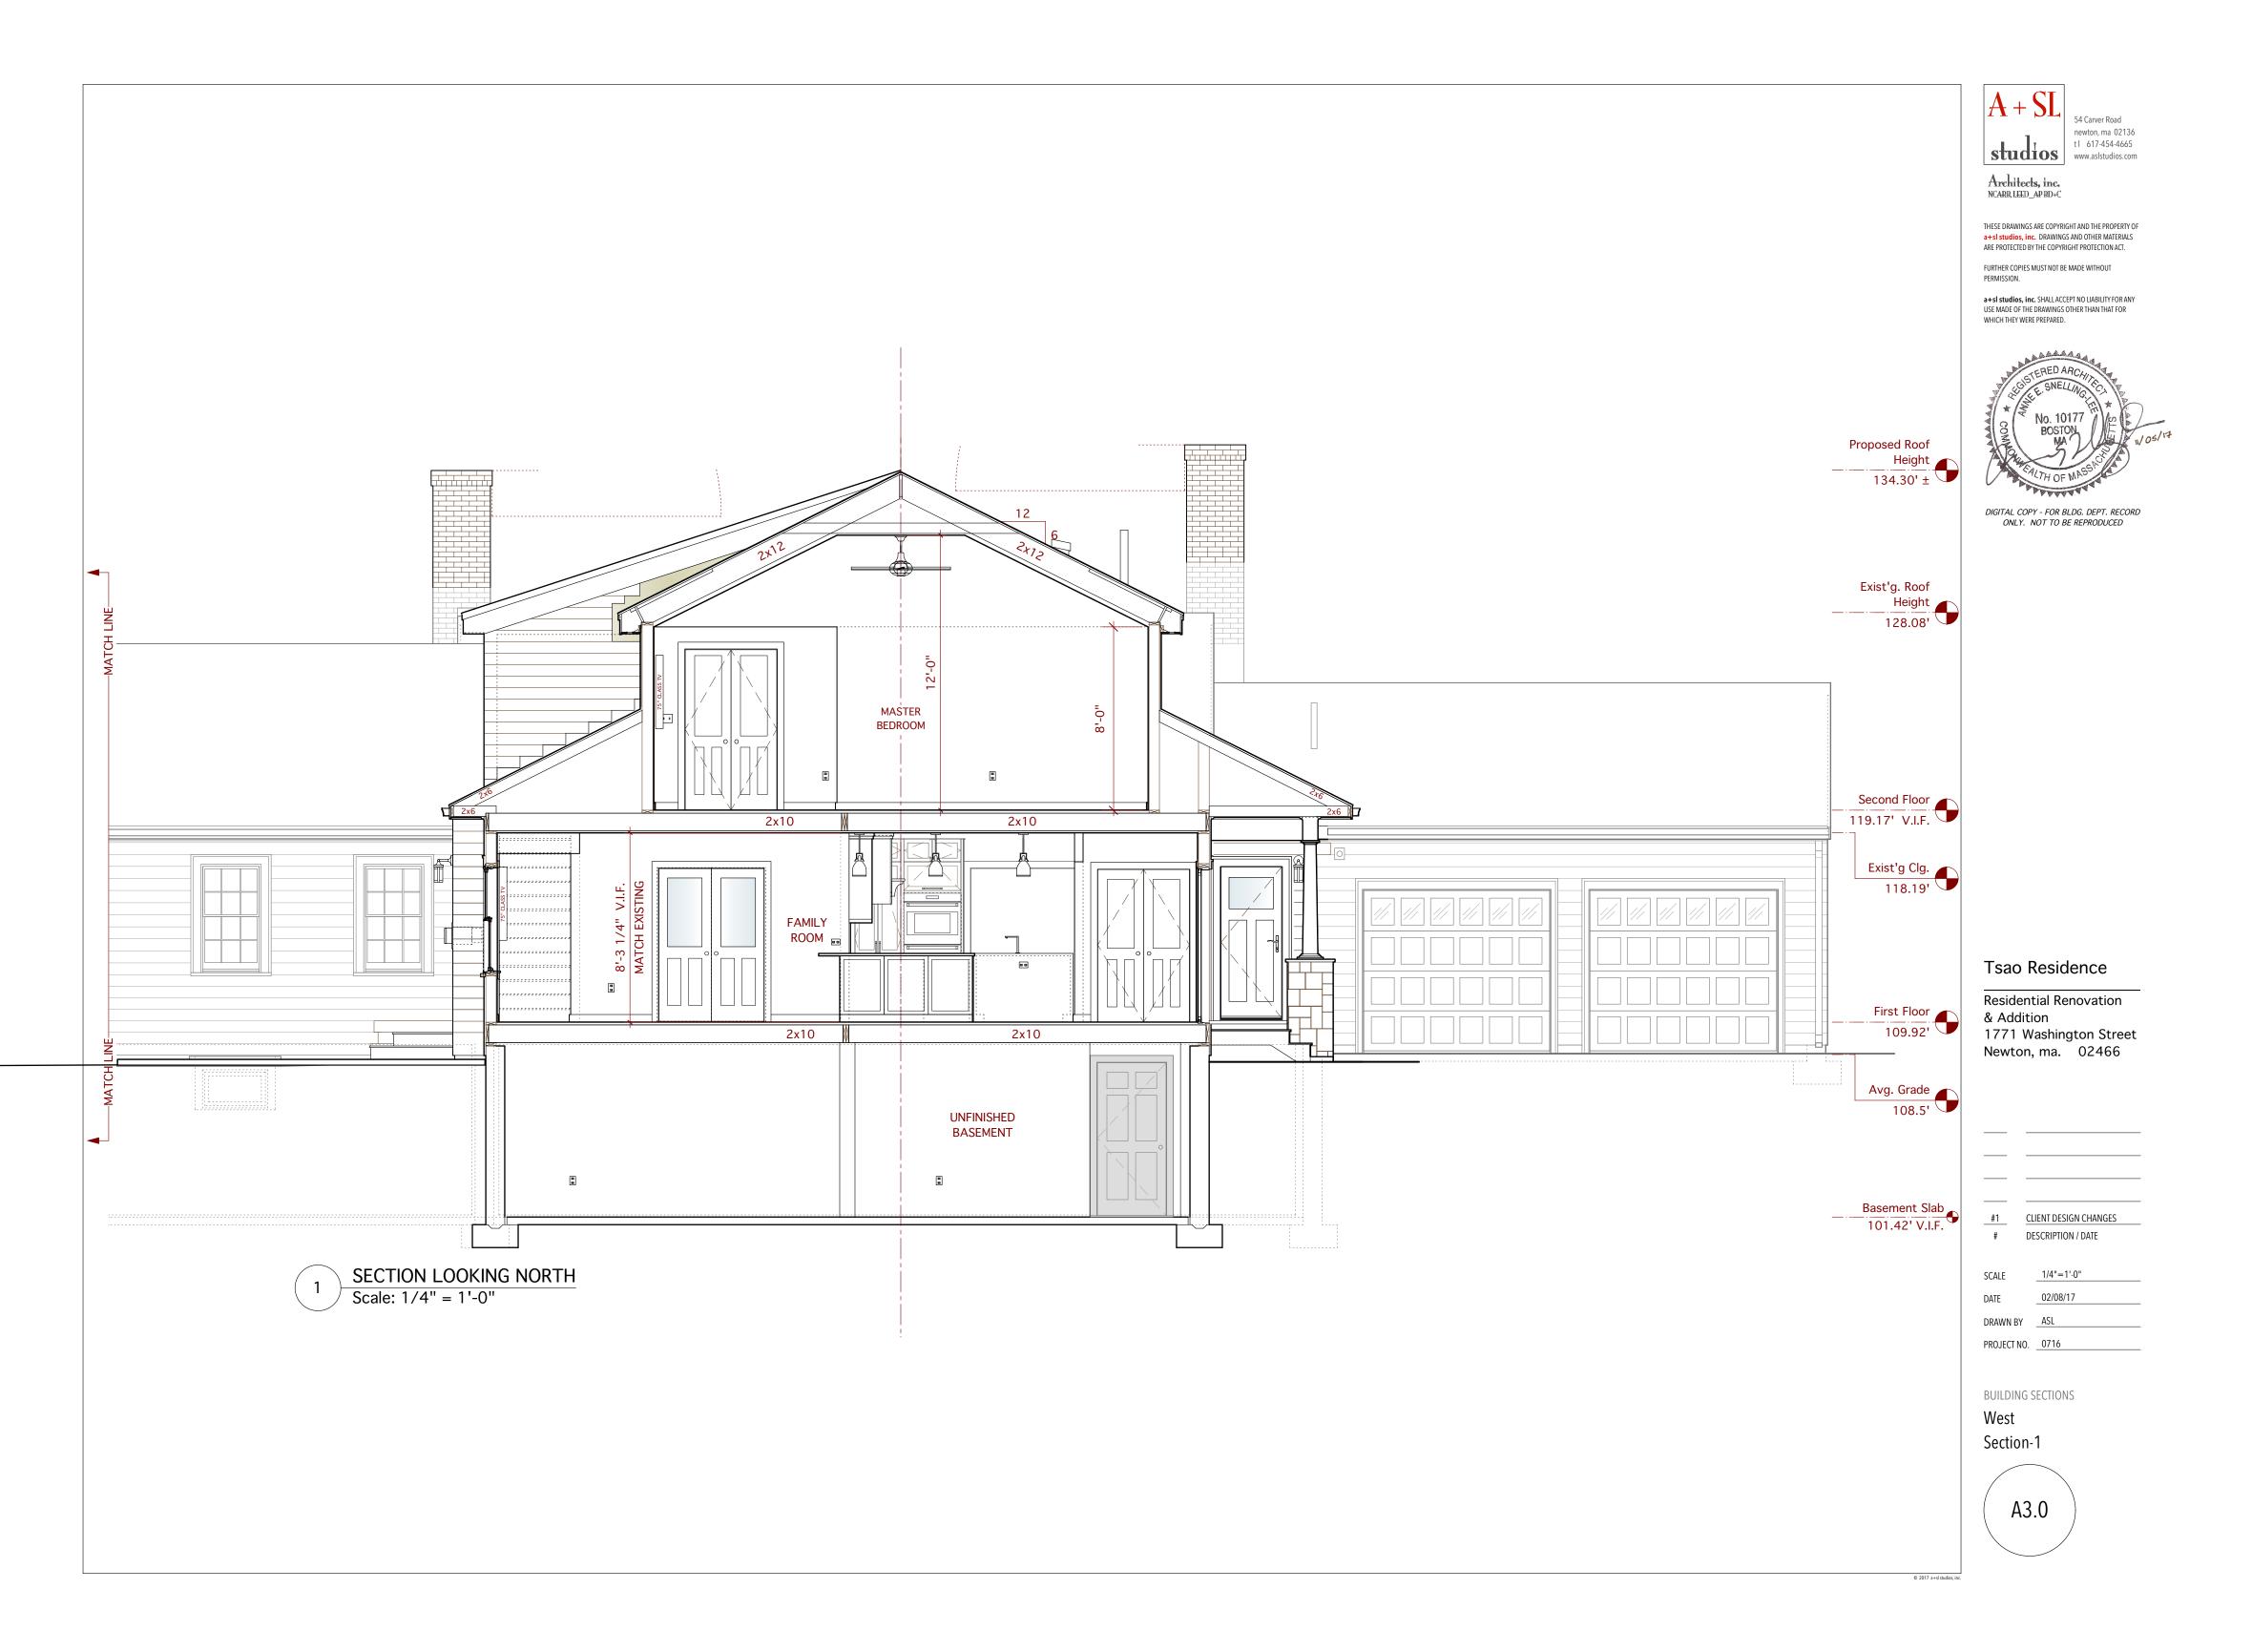

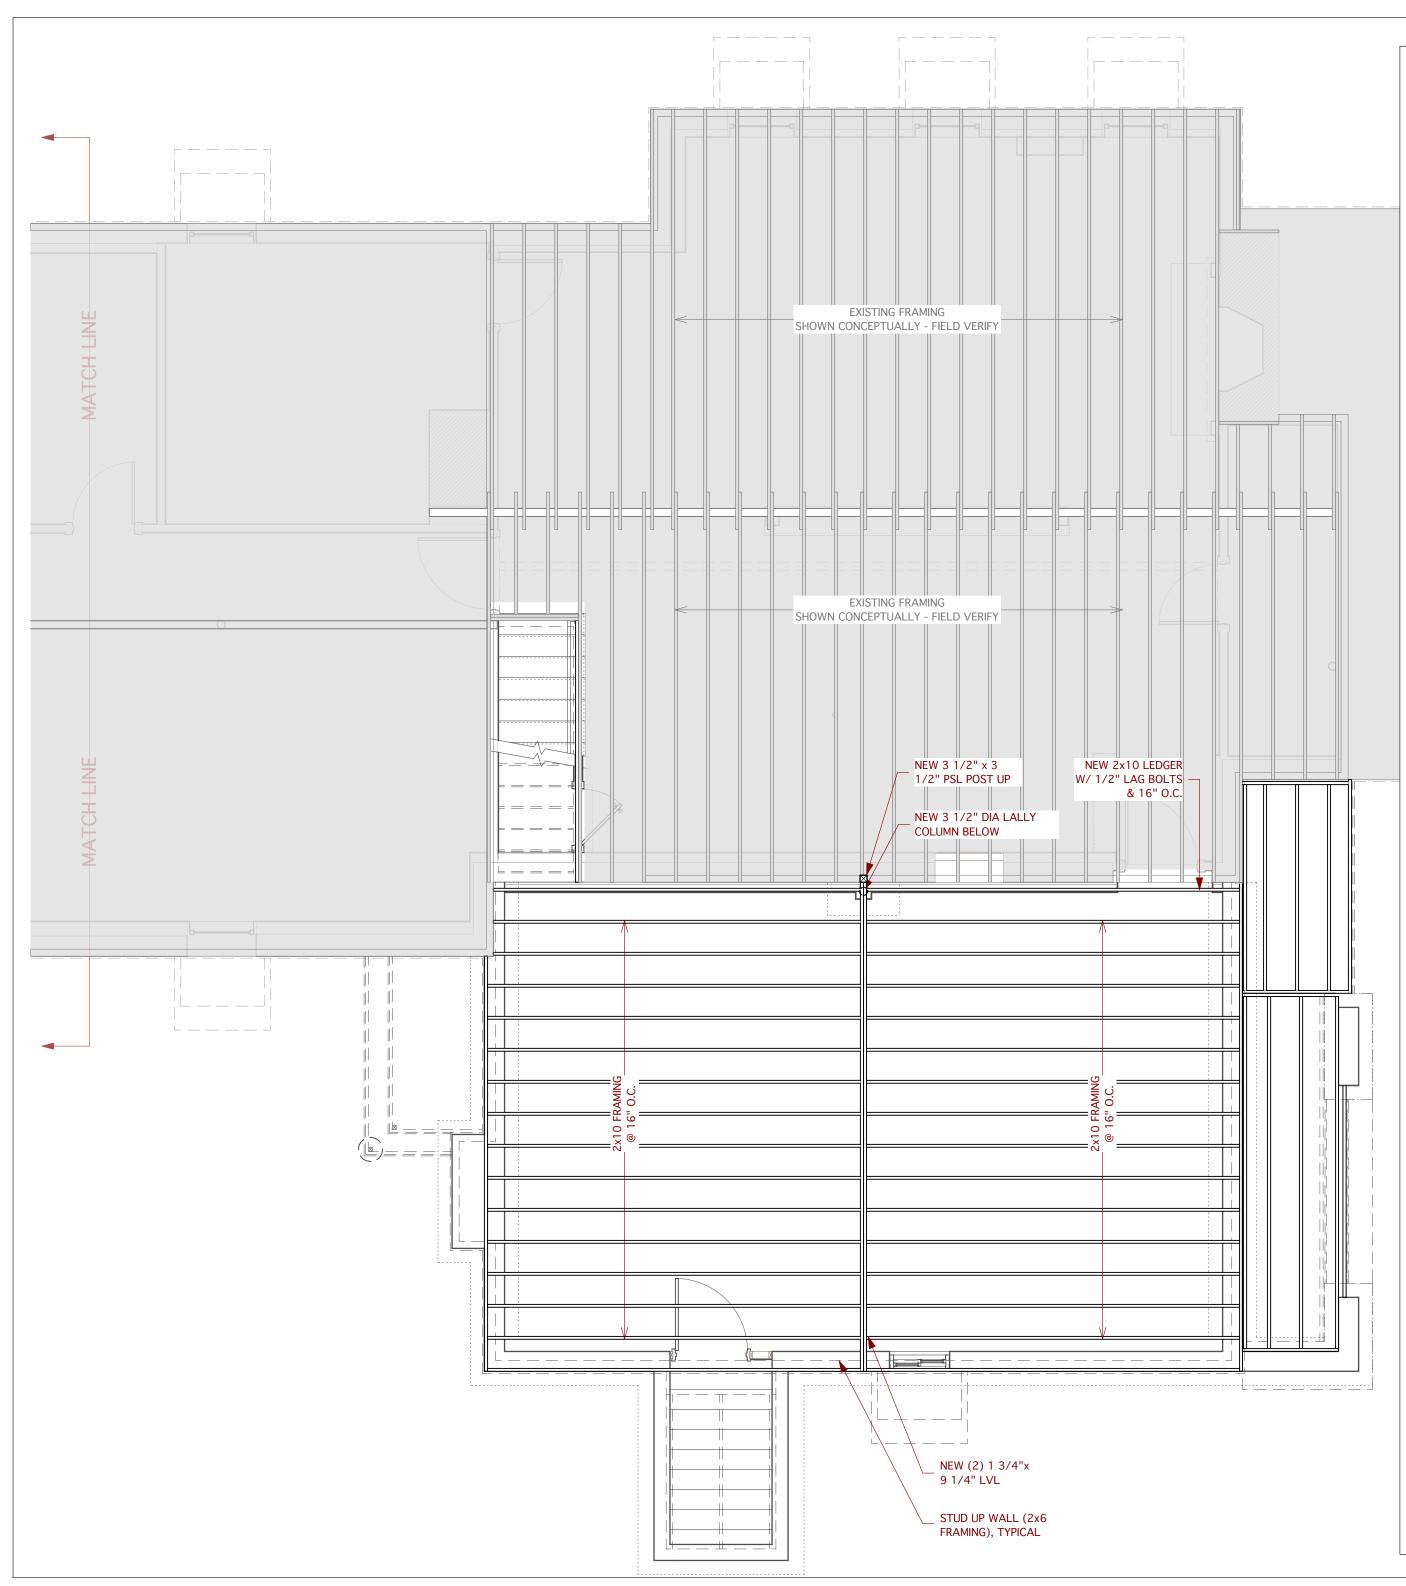

STRUCTURAL GENERAL NOTES:

- 1. CONTRACTOR SHALL BE RESPONSIBLE FOR CHECKING AND COORDINATING ALL DIMENSIONS WITH ARCHITECTURAL DRAWINGS. IN CASE OF CONFLICT, THE ARCHITECT SHALL BE NOTIFIED AND SHALL RESOLVE THE CONFLICT.
- 2. THE CONTRACTOR SHALL MAKE NO DEVIATION FROM DESIGN DRAWINGS WITHOUT PRIOR REVIEW BY THE ARCHITECT.
- 3. WORK NOT INDICATED ON A PART OF THE DRAWINGS BUT REASONABLY IMPLIED TO BE SIMILAR TO THAT SHOWN AT CORRESPONDING PLACES SHALL BE REPEATED.
- 4. ALL WORK SHALL COMPLY WITH APPLICABLE CODES AND LOCAL LAWS AND REGULATIONS.
- 5. THE STRUCTURAL DESIGN OF THE BUILDING IS BASED ON THE FULL INTERACTION OF ALL ITS COMPONENT PARTS. NO PROVISIONS HAVE BEEN MADE FOR CONDITIONS OCCURRING DURING CONSTRUCTION. IT IS THE SOLE RESPONSIBILITY OF THE CONTRACTOR TO MAKE PROPER AND ADEQUATE PROVISIONS FOR STABILITY OF, AND ALL STRESSES TO, THE STRUCTURE DUE TO ANY CAUSE DURING CONSTRUCTION.
- 6. VERIFY AND COORDINATE DIMENSIONS RELATED TO THE PROJECT.
- 7. EXAMINE ARCHITECTURAL, MECHANICAL, PLUMBING, AND ELECTRICAL DRAWINGS FOR VERIFICATION OF LOCATION AND DIMENSIONS SHOWN ON STRUCTURAL DRAWINGS.
- 8. CONTRACTOR SHALL NOT SCALE DRAWINGS. CONTRACTOR SHALL REQUEST ALL DIMENSIONS OR INFORMATION REQUIRED TO PERFORM THE WORK FROM THE ARCHITECT. WORK COMPLETED BY THE CONTRACTOR WITHOUT DIMENSIONS OR INFORMATION SHALL BE DONE AT HIS OWN RISK AND SHALL BE REMOVED AND REINSTALLED TO THE SPECIFICATIONS OF THE ARCHITECT AT NO ADDITIONAL COST TO THE OWNER.
- 9. MEANS AND METHODS OF CONSTRUCTION AS WELL AS COMPLIANCE WITH OSHA AND OTHER SAFETY LAWS AND REGULATIONS IS EXCLUSIVE RESPONSIBILITY OF THE CONTRACTOR, HIS SUBCONTRACTOR(S), SUPPLIERS, CONSULTANTS AND SERVANTS.
- 10. OPENINGS IN SLABS AND WALLS LESS THAN 12" MAXIMUM DIMENSION ARE GENERALLY NOT SHOWN ON STRUCTURAL DRAWINGS.. OPENINGS SHOWN ON STRUCTURAL DRAWINGS SHALL NOT BE REVISED WITHOUT PRIOR WRITTEN APPROVAL OF THE ARCHITECT
- 11. EXISTING STRUCTURAL FRAMING ASSUMED BASED ON LIMITED VISIBILITY. DURING DEMOLITION EXPOSE SECTIONS FOR REVIEW.
- 12. CODES: MASSACHUSETTS STATE BUILDING CODE 8TH EDITION + IBC + AMMENDMENTS IBC - INTERNATIONAL BUILDING CODE 2009
- 13. DESIGN LOADS:

LIVE LUADS	
LIVING AREAS	40 PSF
BEDROOMS	30 PSF
ATTICS	20 PSF
SNOW LOAD	
GROUND SNOW LOAD	45 PSF
FLAT ROOF SNOW LOAD	31.5 PSF
SLOPED ROOF SNOW LOAD	31.5 PSF
WIND LOAD	
BASIC WIND SPEED	110 MPH
WIND IMPORTANCE FACTOR	1.0 (OCCUPANCY II)
WIND EXPOSURE	EXPOSURE C

- 14. MINIMUM 6 MIL POLYETHYLENE VAPOR BARRIER SHALL BE INSTALLED UNDER ALL CONCRETE SLABS-ON-GRADE, U.N.O..
- 15. CALCIUM CHLORIDE OR ADMIXTURES CONTAINING CALCIUM CHLORIDE OR WHICH INCREASE THE POTENTIAL FOR CORROSION OF EMBEDDED METAL ITEMS SHALL NOT BE USED IN ANY CONC.
- 16. ALUMINUM ITEMS SHALL NOT BE PLACED IN CONCRETE.
- 17. PIPE OR CONDUIT EMBEDDED IN SLAB SHALL NOT EXCEED 1/3 THE SLAB THICKNESS AND SHALL BE PLACED WITHIN THE SLAB MIDDLE THIRD OF THICKNESS. MINIMUM CLEAR SPACING OF CONDUIT/PIPE IS 3xOD. NO CONDUIT/PIPE TO BE PLACED CLOSER THAN 12" FROM COLUMN FACE.
- 18. CONTRACTOR IS RESPONSIBLE FOR PROPER AND ADEQUATE SHORING OF CONCRETE WORK.
- 19. FRAMING LUMBER SHALL BE MARKED S-DRY. ALL MATERIALS SHALL BE CHECKED BEFORE USE, WITH ALL CHECKED, SPLIT AND OTHERWISE DEFICIENT STOCK REJECTED, OR USED ONLY FOR MISCELLANEOUS BLOCKING, FURRING OR OTHER INCIDENTAL USE. THE CONTRACTOR SHALL BE RESPONSIBLE FOR REPLACING ALL MEMBERS WHICH, DUE TO WARPAGE, TWIST, SPLITTING, OR CHECKING, RESULT IN UNSATISFACTORY WORK. SUCH REPLACEMENT SHALL BE REQUIRED AT ANY TIME, WHETHER BEFORE OR AFTER APPLICATION OF FINISH MATERIAL.
- 20. FRAMING LUMBER FOR BEAMS AND HEADERS SHALL BE SURFACE DRY HEM-FIR NUMBER 2 OR SURFACE DRY SPRUCE-PINE-FIR NUMBER 2, SHALL HAVE A MINIMUM BENDING STRESS FB NOT LESS THAN 875 PSI SINGLE MEMBER USE.
- 21. FRAMING LUMBER FOR STUDS SHALL BE SURFACE DRY HEM-FIR, SPRUCE-PINE-FIR STUD GRADE OR OTHER STUD GRADE LUMBER WITH AN FC PARALLEL TO THE GRAIN OF 550 PSI OR GREATER.
- 22. FLOOR SEATHING SHALL BE 3/4" THICK CDX GRADE STRUCTURAL PLYWOOD AND ROOF SHEATHING SHALL BE 5/8" THICK CDX GRADE STRUCTURAL PLYWOOD. PLYCLIPS SHALL BE USED AT ALL UNSUPPORTED EDGES. WALL SHEATHING SHALL BE 5/8" THICK CDX STRUCTURAL PLYWOOD.
- 23. ALL WOOD EXPOSED TO WEATHER, ALL WOOD BLOCKING ON ROOFS, INCLUDING NAILERS, BLOCKING AND CURBS, & THAT WHICH WILL BE CONCEALED BY ROOFING OR FLASHING WORK, OR WOOD IN CONTACT WITH CONCRETE OR MASONRY OR WITHIN 12 INCHES OF ADJACENT GRADE SHALL BE PRESSURE TREATED IN ACCORDANCE WITH THE AMERICAN WOOD PRESERVERS INSTITUTE.
- 24. FABRICATED HARDWARE SHALL BE SELECTED FOR SIZE OF MEMBERS JOINED OR SUPPORTED & TO DEVELOP THE FULL STRENGTH OF THE MEMBERS, AS DIRECTED BY THE ENGINEER. IN EXTERIOR AREAS OR WHERE IN CONTACT WITH CONCRETE OR MASONRY ROUGH HARDWARE SHALL BE HOT-DIPPED GALVANIZED. IN OTHER AREAS ELECTROGALVANIZING WILL BE ACCEPTABLE.
- 25. CONNECTIONS SHALL BE SUBMITTED TO THE ENGINEER FOR REVIEW AND SHALL DEVELOP THE FULL CAPACITY OF THE MEMBERS JOINED.
- 26. LAMINATED VENEER LUMBER SHALL BE 1.9E MICROLLAM BY ILEVEL (WEYERHAUSER) OR EQUAL. FLEXURAL STRESS TO BE NO LESS THAN 2,600 PSI.



Architects, inc. NCARB, LEED\_AP BD+C

THESE DRAWINGS ARE COPYRIGHT AND THE PROPERTY OF **a+sl studios, inc.** DRAWINGS AND OTHER MATERIALS

ARE PROTECTED BY THE COPYRIGHT PROTECTION ACT. FURTHER COPIES MUST NOT BE MADE WITHOUT PERMISSION.

a+sl studios, inc. SHALLACCEPT NO LIABILITY FOR ANY USE MADE OF THE DRAWINGS OTHER THAN THAT FOR WHICH THEY WERE PREPARED.



DIGITAL COPY - FOR BLDG. DEPT. RECORD ONLY. NOT TO BE REPRODUCED

#### Tsao Residence


Residential Renovation		
& Addition		
1771 Washing	gton Stree	
Newton, ma.	02466	

# [	DESCRIPTION / DATE
SCALE	1/4"=1'-0"
DATE	02/08/17
DRAWN BY	ASL
PROJECT NO.	0716

STRUCTURAL


First Floor Framing Plan

/		$\backslash$
	S1.1	

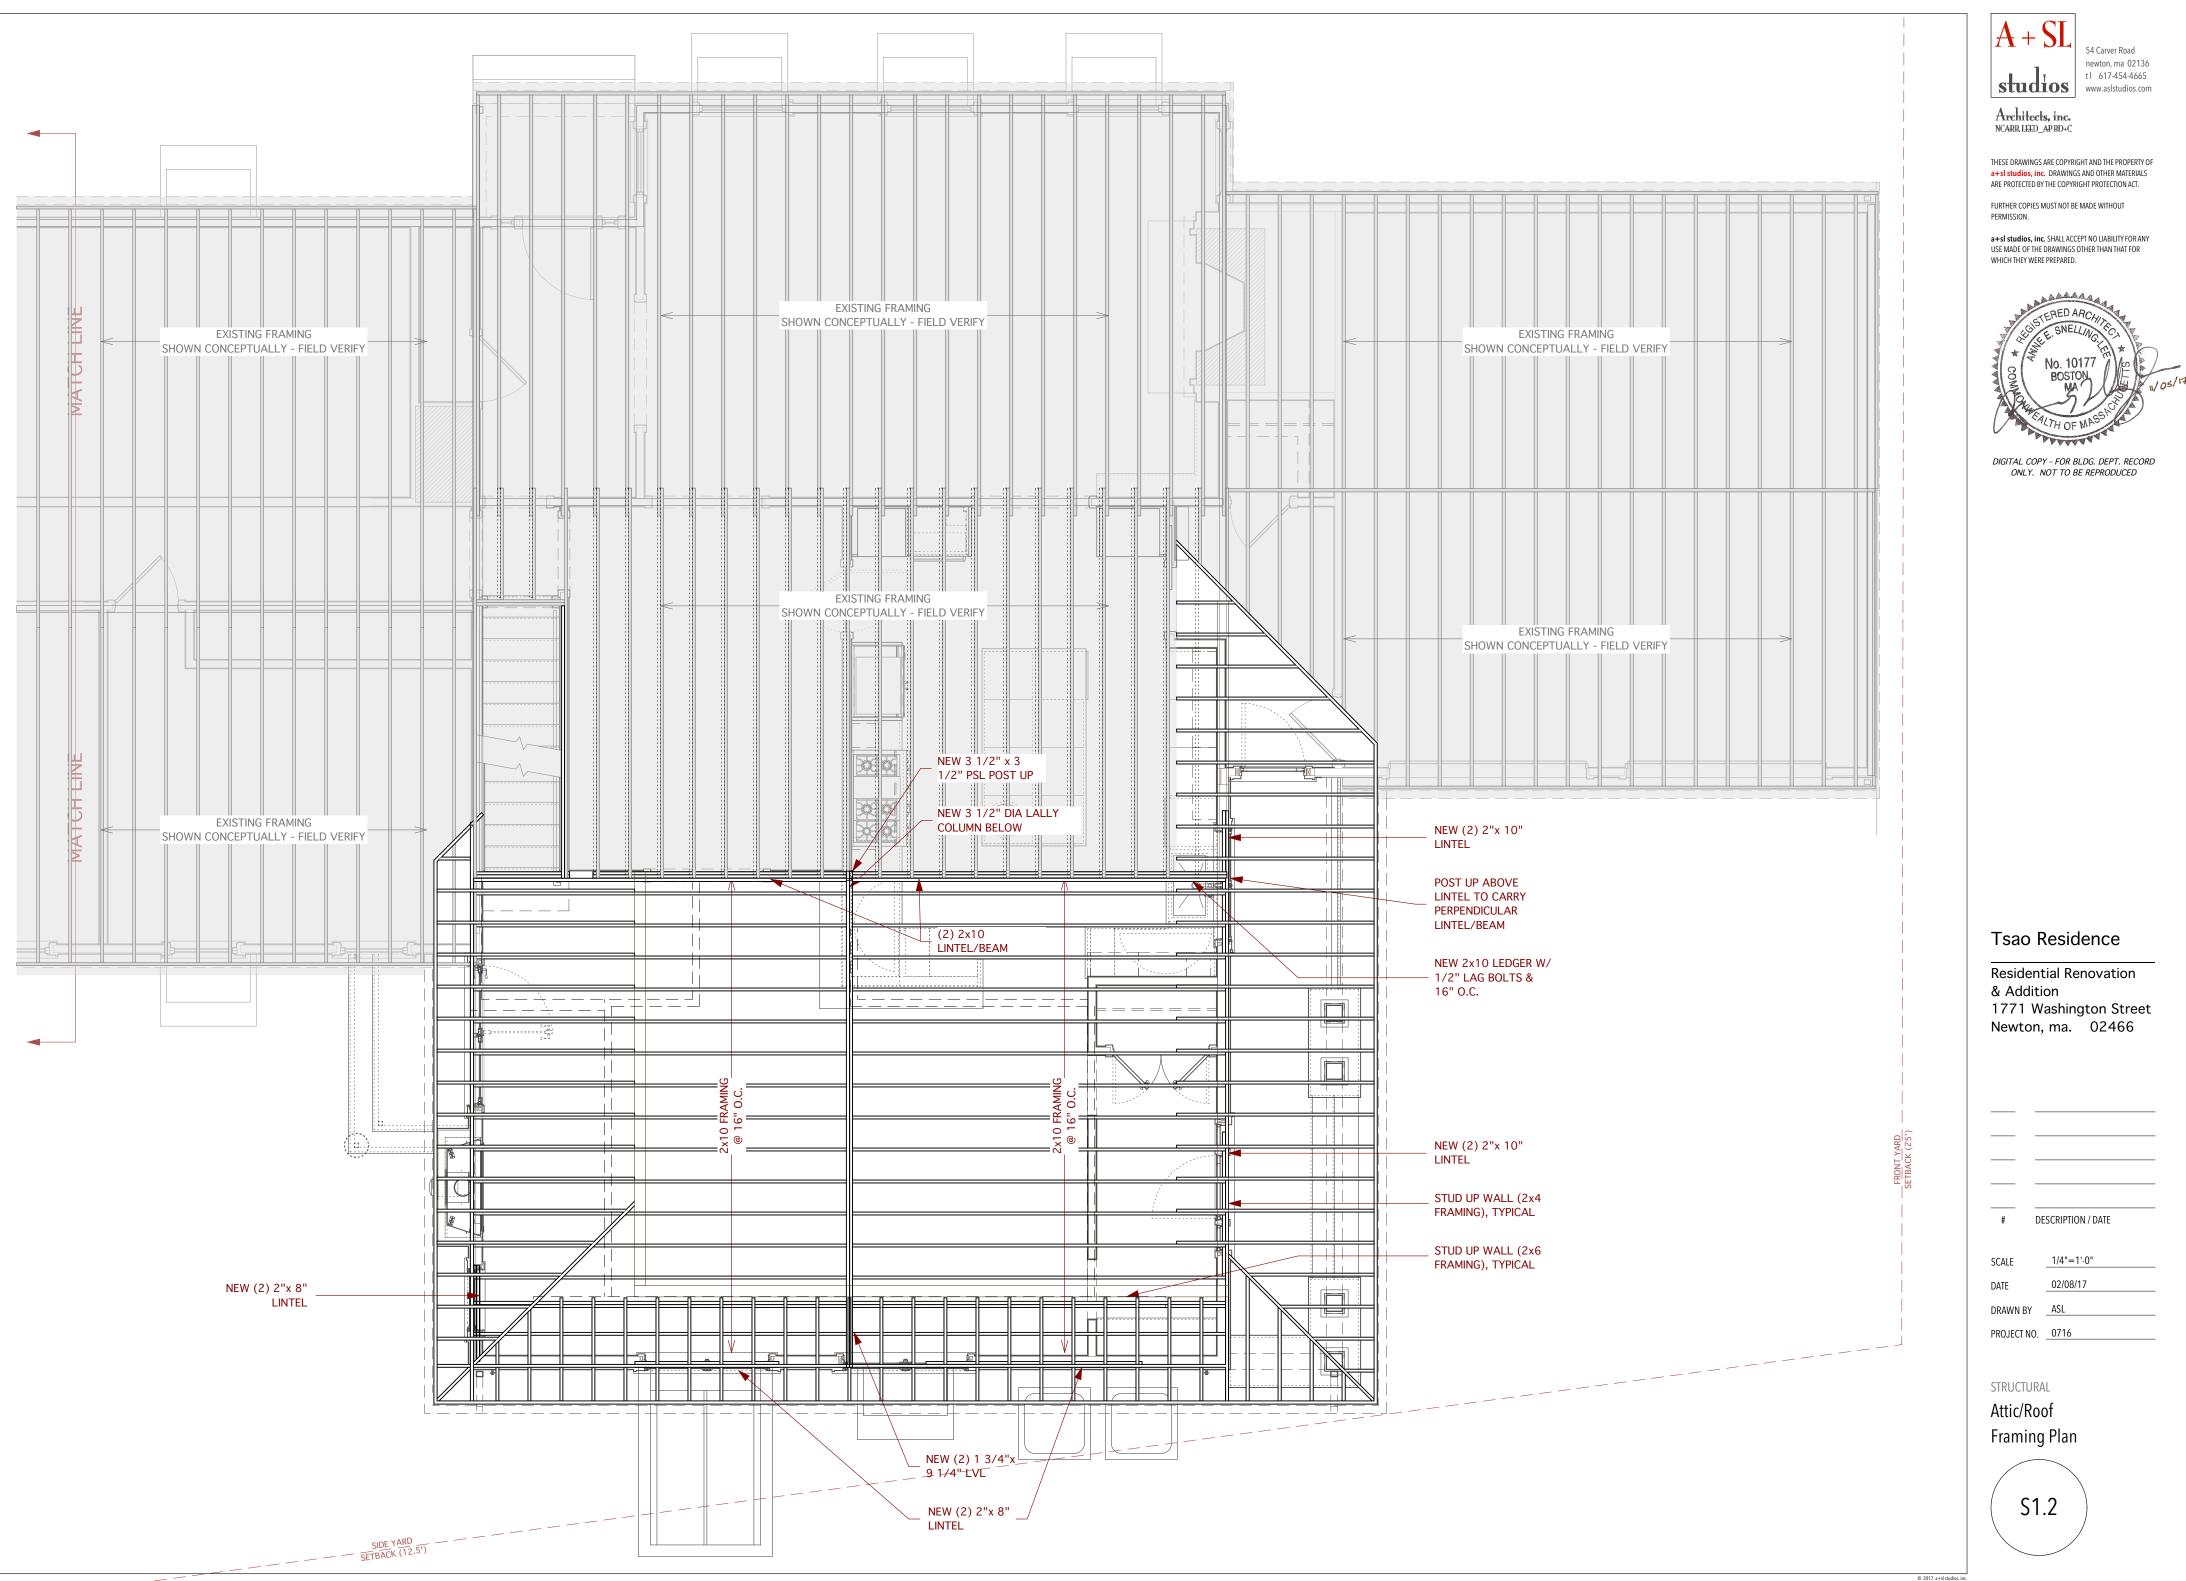

# DI	ESCRIPTION / DATE
SCALE	1/4"=1'-0"
DATE	02/08/17
DRAWN BY	ASL
PROJECT NO.	0716

© 2017 a+sl studios, inc

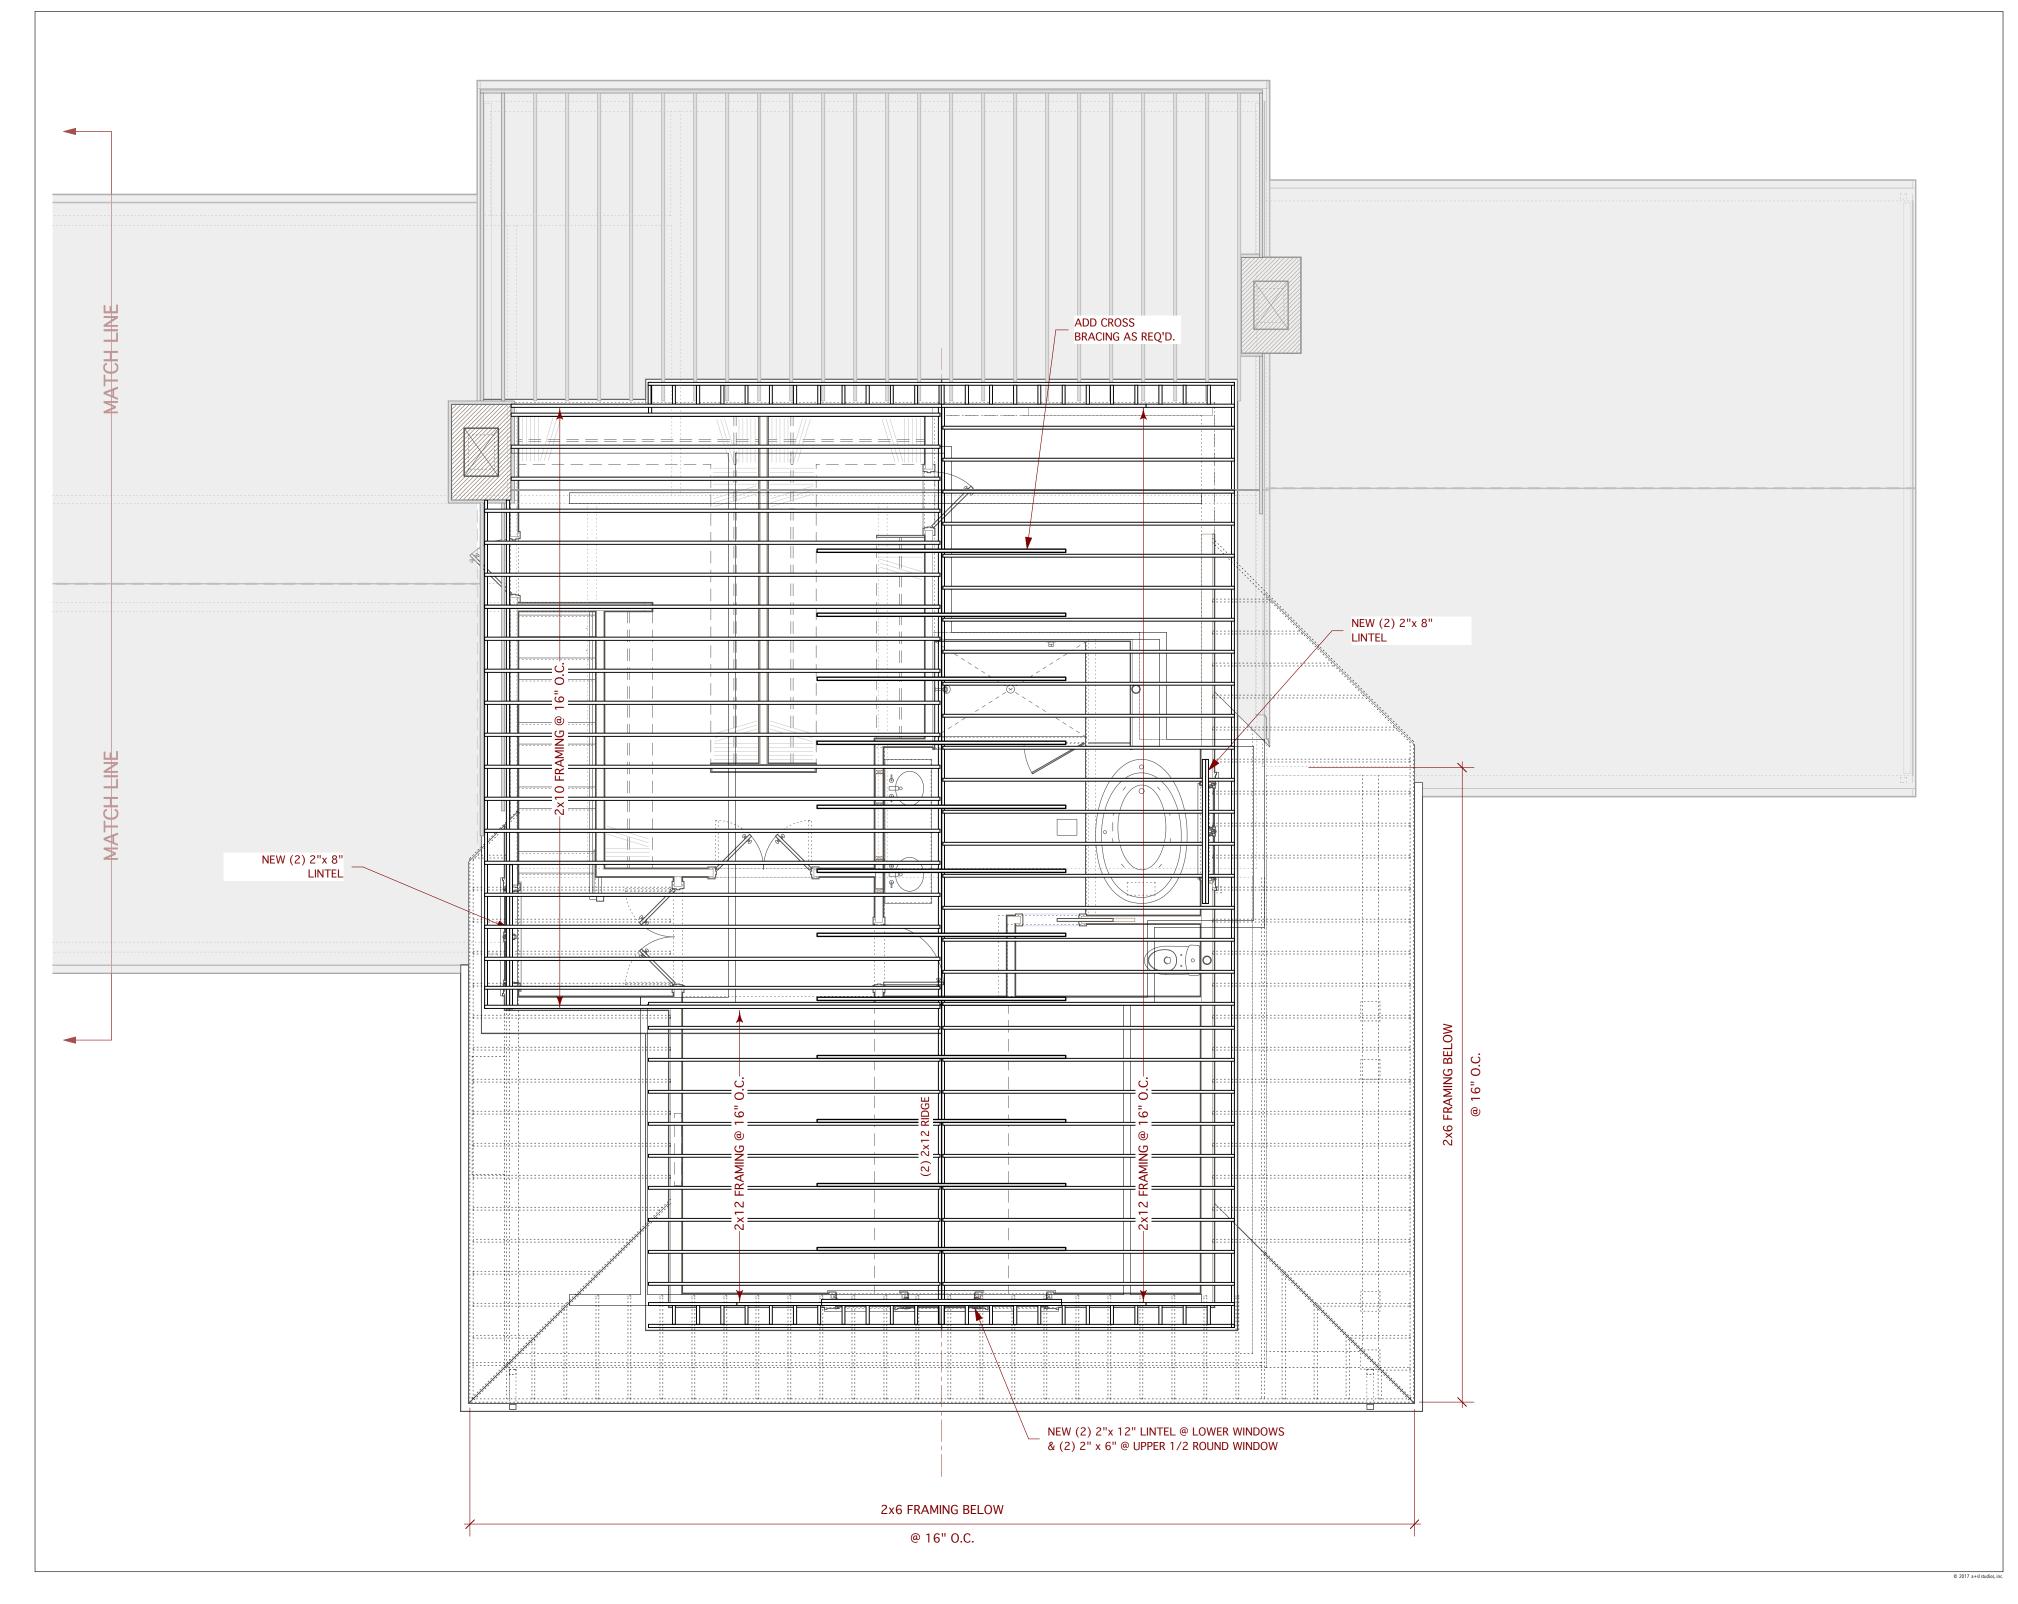




Architects, inc. NCARR, LEED\_AP BD+C

THESE DRAWINGS ARE COPYRIGHT AND THE PROPERTY OF a+sl studios, inc. DRAWINGS AND OTHER MATERIALS ARE PROTECTED BY THE COPYRIGHT PROTECTION ACT.

FURTHER COPIES MUST NOT BE MADE WITHOUT PERMISSION.

a+si studios, inc. SHALL ACCEPT NO LIABILITY FOR ANY USE MADE OF THE DRAWINGS OTHER THAN THAT FOR WHICH THEY WERE PREPARED.

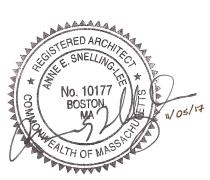

DIGITAL COPY - FOR BLDG. DEPT. RECORD ONLY. NOT TO BE REPRODUCED

# Tsao Residence

Residential Renovation & Addition 1771 Washington Street Newton, ma. 02466

#	DESCRIPTION / DATE
SCALE	
DATE	02/08/17
DRAWN BY	ASL
PROJECT NO	)0716

