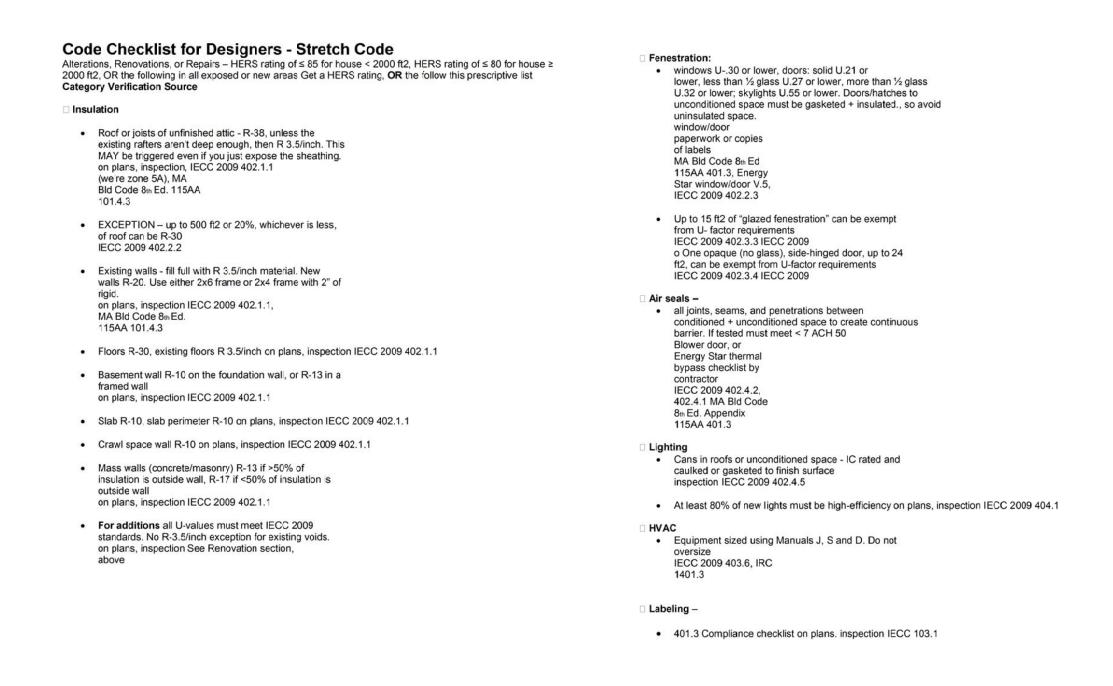
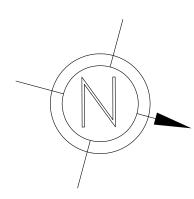
INSULATION GUIDELINES



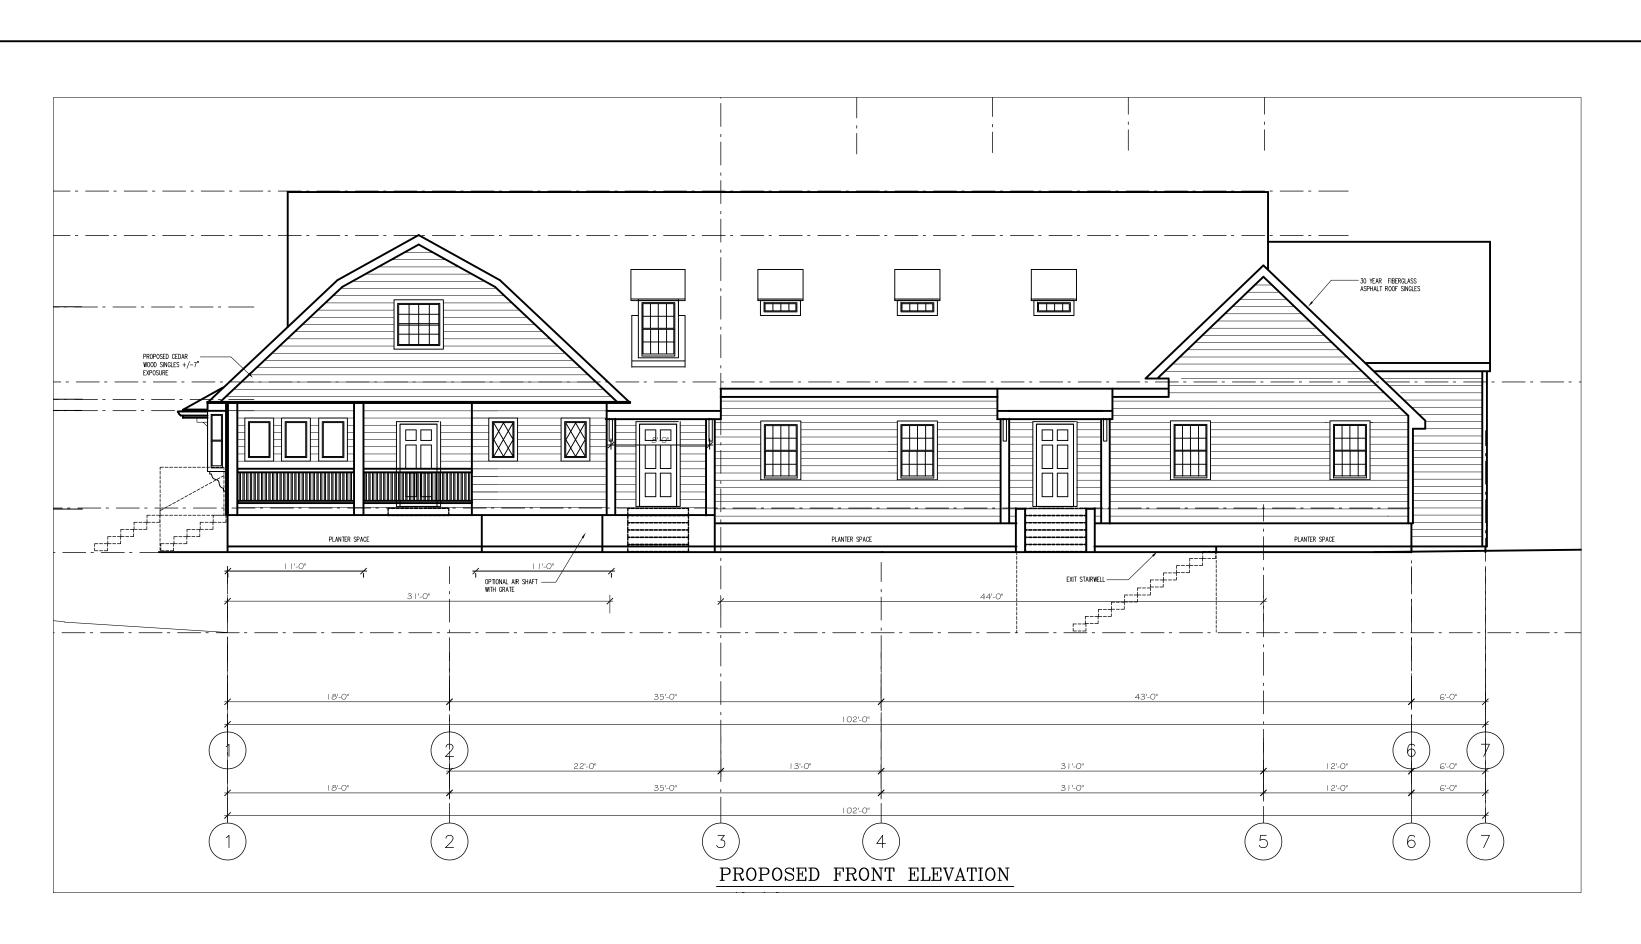


SEE VTPPLS, NEWTON HIGHLANDS, MA CURRENT SURVEY PLAN

SITE PLAN NTS

15 SOUTH GATE PARK, WEST NEWTON, MA 02465

	EXISTING WALLS TO REMAIN	AL APPROX BD BLDG	Aluminum Approximately Board Building	MIN MISC NIC	Minimum Miscellane Not In Cc
	TO BE REMOVED NEW WALLS	CLG CLR COL	Ceiling Clear Column	NTS OPP P.LAM PL	Not To So Opposite Plastic Lo Plaster
(N) (E)	NEW EXISTING	CONC CONSTR CONT CPT	Concrete Construction Continuous Carpet	PTD REQ RO	Painted Required Rough Op
Detail No.	BUILDING SECTION	CT CTR DET DIA	Ceramic Tile Center Detail Diameter	SIM SST STD STL STOR	Similar Stainless Standard Steel Storage
Detail No.	DETAIL SECTION	DISP DN DWG ELEC	Dispenser Down Drawing Electric(Electrical)	SUSP T&G THK TYP	Suspended Tongue & Thick Typical
	PARTITION TYPE	EQ ETR EXIST FFL	Equal Existing to Remain Existing Finish Floor	VCB VPB WC WD	Vinyl Cove Veneer Pla Water clos Wood
	NEW DOOR & DOOR NUMBER	GA GL GWB	Gauge Glass Gypsum Wall Board	W/ W/O WT	With Without Weight
Drawing No.	WINDOW NUMBER	HCP HDP HR	Handicapped High Density Polymer Hour		-
### #Elevation No.	INTERIOR ELEVATION	HT INSUL LT MAX MECH	Height Insulation(Insulated) Light Maximum Mechanical		
LEGEND		ABBI	REVIATIONS		



15 South Gate Park, West Newton, MA 02465 **RESIDENTIAL RENOVATION AND ALTERATION**

LIST OF DRAWINGS

A-0	TITLE SHEET
A-1	NOTES & MATERIALS
A-2	PROPOSED BASEMENT GARAGE FLOOR PLAN
A-2a	BASE GARAGE TURNING MOVE FLOOR PLAN
A-3	PROPOSED FIRST FLOOR PLAN
A-4	PROPOSED SECOND FLOOR PLAN
A-5	PROPOSED ATTIC FLOOR PLAN
A-6	PROPOSED ROOF PLAN
A-7	PROPOSED FRONT ELEVATION
A-8	PROPOSED RIGHT SIDE ELEVATION
A-9	PROPOSED LEFT SIDE ELEVATION
A-10	PROPOSED REAR ELEVATION
A-11	PROPOSED CROSS SECTION
A-12	PROPOSED SECTION B-B
A-13	PROPOSED WALL SECTIONS
A-14	PROPOSED SECTIONS & DETAILS
A-15	PROPOSED SECTIONS & DETAILS
F-1	
F-2	PROPOSED FIRST FLOOR FRAMING PLAN
F -3	PROPOSED SECOND FLOOR FRAMING PLAN
F-4	PROPOSED ATTIC & THIRD FLOOR FRAMING PLAN
F-5	PROPOSED ROOF FRAMING PLAN
F-6	
EX-0	EXISTING BASEMENT FLOOR PLAN (similar above)
EX-1	
	EXISTING ELEVATION
	EXISTING ELEVATION
EX-4	EXISTING ELEVATION

neous Contract Scale

Laminate

Dpening

Steel

ed & Groove

ve Base Plaster Base oset

Architect: Ronald F. Jarek

487 Watertown Street Newtonville, MA 02460 (617) 818-4540



PECIAL	SET	UPDATE:	11/28/2016

SHEE TITLE 465 15 SOUTH GATE PARK WEST NEWTON, MA 02 . SET PERMIT SPECIAL ALTERATIONS RK 02465 K, 02465 ళ NO PROJECT: RENOVATIC 15 SOUTH GATE PARK WEST NEWTON, MA 02 WEST NEWTON, MA 02 15 SOUTH GATE PARI WEST NEWTON, MA 0 Architect 487 Watertown Street Newtonville, MA 02460 Ronald F. Jarek, 4/22/2015 AS NOTED AWN BY: N.G.HECKED BY: R.JA-0

ໄ WEST NEWTON, MA 02465 SOUTH GATE PARK RESID DENCE

S

GENERAL NOTES

ALL WORK SHALL COMPLY WITH THE COMMONWEALTH OF MASSACHUSETTS STATE BUILDING CODE, THE REQUIREMENTS OF THE CITY OF NEWTON, THE OCCUPATIONAL SAFETY AND HEALTH STANDARDS AND ALL OTHER APPLICABLE REGULATIONS, LAWS, ORDINANCES, ETC. GOVERNING THIS WORK INCLUDING HERS RATINGS.
 PRIOR TO SUBMITTING BID, CONTRACTOR MUST THOROUGHLY EXAMINE THE DRAWINGS, AND INSPECT THE BUILDING TO FULLY UNDERSTAND THE FACILITY, DIFFICULTIES AND RESTRICTIONS AFFECTING THE EXECUTION OF THE WORK UNDER THIS CONTRACT. THE FAILURE OF THE CONTRACTOR TO RECEIVE OR EXAMINE ADDITIONAL COST WILL BE ALLOWED DUE TO LACK OF FULL KNOWLEDGE OF EXISTING CONDITIONS.
 CONTRACTOR'S BID PRICE SHALL REFLECT ALL SPECIFIED WORK.
 DRAWN INFORMATION IS TAKEN FROM EXISTING CONDITIONS AND RANDOM FIELD MEASUREMENTS AND IS PROVIDED ONLY TO ASSIST THE CONTRACTOR IN ESTABLISHING THE SCOPE OF WORK.
 DRAWN INFORMATION IS TAKEN FROM EXISTING CONDITIONS SHOULD BE VERIFIED IN THE FIELD PRIOR TO COMMENCING THE WORK. THE CONTRACTOR SHALL NOTIFY THE OWNER OF ANY DISCREPANCIES FOUND IN THE PLANS OR SPECIFICATIONS BEFORE PROCEEDING WITH THE AFFECTED PART OF THE WORK.
 DI NOT SCALE THESE DRAWINGS SHOW EVERY CUT, CONDITION ETC. OF THIS SYSTEM, HOWEVER, THE CONTRACTOR SHALL FURNISH A COMPLETE PRODUCT IN ACCORDANCE WITH THE BEST PRACTICE OF THE TRADE TO THE SATISFACTION OF THE ARCHITECT AND THE OWNER, AND IN STRICT CONFORMANCE WITH ALL APPLICABLE LOCAL AND STATE BUILDING CODE REGULATIONS.

00 CONTRACTOR SHALL REPAIR ALL AREAS DAMAGED BY DEMOLITION PRIOR TO INSTALLATION OF NEW MATERIAL

9. WITH IF HAZARDOUS WASTES ENCOUNTERED, STOP WORK & CONTACT THE OWNER & ARCHITECT IMMEDIATELY DHCD STANDARDS. TO INITIATE ABATEMENT

GENERAL NOTES STRUCTURAL

ALL WORK SHALL COMPLY WITH THE STATE OF MASSACHUSETTS BUILDING CODE, REQUIREMENTS OF THE CITY OF NEWTON, AND ALL OTHER LOCAL, STATE AND FEDERAL STANDARDS AND REGULATIONS.
 DO NOT SCALE THIS DRAWING. REFER TO ARCHITECTURAL DRAWINGS FOR DIMENSIONS, LIMITS AND LOCATIONS REGARDING LAYOUT OF ALL STRUCTURAL FRAMING MEMBERS AND COMPONENTS. REFER TO ARCHITECTURAL DWGS, FOR ALL ELEVATIONS.
 THE STRUCTURAL DRAWINGS SHALL BE USED IN CONJUNCTION WITH THE ARCHITECTURAL, MECHANICAL AND ELECTRICAL DRAWINGS AND THESE DRAWINGS SHALL BE REFERED TO FOR SIZE AND LOCATION OF APPURTENANCES.
 DIMENSIONS SHOWN ON THE DRAWINGS MUST BE COORDINATED WITH ARCHITECTURAL DRAWINGS PRIOR TO DETAILING, FABRICATION AND ERECTION OF APPURTENANCES.
 DIMENSIONS SHOWN ON THE DRAWINGS MUST BE COORDINATED WITH ARCHITECTURAL DRAWINGS PRIOR TO DETAILING, FABRICATION AND ERECTION OF ALL STRUCTURAL MEMBERS.
 DIMENSIONS SHOWN ON THE DRAWINGS MOUTONS MAY DIFFER FROM AS SHOWN. ALL EXISTING CONDITIONS AND DIMENSIONS MUST BE VERIFIED IN FIELD PRIOR TO COMMENCING THE WORK. ANY DISCREPENCIES FOUND SHALL BE BROUGHT TO THE ATTENTION OF THE ENGINEER BEFORE PROCEEDING WITH THE AFFECTED PART OF THE WORK. AND THE CONTRACT DOCUMENTS WILL NOT RELIEVE THE BIDDER FROM ANY OBLICATION UNDER THE SIDE BEFORE TO SO EXAMINE THE SITE AND THE CONTRACT DOCUMENTS WILL NOT RELIEVE THE BIDDER FROM ANY OBLICATION UNDER THE BID AS SUBMITTED.
 FABRICATOR FOR EACH STRUCTURAL TRADE SHALL PREPARE SHOP DRAWINGS SHOW DAVING LOCATION, LIMITS, DIMENSIONS AND EXTENT OF ALL MEMBERS, CONNECTIONS AND DETAILS TO BE SUBMITED FOR APPROVAL. NO ERECTION SHALL BE PERFORMED WITHOUT THE APPROVAL OF SHOP DRAWINGS.
 THE CONTRACTOR SHALL AND EAUCHY ALL DIMENSIONS AND EXTENT OF ALL MEMBERS, CONNECTIONS AND DETAILS TO BE SUBMITED FOR APPROVAL. NO ERECTION SHALL BE PERFORMED WITHOUT THE APPROVAL OF SHOP DRAWINGS.
 CONTRACTOR SHALL TAKE ADEGULATE PRECAUTIONS AT ALL TIMES TO PROTECT ADJOINING PROPERTY FROM

OUNDATION NOTES

1. FOOTINGS SHALL BE CARRIED TO ELEVATIONS SHOWN ON THE DRAWINGS AND DEEPER IF NECESSARY TO OBTAIN A SAFE BEARING PRESSURE OF AT LEAST 2000 POUNDS PER SQUARE FOOT. <u>CONTRACTOR SHALL VERIFY THE DESIGN BEARING CAPACITY THROUGH GEOTECHNICAL SERVICES PRIOR TO PLACING CONCRETE AND AFTER PLACEMENT HAS BEEN APPROVED.</u> 2. NO FOUNDATIONS SHALL BE PLACED ON FROZEN SOIL OR WATER. PROVIDE PROPER DRAINAGE OF EXCAVATION WITH PLASTIC PIPE TO PROTECT AGAINST WATER. WHERE IT IS NECESSARY TO RAISE THE GRADE BELOW SLAB DUE TO OVER EXCAVATION, STRUCTURAL FILL SHALL BE PLACED AND COMPACTED TO 95% DRY DENSITY. G PRESSURE OF AT LEAST RIOR TO PLACING CONCRETE

DENSITY. PROVIDE PROPER DRAINAGE

YWOOD NOTES

NN → ALL ALL PLYWOOD SHEATHING SHALL PLYWOOD SHALL HAVE A MI EDGES SHALL BE TONGUE A LL BE APA RATED STRUCTURAL I. PLYWOO MINIMUM THICKNESS OF 3/4". AND GROOVE JOINTED OR CONTINUOUSLY PLYWOOD USED FOR SUPPORTED ROOF WITH WOOD SHEATHING BLOCKING. SHALL ΒË EXTERIOR GRADE.

<u>CONCRETE</u> NOTES

8 (BUILDING ACI 305 R I FOR H E REQUIREMENTS FOR HOT WEATHER CURING.

FABRIC SHALL BE 6x6-W4xW4 UNLESS

 $^{\rm 2}$ 3/4" CHAMFER, USING EDGING TOOL WHERE NEEDED. EXPOSED CONCRETE SURFACE A UNIFORM TEXTURE WHILE CONCRETE IS STILL GREEN, TO PRODUCE A SURFACE A ES SHALL HAVE A PLYWOOD CCEPTABLE TO THE

 ALL WORK AND MATERIALS SHALL CONFORM TO THE LATEST EDITION OF AMERICAN CONCRETE INSTITUTE'S ACI 318 (BUILDIN REINFORCED CONCRETE). CONCRETING SHALL FOLLOW REQUIREMENTS OF ACI 306 R FOR COLD WEATHER CURING AND ACI 305
 CONCRETE STRENGTH SHALL BE AS FOLLOWS: ALL CONFORM TO ASTM A615 – GRADE 60.
 ALL BAR REINFORCEMENT SHALL CONFORM TO ASTM A185 AND SHALL BE SUPPLIED IN FLAT SHEETS. WELDED WIRE FABRIC SHALL CONFORM TO ASTM A185 AND SHALL BE SUPPLIED IN FLAT SHEETS. WELDED WIRE FABRIC SLABS: TOP – 2"
 MINIMUM CONCRETE CLEARANCES FOR PROTECTION OF REINFORCING: SLABS: TOP – 2"
 MALL: ALL SIDES – 2" (MIN.)
 ALL EXPOSED CONCRETE EDGES SHALL HAVE 3/4" CHAMFER, USING EDGING TOOL WHERE NEEDED. EXPOSED CONCRETE SU FINISH. JOINTS AND FINS SHALL BE SACKED TO A UNIFORM TEXTURE WHILE CONCRETE IS STILL GREEN, TO PRODUCE A SURFJ DESIGNERS & OWNER.
 CONSTRUCTION JOINT SPACING SHALL BE AS SHOWN ON THE DRAWINGS.
 BONDING AGENT FOR ADHERING NEW CONCRETE TO EXISTING CONCRETE SHALL BE APPLIED PRIOR TO POURING NEW CONC "WELDCRETE" AS MANUFACTURED BY LARSEN PRODUCTS CORP. OF ROCKVILLE, MD, OR APPROVED EQUAL.
 DOWELLING OF NEW REINFORCEMENT INTO EXISTING CONCRETE SHALL BE ACHIEVED BY USING THE HILTI HVA "ADHESIVE AN SHALL BE IN ACCORDANCE WITH MANUFACTURER'S PRINTED INSTRUCTIONS.
 CONTROL JOINTS SHALL BE PLACED THROUGHOUT AND EQUALLY SPACED NOT EXCEEDING 10' ON CENTER, IN ANY DIRECTI PRIOR TO POURING NEW CONCRETE. D EQUAL. THE HILTI HVA "ADHESIVE ANCHOR METHOD" BONDING AGENT SHALL BE ALL INSTALLATION

DIRECTION. ANCHOR

WOOD NOTE $\left| \mathcal{O} \right|$

1. ALL STRUCTURAL WOODWORK, MATERIALS AND WORKMANSHIP SHALL CONFORM TO THE LATEST EDITION OF CONSTRUCTION'S SPECIFICATION FOR DESIGN, FABRICATION AND ERECTION OF WOOD STRUCTURES. 2. ALL STRUCTURAL LUMBER SHALL BE SOUTHERN PINE, DOUGLAS FIR, GRADE 1 OR APPROVED EQUAL WITH MINIMUM PROPERTIES OF: E = 1,800,000 PSI, Fb = 1500 PSI, Fv = 190 PSI. THE AMERICAN **INSTIT** ÛTE

NOTE DIMENSION

ALL DIMENSIONS ARE APPROXIMATE. CONTRACTOR MUST VERIFY ALL AND PREPARE A LAYOUT DRAWING WITH ALL EXISTING CONDITION PRI WITH ANY NEW WORK. EXISTING RIOR TO PF PROCEEDING

• SEE ATTACHED MATERIALS LIST FOR PRODUCTS AND/OR

FINISHES

EXTERIOR MATERIALS LIST: 15 SOUTH GATE PARK., West Newton MA 02465

ROOF:

30 year Fiberglass Asphalt Shingles

Corrugated (black) Ridge Vent Black Vent Pipes Natural Heating Exhaust Stacks (flush style)

TRIM Azek or equal Rake, Cornice, Frieze, Water-table, and/or Running Trim

SIDING

7" to weather, texture side out, matching existing

Block outs

DOWN Square Butt Cedar Wood Shingles 7" to weather, texture Painted MDO Plywood at Dormer Pediments Azek or equal Direct Vent Exhaust Block Outs, Lighting Painted Side-wall Vents (Dryer, Exhaust Fans) through V SPOUTS AND GUTTERS Baked on Color Finish, Aluminum Box Trough Style w/ F Azek equal Blocks outs

WINDOWS Marvin or equal Insulated Glass, Simulated 2 over w/ Round Divided Lites Leaders and Ovals and Fittings

DOORS Simulated **Divided Side Lites**

COLUMNS Synthetic Panel Entry Units with Vision Lites and/or Sim Synthetic Panel Style Garage Door or Coiling Grill Style based 9 VentilationReqs

 Azek or equal Square synthetic and/or field built square Columns, Plinth and PORCH, DECK and STEPS and Ramps
 Trex or equal Porch, Deck and Stair Treads
 Azek or equal Risers and Stringers
 Synthetic Balustrade and Square Newel Posts, Synthetic Rail System at HC Plinth and Capital.

Ramps

HARDWARE

WALKS

DRIVEYAY

Floor Area Ratio Chart: ப் SOUTH GATE PARK RESIDENCES, WES-

BASEMENT ATTIC FLOOR AREA SECOND FLOOR FIRST AREA 끈 00 3776 1117 550 S.F SE Ś Ś NOT INCLUDED LESS PARTIAL CATHEDRAL THAN 7' 550 377 S.F Ś Ś NOT INCLUDED LESS THAN Ĺ, 1649 1496 S.F

3,145

SF.

5,507

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T INCLUDED

TOTAL S.F. ALLOWED @ 0.39 FAR

TOTAL S.F. PROVIDED 0.43 FAR

NEWTON, MA 02465

TOTAL SQ. FT. UNIT "1" 1667 S 1,227 SF. UNIT "2"

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TIMBER

PROCEDURES IN ACCORDANCE

LIGHTING

Wall Mounted Lantern Style

Stainless Steel Lever or Thumb Latch Style

Mail Boxes Stainless Steel House Numbers Stainless Steel

Modular Pavers at Entry Points

Bituminous

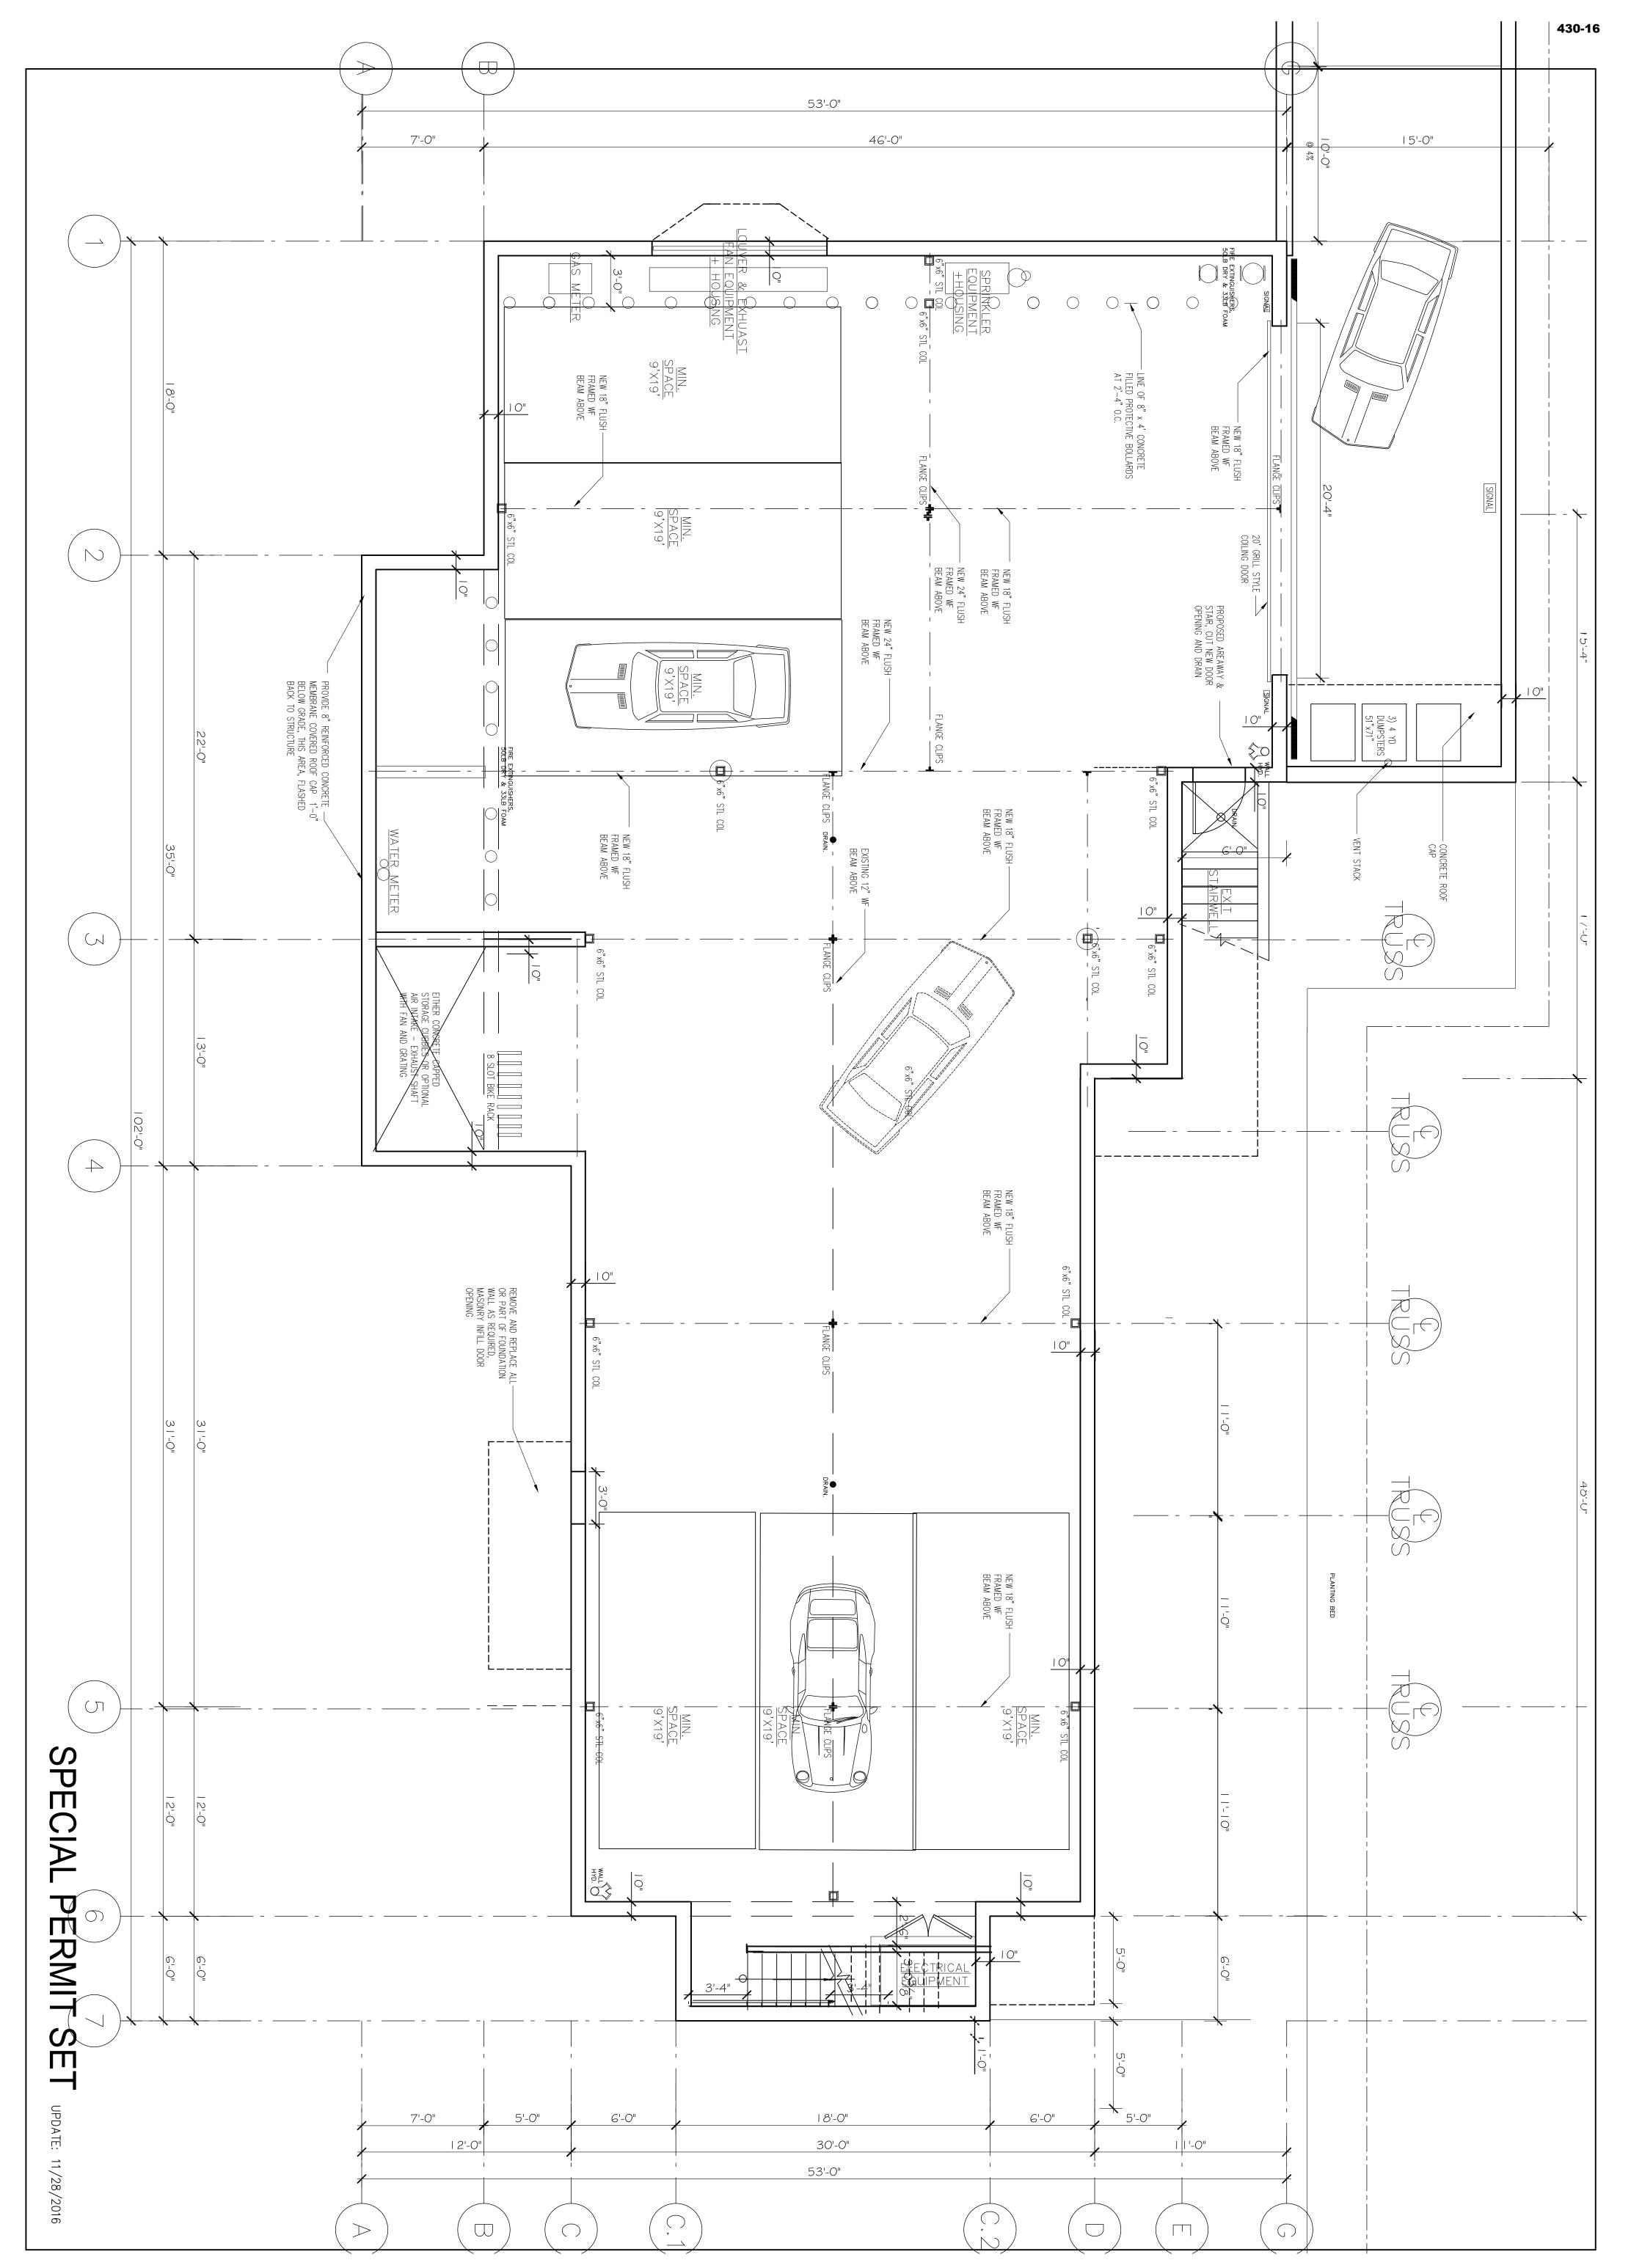
RETAINING WALLS
Concrete at Vehicular Ramp and Stone Faced (matrix)

SPECIAL PERMIT SE ____ UPDATE: 11/29/2016

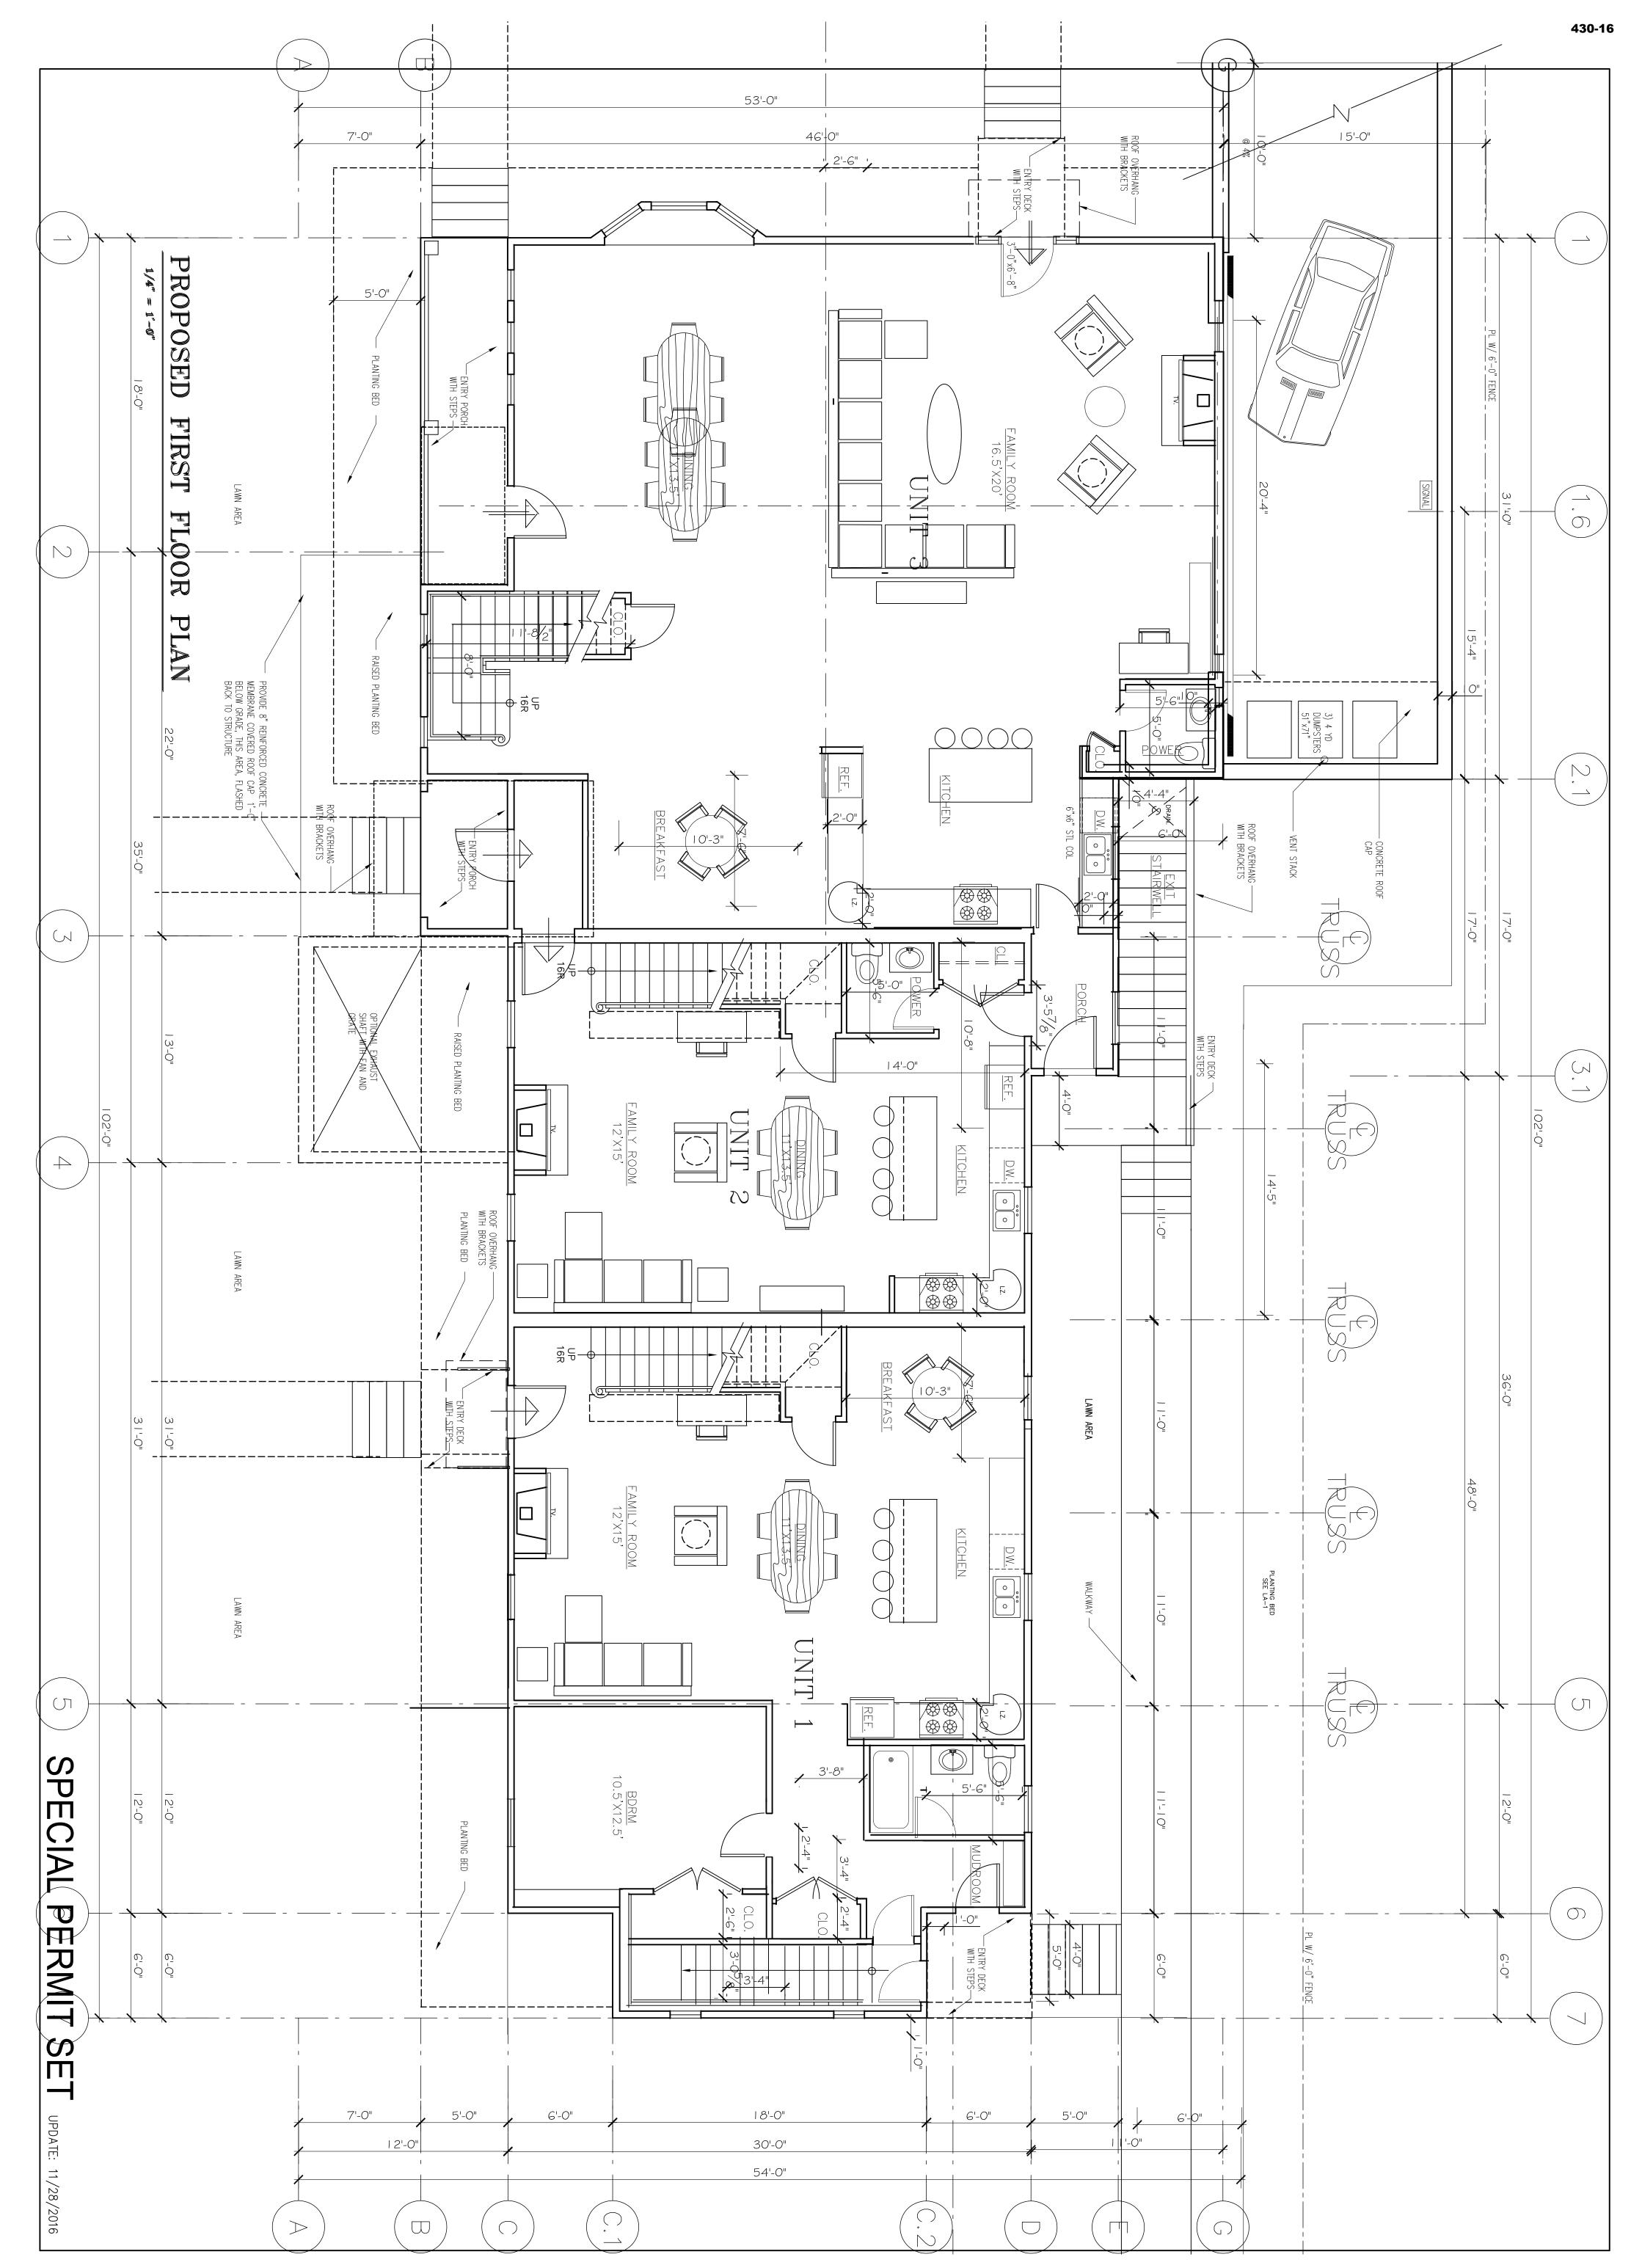
Belt, Brackets, Dentals, Corner

tch fdn) at Handicapped Ramp.

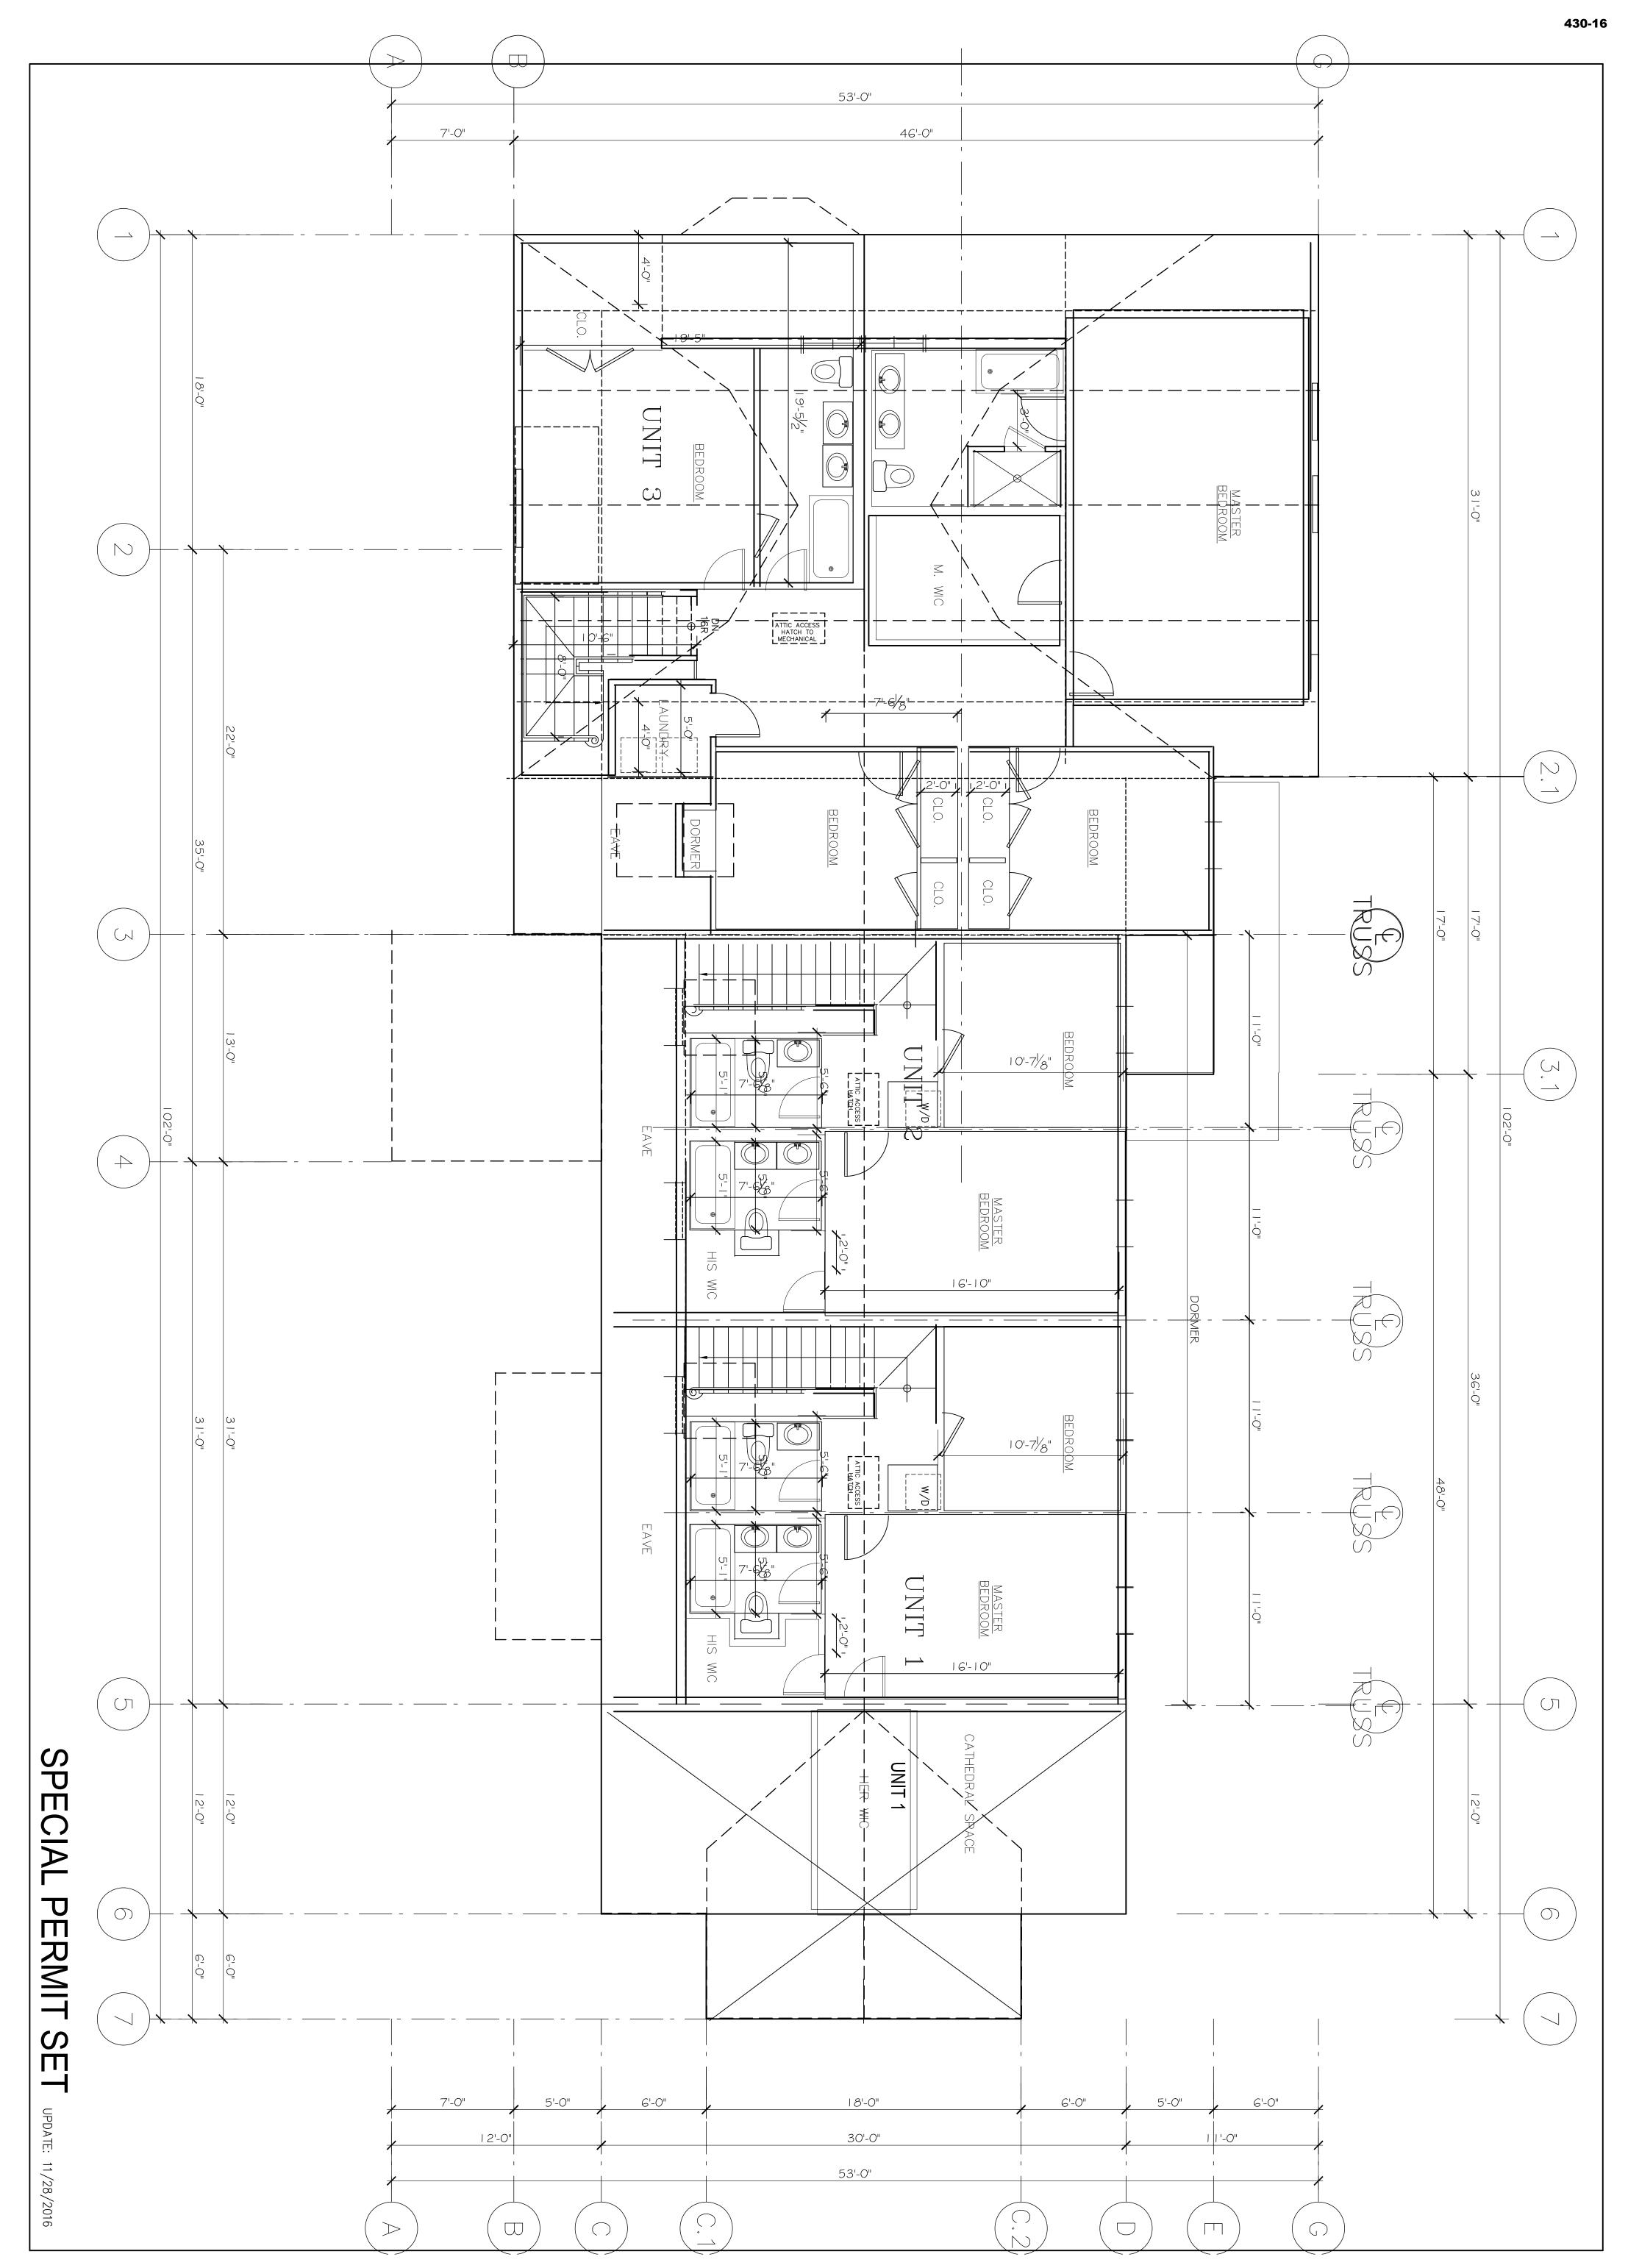
PROJECT: RENOVATION & ALTERATIONS, SPECIAL PERMIT SET - NOTES & MATERIALS Ronald F. Jarek, Architect R.J 15 SOUTH GATE PARK, \triangleright WEST NEWTON, MA 02465 487 Watertown Street Newtonville, MA 02460 CLIENT: 15 SOUTH GATE PARK **15 SOUTH GATE PARK** WEST NEWTON, MA 02465 WEST NEWTON, MA 02465



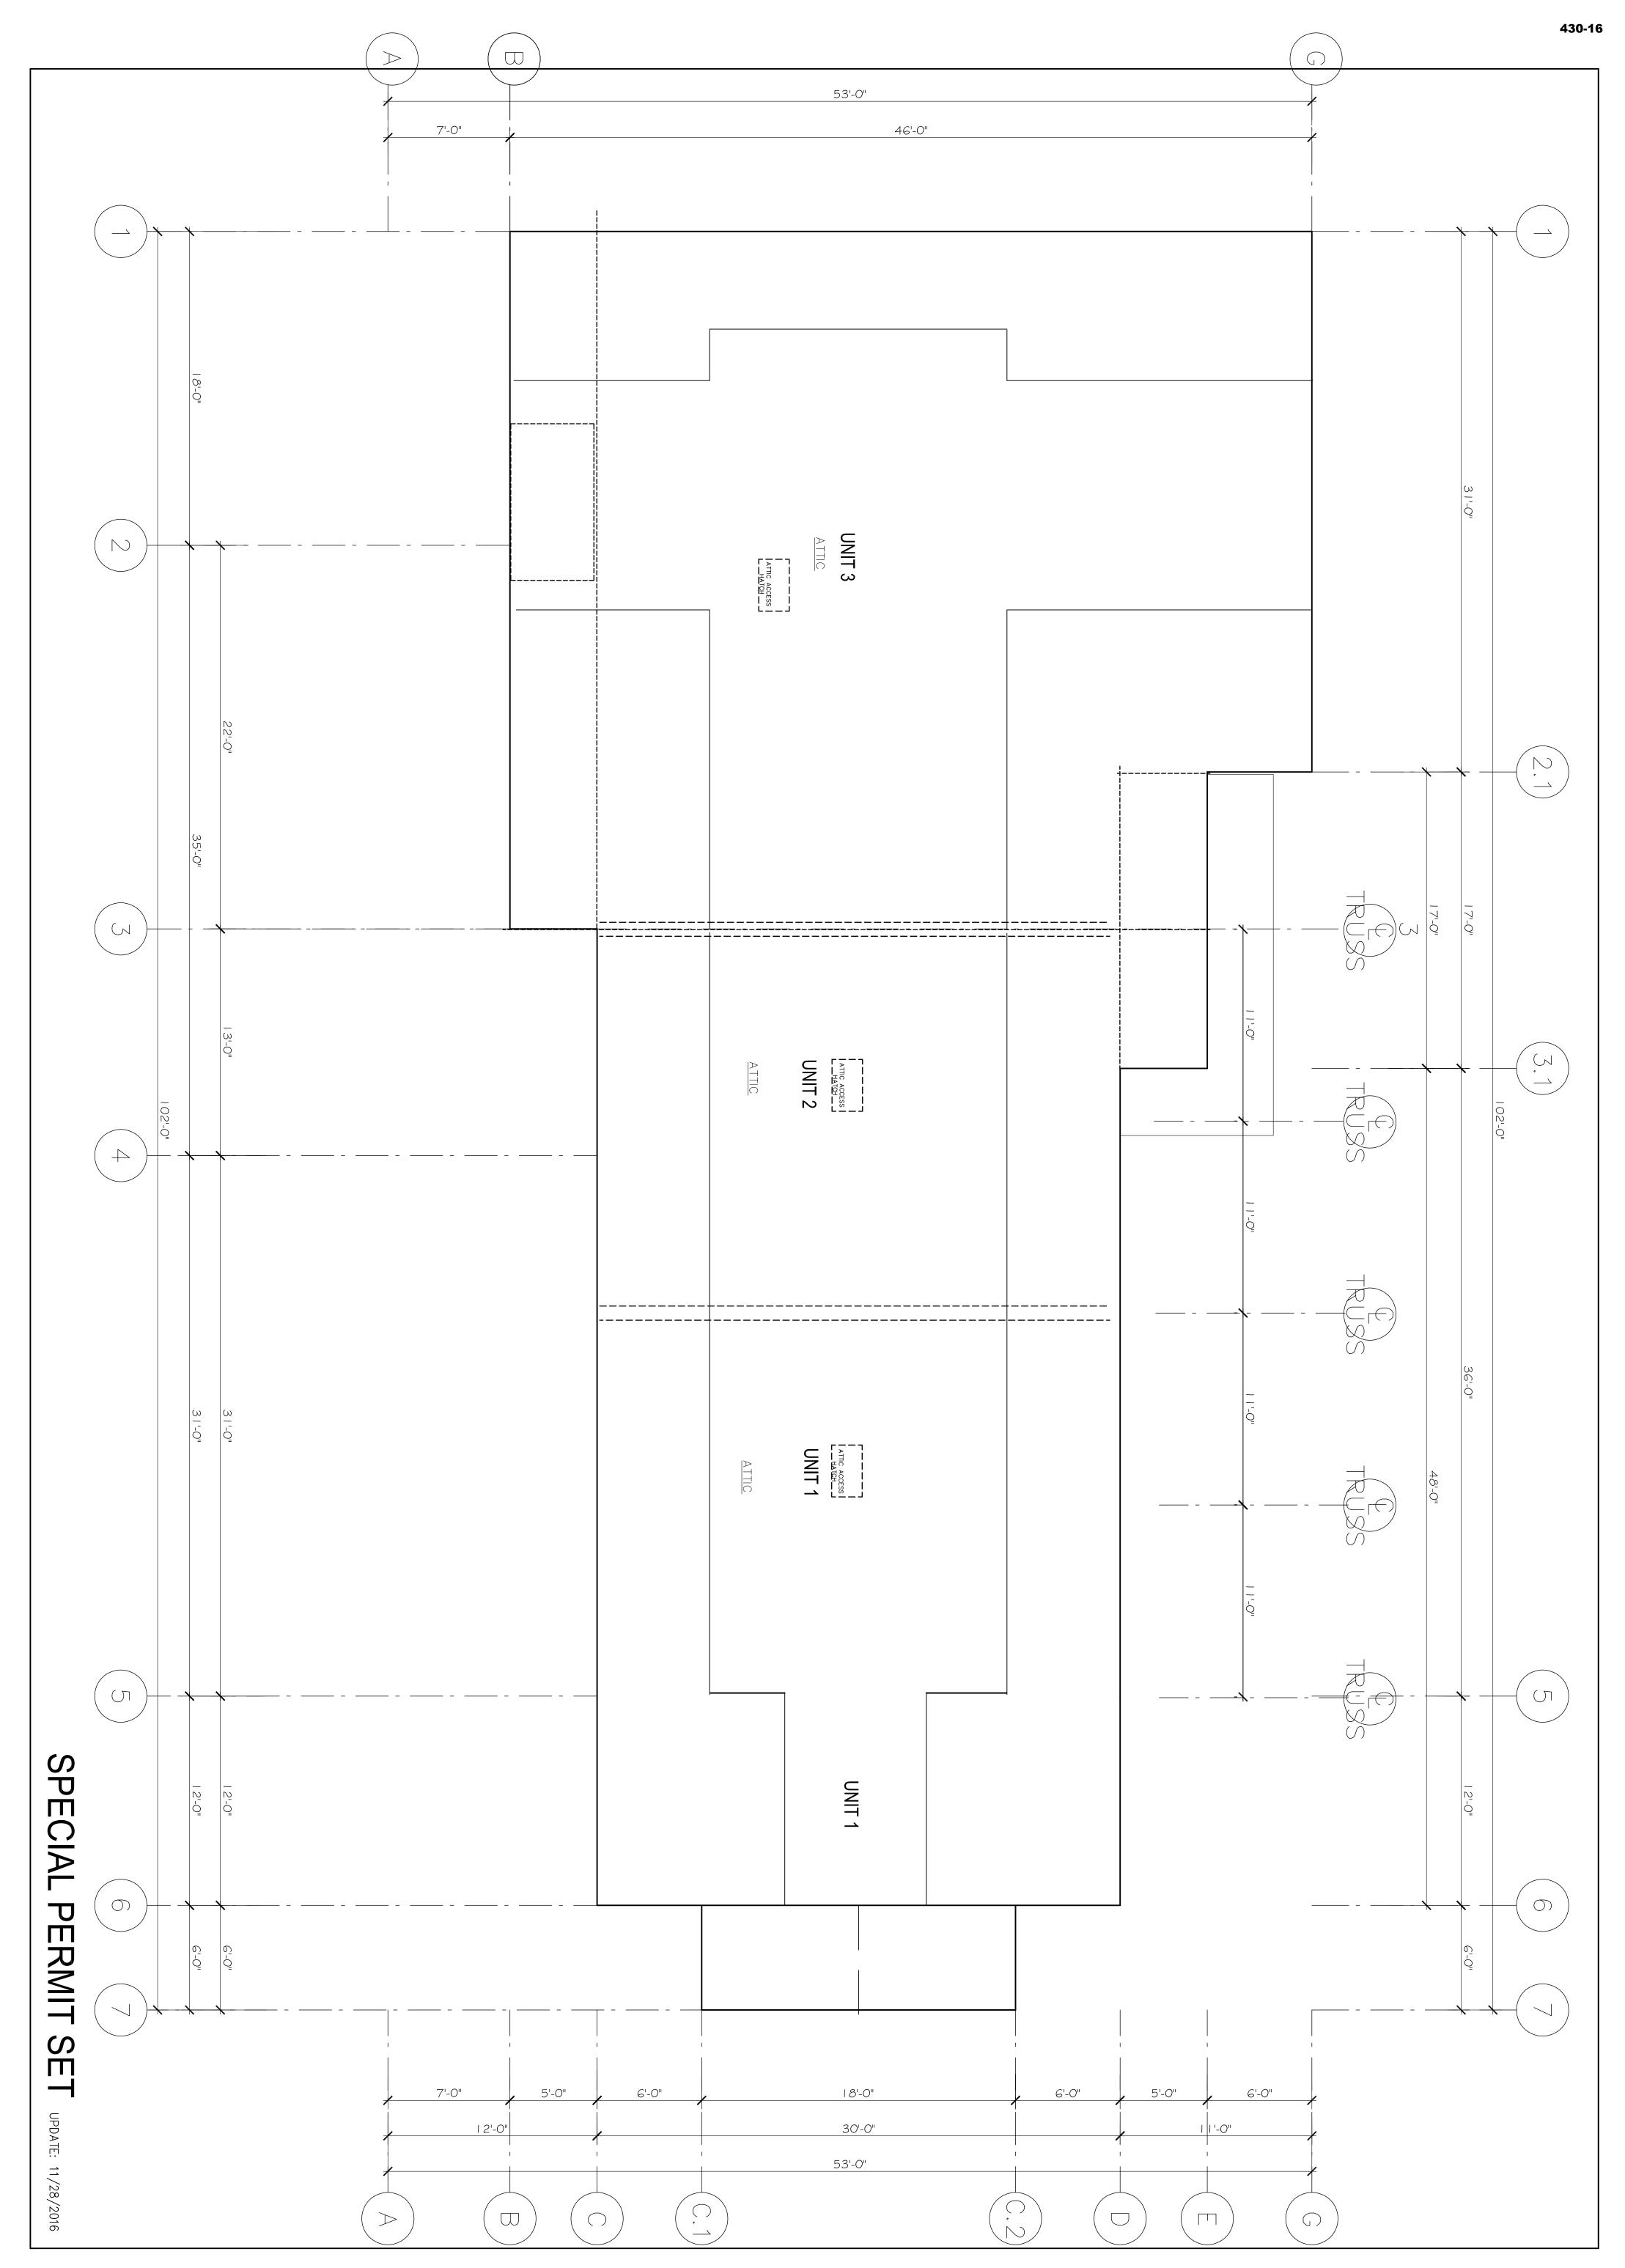
DATE: SCALE: AS NOTED DRAWN BY: N.G.H CHECKED BY: R.J REV: 6-6-2014 REV: 6-6-2014	Ronald F. Jarek, Architect 487 Watertown Street Newtonville, MA 02460	PROJECT: RENOVATION & ALTERATIONS, 15 SOUTH GATE PARK, WEST NEWTON, MA 02465 CLIENT: 15 SOUTH GATE PARK WEST NEWTON, MA 02465	BASEMENT GARAGE 15 SOUTH GATE PARK WEST NEWTON, MA 02465	STAME:
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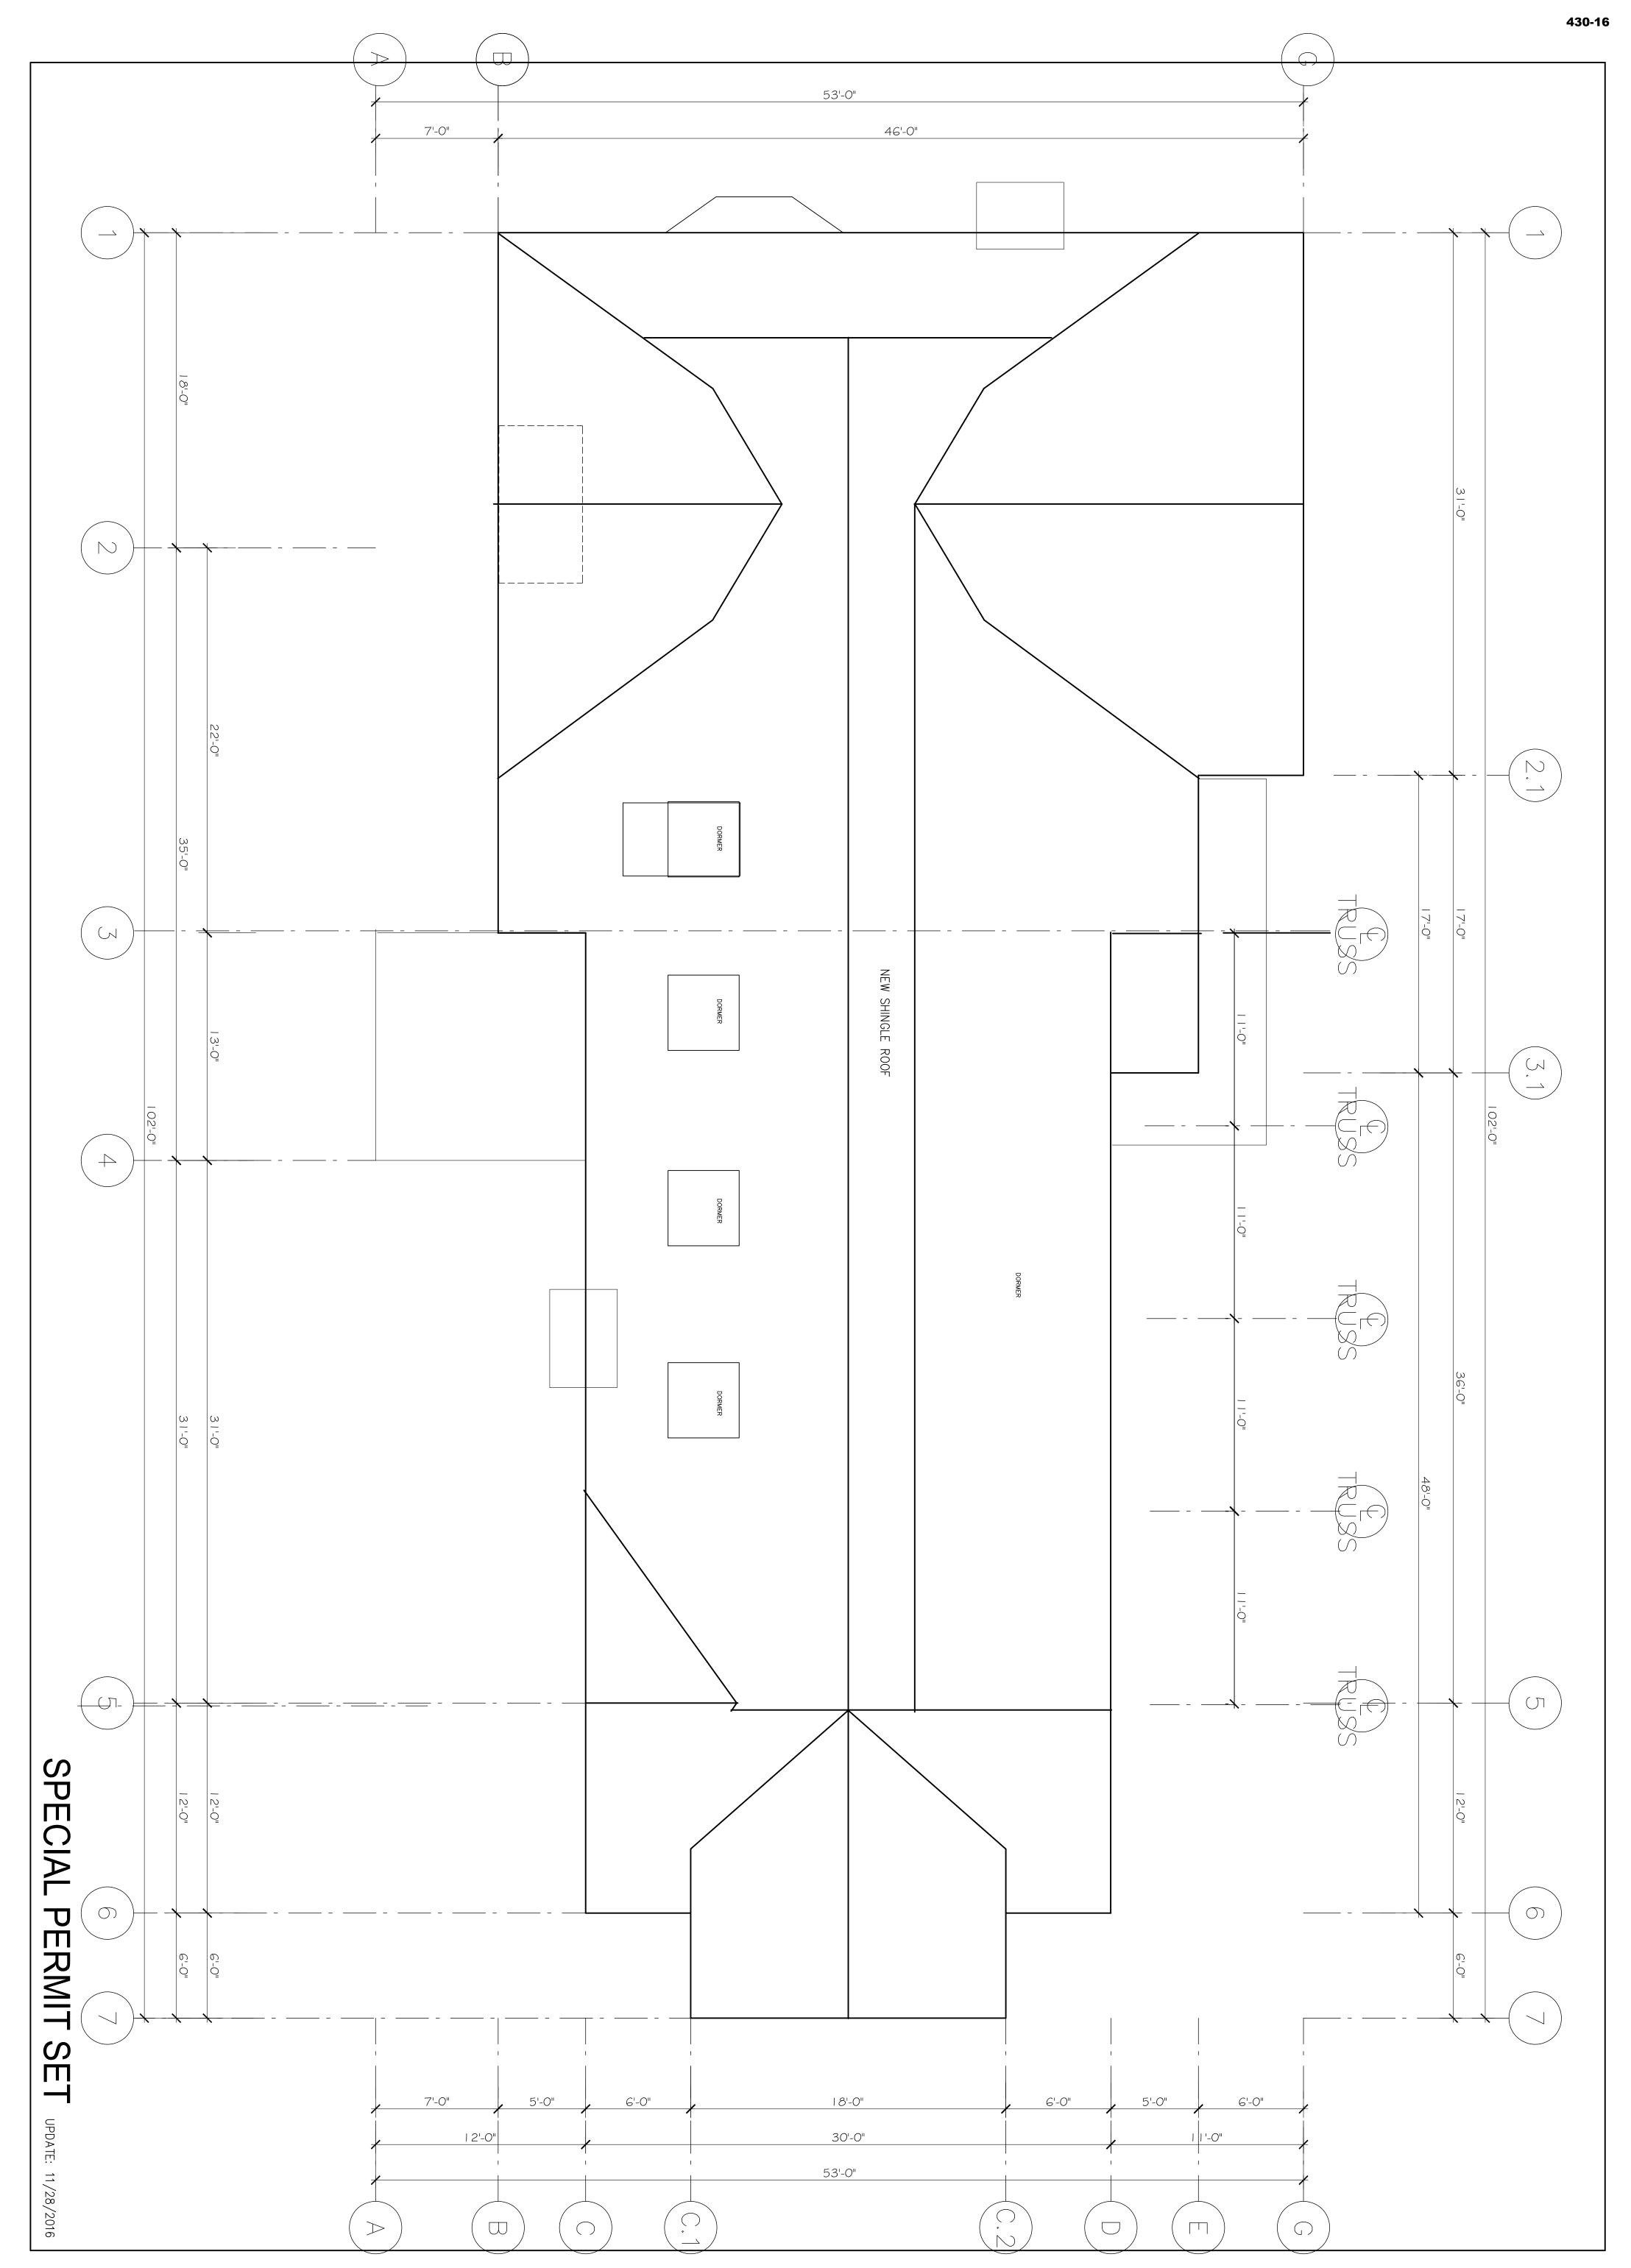
A-3	DATE: 4/22/2015 SCALE: AS NOTED DRAWN BY: N.G.H CHECKED BY: R.J REV : 6-6-2014	Ronald F. Jarek, Architect 487 Watertown Street Newtonville, MA 02460	PROJECT: RENOVATION & ALTERATIONS, 15 SOUTH GATE PARK, WEST NEWTON, MA 02465 CLIENT: 15 SOUTH GATE PARK WEST NEWTON, MA 02465	FIRST FLOOR PLAN - SPECIAL PERMIT SET 15 SOUTH GATE PARK WEST NEWTON, MA 02465	STAME:
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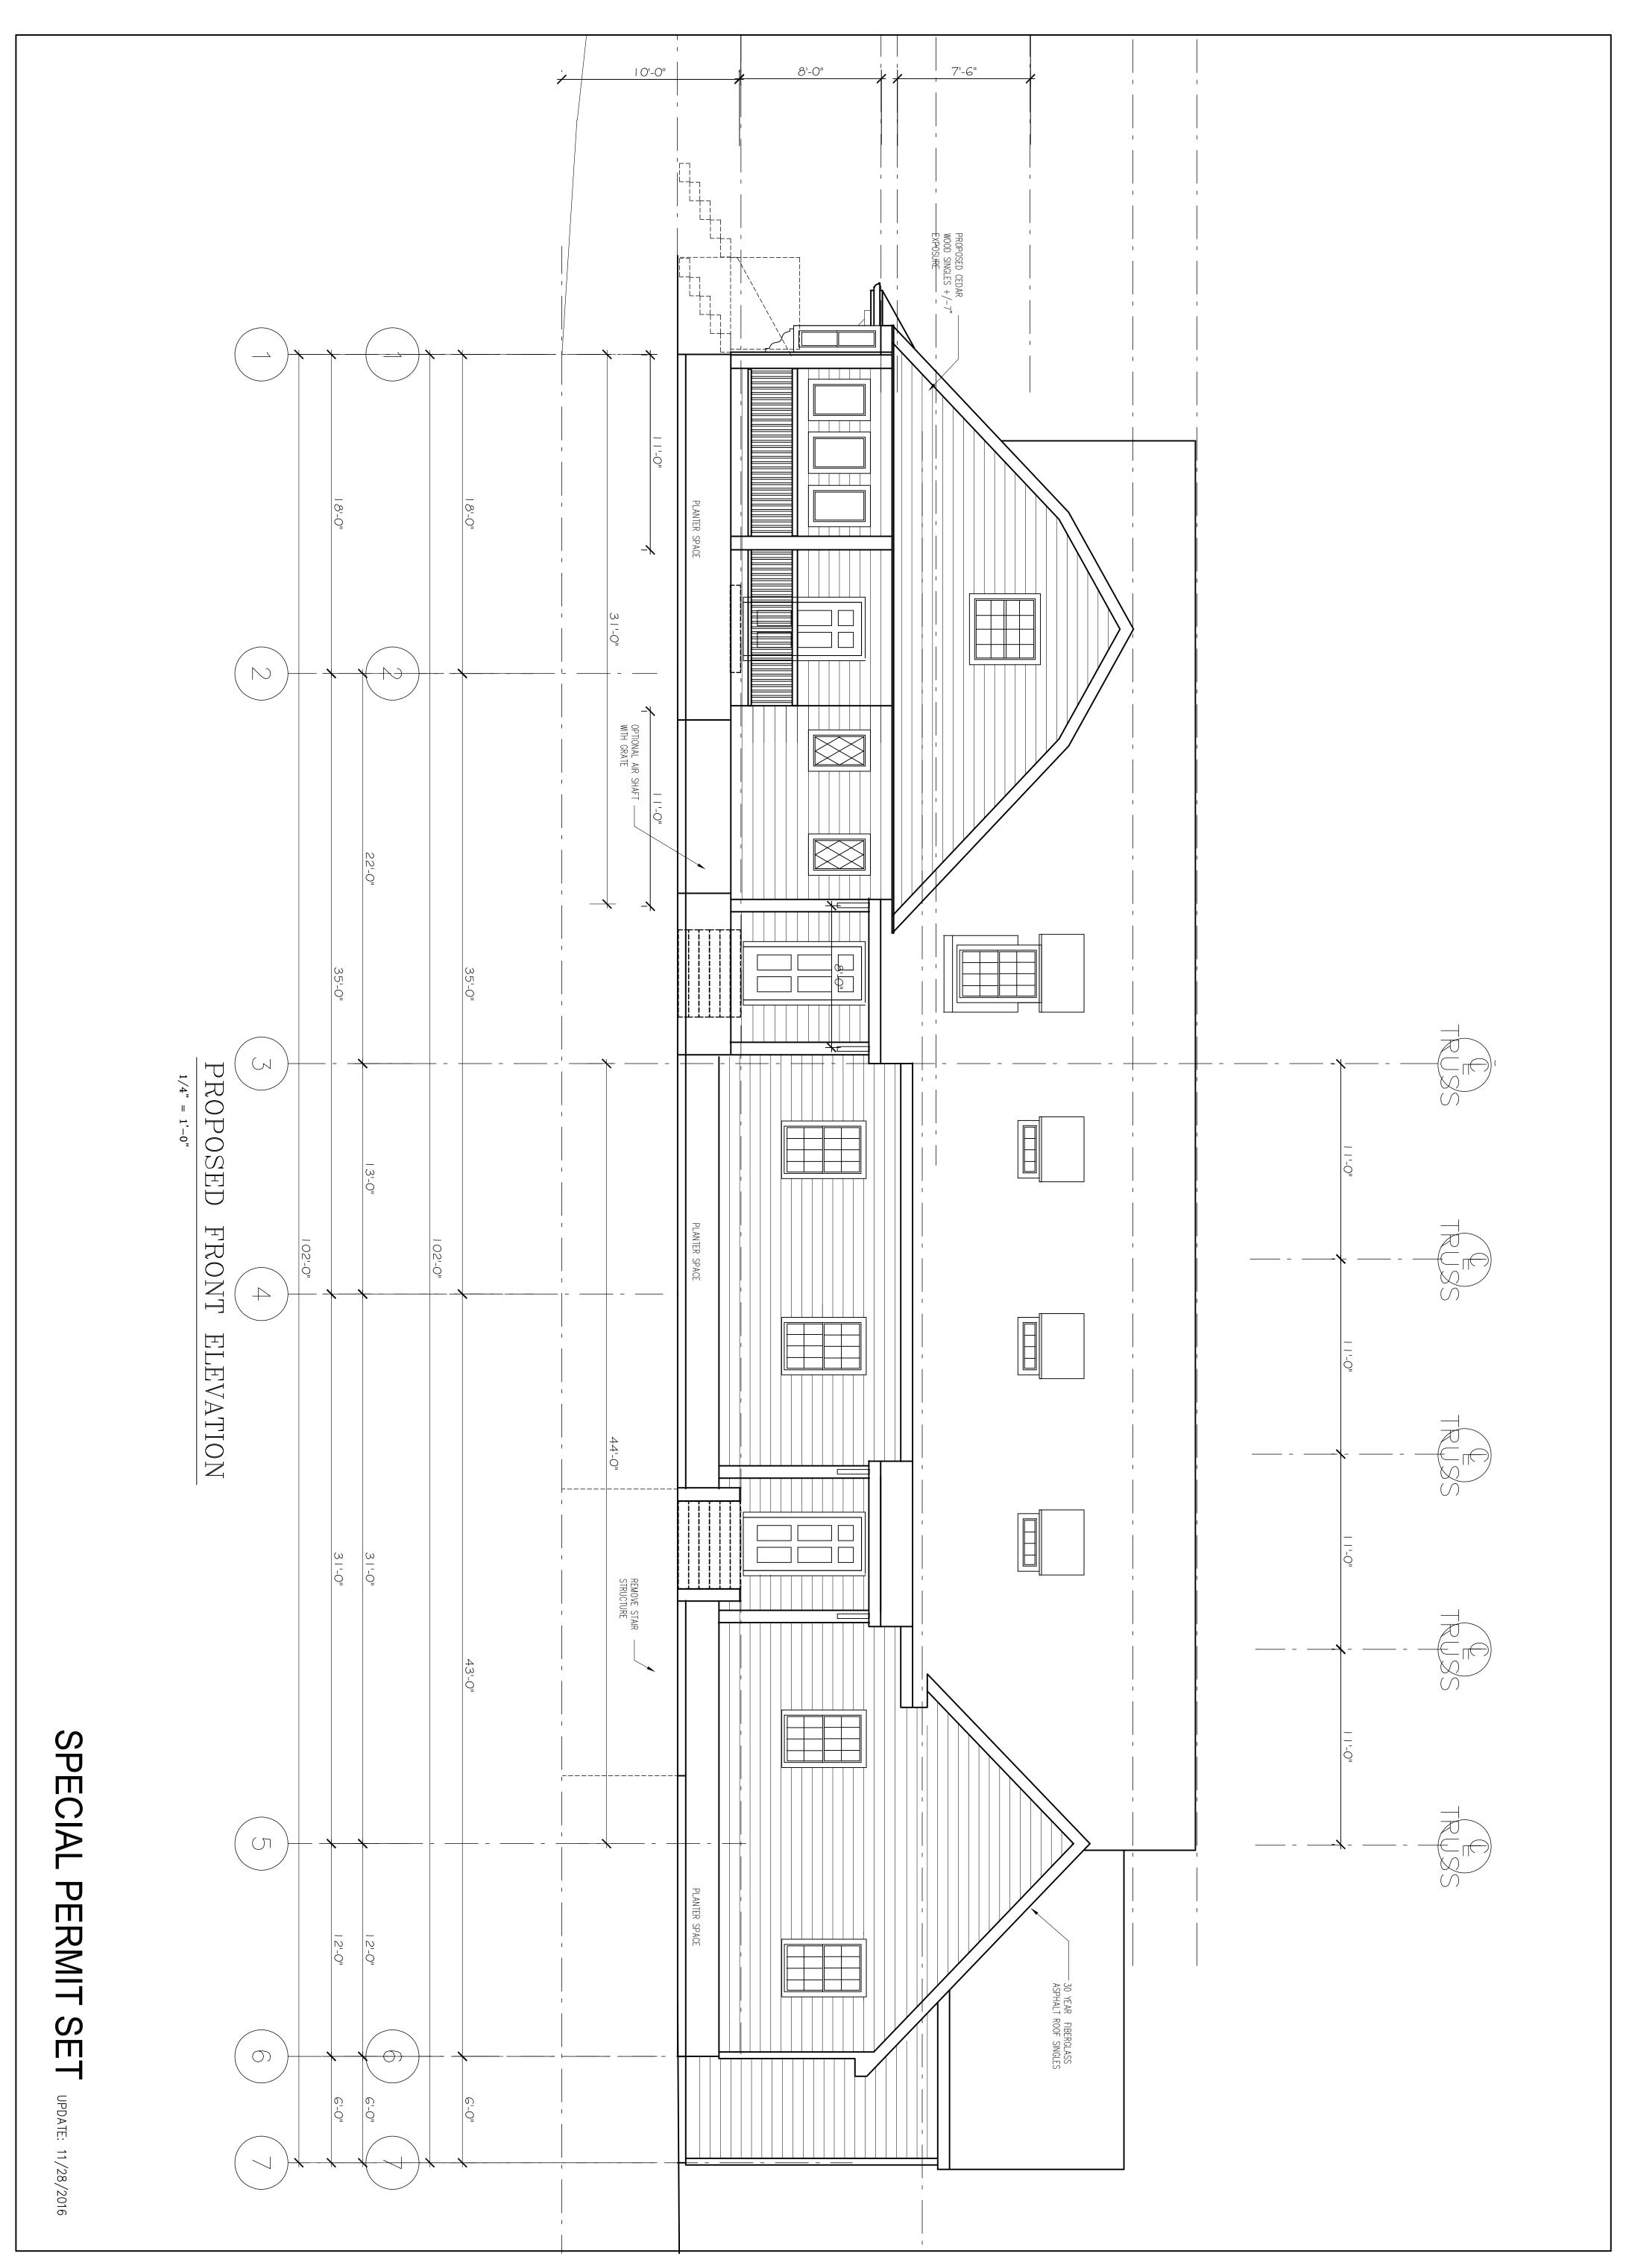
422/2015 SCALE: AS NOTED DRAWW BY: N.G.H CHECKED BY: R.J REV : 6-6-2014 REV : 6-6-2014	Ronald F. Jarek, Architect 487 Watertown Street Newtonville, MA 02460	PROJECT: RENOVATION & ALTERATIONS, 15 SOUTH GATE PARK, WEST NEWTON, MA 02465 CLIENT: 15 SOUTH GATE PARK WEST NEWTON, MA 02465	SECOND FLOOR PLAN - SPECIAL PERMIT SET 15 SOUTH GATE PARK WEST NEWTON, MA 02465	STAMP:
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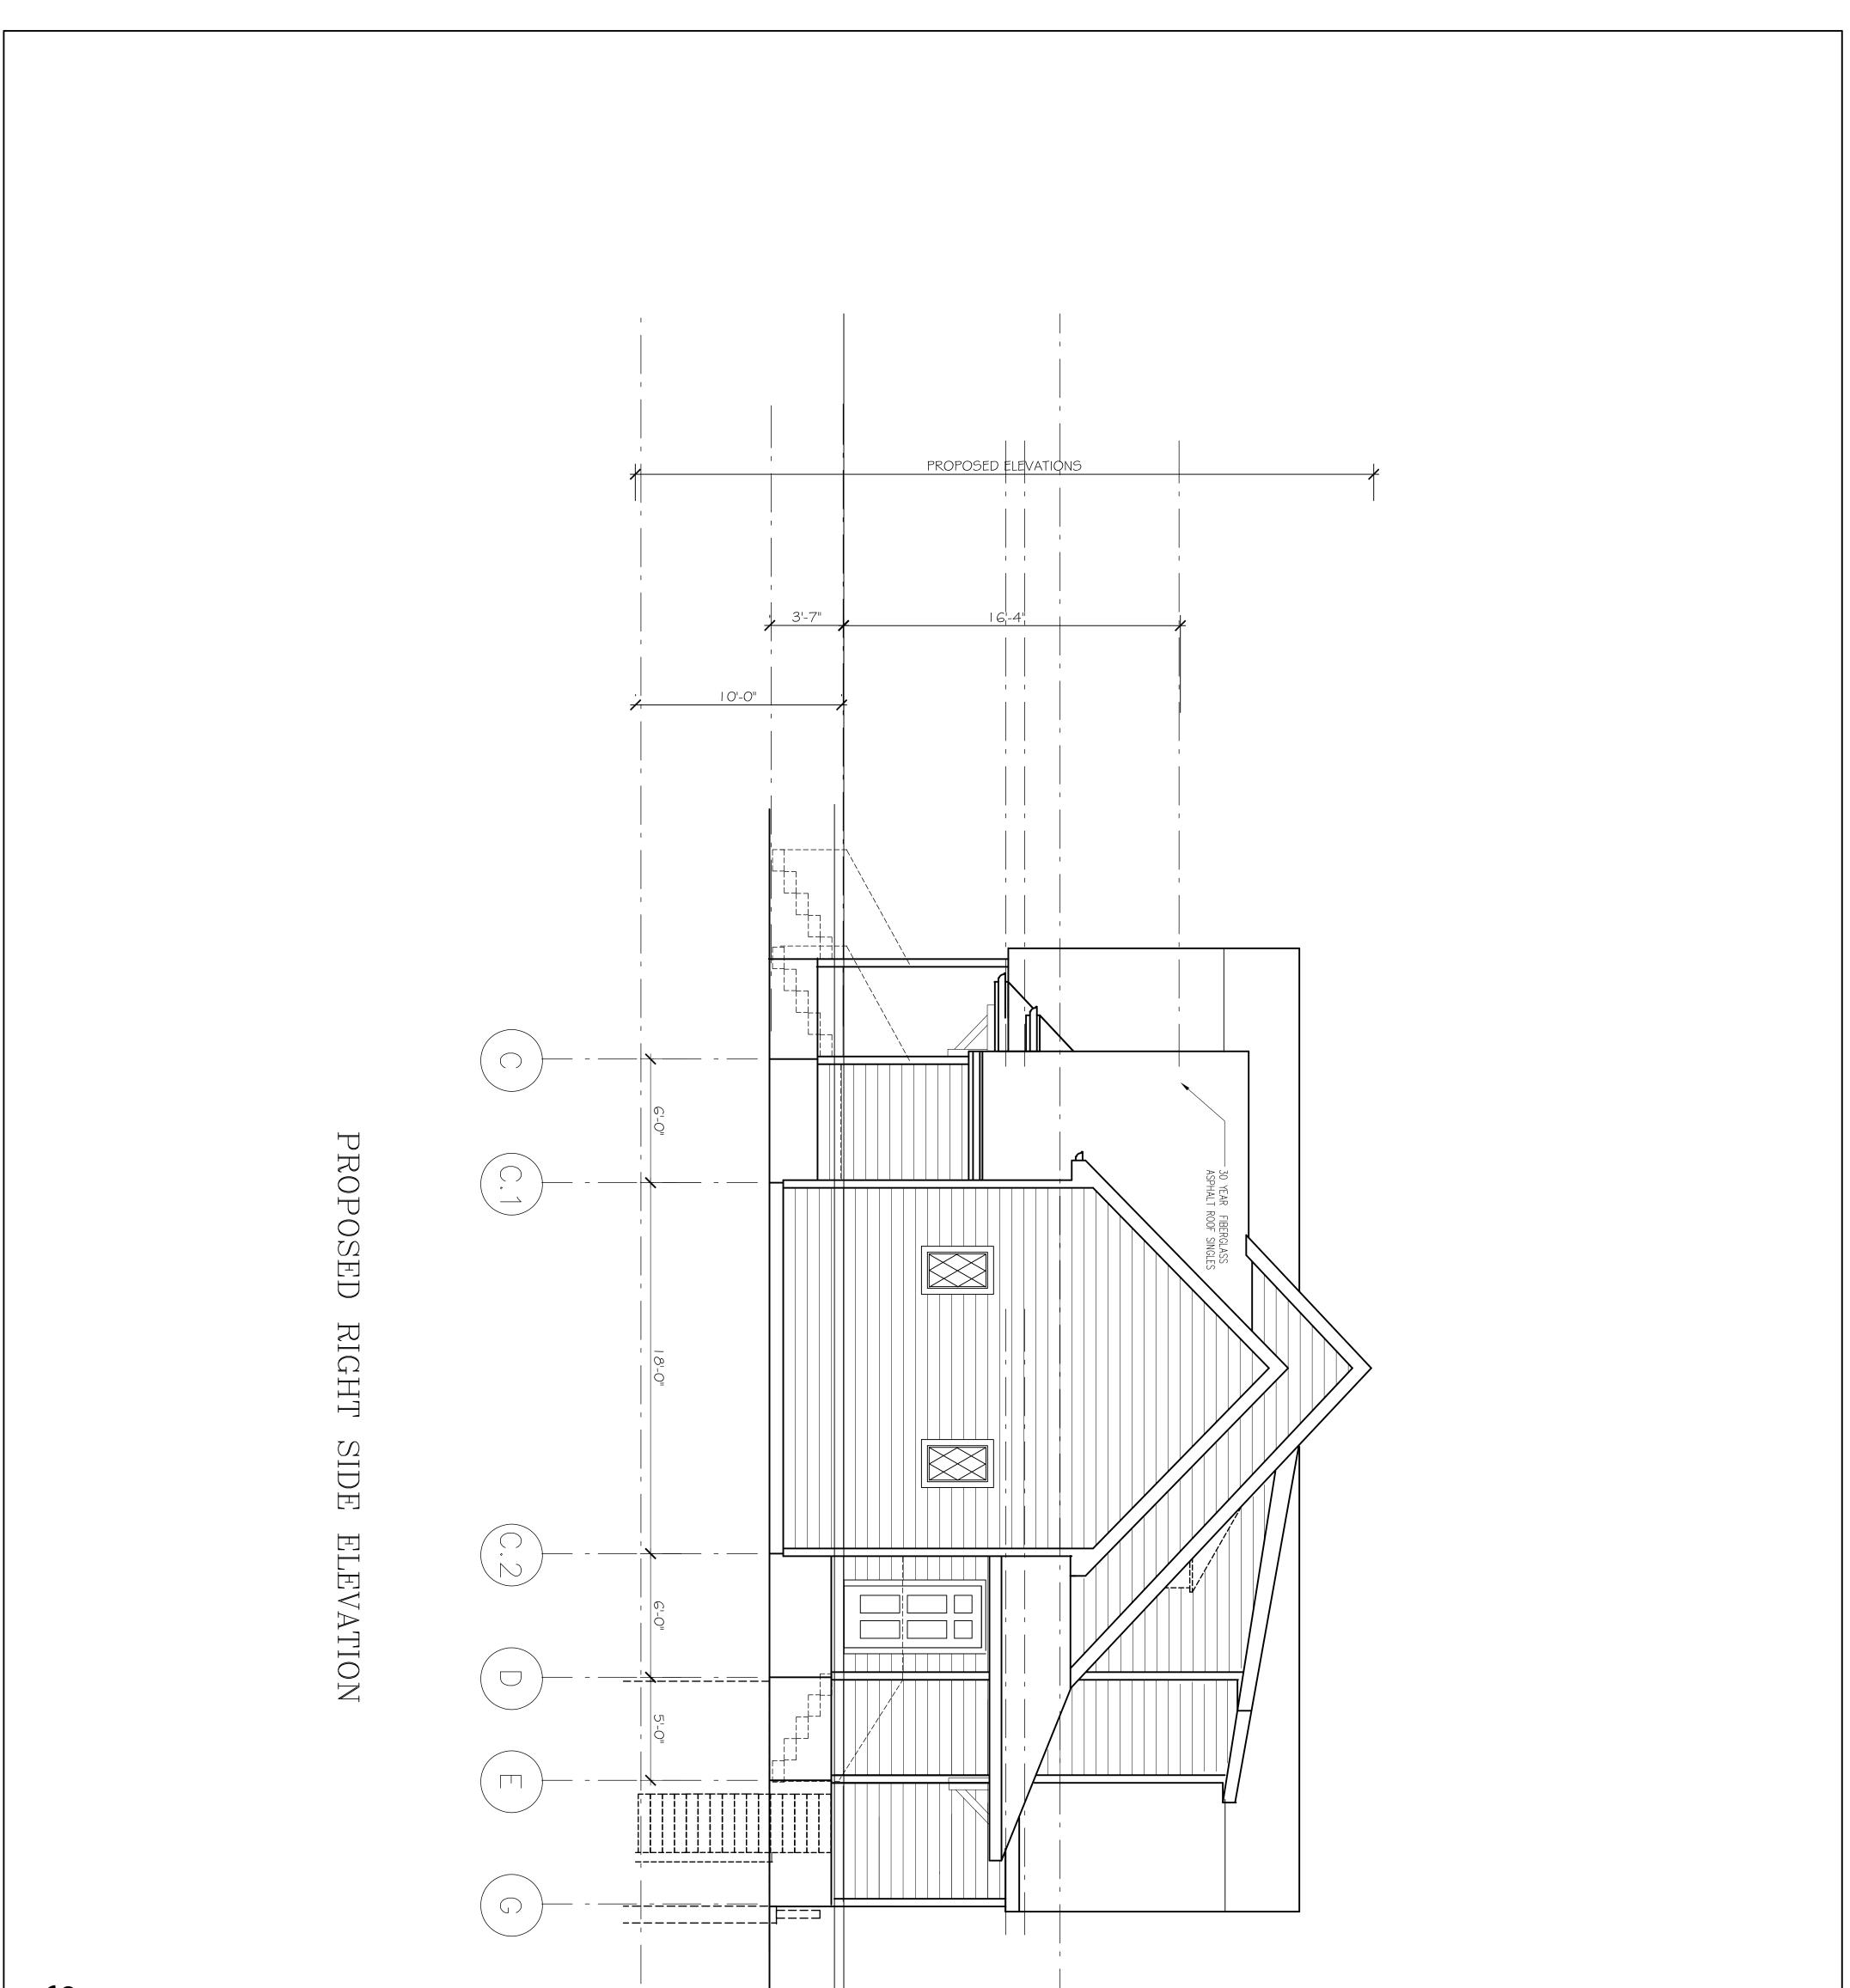
A	DATE: 4/22/2015 SCALE: AS NOTED DRAWN BY: N.G.H CHECKED BY: R.J REV : 6-6-2014	Ronald F. Jarek, Architect 487 Watertown Street	PROJECT: RENOVATION & ALTERATIONS, 15 SOUTH GATE PARK, WEST NEWTON, MA 02465	ATTIC PLAN - SPECIAL PERMIT SET	STAMP:
J		Newtonville, MA 02460	CLIENT: 15 SOUTH GATE PARK WEST NEWTON, MA 02465	15 SOUTH GATE PARK WEST NEWTON, MA 02465	TELESCON CONTRACTOR



REV: 6-6-2014	DRAWVBE: NG.H NG.H NG.H NG.H NG.H NG.H NG.H NG.H	PROJECT: RENOVATION & ALTERATIONS, 15 SOUTH GATE PARK, WEST NEWTON, MA 02465 CLIENT: 15 SOUTH GATE PARK WEST NEWTON, MA 02465	ROOF PLAN - SPECIAL PERMIT SET 15 SOUTH GATE PARK WEST NEWTON, MA 02465	STAME:
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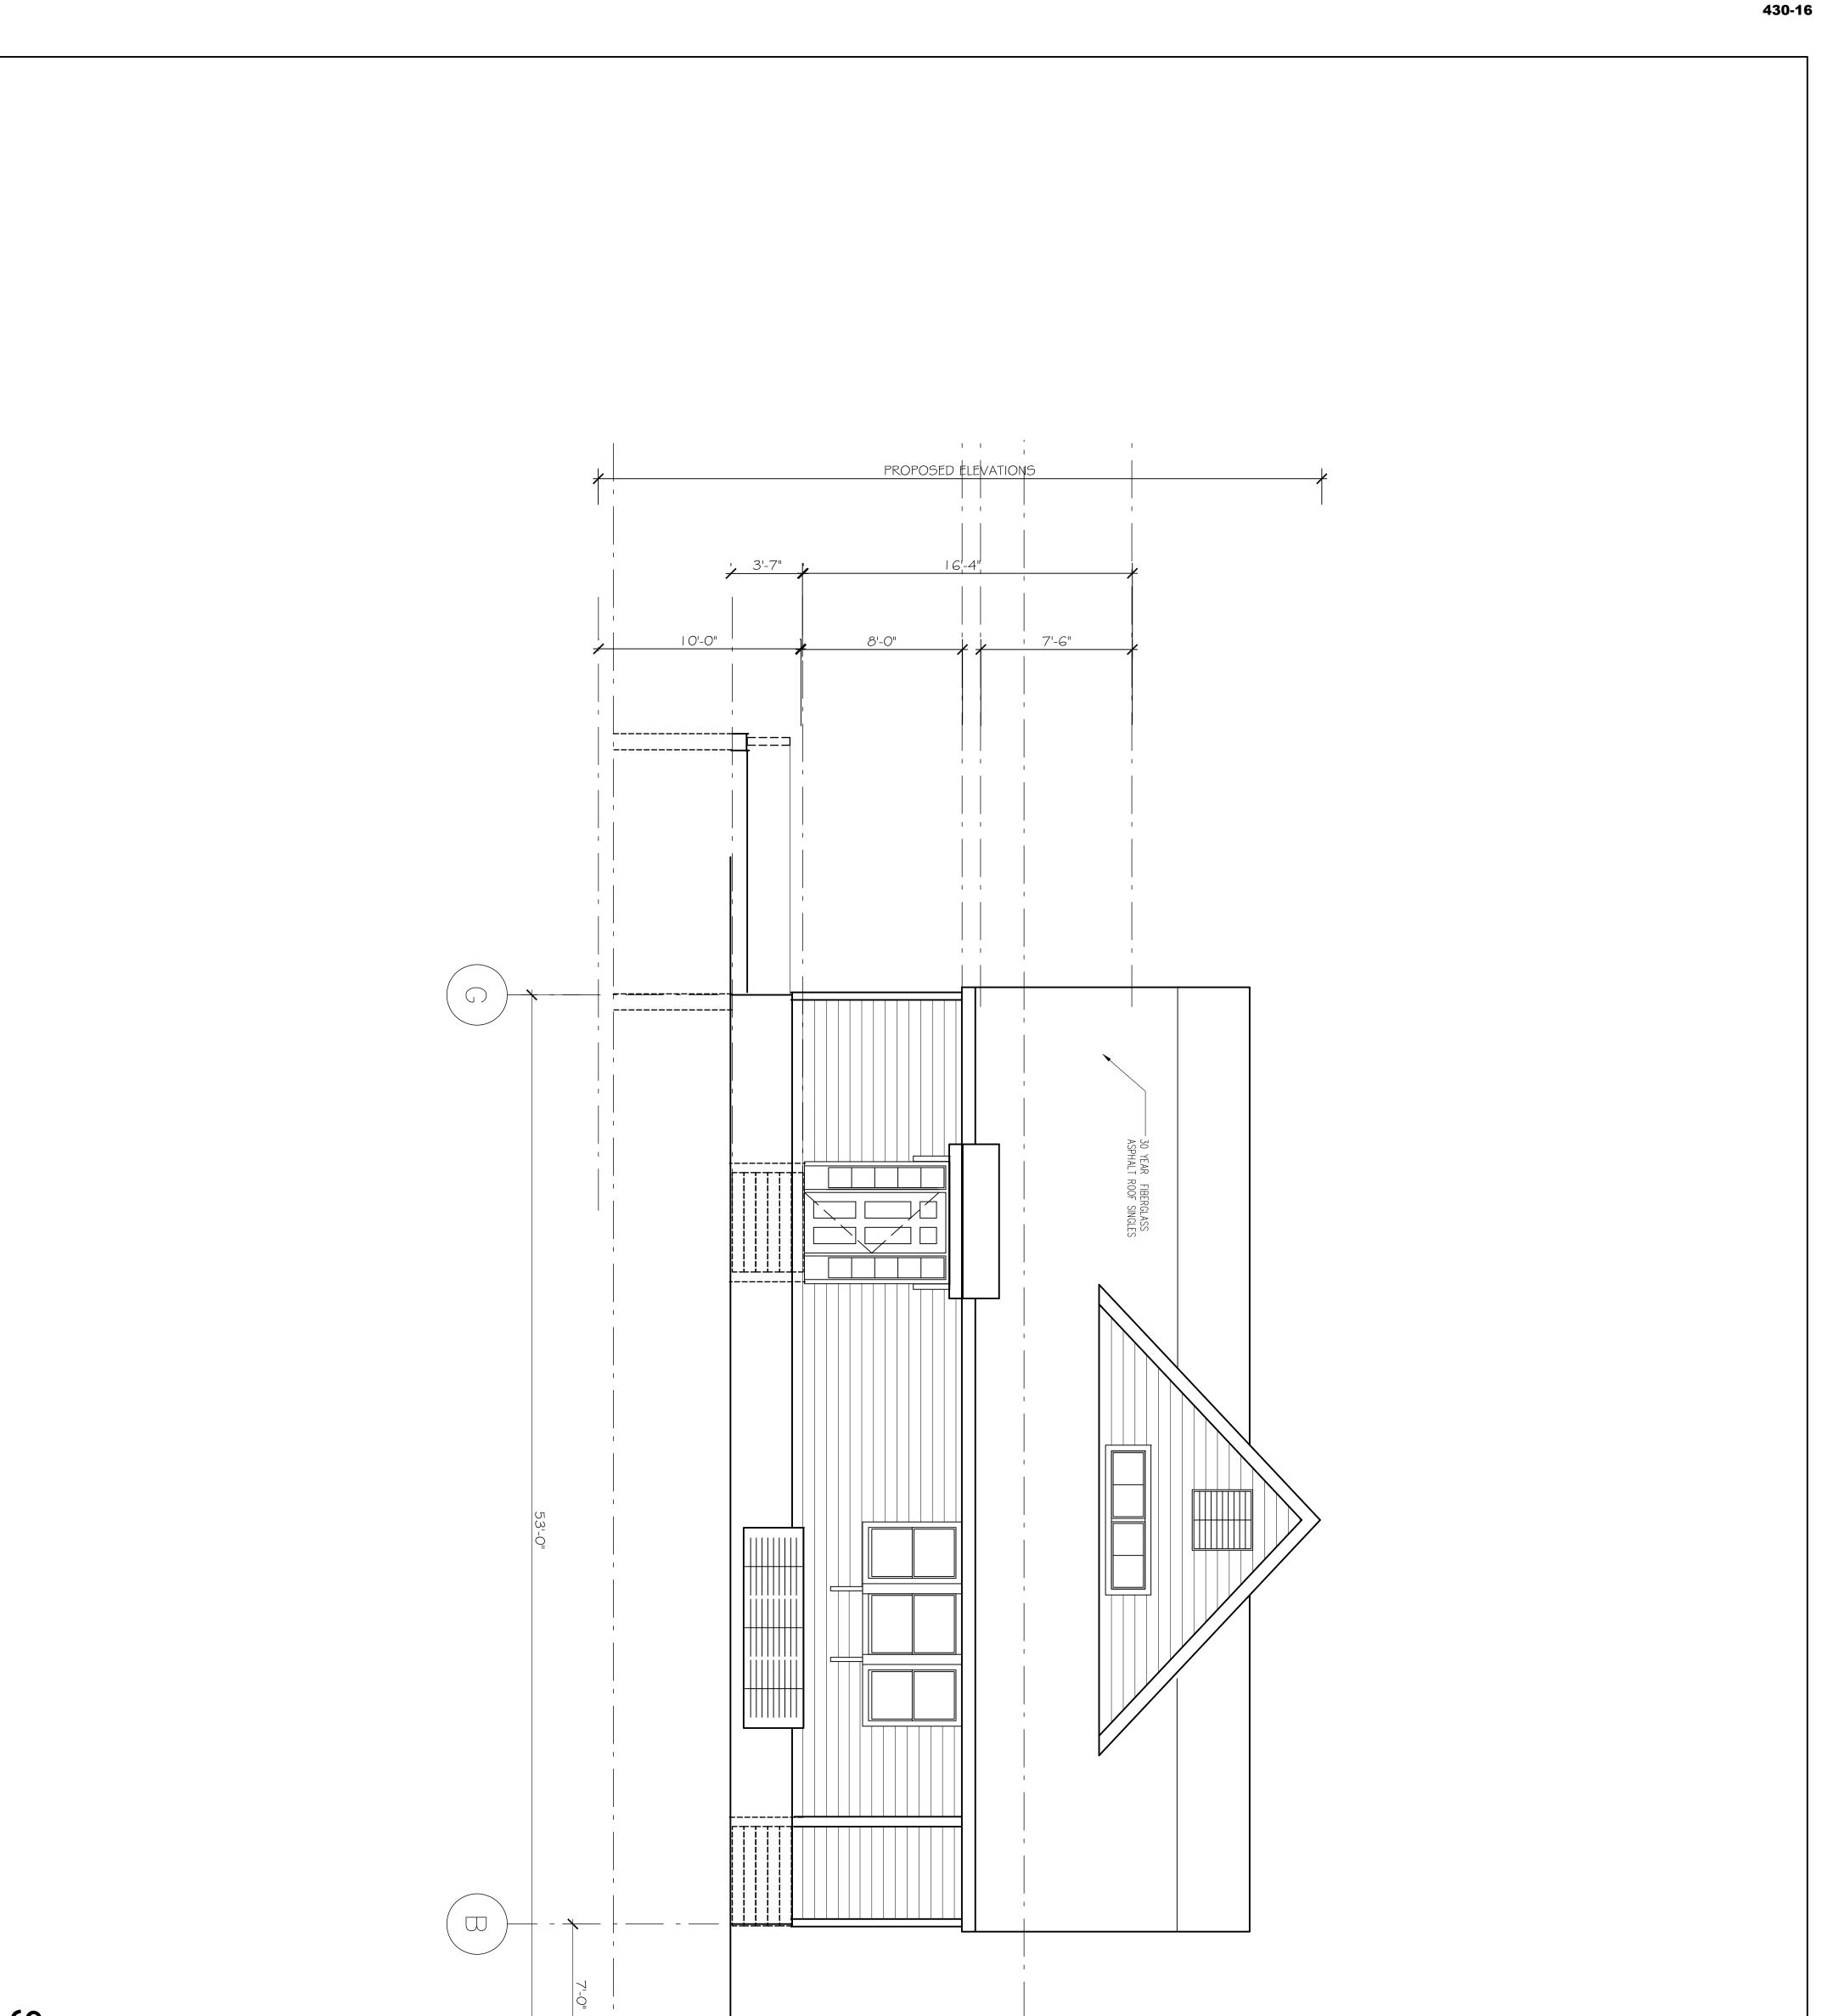


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7		Newtonville, MA 02460	CLIENT: 15 SOUTH GATE PARK WEST NEWTON, MA 02465	15 SOUTH GATE PARK WEST NEWTON, MA 02465	THE REAL PROPERTY OF THE REAL



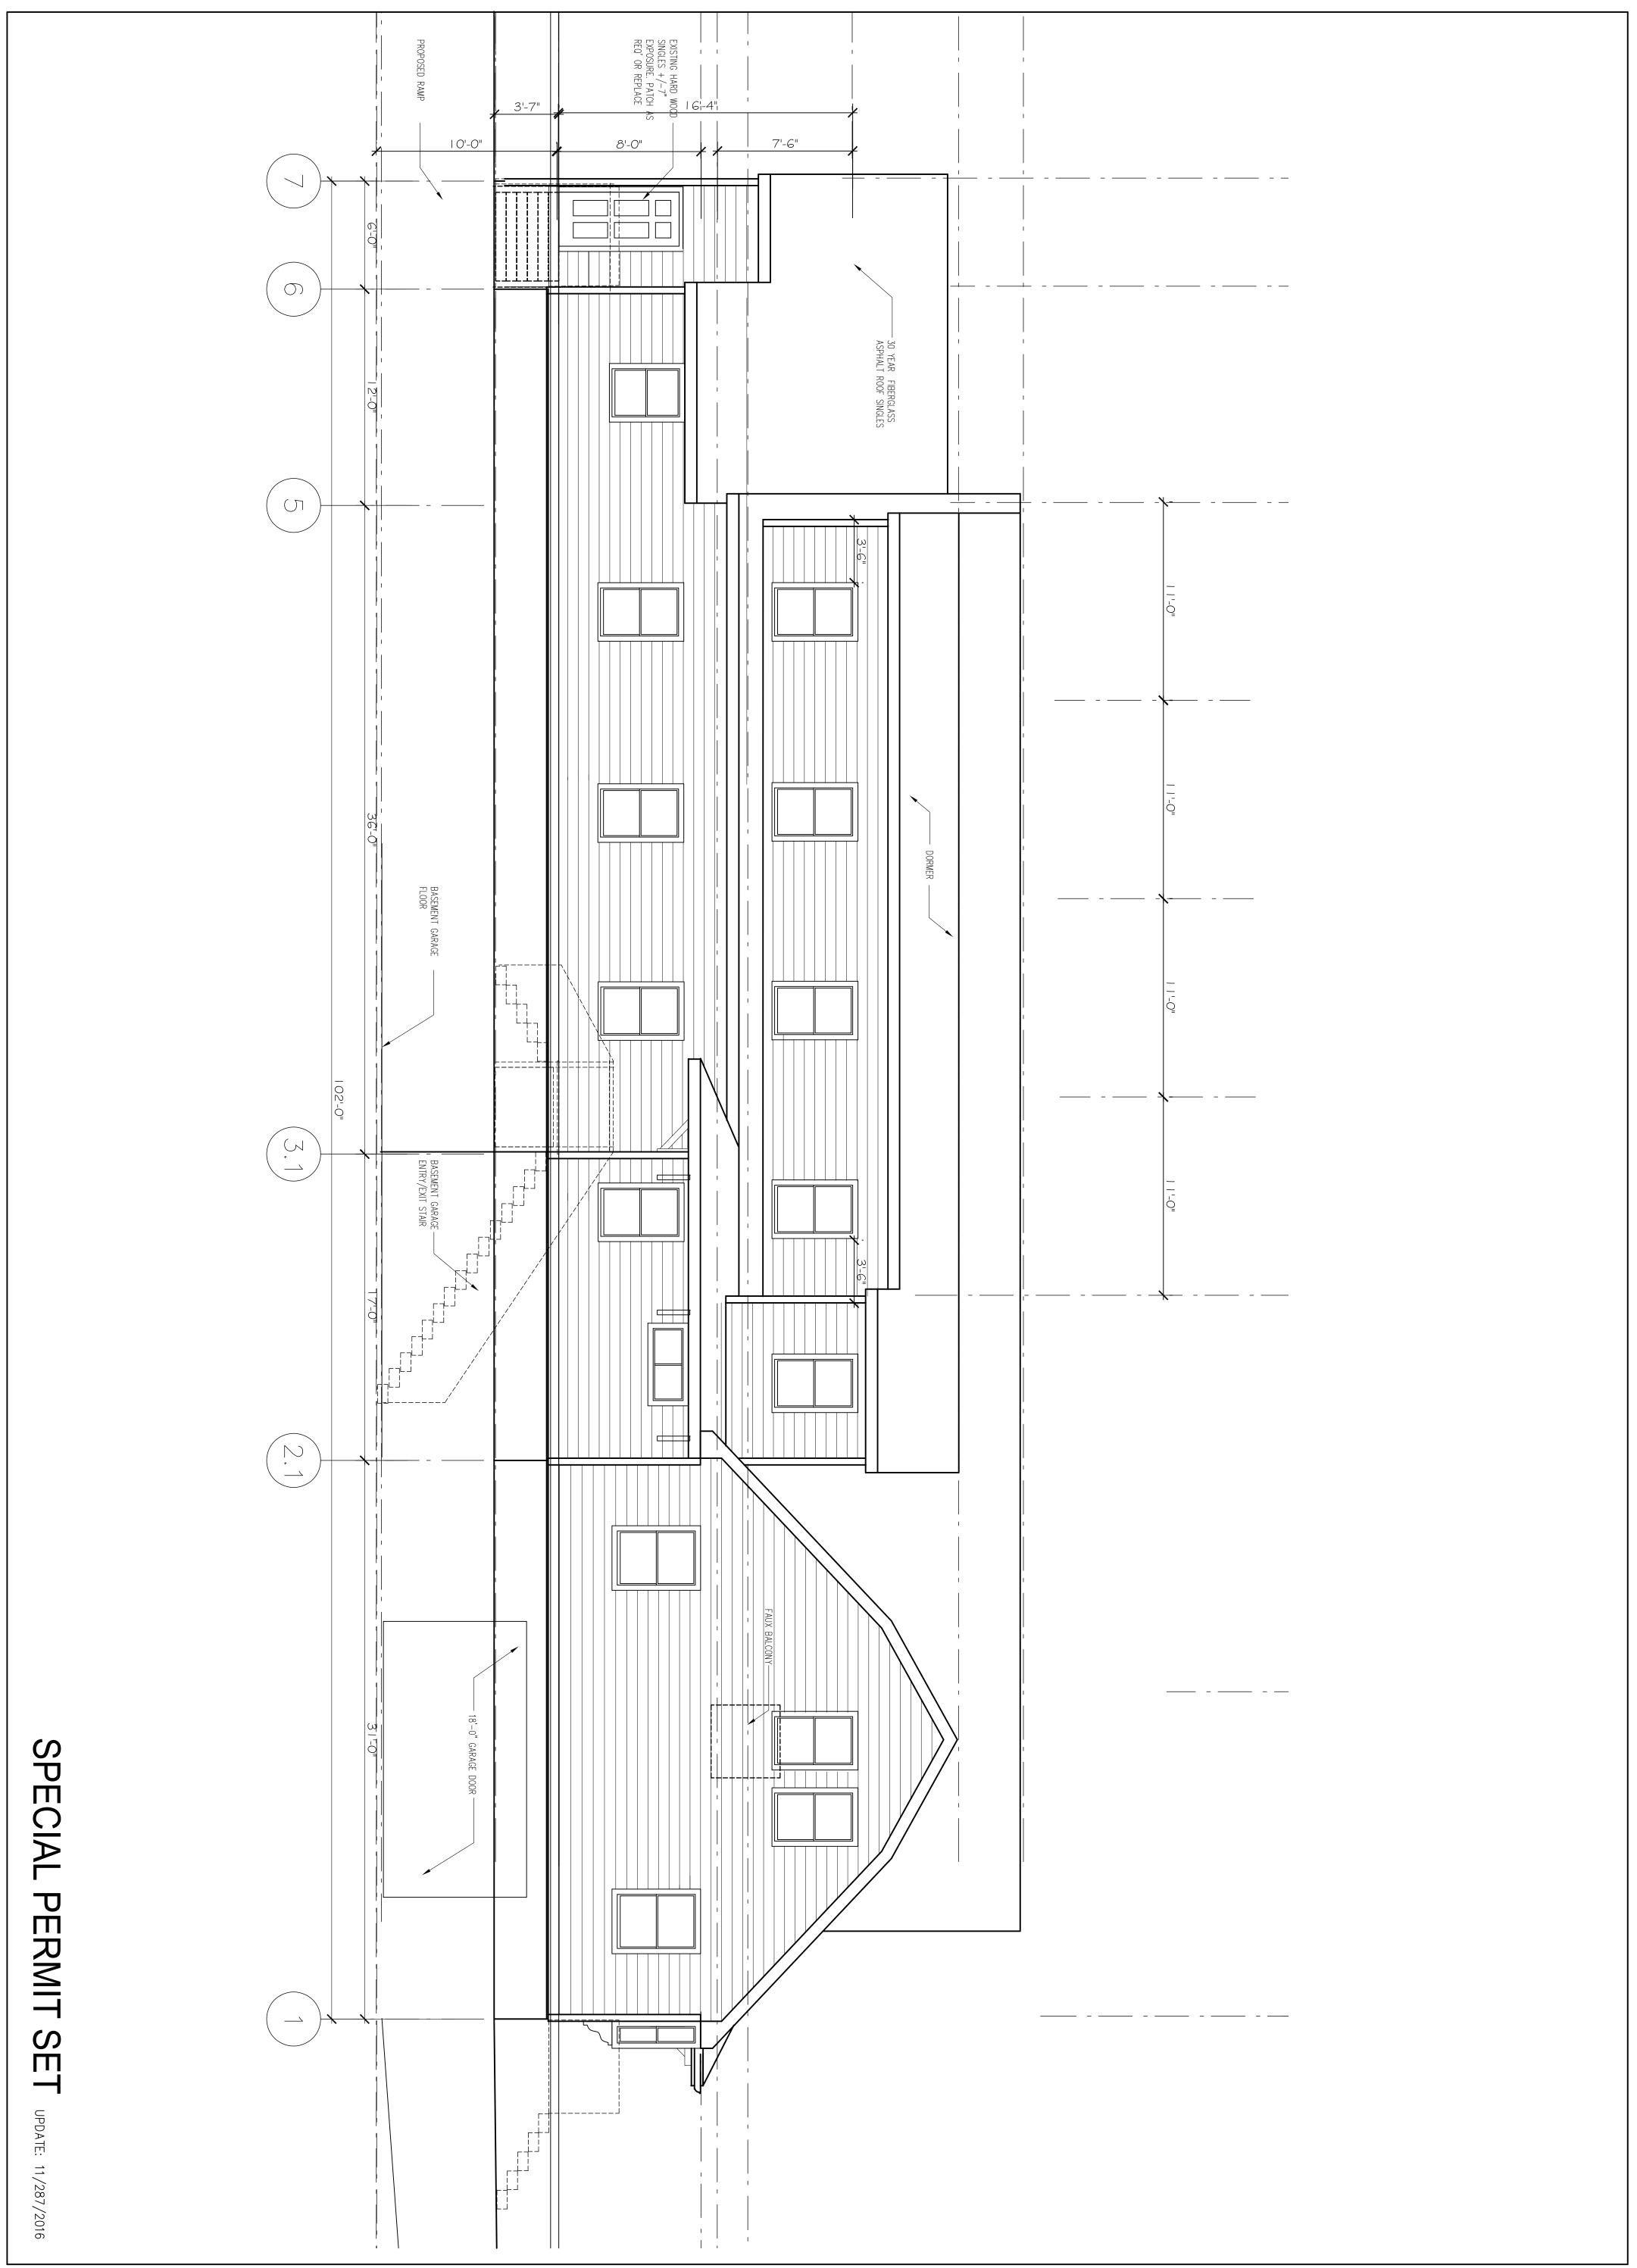
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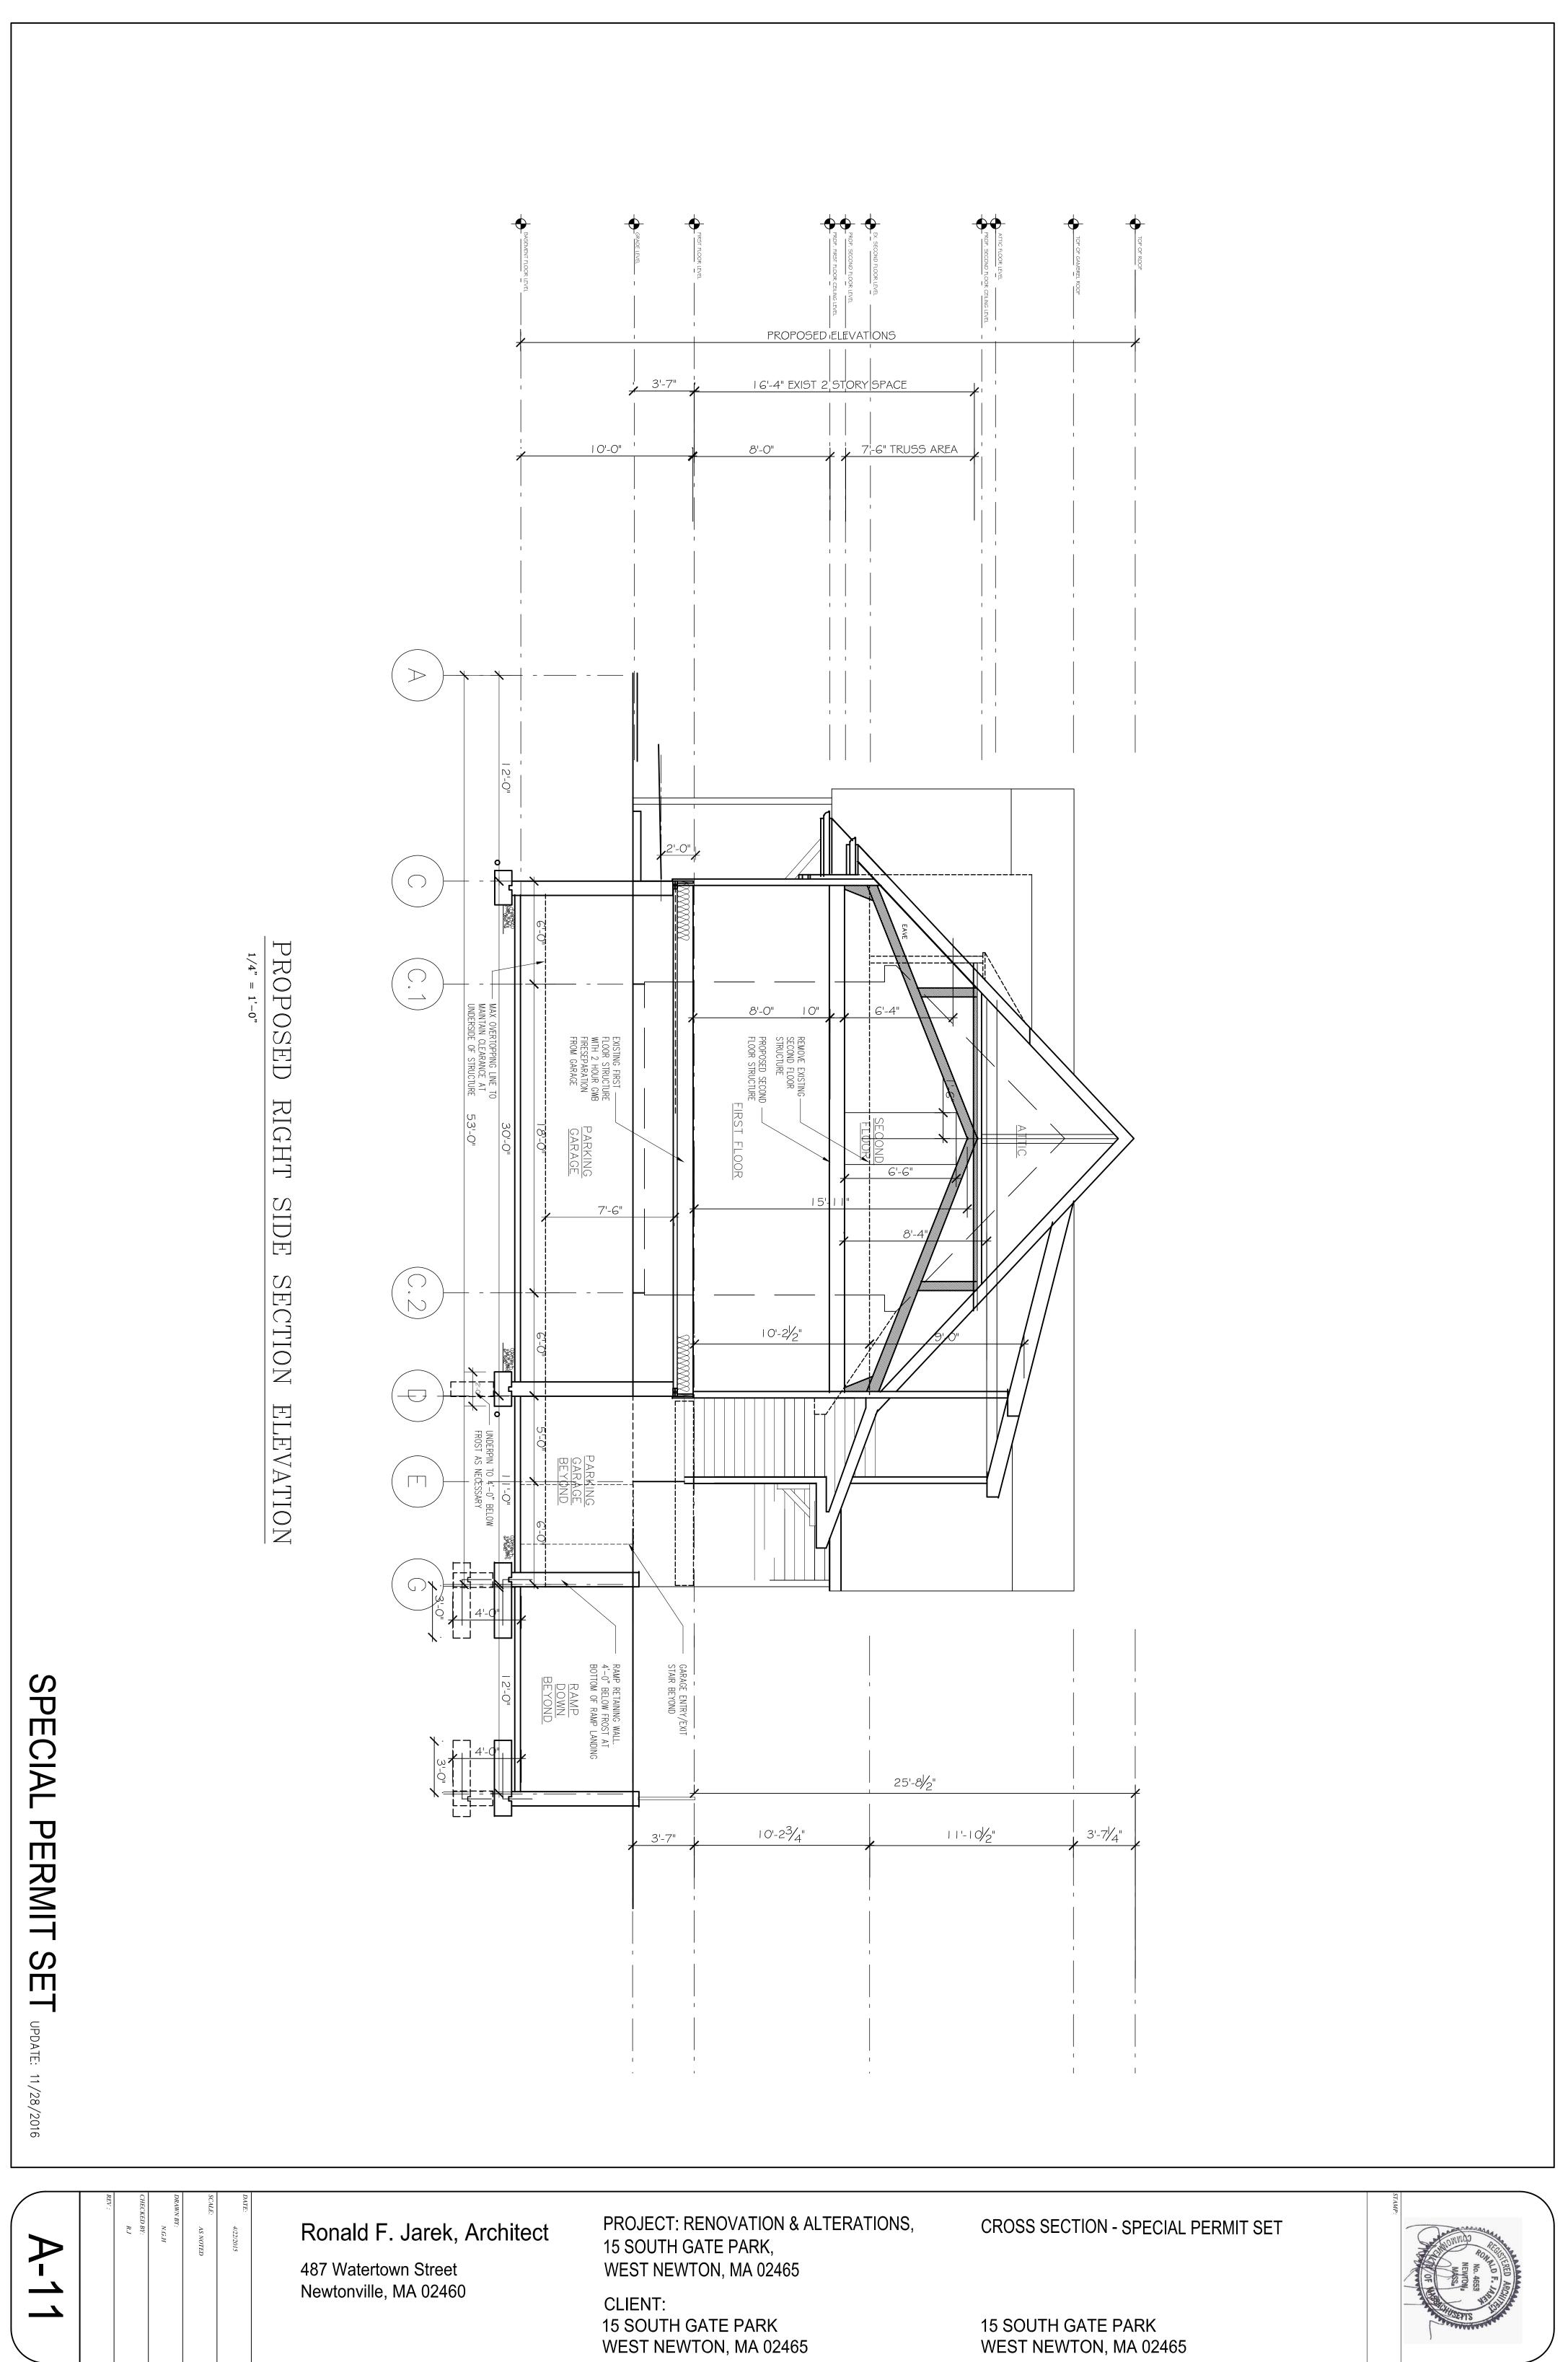


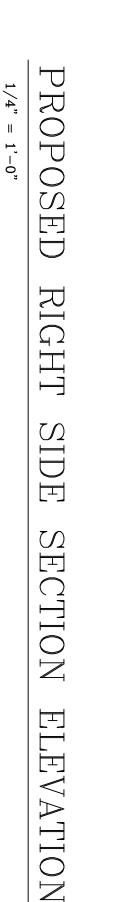
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	DRAWN BY: N.G.H CHECKED BY: R.J REV :	DATE: 4/22/2015 SCALE: AS NOTED	Ronald F. Jarek, Architect	PROJECT: RENOVATION & ALTERATIONS, 15 SOUTH GATE PARK,	LEFT ELEVATIONS - SPECIAL PERMIT SET	STARP:
0 I			487 Watertown Street Newtonville, MA 02460	WEST NEWTON, MA 02465 CLIENT: 15 SOUTH GATE PARK WEST NEWTON, MA 02465	15 SOUTH GATE PARK WEST NEWTON, MA 02465	do. 4653

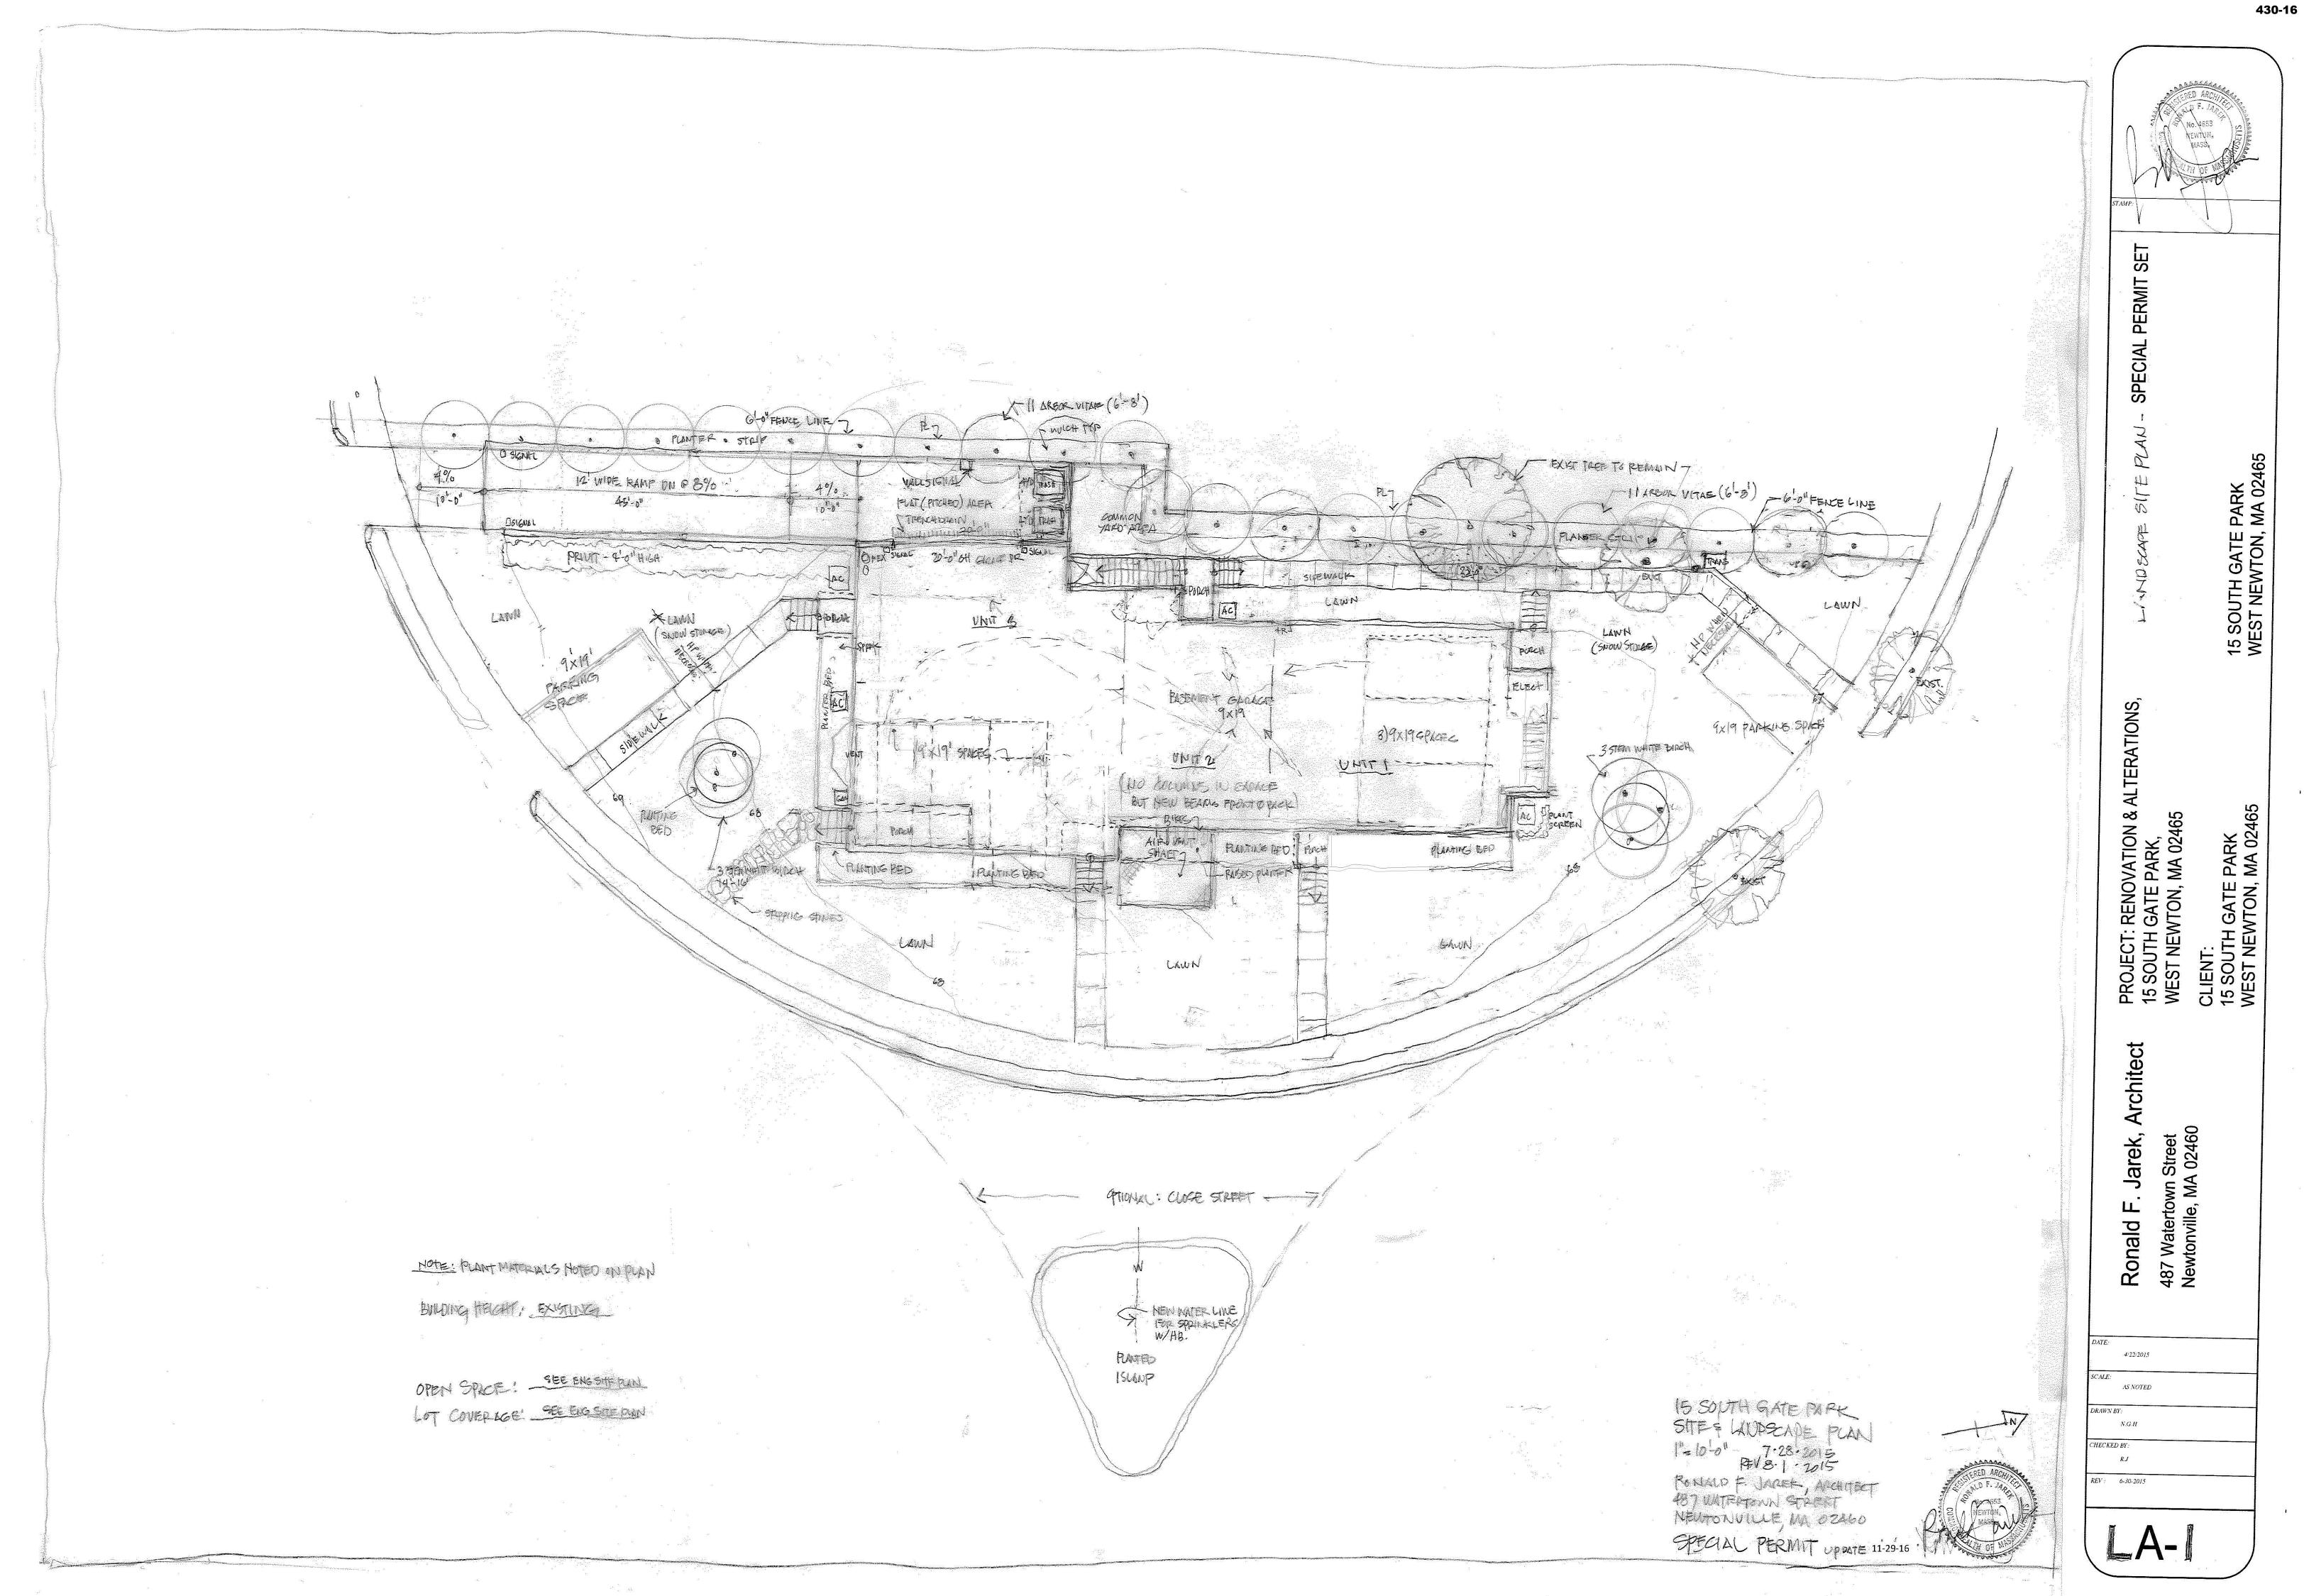


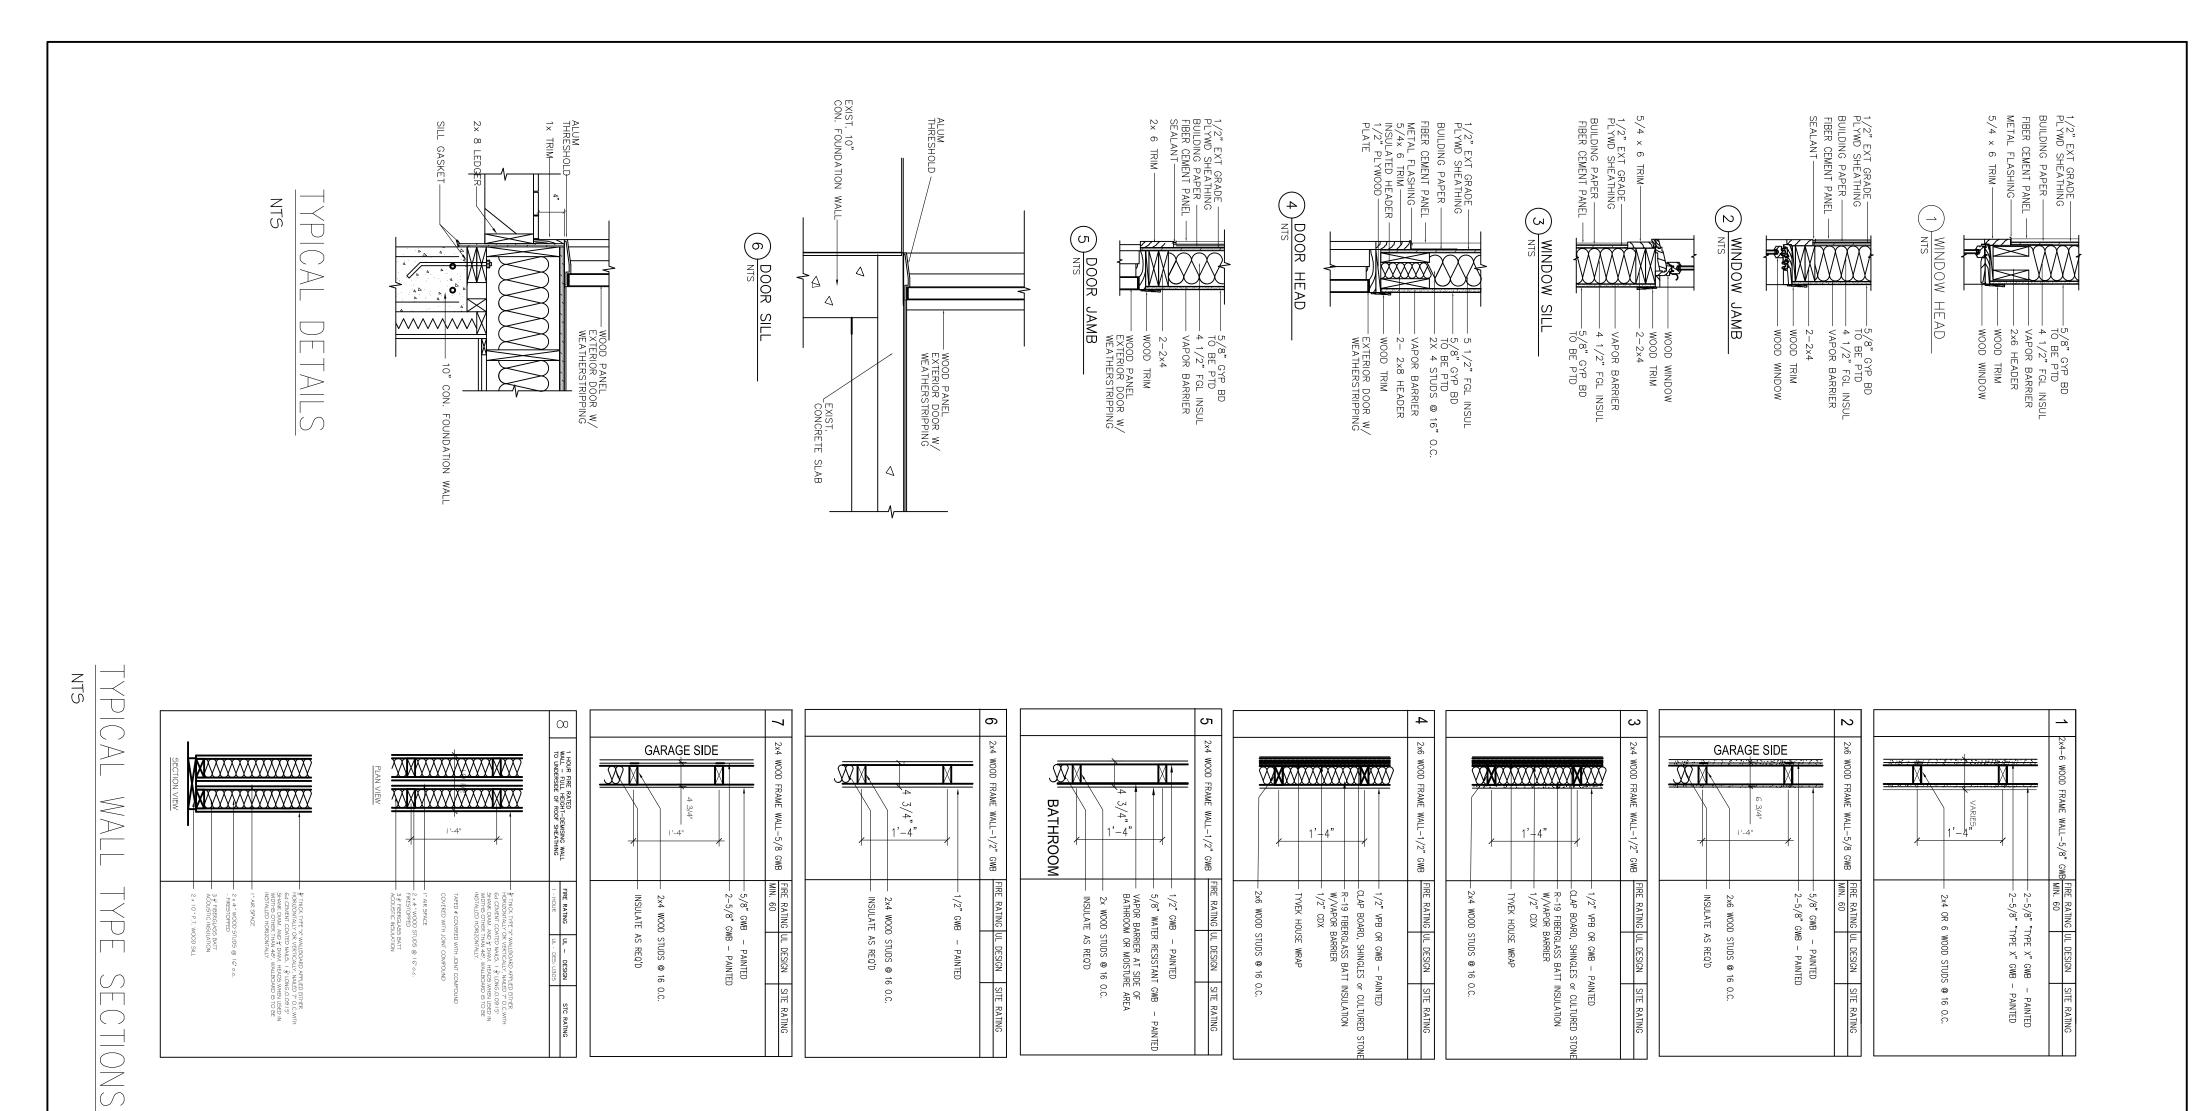
A-10	DATE: 4/22/2015 SCALE: AS NOTED DRAWN BY: N.G.H CHECKED BY: R.J REV :	Ronald F. Jarek, Architect 487 Watertown Street Newtonville, MA 02460	PROJECT: RENOVATION & ALTERATIONS, 15 SOUTH GATE PARK, WEST NEWTON, MA 02465 CLIENT: 15 SOUTH GATE PARK WEST NEWTON, MA 02465	REAR ELEVATION - SPECIAL PERMIT SET 15 SOUTH GATE PARK WEST NEWTON, MA 02465	STAMP:
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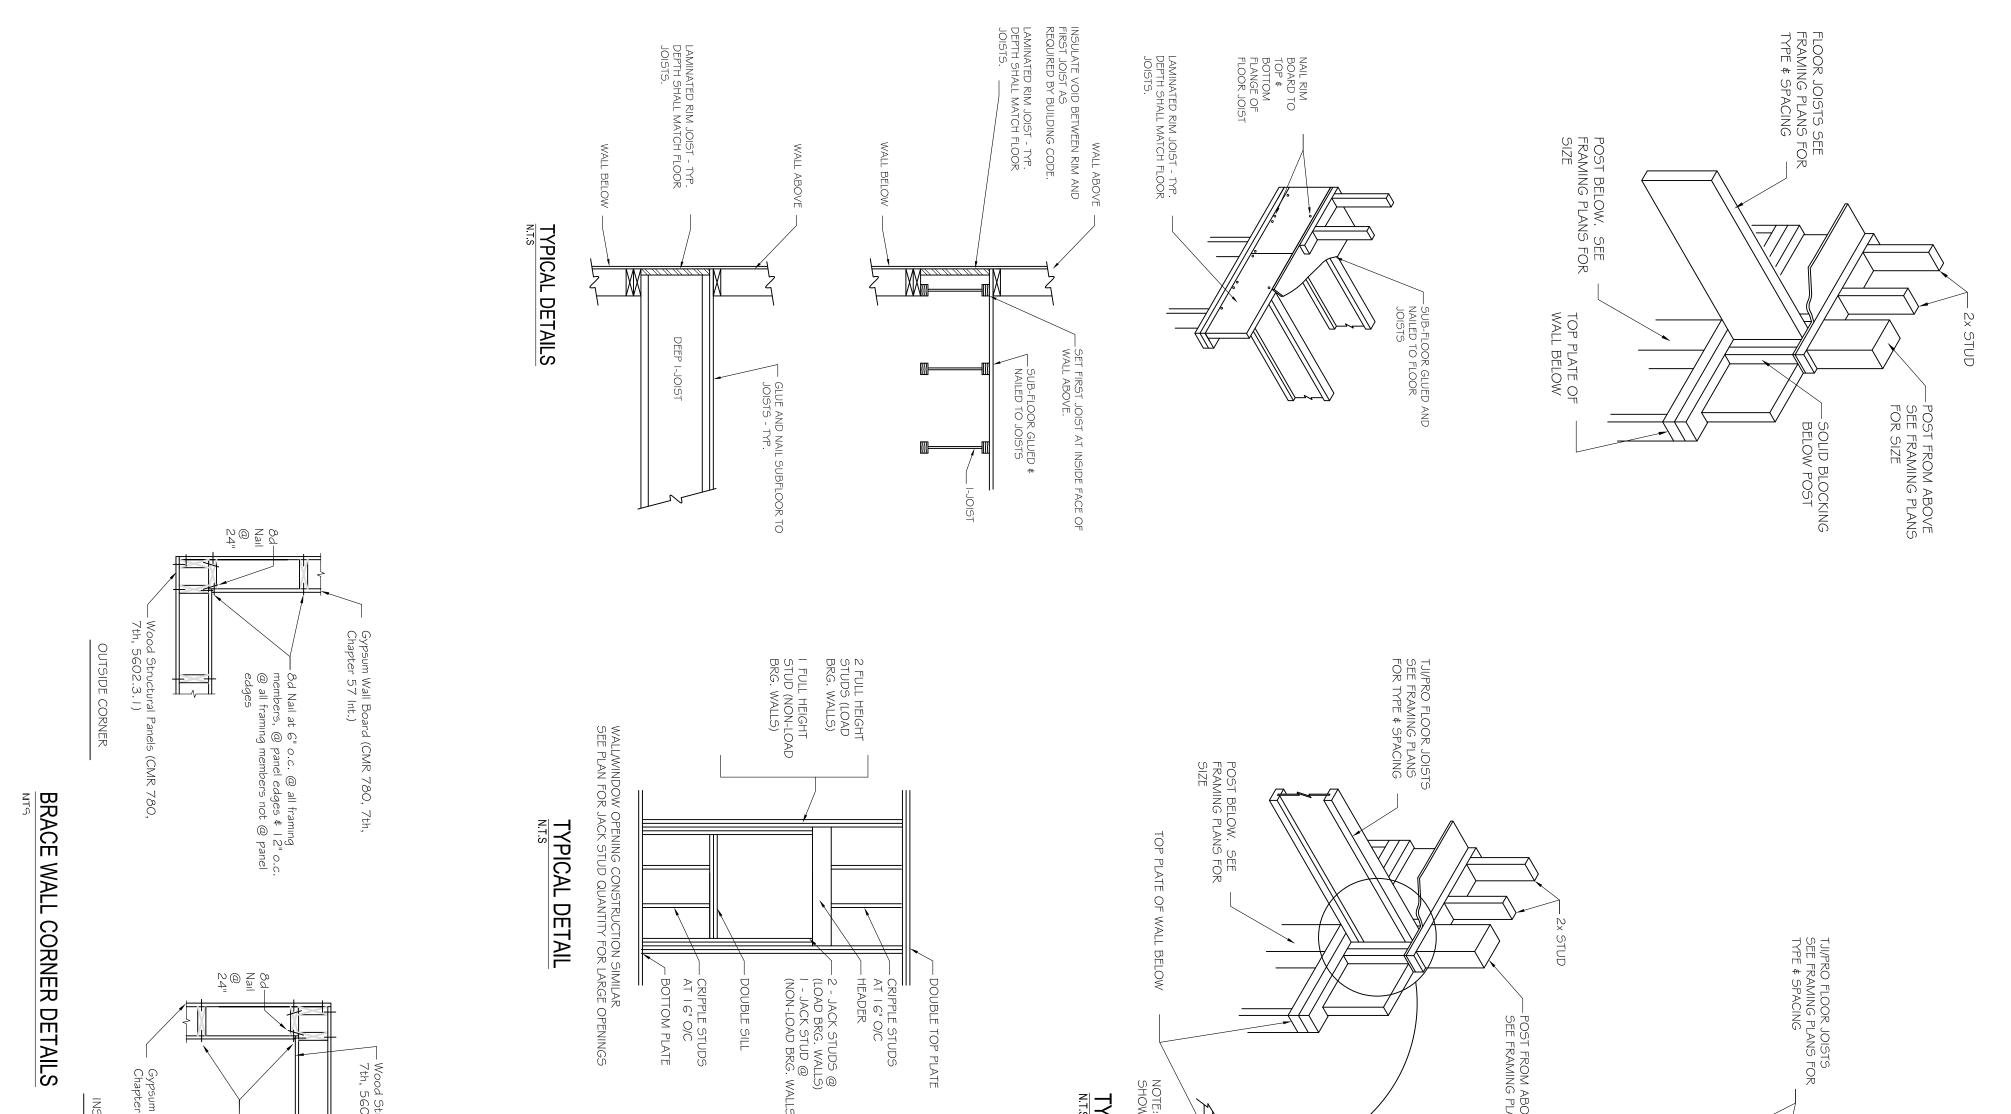


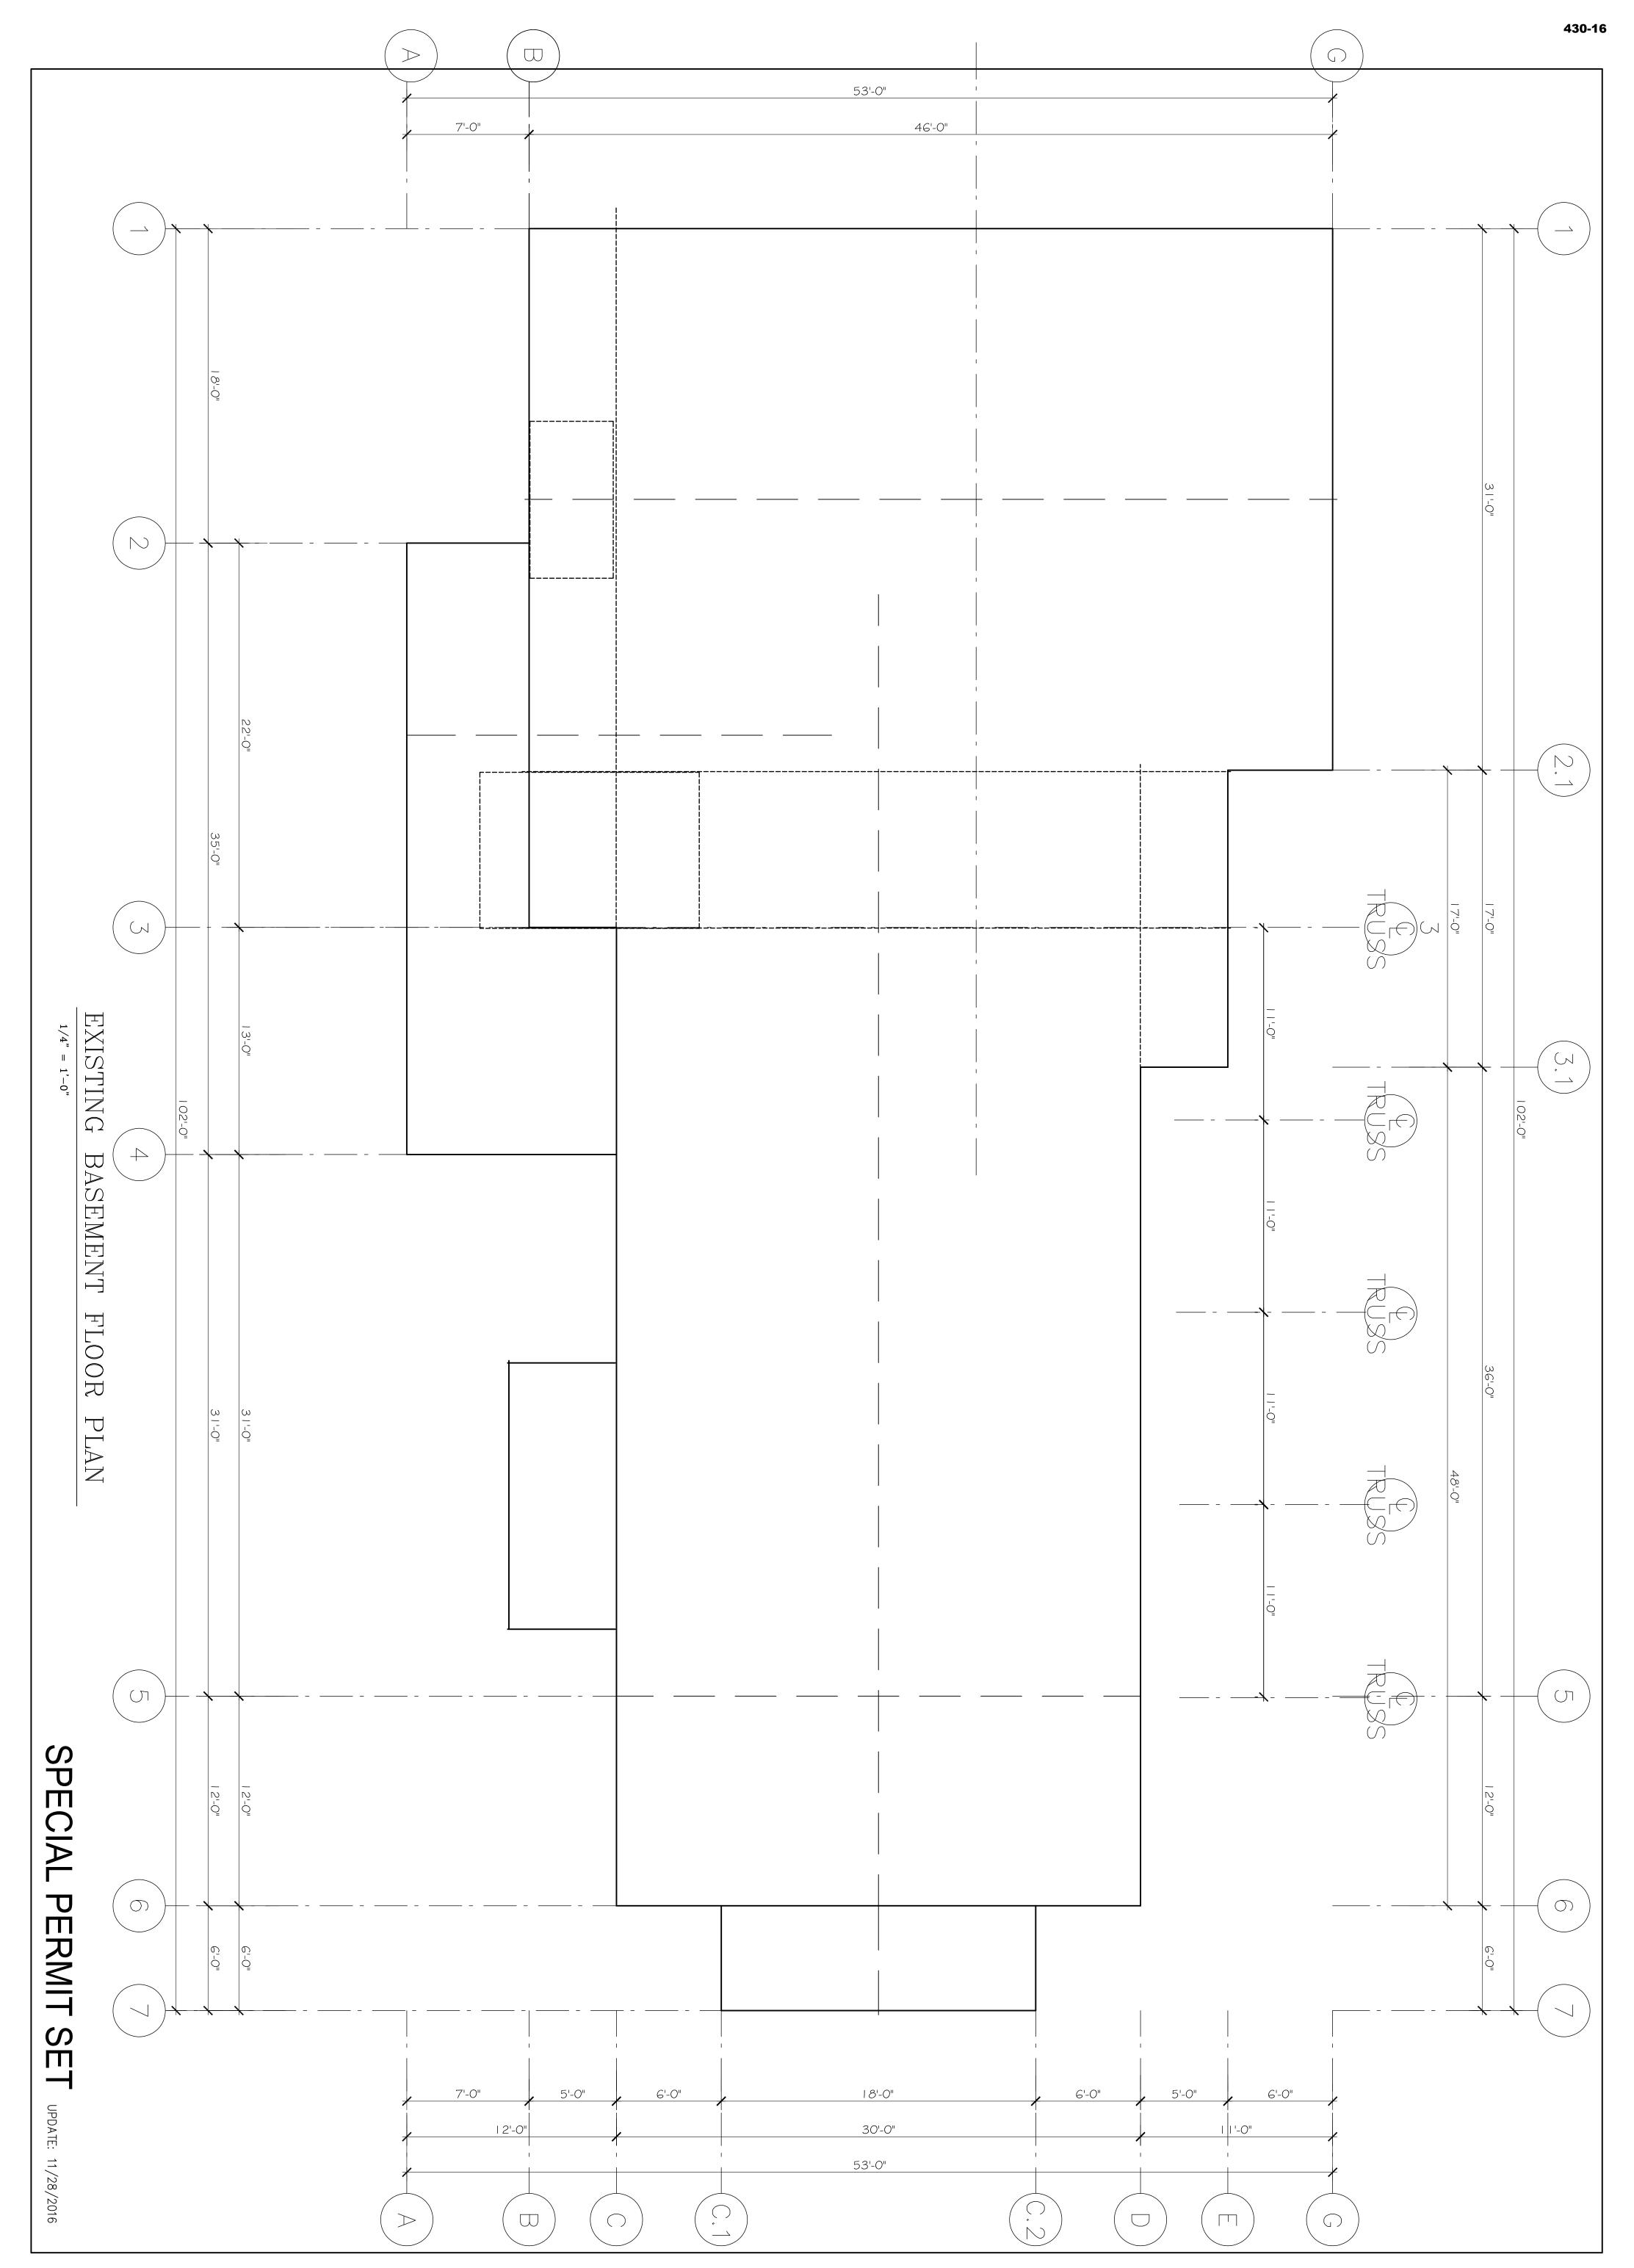


487 Watertown Street
Newtonville, MA 02460

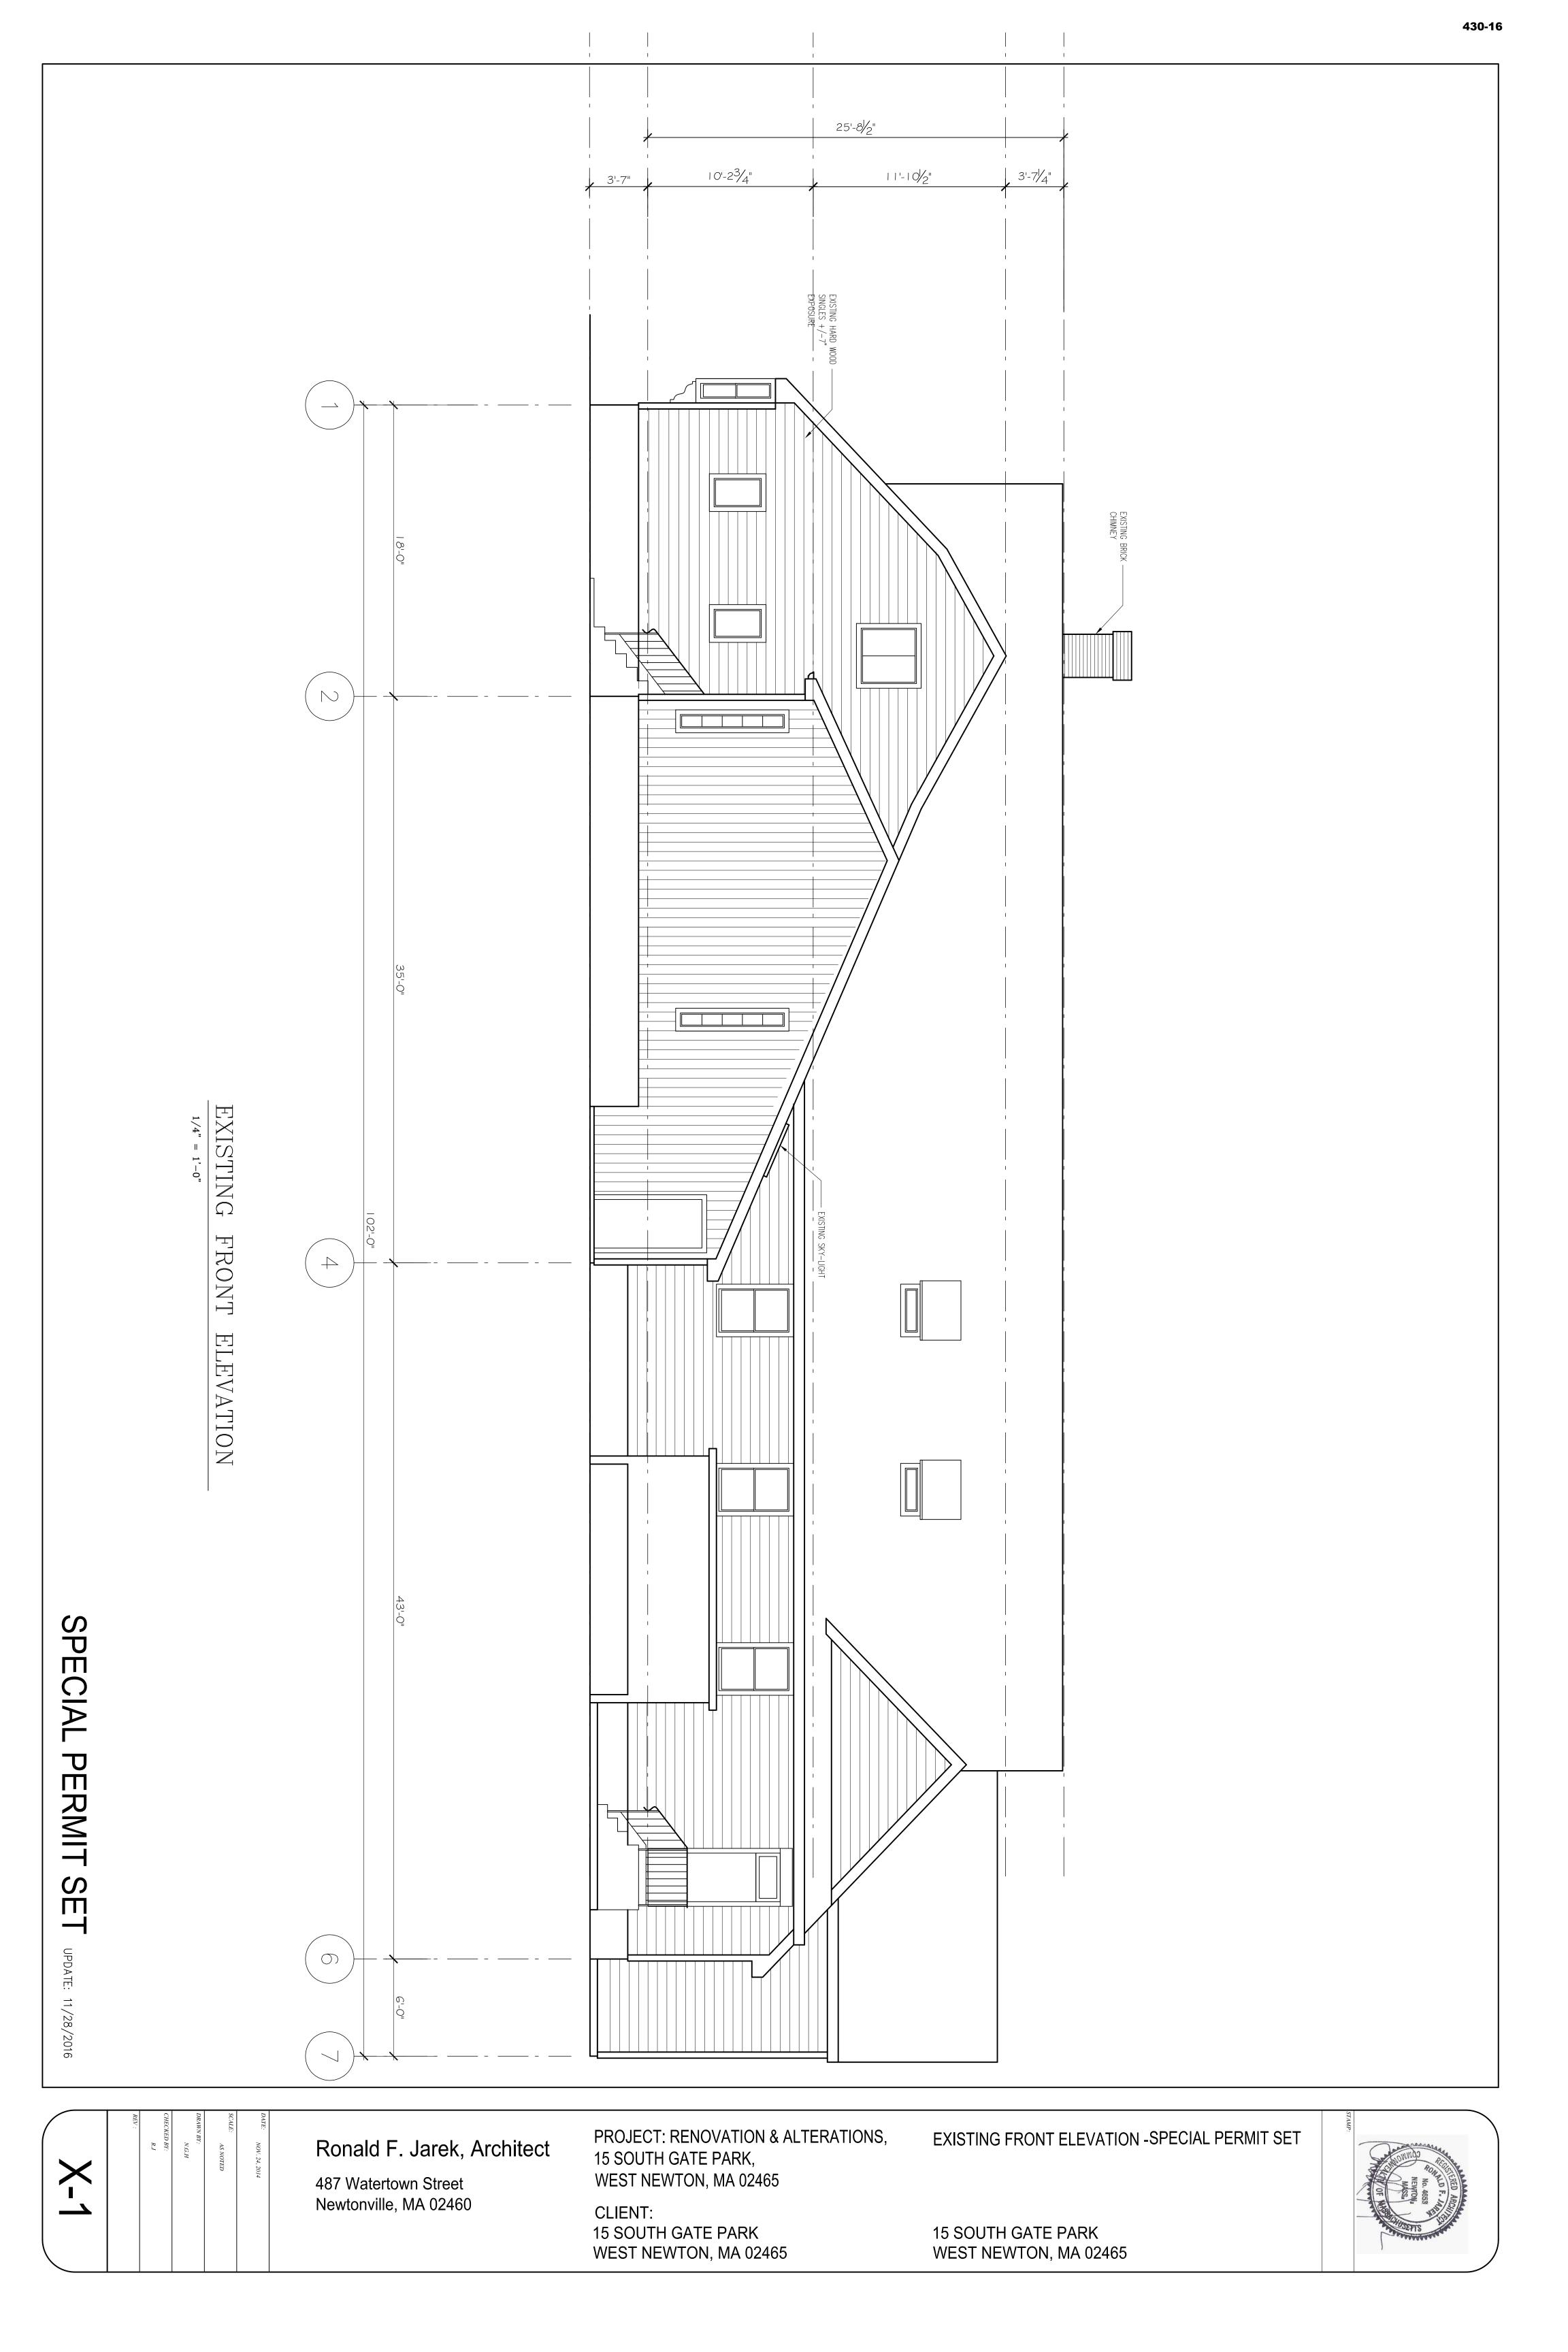


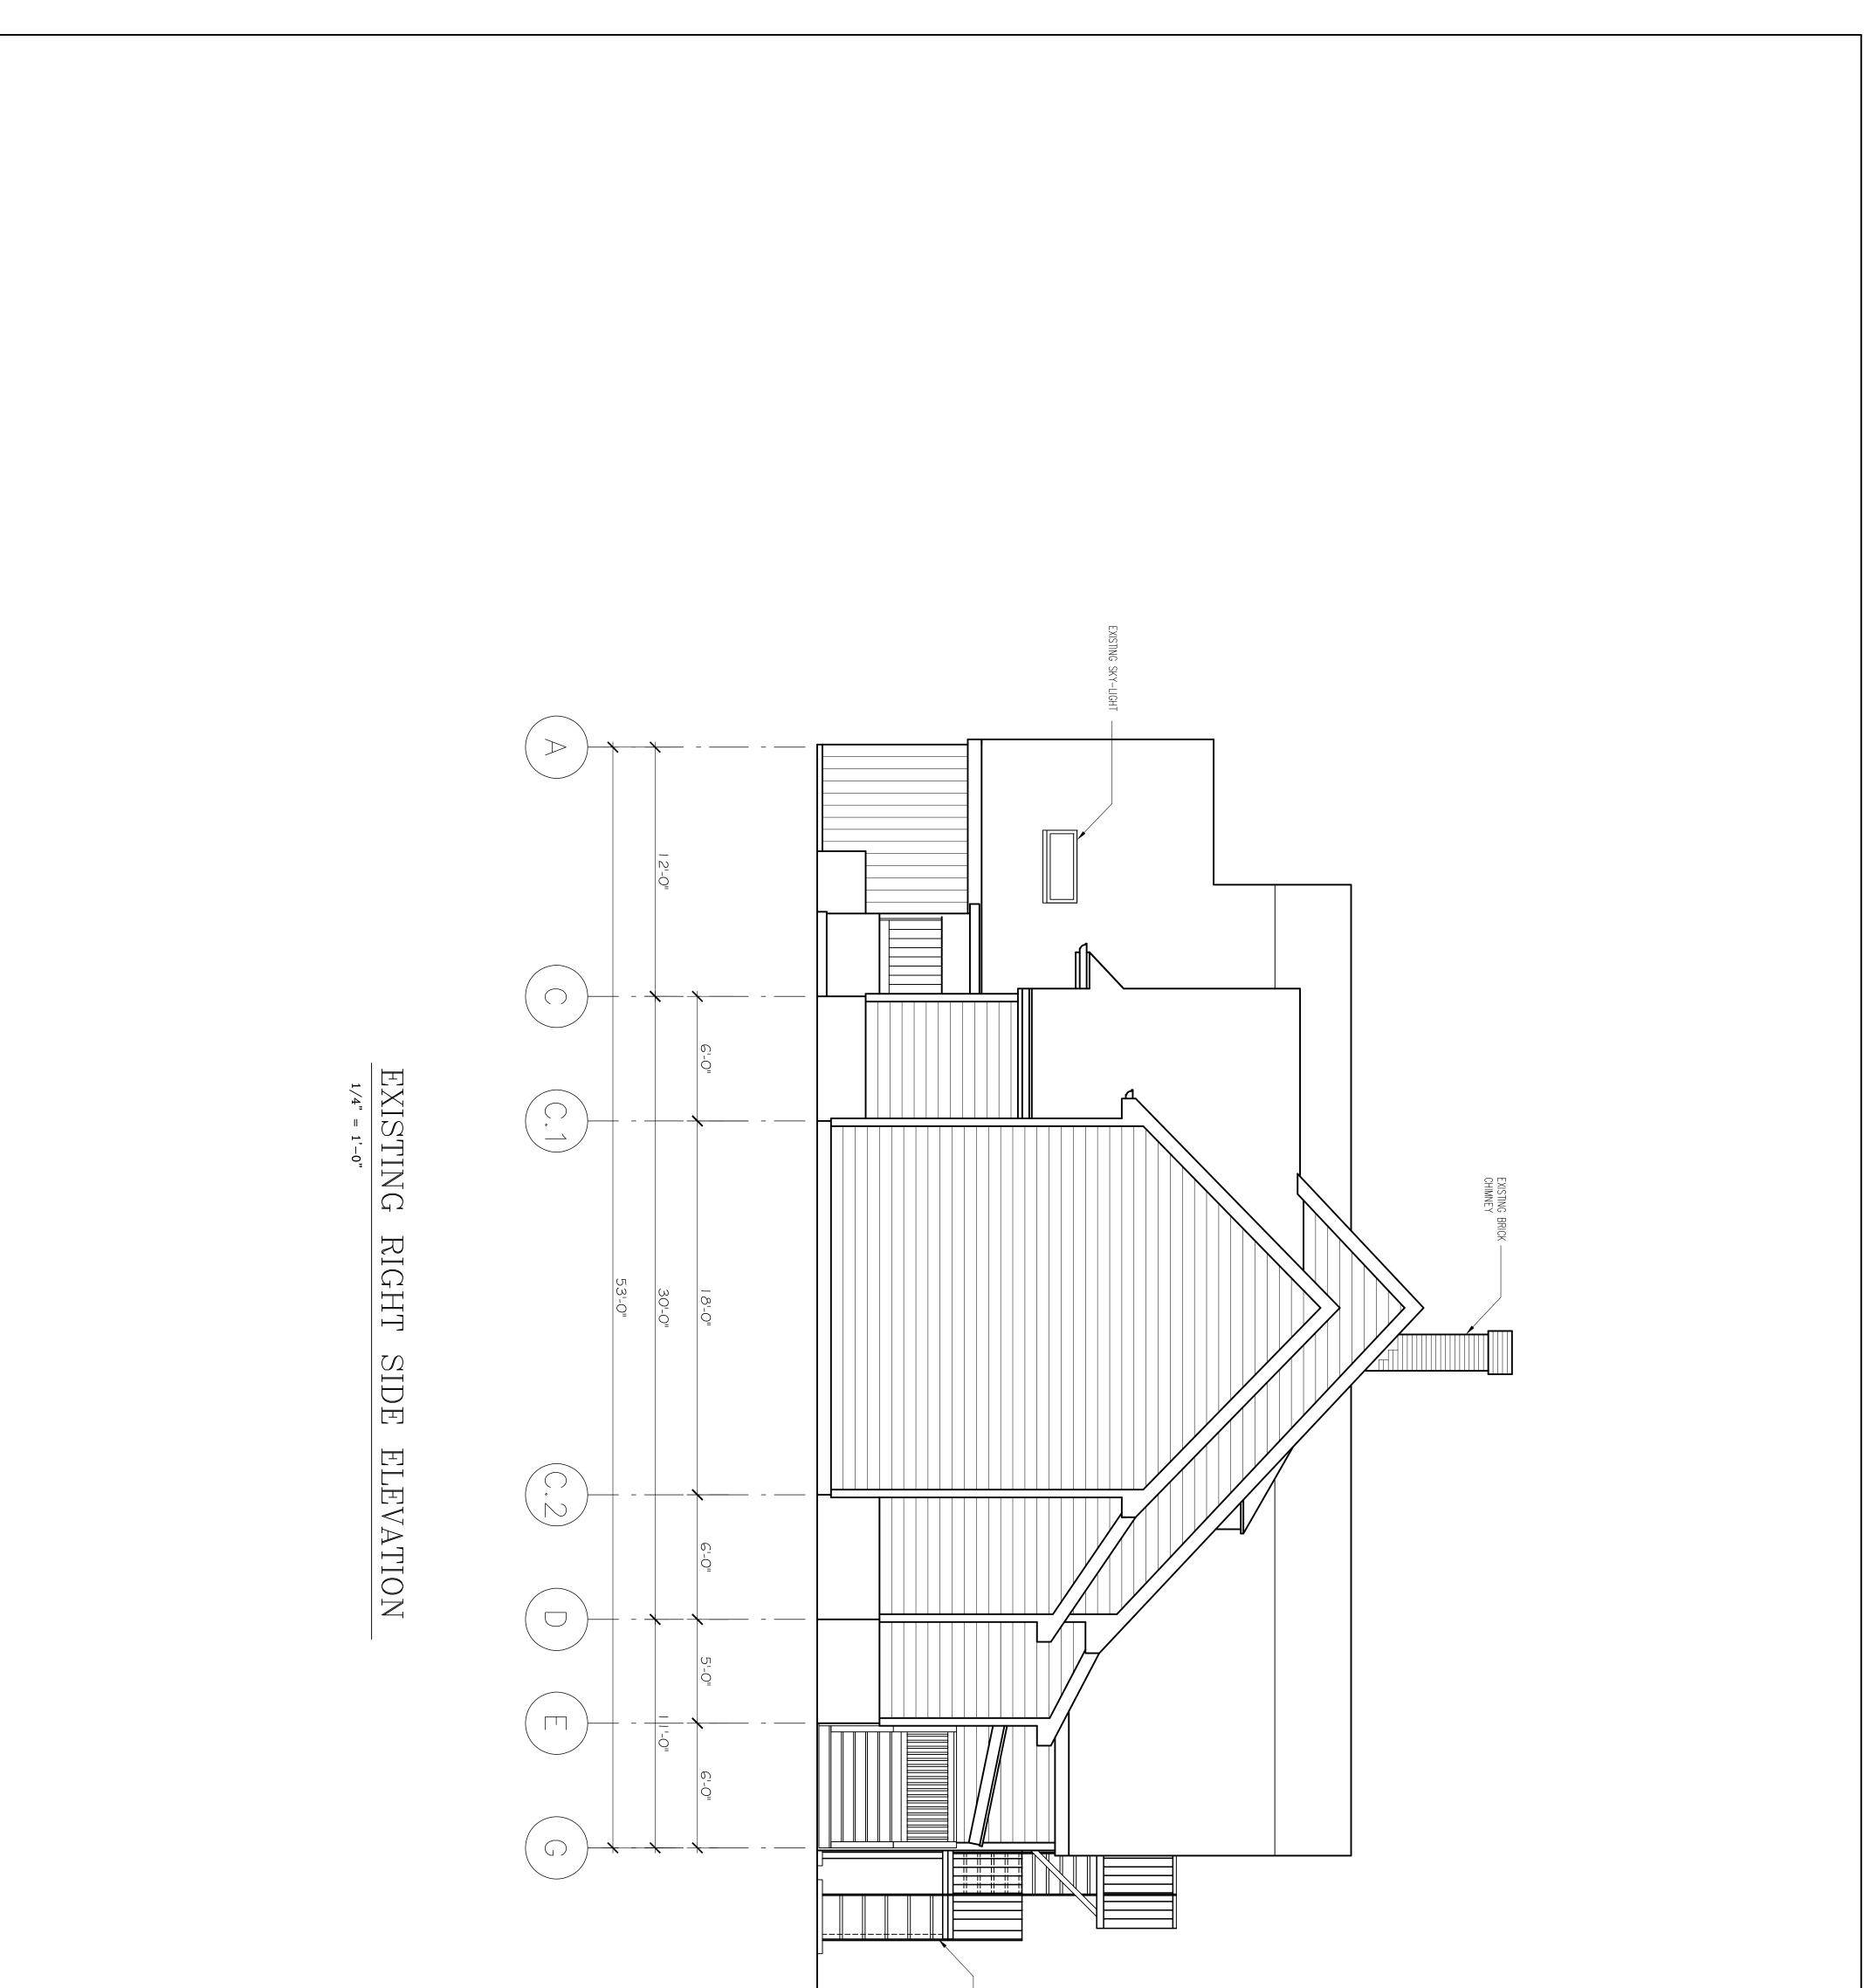




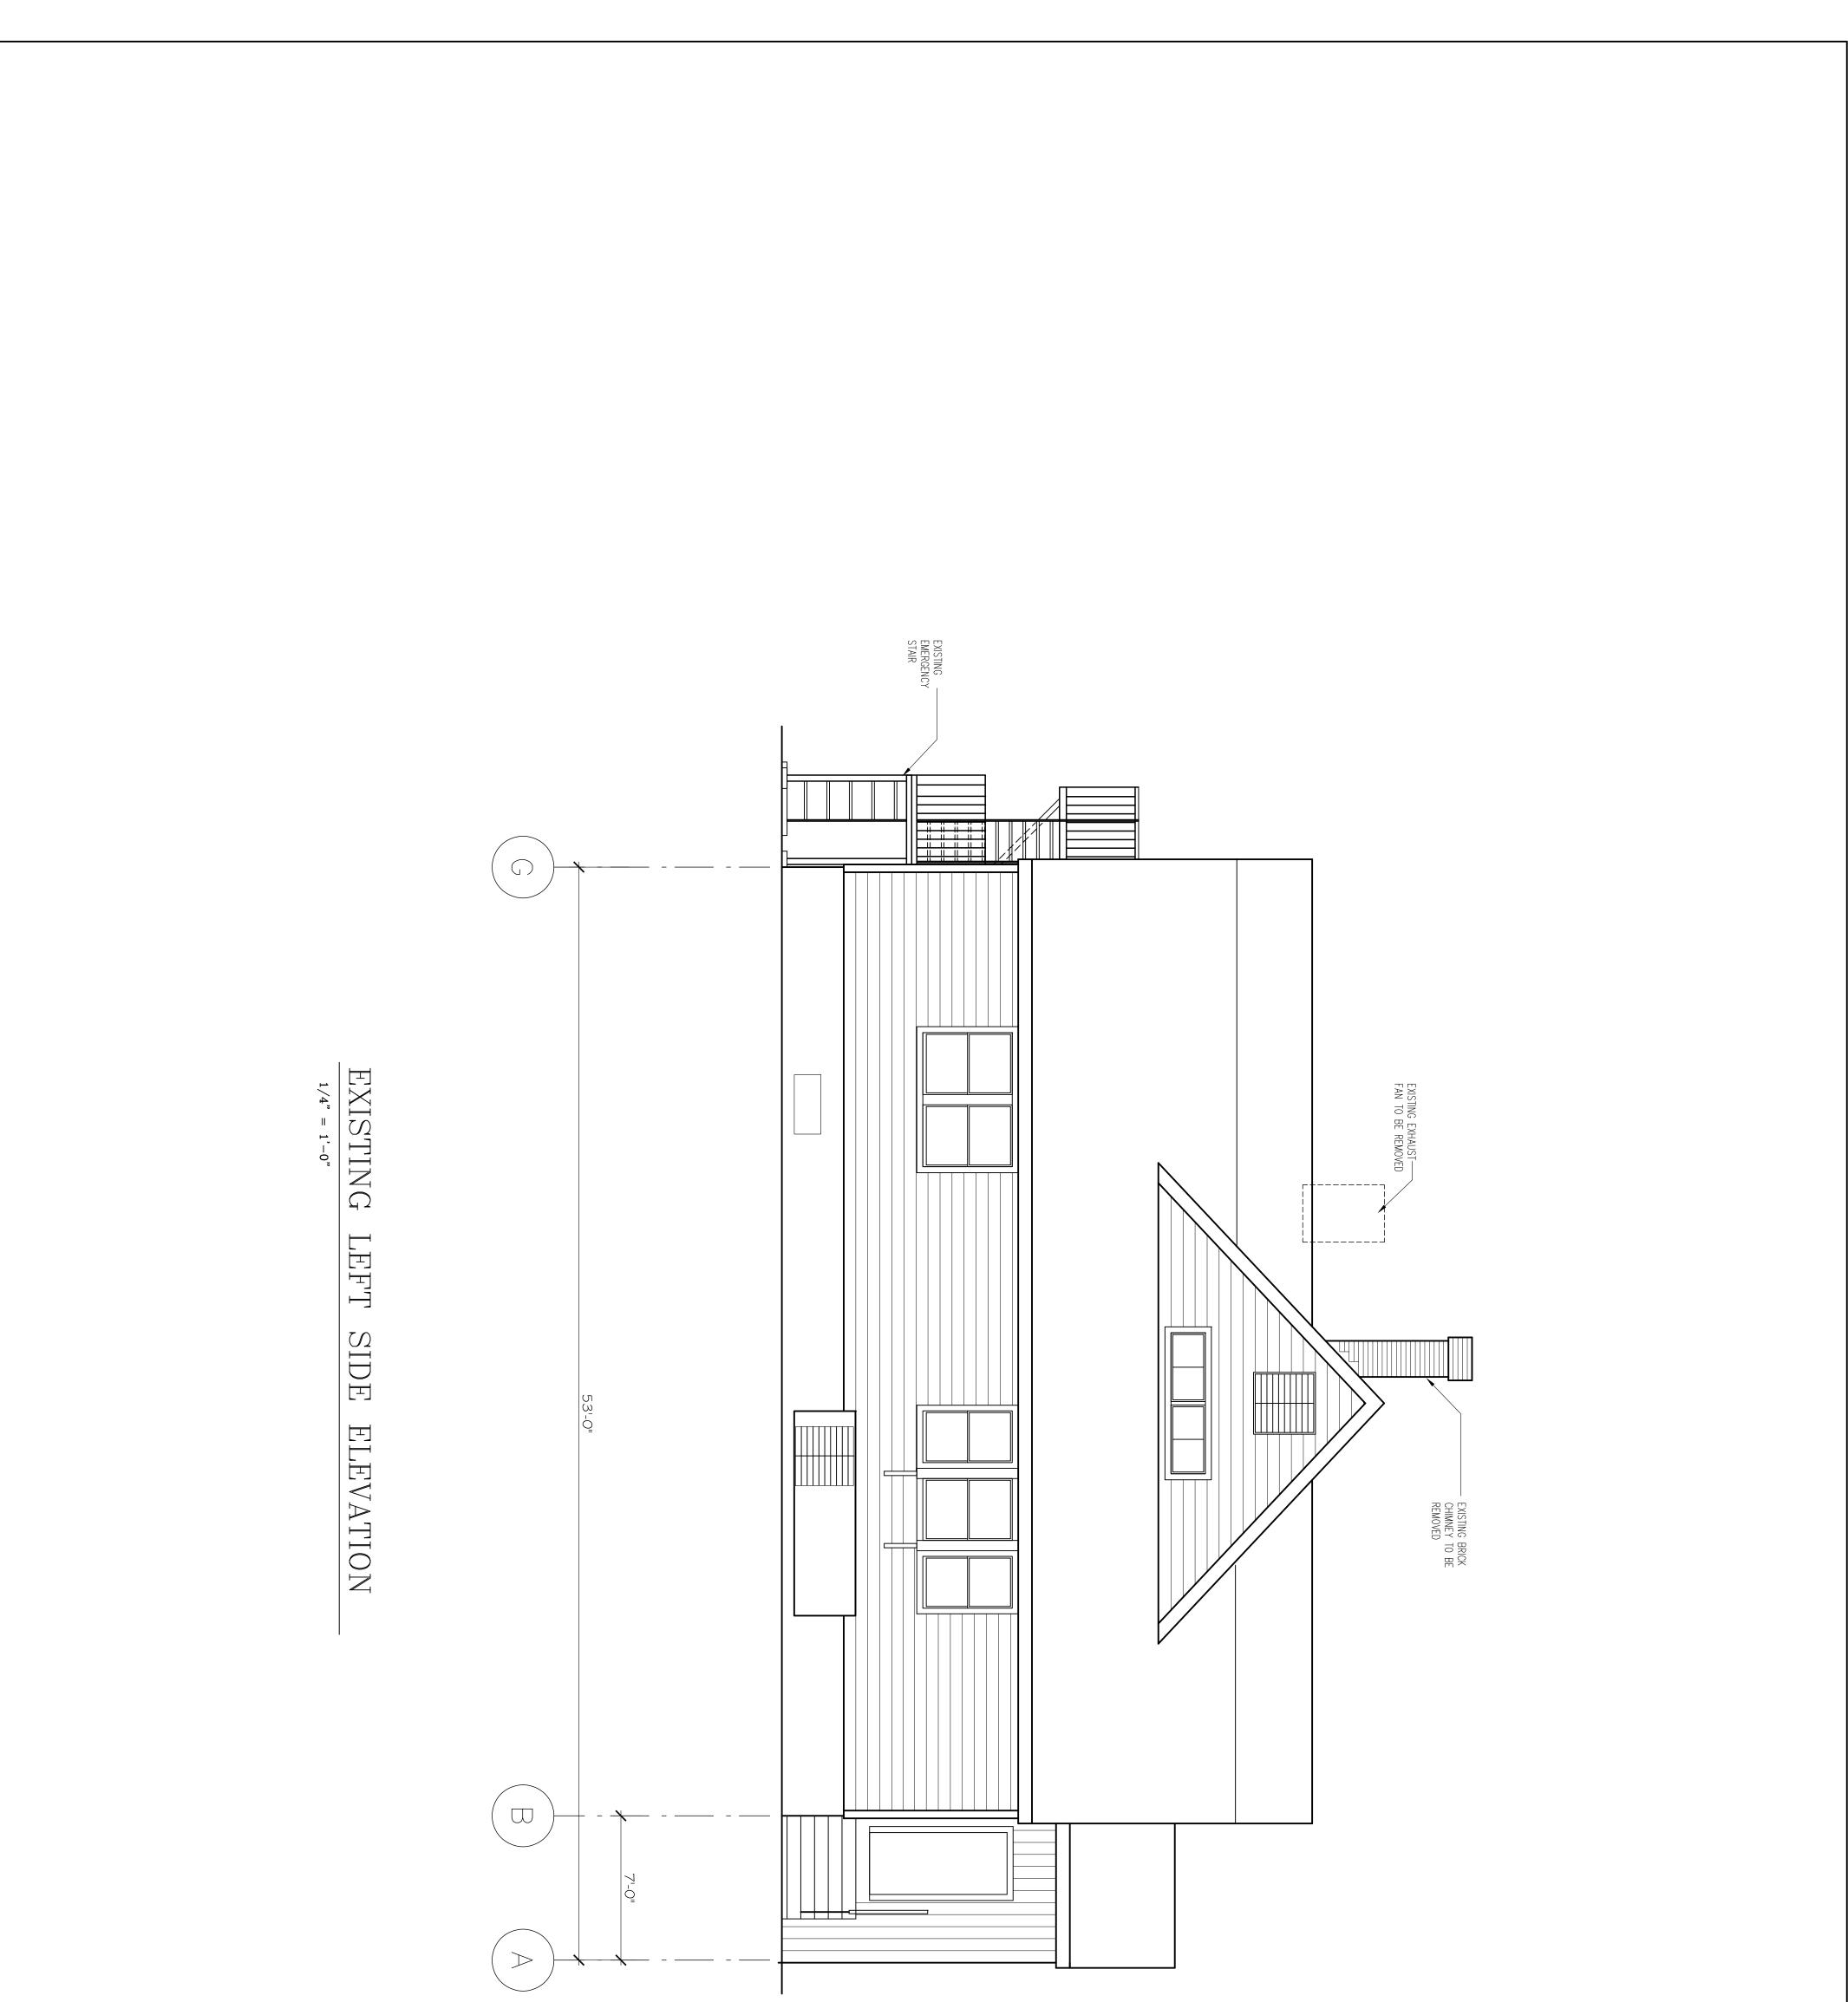


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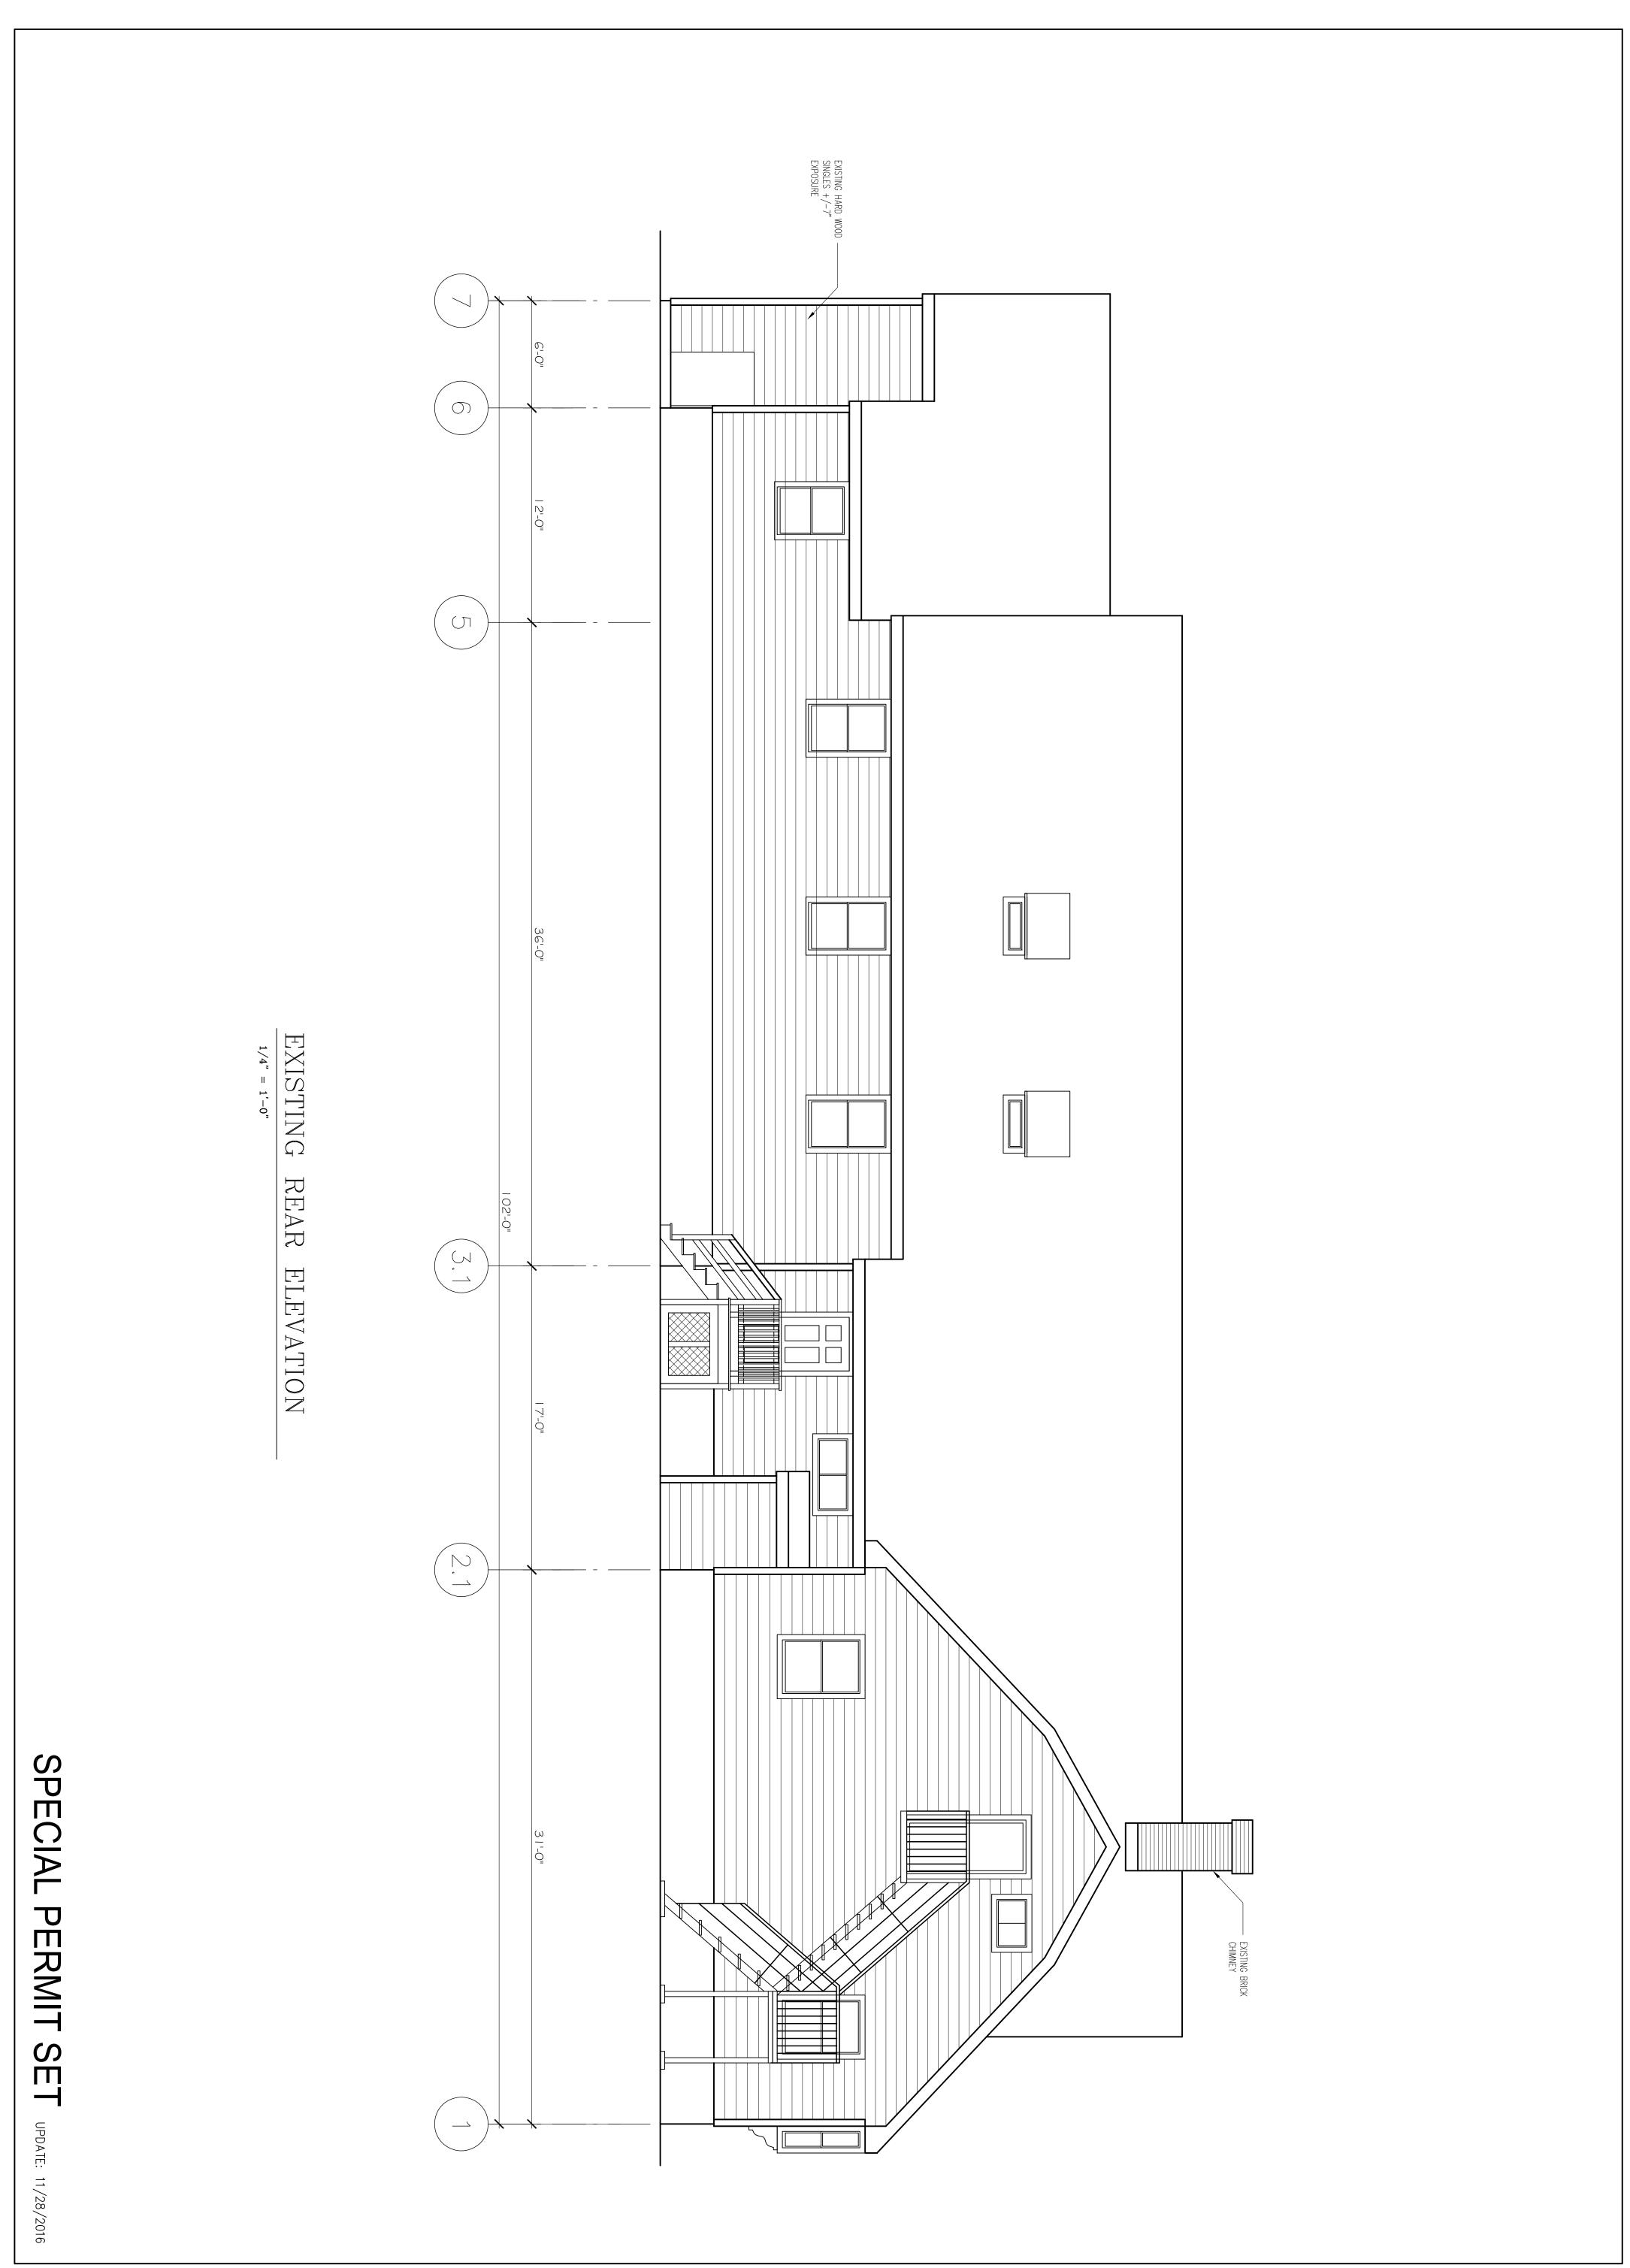


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×	DATE: NOV.24,2014 SCALE: AS NOTED DRAWN BY: N.G.H CHECKED BY: RJ REV :	Ronald F. Jarek, Architect 487 Watertown Street	PROJECT: RENOVATION & ALTERATIONS, 15 SOUTH GATE PARK, WEST NEWTON, MA 02465	EXISTING LEFT SIDE ELEVATION - SPECIAL PERMIT SET	ACOST AND FRED AND FR
ω		Newtonville, MA 02460	CLIENT: 15 SOUTH GATE PARK WEST NEWTON, MA 02465	15 SOUTH GATE PARK WEST NEWTON, MA 02465	HERE SERVICE



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		Newtonville, MA 02460	CLIENT: 15 SOUTH GATE PARK WEST NEWTON, MA 02465	15 SOUTH GATE PARK WEST NEWTON, MA 02465	THE STATE OF THE S