

5 South RESIDENTIAL RENOVATION AND ALTERATION Gate Park, West Newton 02465

DRAWINGS

NOTES & MATERIALS

F-6 E-X-1 E-X-2 E-X-2 E-X-3 PROPOSED LEFT SIDE ELEVATION
PROPOSED REAR ELEVATION
PROPOSED CROSS SECTION
PROPOSED SECTION B-B
PROPOSED SECTIONS & DETAILS
PROPOSED SECTIONS & DETAILS
PROPOSED SECTIONS & DETAILS
PROPOSED FIRST FLOOR FRAMING PLAN
PROPOSED FIRST FLOOR FRAMING PLAN
PROPOSED SECOND FLOOR FRAMING PLAN
PROPOSED SECTIONS & DETAILS
PROPOSED ATTIC & THIRD FLOOR FRAMING PLAN
PROPOSED ROOF FRAMING PLAN
PROPOSED ROOF FRAMING PLAN
PROPOSED ROOF FRAMING PLAN
PROPOSED ROOF FRAMING PLAN
S PROPOSED ATTIC & THIRD FLOOR FRAMING PLAN
S PROPOSED ROOF FRAMING PLAN
S PROPOSED ROOF FRAMING PLAN
S PROPOSED RECTIONS & DETAILS
S PROPOSED ROOF FRAMING PLAN
S PROPOSED RECTIONS & DETAILS
S PROPOSED ATTIC & THIRD FLOOR PLAN (similar above)
C-1 EXISTING ELEVATION
S EXISTING ELEVATION

> Architect: Ronald F. Ronald Jarek

Newtonville, Watertown 818-4540 \leq Street

PROPOSED FRONT ELEVATION

PROPOSED RIGHT SIDE ELEVATION

PROPOSED ATTIC FLOOR PLAN

PROPOSED SECOND FLOOR PLAN

PROPOSED FIRST FLOOR PLAN


BASE GARAGE TURNING MOVE FLOOR PLAN

PROPOSED BASEMENT GARAGE FLOOR PLAN

PROPOSED ROOF PLAN



SPECIAL PERMIT SET

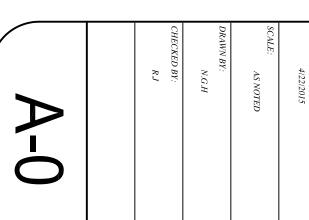

Ronald F. Jarek, Architect

PROJECT: RENOVATION & ALTERATIONS, 15 SOUTH GATE PARK, WEST NEWTON, MA 02465 CLIENT:

15 SOUTH GATE PARK

WEST NEWTON, MA 02465

SPECIAL PERMIT SET - TITLE SHEET

WEST NEWTON, MA 02465 15 SOUTH GATE PARK RESIDENCES,

1. ALL WORK SHALL COMPLY WITH THE COMMONWEALTH OF MASSACHUSETTS STATE BUILDING CODE, THE REQUIREMENTS OF THE CITY OF NEWTON, THE OCCUPATIONAL SAFETY AND HEALTH STANDARDS AND ALL OTHER APPLICABLE REGULATIONS, LAWS, ORDINANCES, ETC. GOVERNING THIS WORK INCLUDING HERS RATINGS.

2. PRIOR TO SUBMITTING BID, CONTRACTOR MUST THOROUGHLY EXAMINE THE DRAWINGS, AND INSPECT THE BUILDING TO FULLY UNDERSTAND THE FACILITY, DIFFICULTIES AND RESTRICTIONS AFFECTING THE EXECUTION OF THE WORK UNDER THIS CONTRACT. THE FAILURE OF THE CONTRACTOR TO RECEIVE OR EXAMINE ANY FORM OF INSTRUMENT OR DOCUMENT OR TO VISIT THE SITE SHALL IN NO WAY RELIEVE ANY OBLIGATION WITH RESPECT TO THIS WORK. NO CLAIMS FOR ANY ADDITIONAL COST WILL BE ALLOWED DUE TO LACK OF FULL KNOWLEDGE OF EXISTING CONDITIONS.

3. CONTRACTOR'S BID PRICE SHALL REFLECT ALL SPECIFED WORK.

4. DRAWN INFORMATION IS TAKEN FROM EXISTING CONDITIONS AND RANDOM FIELD MEASUREMENTS AND IS PROVIDED ONLY TO ASSIST THE CONTRACTOR IN ESTABLISHING THE SCOPE OF WORK.

5. ALL EXISTING CONDITIONS AND PLAN AND DETAIL DIMENSIONS SHOULD BE VERIFIED IN THE FIELD PRIOR TO COMMENCING THE WORK. THE CONTRACTOR SHALL NOTIFY THE OWNER OF ANY DISCREPANCIES FOUND IN THE PLANS OR SPECIFICATIONS BEFORE PROCEEDING WITH THE AFFECTED PART OF THE WORK.

6. DO NOT SCALE THESE DRAWINGS FOR DUANTITIES, LENGTHS, SIZES, AREAS ETC.

7. IT IS NOT INTENDED THAT THESE DRAWINGS SHOW EVERY CUT, CONDITION ETC. OF THIS SYSTEM, HOWEVER, THE CONTRACTOR SHALL FURNISH A COMPLETE PRODUCT IN ACCORDANCE WITH THE BEST PRACTICE OF THE TRADE TO THE SATISFACTION OF THE ARCHITECT AND THE OWNER, AND IN STRICT CONFORMANCE PRODUCT IN ACCORDANCE WITH THE BEST PRACTICE OF THE TRADE TO THE SATISFACTION OF THE ARCHITECT AND THE OWNER, AND IN STRICT CONFORMANCE PRODUCT IN ACCORDANCE AND STATE BUILDING CODE REGULATIONS.

CONTRACTOR SHALL REPAIR ALL AREAS DAMAGED BY DEMOLITION PRIOR TO INSTALLATION OF NEW MATERIAL

9. IF HAZARDOUS WASTES ENCOUNTERED, STOP WORK & CONTACT THE OWNER & ARCHITECT IMMEDIATELY TO INITIATE ABATEMENT WITH DHCD STANDARDS. PROCEDURES IN ACCORDANCE

GENERAL NOTES

1. ALL WORK SHALL COMPLY WITH THE STATE OF MASSACHUSETTS BUILDING CODE, REQUIREMENTS OF THE CITY OF NEWTON, AND ALL OTHER LOCAL, STATE AND PEDERAL STANDARDS AND REGULATIONS.
2. DO NOT SCALE THIS DRAWING. REFER TO ARCHITECTURAL DRAWINGS FOR DIMENSIONS, LIMITS AND LOCATIONS REGARDING LAYOUT OF ALL STRUCTURAL FRAMING MEMBERS AND COMPONENTS. REFER TO ARCH. DWGS. FOR ALL ELEVATIONS.
3. THE STRUCTURAL DRAWINGS SHALL BE USED IN CONJUNCTION WITH THE ARCHITECTURAL, MECHANICAL AND ELECTRICAL DRAWINGS AND THESE DRAWINGS SHALL BE USED IN CONJUNCTION WITH THE ARCHITECTURAL, MECHANICAL AND ELECTRICAL DRAWINGS AND THESE DRAWINGS AND THESE DRAWINGS AND THESE DRAWINGS AND THESE DRAWINGS AND THE STRUCTURAL MEMBERS.
4. DIMENSIONS SHOWN ON THE DRAWINGS MUST BE COORDINATED WITH ARCHITECTURAL, DRAWINGS PRIOR TO DETAILING, FABRICATION AND ERECTION OF ALL STRUCTURAL MEMBERS.
5. EXISTING LAYOUT, ITEMS AND CONDITIONS MAY DIFFER FROM AS SHOWN. ALL EXISTING CONDITIONS AND DIMENSIONS MUST BE VERIFIED IN FIELD PRIOR TO COMMENCING THE WORK. ANY DISCREPENCIES FOUND SHALL BE BROUGHT TO THE ATTENTION OF THE ENGINEER BEFORE PROCEEDING WITH THE AFFECTED PART OF THE WORK. ANY DISCREPENCIES FOUND SHALL BE BROUGHT TO THE ATTENTION UNDER THE SITE PRIOR TO BIDDING, FAILURE TO SEXAMINE THE SITE AND THE CONTRACTOR SHALL TAKE ADEQUATE PRECAUTIONS AT ALL TIMES TO PROTECT ADJOINING PROPERTY FROM DAMAGE. ALL ABUTTING WORK SHALL BE RESTORED TO PRESENT CONDITION.

7. FABRICATOR FOR EACH STRUCTURAL TRADE SHALL PREPARE SHOP DRAWINGS SHOWING LOCATION, LIMITS, DIMENSIONS AND EXTENT OF ALL MEMBERS, CONNECTION SHALL BE SUBMITTED FOR APPROVAL. NO ERECTION SHALL BE PERFORMED WITHOUT THE APPROVAL OF SHOP DRAWINGS.

8. THE CONTRACTOR SHALL TAKE ADEQUATE PRECAUTIONS AT ALL TIMES TO PROTECT ADJOINING PROPERTY FROM DAMAGE. ALL ABUTTING WORK SHALL BE RESTORED TO PRESENT CONDITION.

9. CONTRACTOR SHALL THAT AND DEPARTS FOR ALL ITEMS FOR APPROVAL.

OUNDATION NOTES

1. FOOTINGS SHALL BE CARRIED TO ELEVATIONS SHOWN ON THE DRAWINGS AND DEEPER IF NECESSARY TO OBTAIN A SAFE BEARING PRESSURE OF AT LEAST 2000 POUNDS PER SQUARE FOOT. CONTRACTOR SHALL VERIFY THE DESIGN BEARING CAPACITY THROUGH GEOTECHNICAL SERVICES PRIOR TO PLACING CONCRETE AND AFTER PLACEMENT HAS BEEN APPROVED.

2. NO FOUNDATIONS SHALL BE PLACED ON FROZEN SOIL OR WATER. PROVIDE PROPER DRAINAGE OF EXCAVATION WITH PLASTIC PIPE TO PROTECT AGAINST WATER. WHERE IT IS NECESSARY TO RAISE THE GRADE BELOW SLAB DUE TO OVER EXCAVATION, STRUCTURAL FILL SHALL BE PLACED AND COMPACTED TO 95% DRY DENSITY.

3. PROVIDE PROPER DRAINAGE OF EXCAVATION OR COVER EXCAVATION WITH PLASTIC TO PROTECT AGAINST WATER. SAFE BEARING PRESSURE OF AT LEAST LEAST PRIOR TO PLACING CONCRETE

YWOOD NOTES

PLYWOOD SHEATHING SHALL BE APA RATED STRUCTURAL I. PLYWOO. PLYWOOD SHALL HAVE A MINIMUM THICKNESS OF 3/4". EDGES SHALL BE TONGUE AND GROOVE JOINTED OR CONTINUOUSLY I. PLYWOOD USED FOR ROOF GRADE.

SUPPORTED WITH WOOD BLOCKING.

BE 6x6-W4xW4 UNLESS

E 3/4" CHAMFER, USING EDGING TOOL WHERE NEEDED. EXPOSED CONCRETE SURFACES SHALL HAVE A UNIFORM TEXTURE WHILE CONCRETE IS STILL GREEN, TO PRODUCE A SURFACE ACCEPTABLE TO

1. ALL WORK AND MATERIALS SHALL CONFORM TO THE LATEST EDITION OF AMERICAN CONCRETE INSTITUTE'S ACI 318 (BUILDING REINFORCED CONCRETE). CONCRETING SHALL FOLLOW REQUIREMENTS OF ACI 306 R FOR COLD WEATHER CURING AND ACI 305 R I 2 CONCRETE STRENGTH SHALL BE AS FOLLOWS: ALL CONCRETE — MIN. COMPRESSIVE STRENGTH = 4000 PSI 3. ALL BAR REINFORCEMENT SHALL CONFORM TO ASTM A615 — GRADE 60.

4. ALL WELDED WIRE FABRIC SHALL CONFORM TO ASTM A185 AND SHALL BE SUPPLIED IN FLAT SHEETS. WELDED WIRE FABRIC S NOTED.

5. MINIMUM CONCRETE CLEARANCES FOR PROTECTION OF REINFORCING:

5. SLABS: TOP — 2"

MALL: ALL SIDES — 2" (MIN.)

6. ALL EXPOSED CONCRETE EDGES SHALL HAVE 3/4" CHAMFER, USING EDGING TOOL WHERE NEEDED. EXPOSED CONCRETE SURFIFINISH. JOINTS AND FINS SHALL BE SACKED TO A UNIFORM TEXTURE WHILE CONCRETE IS STILL GREEN, TO PRODUCE A SURFACE DESIGNERS & OWNER.

7. CONSTRUCTION JOINT SPACING SHALL BE AS SHOWN ON THE DRAWINGS.

8. BONDING AGENT FOR ADHERING NEW CONCRETE TO EXISTING CONCRETE SHALL BE APPLIED PRIOR TO POURING NEW CONCRETE "WELDCRETE" AS MANUFACTURED BY LARSEN PRODUCTS CORP. OF ROCKVILLE, MD, OR APPROVED EQUAL.

9. DOWELLING OF NEW REINFORCEMENT INTO EXISTING CONCRETE SHALL BE ACHIEVED BY USING THE HILTI HVA "ADHESIVE ANCH SHALL BE IN ACCORDANCE WITH MANUFACTURER'S PRINTED INSTRUCTIONS.

10. CONTROL JOINTS SHALL BE PLACED THROUGHOUT AND EQUALLY SPACED NOT EXCEEDING 10' ON CENTER, IN ANY DIRECTION. ALL INSTALLATION

IN ANY DIRECTION.

1. ALL STRUCTURAL WOODWORK, MATERIALS AND WORKMANSHIP SHALL CONFORM TO THE LATEST EDITION CONSTRUCTION'S SPECIFICATION FOR DESIGN, FABRICATION AND ERECTION OF WOOD STRUCTURES.

2. ALL STRUCTURAL LUMBER SHALL BE SOUTHERN PINE, DOUGLAS FIR, GRADE 1 OR APPROVED EQUAL WIMINIMUM PROPERTIES OF: E = 1,800,000 PSI, Fb = 1500 PSI, Fv = 190 PSI.

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ALL DIMENSIONS ARE APPROXIMATE. CONTRACTOR MUST VERIFY ALL EXISTING DIMENSIONS AND PREPARE A LAYOUT DRAWING WITH ALL EXISTING CONDITION PRIOR TO PROCEEDING WITH ANY NEW WORK.

MATERIALS

DIMENSION

PRODUCTS

SEE ATTACHED

EXTERIOR MATERIALS LIST: 15 SOUTH GATE PARK., West Newton MA 02465

ROOF:

30 year Fiberglass Asphalt Shingles Corrugated (black) Ridge Vent Black Vent Pipes Natural Heating Exhaust Stacks (flush style)

Azek or equal Rake, Cornice, Frieze, Water-table, Running Trim

SIDING

Square Butt Cedar Wood Shingles 7" to weather, texture side out, matching existing
 Painted MDO Plywood at Dormer Pediments
 Azek or equal Direct Vent Exhaust Block Outs, Lighting Block outs
 Painted Side-wall Vents (Dryer, Exhaust Fans) through Azek or equal Blocks outs
 DOWN SPOUTS AND GUTTERS
 Baked on Color Finish, Aluminum Box Trough Style w/ Round Leaders and Fittings

WINDOWS Marvin or equal Insulated Glass, Simulated 2 over 1

 Synthetic Panel Entry Units with Vision Lites and/or
 Synthetic Panel Style Garage Door or Coiling Grill S
 COLUMNS **DOORS**

 Azek or equal Square synthetic and/or field built PORCH, DECK and STEPS and Ramps
 Trex or equal Porch, Deck and Stair Treads
 Azek or equal Risers and Stringers
 Synthetic Balustrade and Square Newel Posts, Synthetic Balustrade ynthetic Rail System at HC Ramps

HARDWARE LIGHTING Wall Mounted Lantern Style

Stainless Steel Lever or Thumb Latch Style

Mail Boxes Stainless Steel House Numbers Stainless

WALKS

DRIVEYAY

Modular Pavers at Entry Points

■ Bituminous RETAINING WALLS Concrete at Vehicular Ramp and Stone Faced (match fdn) at Handicapped Ramp.

Floor Area Ratio Chart: 15 SOUTH GATE PARK RESIDENCES, WEST NEWTON, MA 02465

TOTAL SQ. FT.	ATTIC FLOOR AREA	SECOND FLOOR	FIRST FLOOR	BASEMENT GARAGE	AREA		15 South Gate Park, Residences FAR
1667 SF.		550 SF.	1117 SF.	3776 SF. –	S.F	UNIT "1"	ite Park,
	LESS THAN 7'	PARTIAL CATHEDRAL			NOT INCLUDED IN FAR		Residence
1,227 SF.		550 SF.	377 SF.		S.F	UNIT "2"	s FAR / SQ. FT. CALCULATIONS, SR-3 Zone, LOT SIZE 14,120 sf
	LESS THAN 7'				NOT INCLUDED IN FAR		
1,436 SF.		673 SF.	763 SF.		S.F	UNIT "3"	
	LESS THAN 7'				NOT INCLUDED IN FAR		NS, SR-3
1,709 SF.		823 SF.	886 SF.		S.F	UNIT "4"	Zone, L(
	LESS THAN 7'			>	NOT INCLUDED IN FAR		OT SIZE 14
5,507 SF.					TOTAL S.F. ALLOWED @ 0.39 FAR		,120 sf -
6,039 SF.					PROVIDED @ 0.43 FAR	-4 UNITS	

SPECIAL PERMIT SE UPDATE:

9/17/2015

Ronald F. Jarek, Architect

487 Watertown Street

Newtonville, MA 02460

PROJECT: RENOVATION & ALTERATIONS, 15 SOUTH GATE PARK,


15 SOUTH GATE PARK

SPECIAL PERMIT SET - NOTES & MATERIALS

15 SOUTH GATE PARK WEST NEWTON, MA 02465


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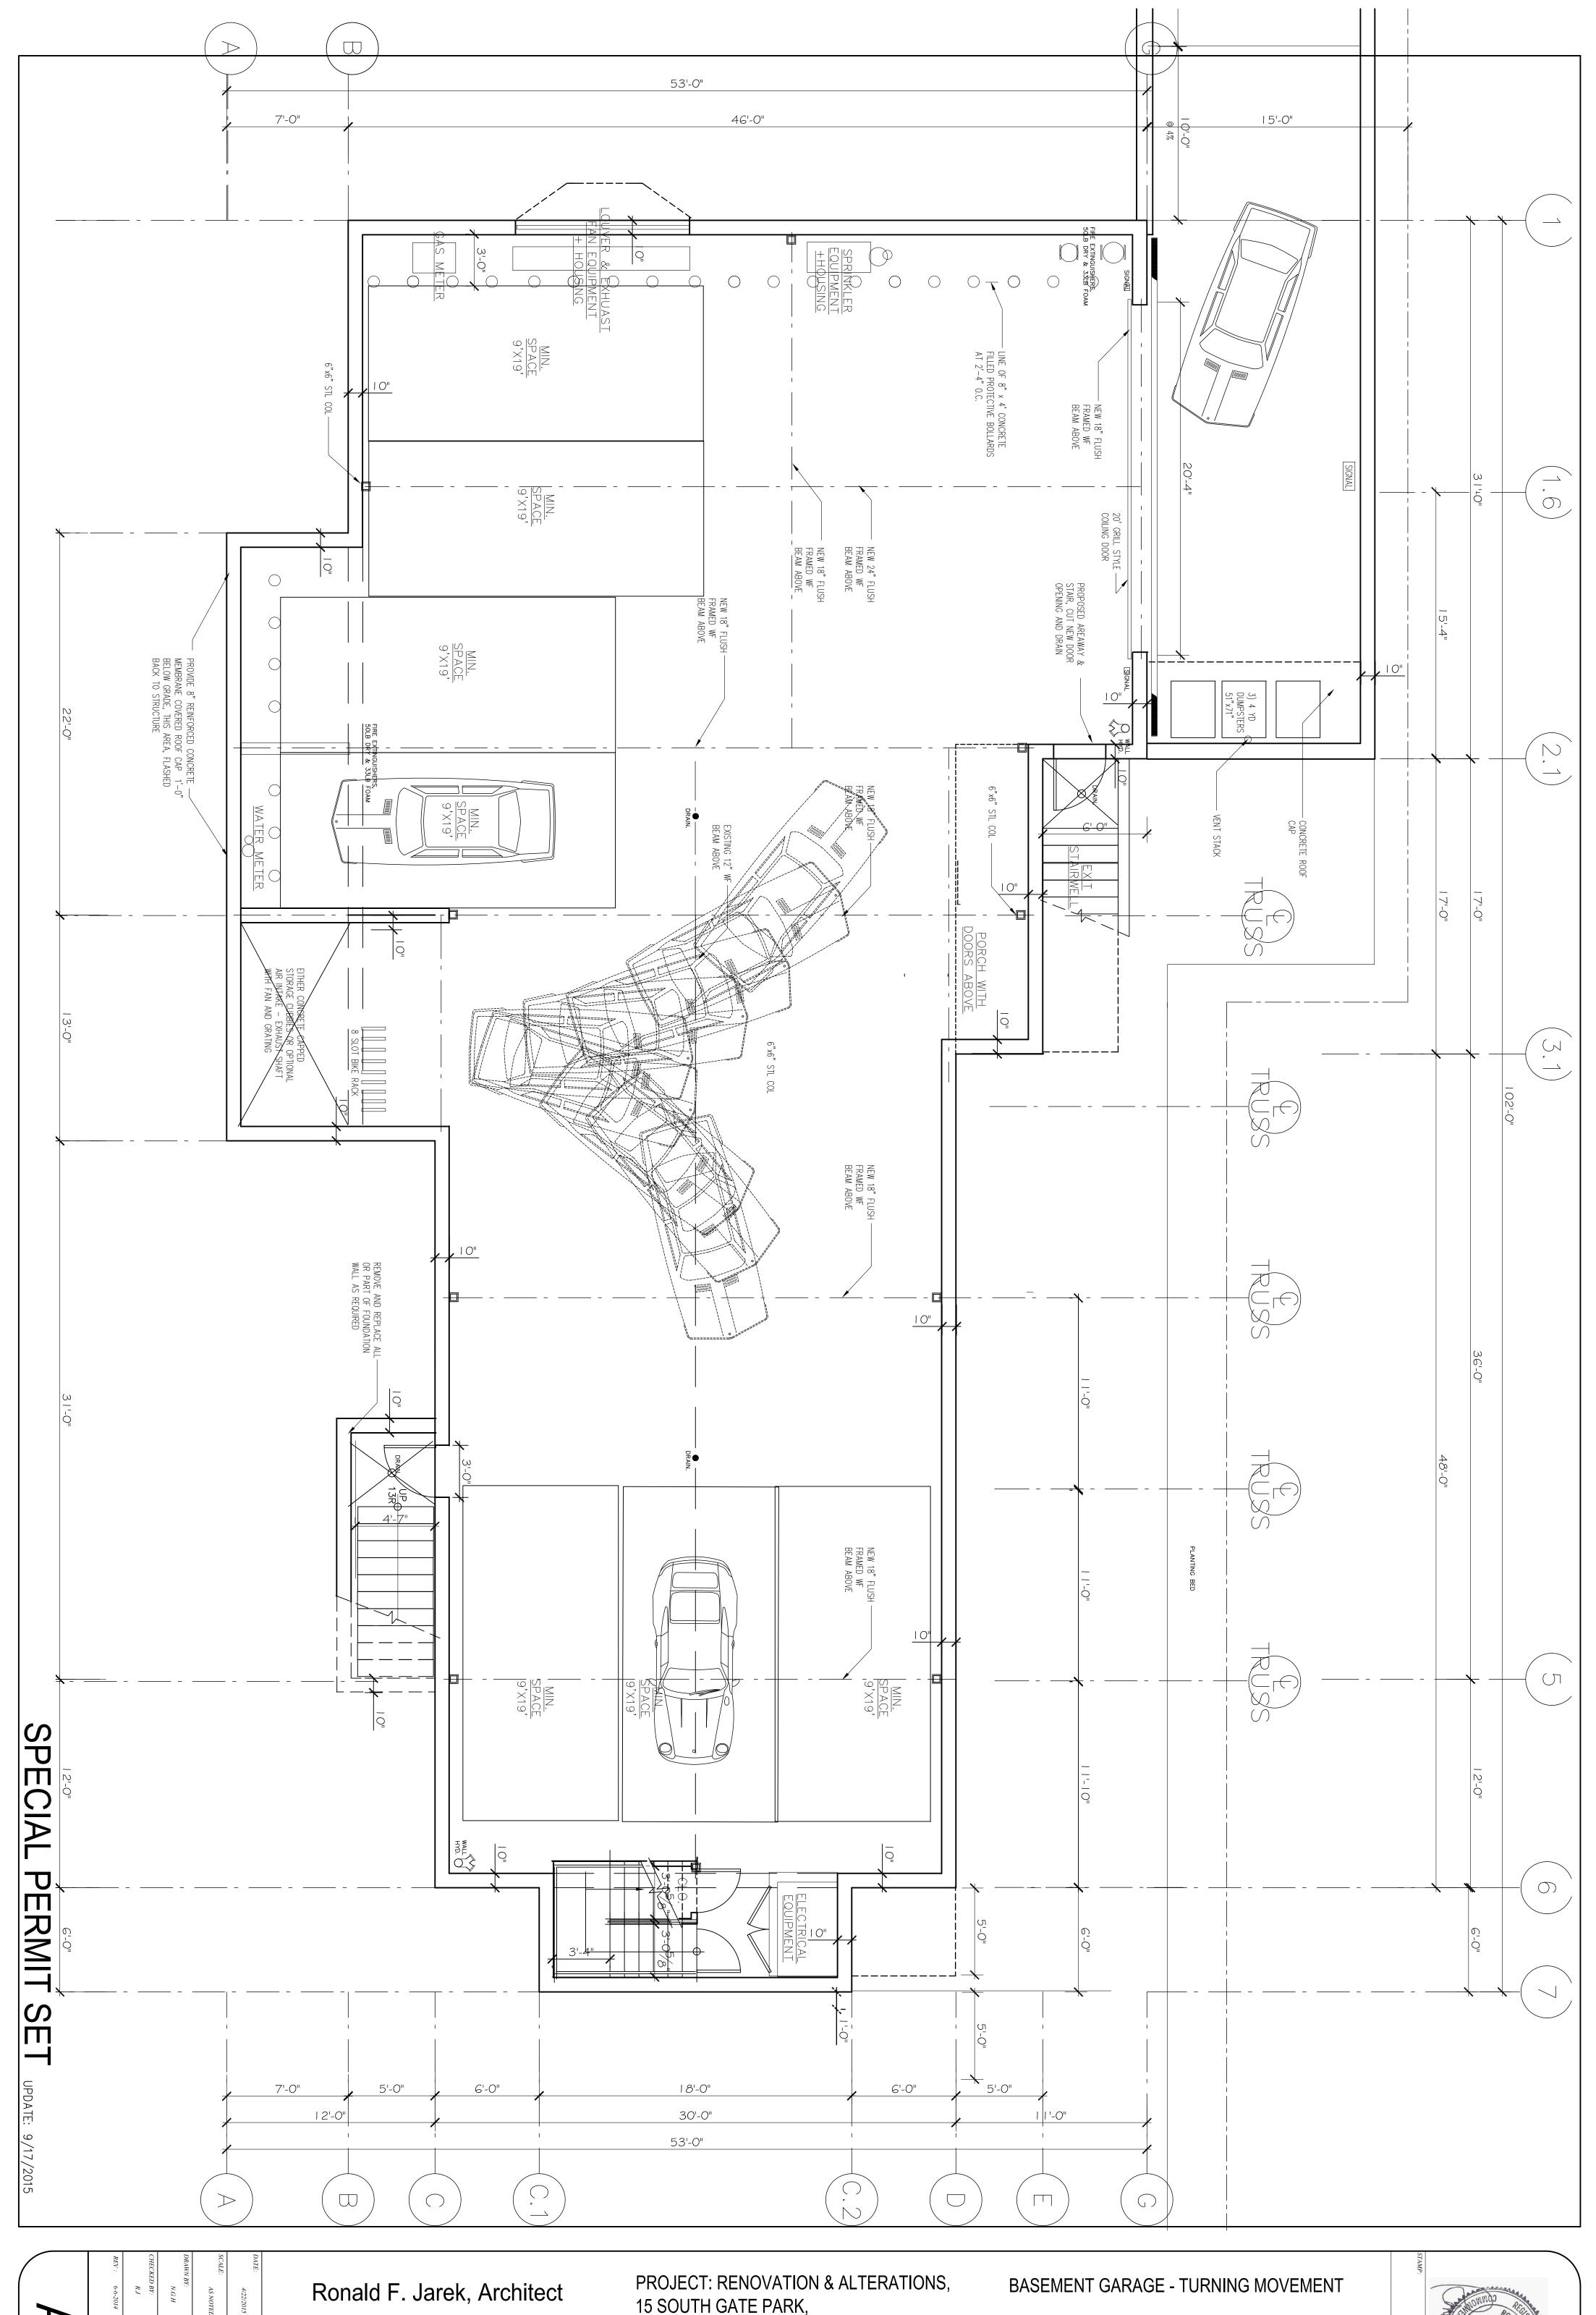
WEST NEWTON, MA 02465

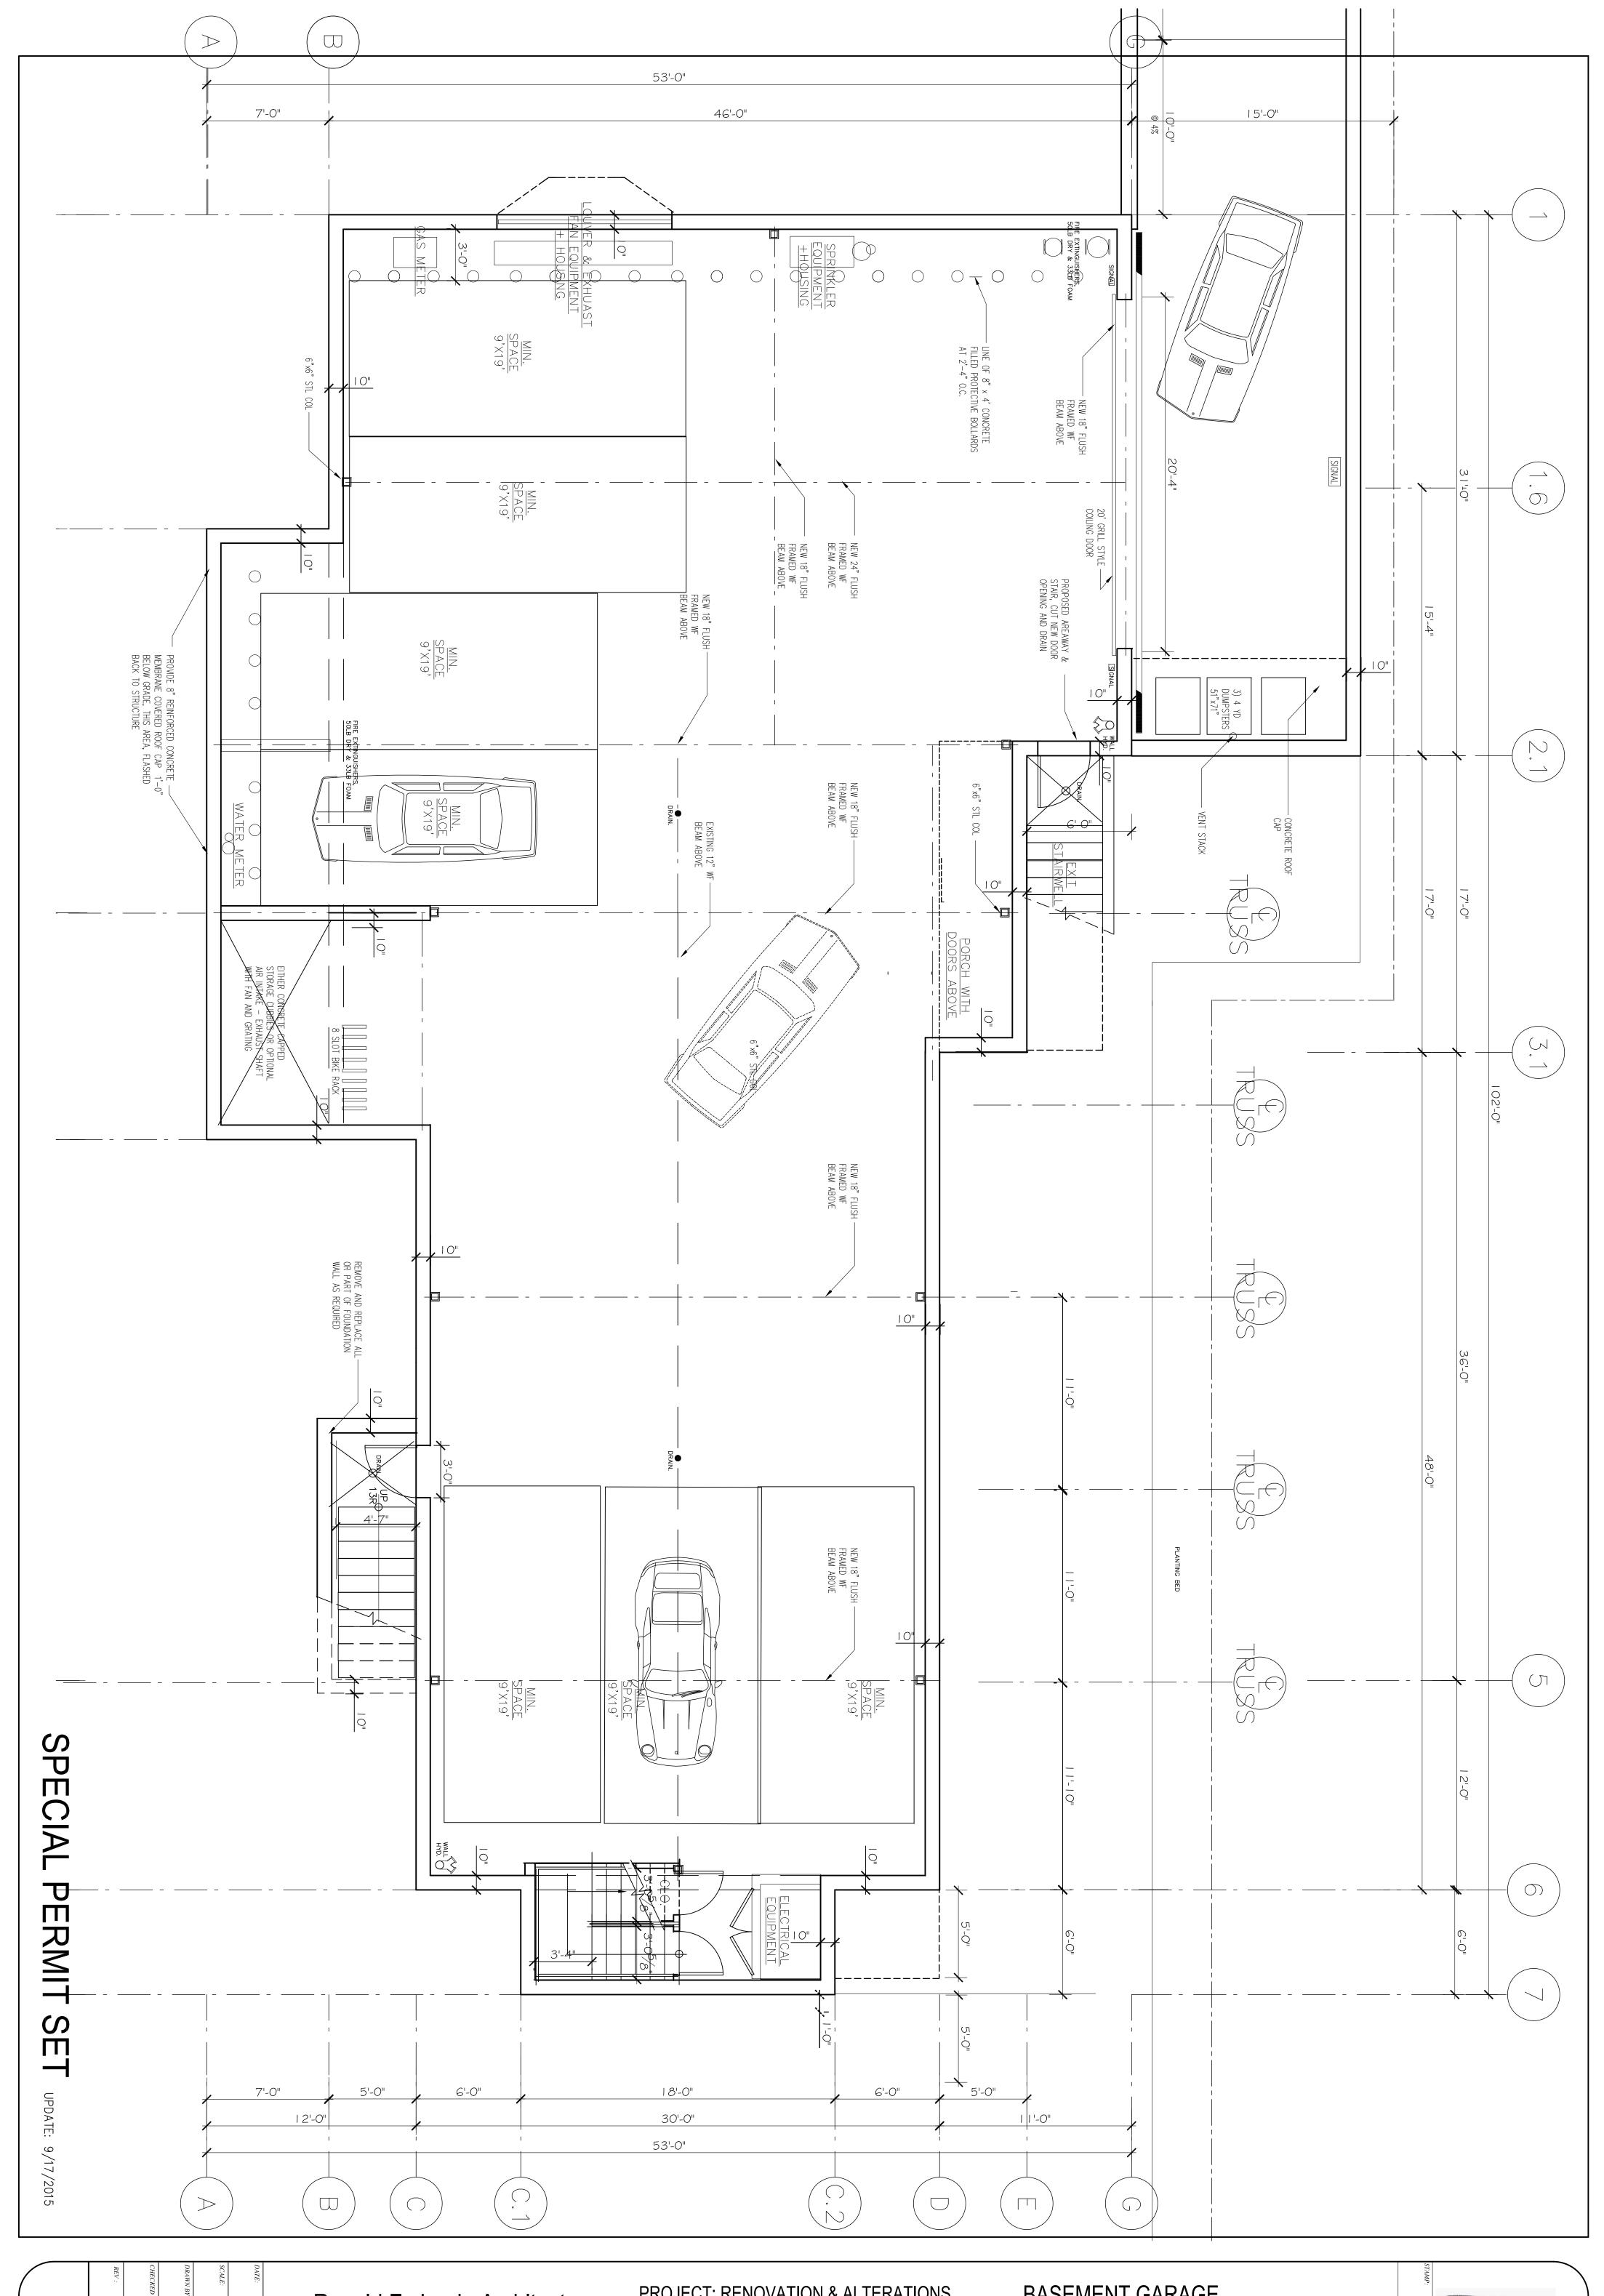

PROJECT: RENOVATION & ALTERATIONS, 15 SOUTH GATE PARK, WEST NEWTON, MA 02465

CLIENT: 15 SOUTH GATE PARK WEST NEWTON, MA 02465 BASEMENT GARAGE




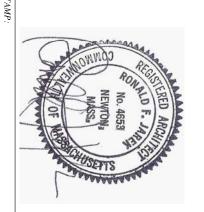


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487 Watertown Street Newtonville, MA 02460 15 SOUTH GATE PARK, WEST NEWTON, MA 02465

CLIENT: 15 SOUTH GATE PARK WEST NEWTON, MA 02465



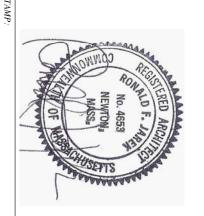


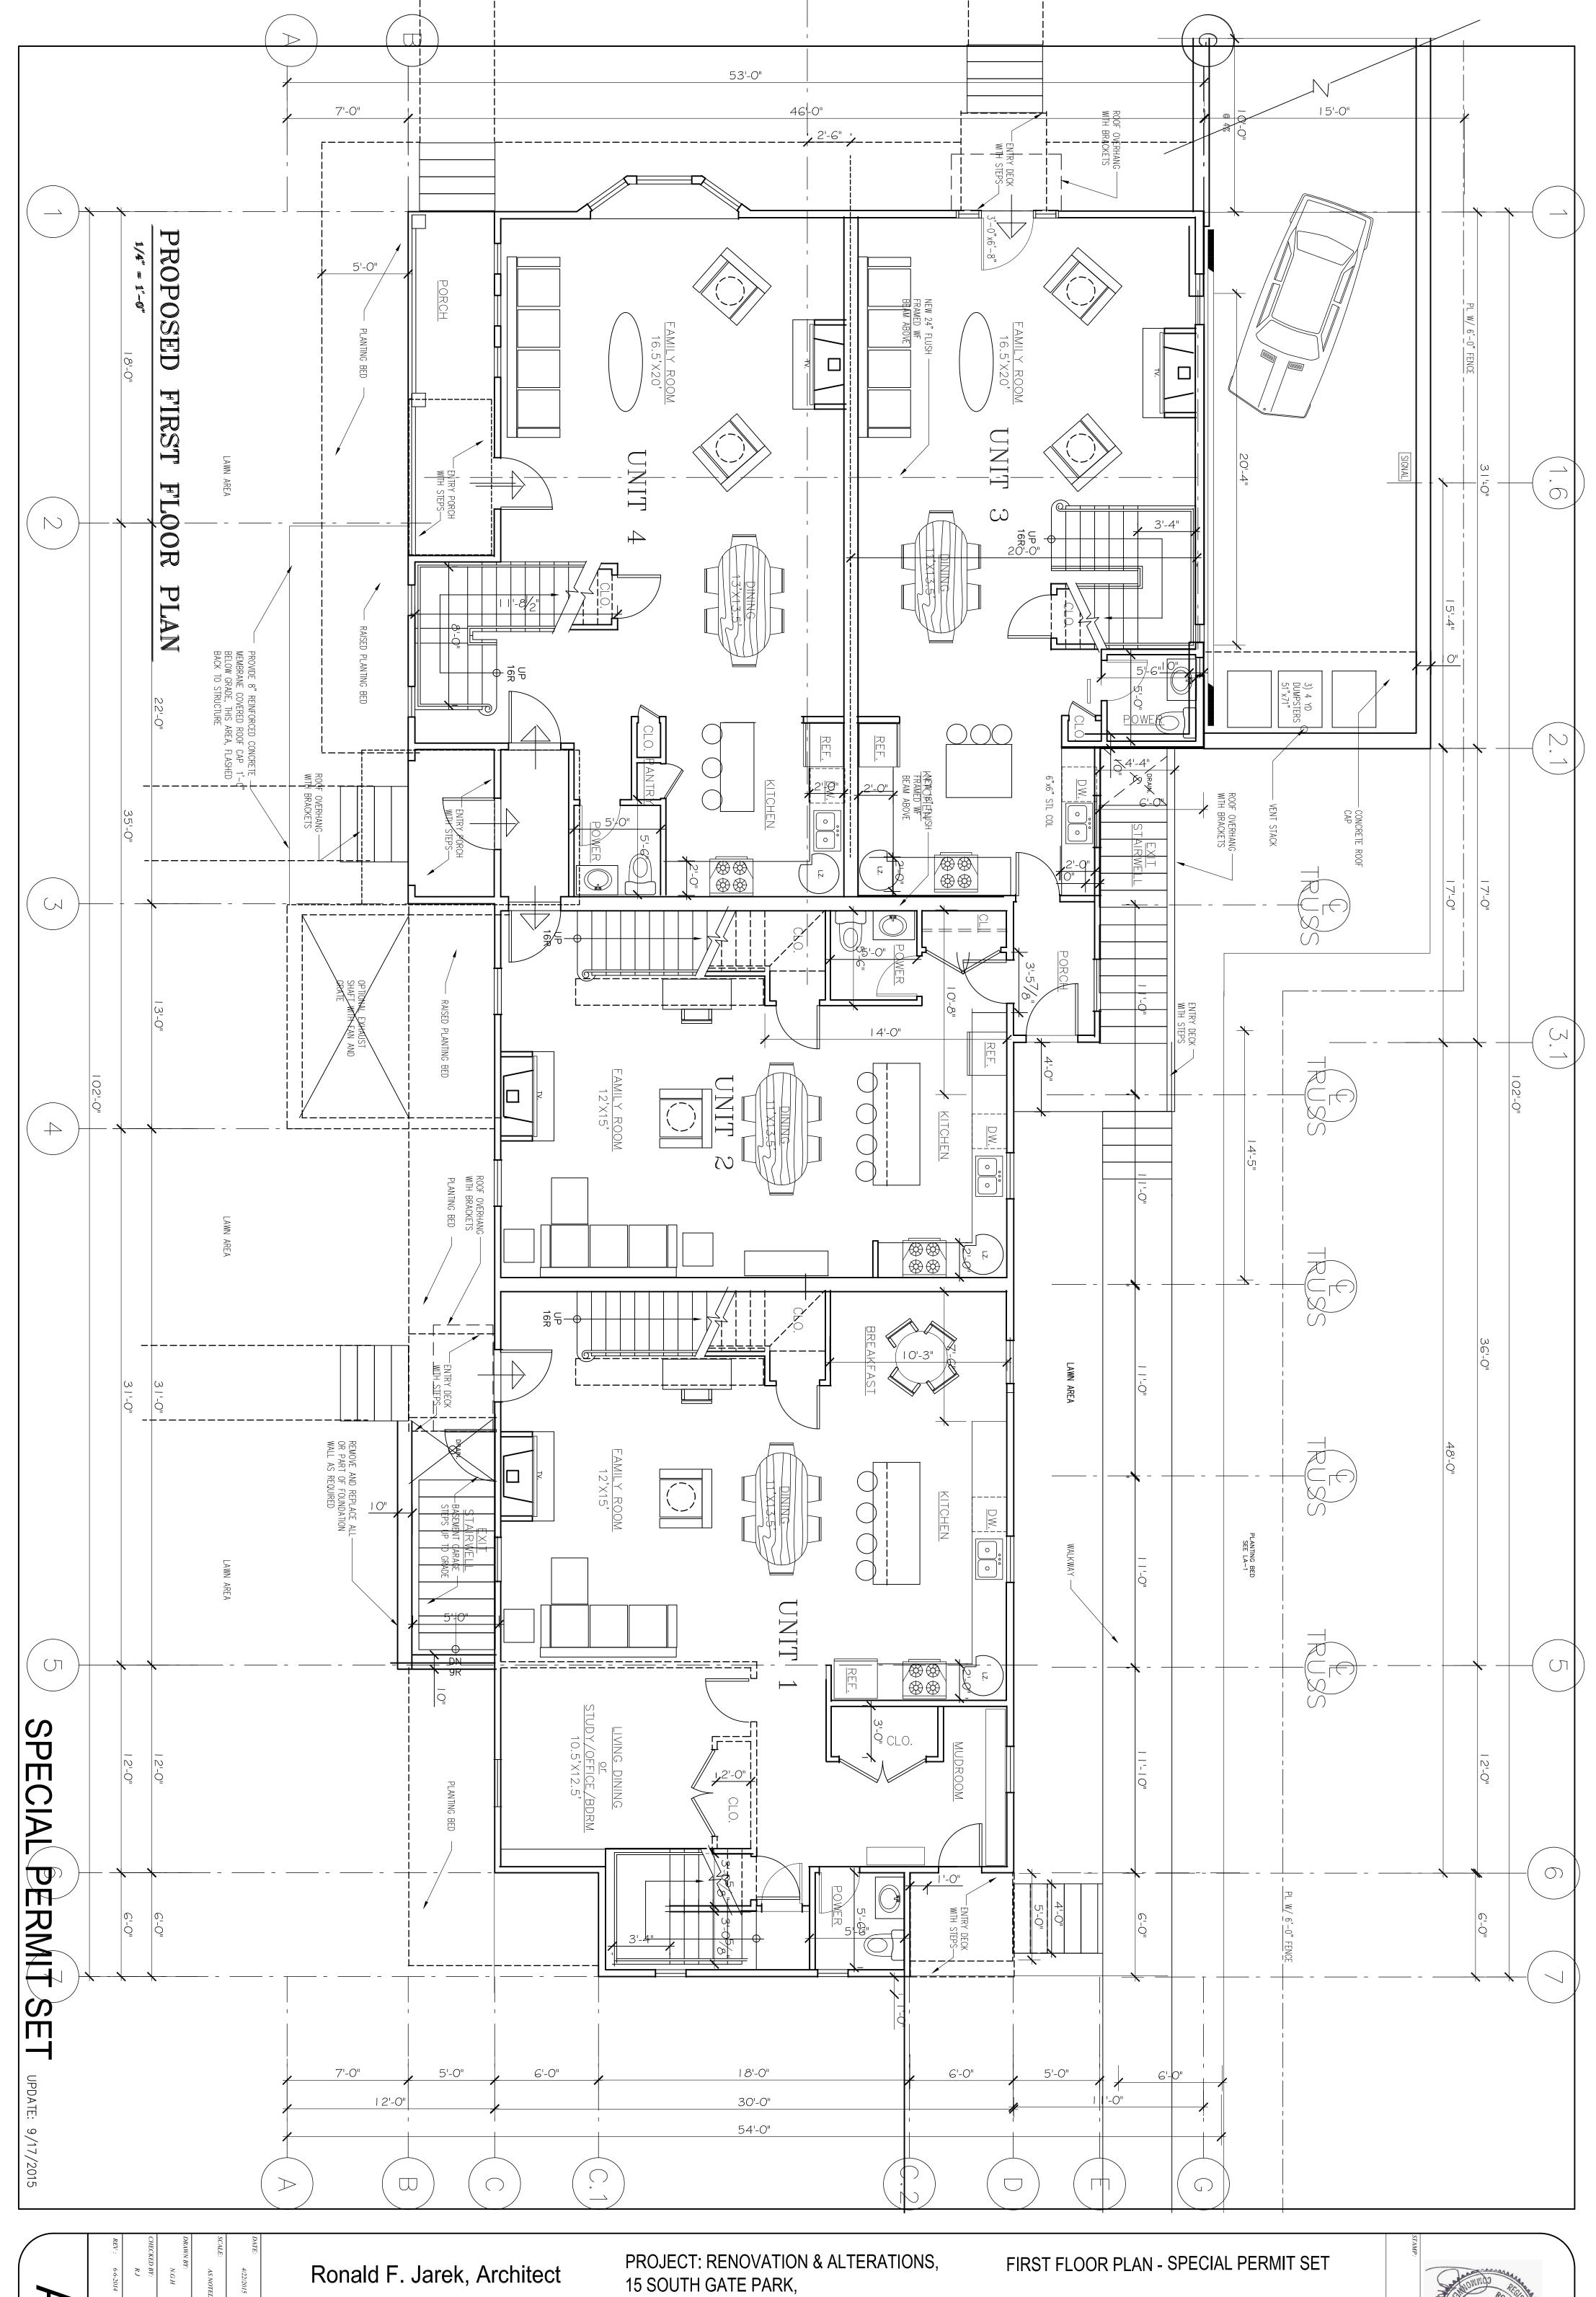
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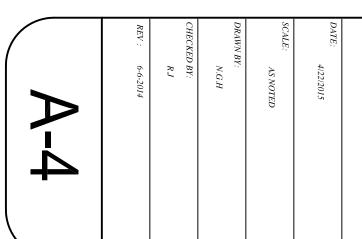
Newtonville, MA 02460

WEST NEWTON, MA 02465

CLIENT: 15 SOUTH GATE PARK WEST NEWTON, MA 02465




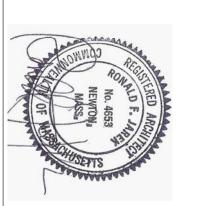


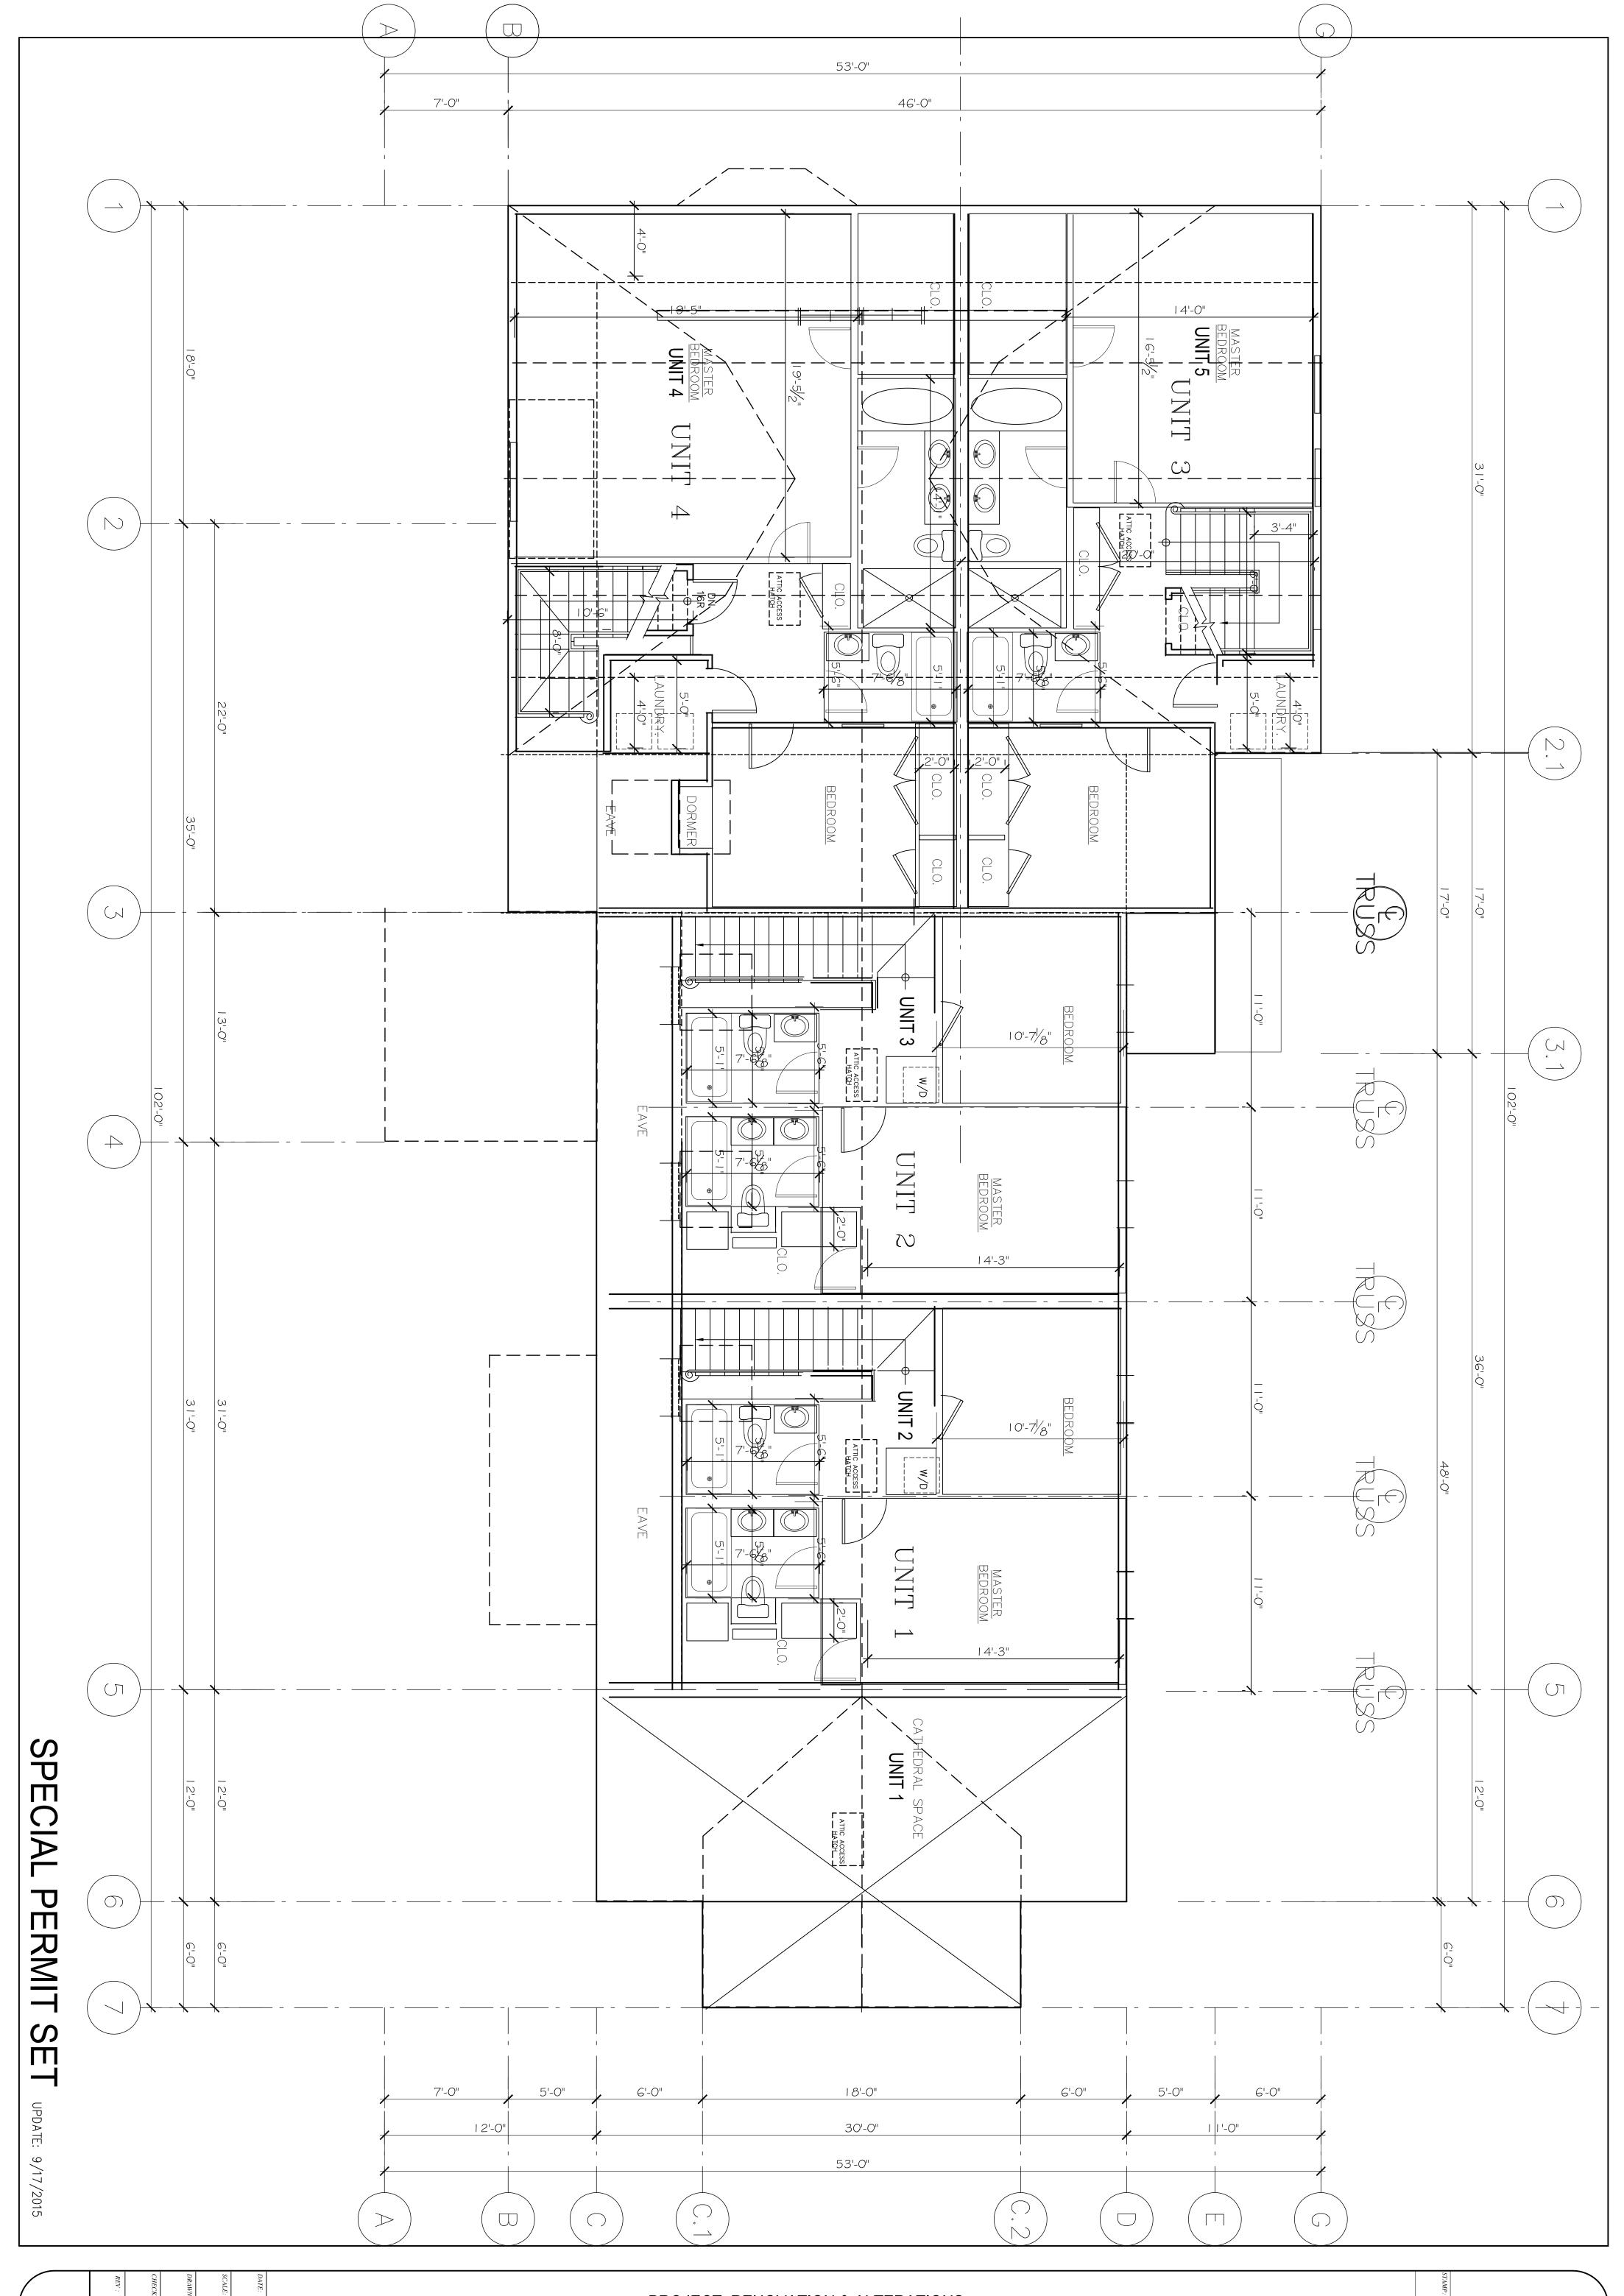

PROJECT: RENOVATION & ALTERATIONS, 15 SOUTH GATE PARK, WEST NEWTON, MA 02465

CLIENT: 15 SOUTH GATE PARK WEST NEWTON, MA 02465 SECOND FLOOR PLAN - SPECIAL PERMIT SET

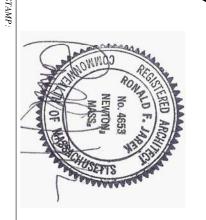

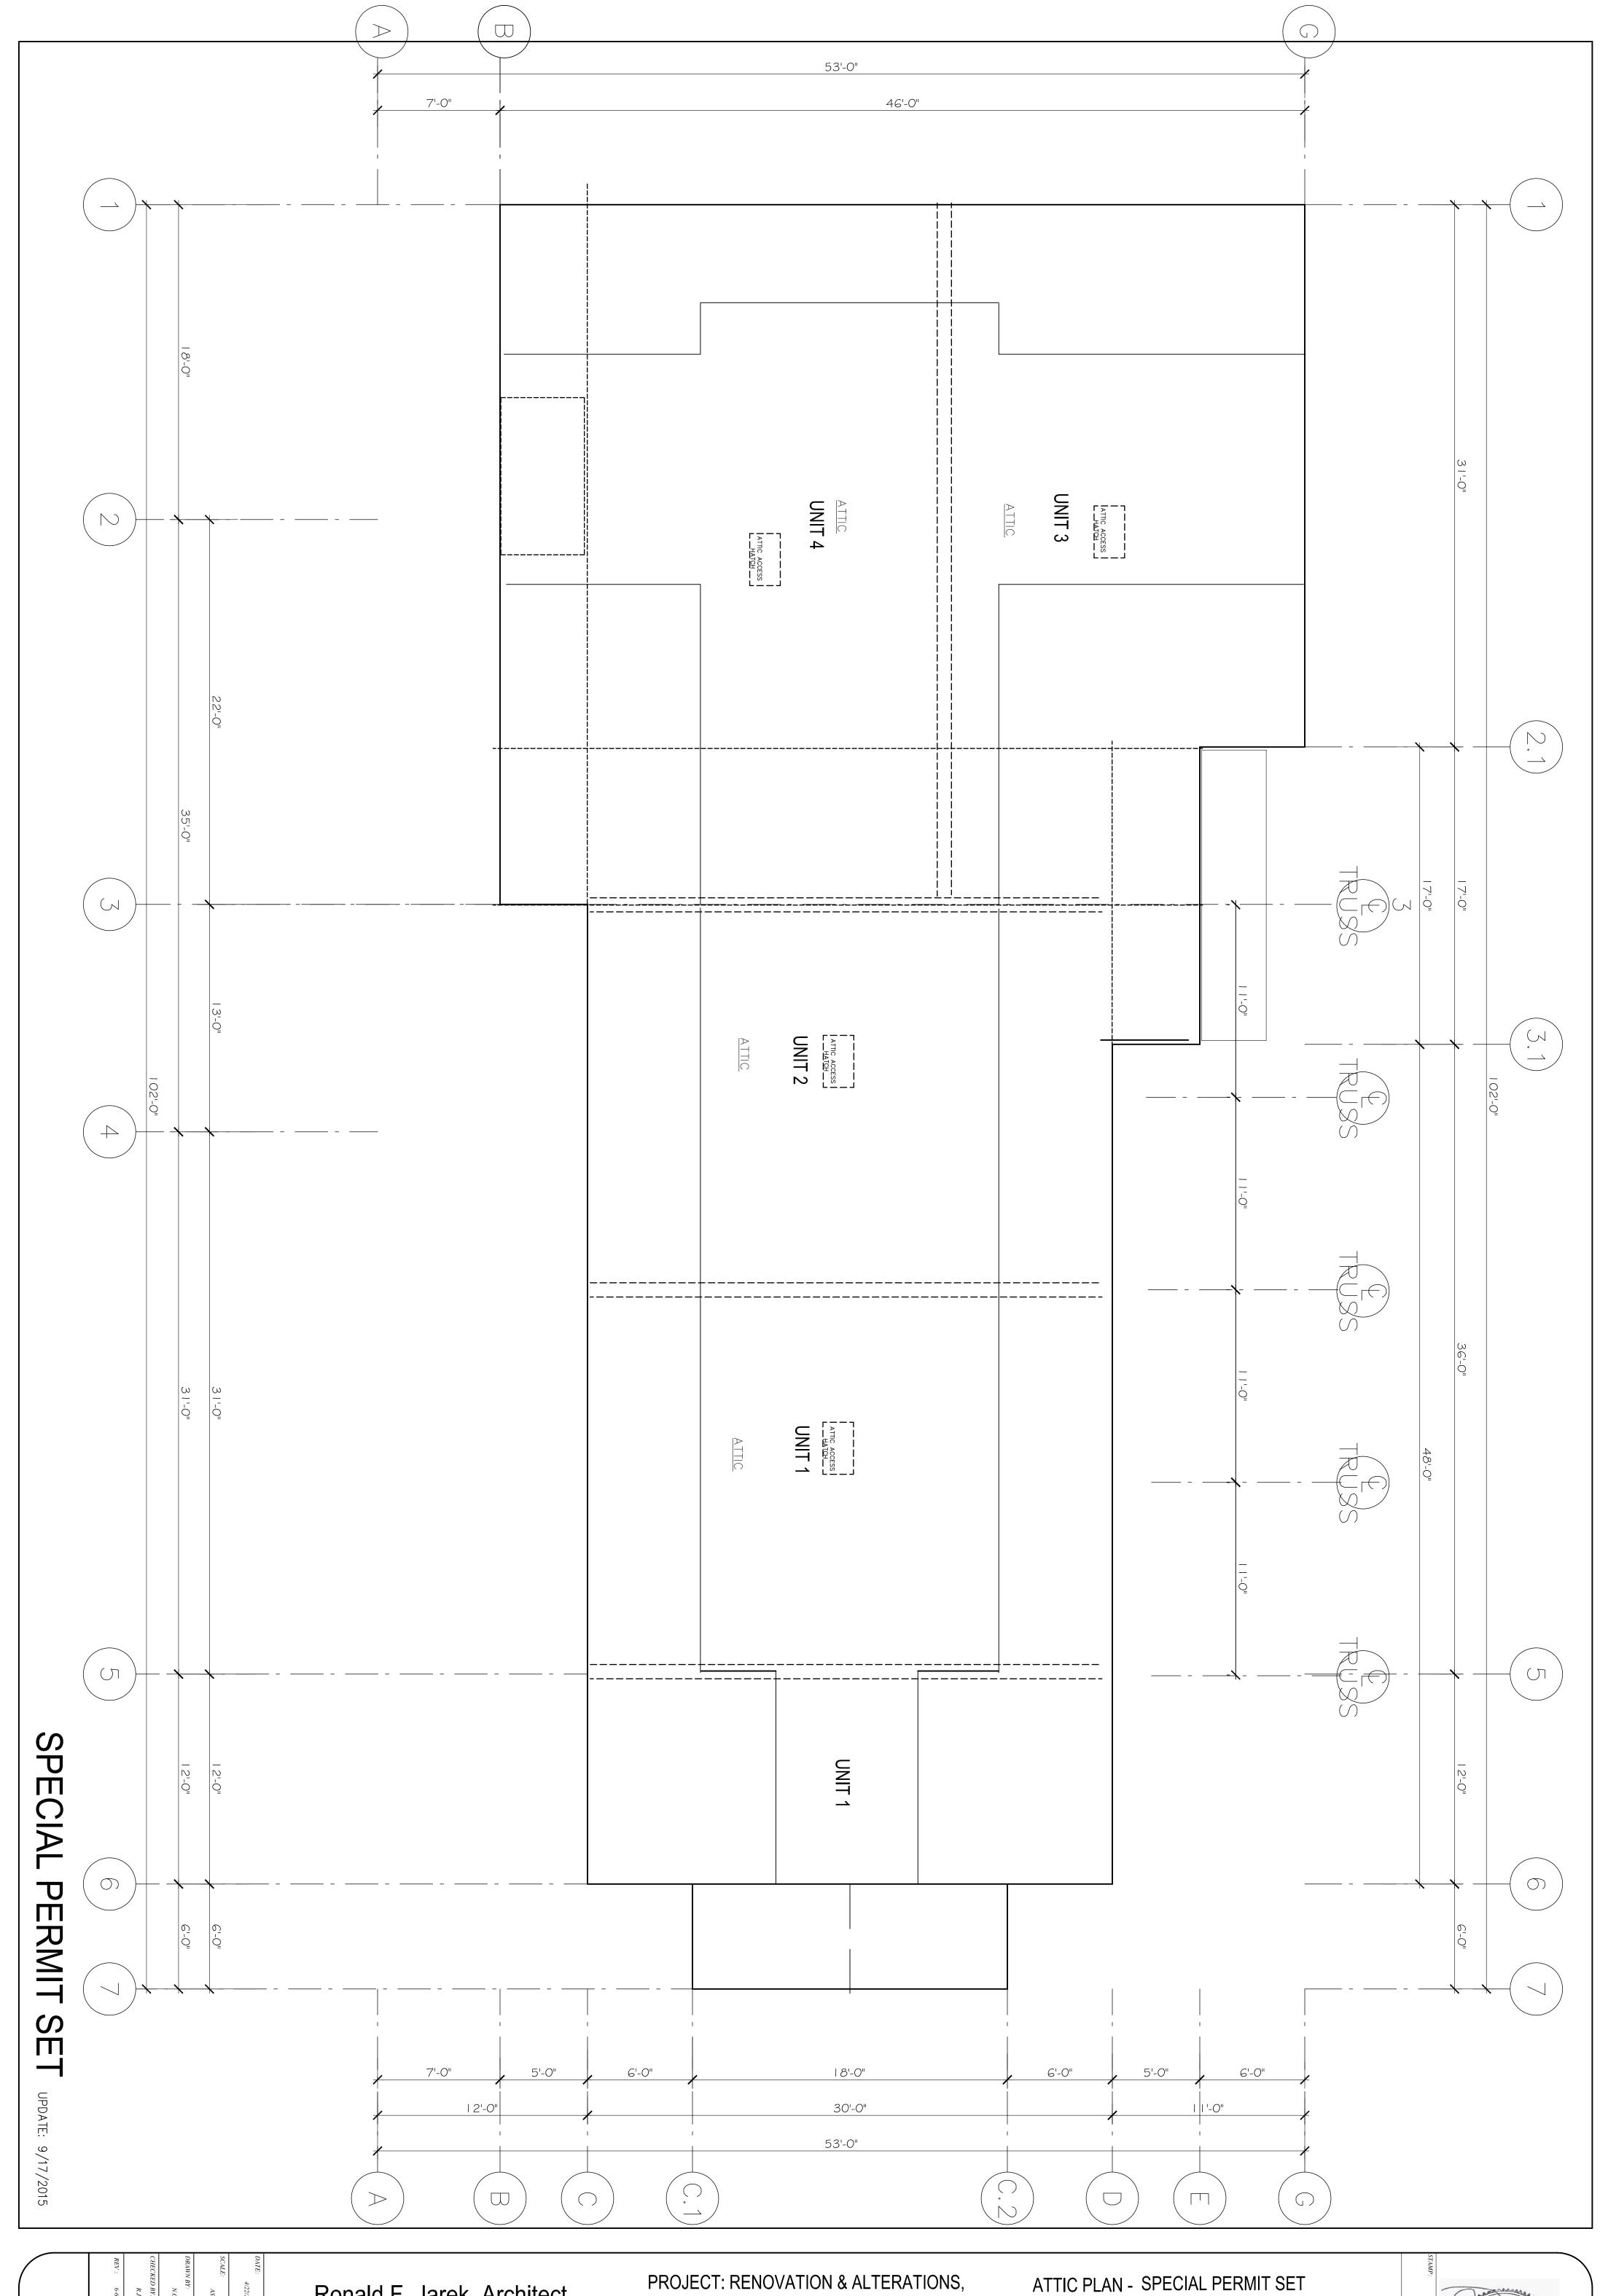



A-5

Ronald F. Jarek, Architect 487 Watertown Street Newtonville, MA 02460

15 SOUTH GATE PARK, WEST NEWTON, MA 02465

CLIENT: 15 SOUTH GATE PARK WEST NEWTON, MA 02465

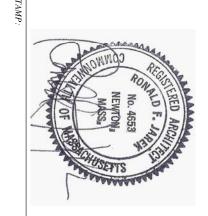

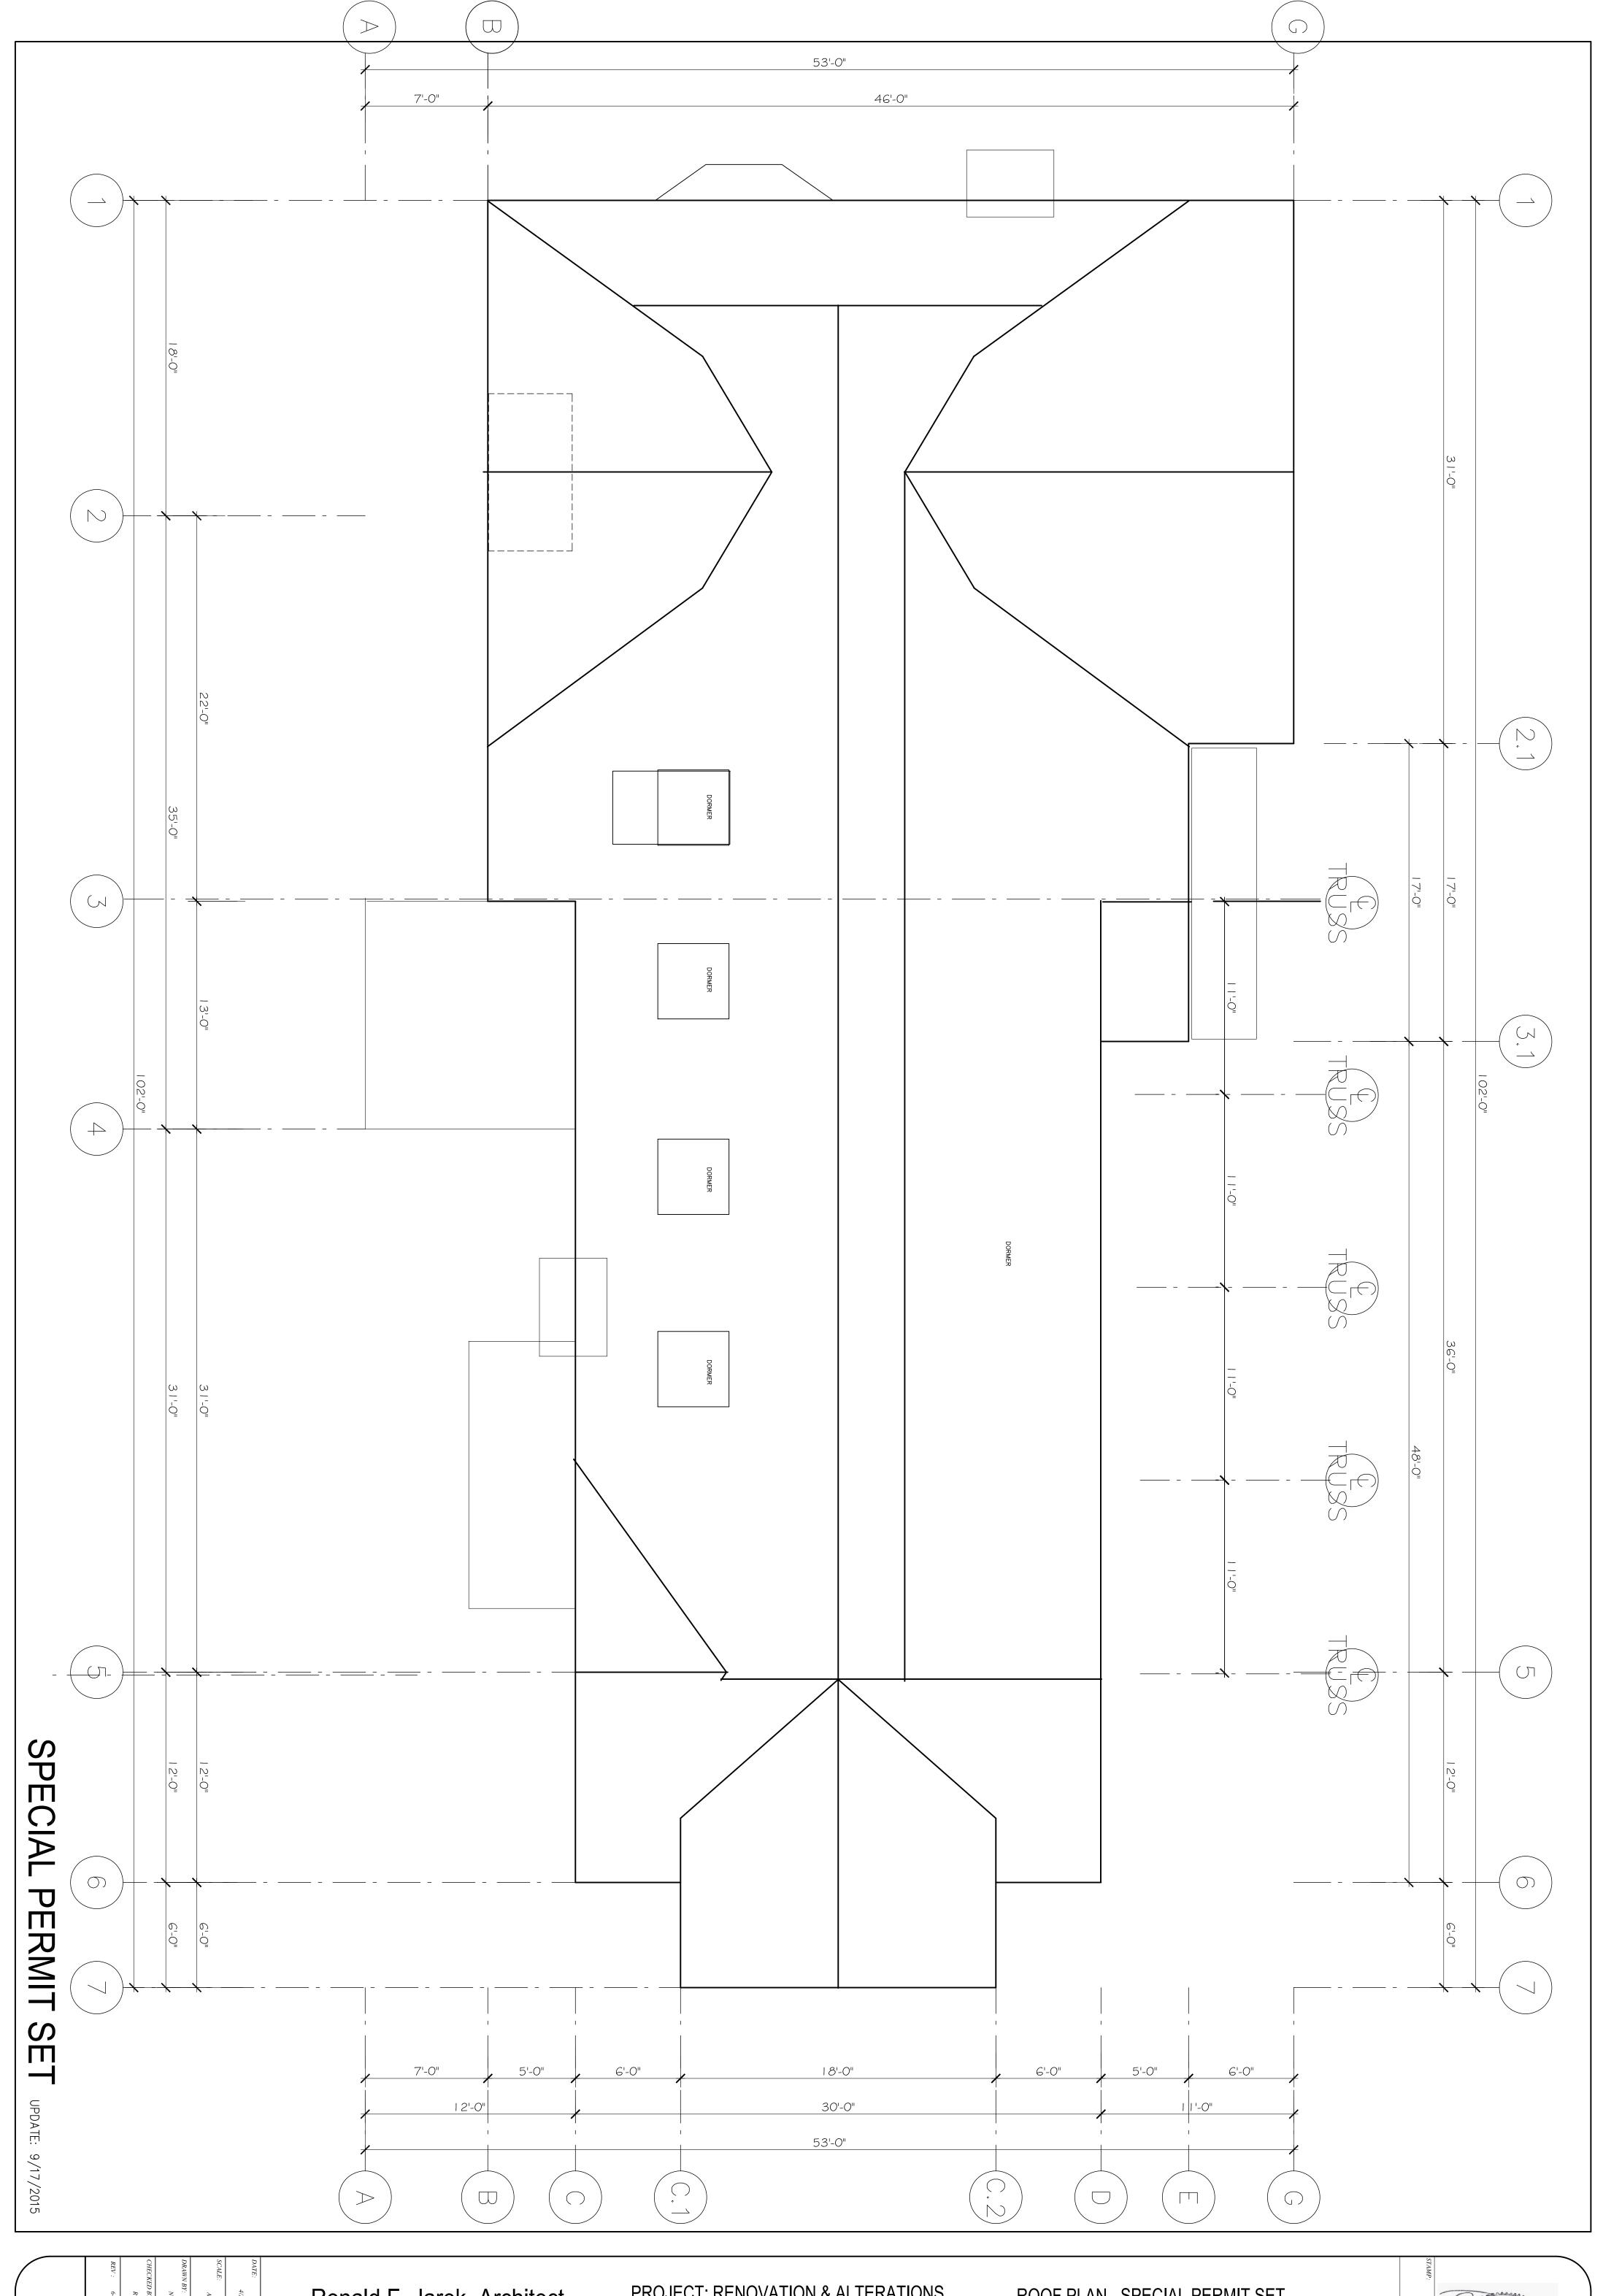

DATE:
4/22/2015

SCALE:
AS NOTED


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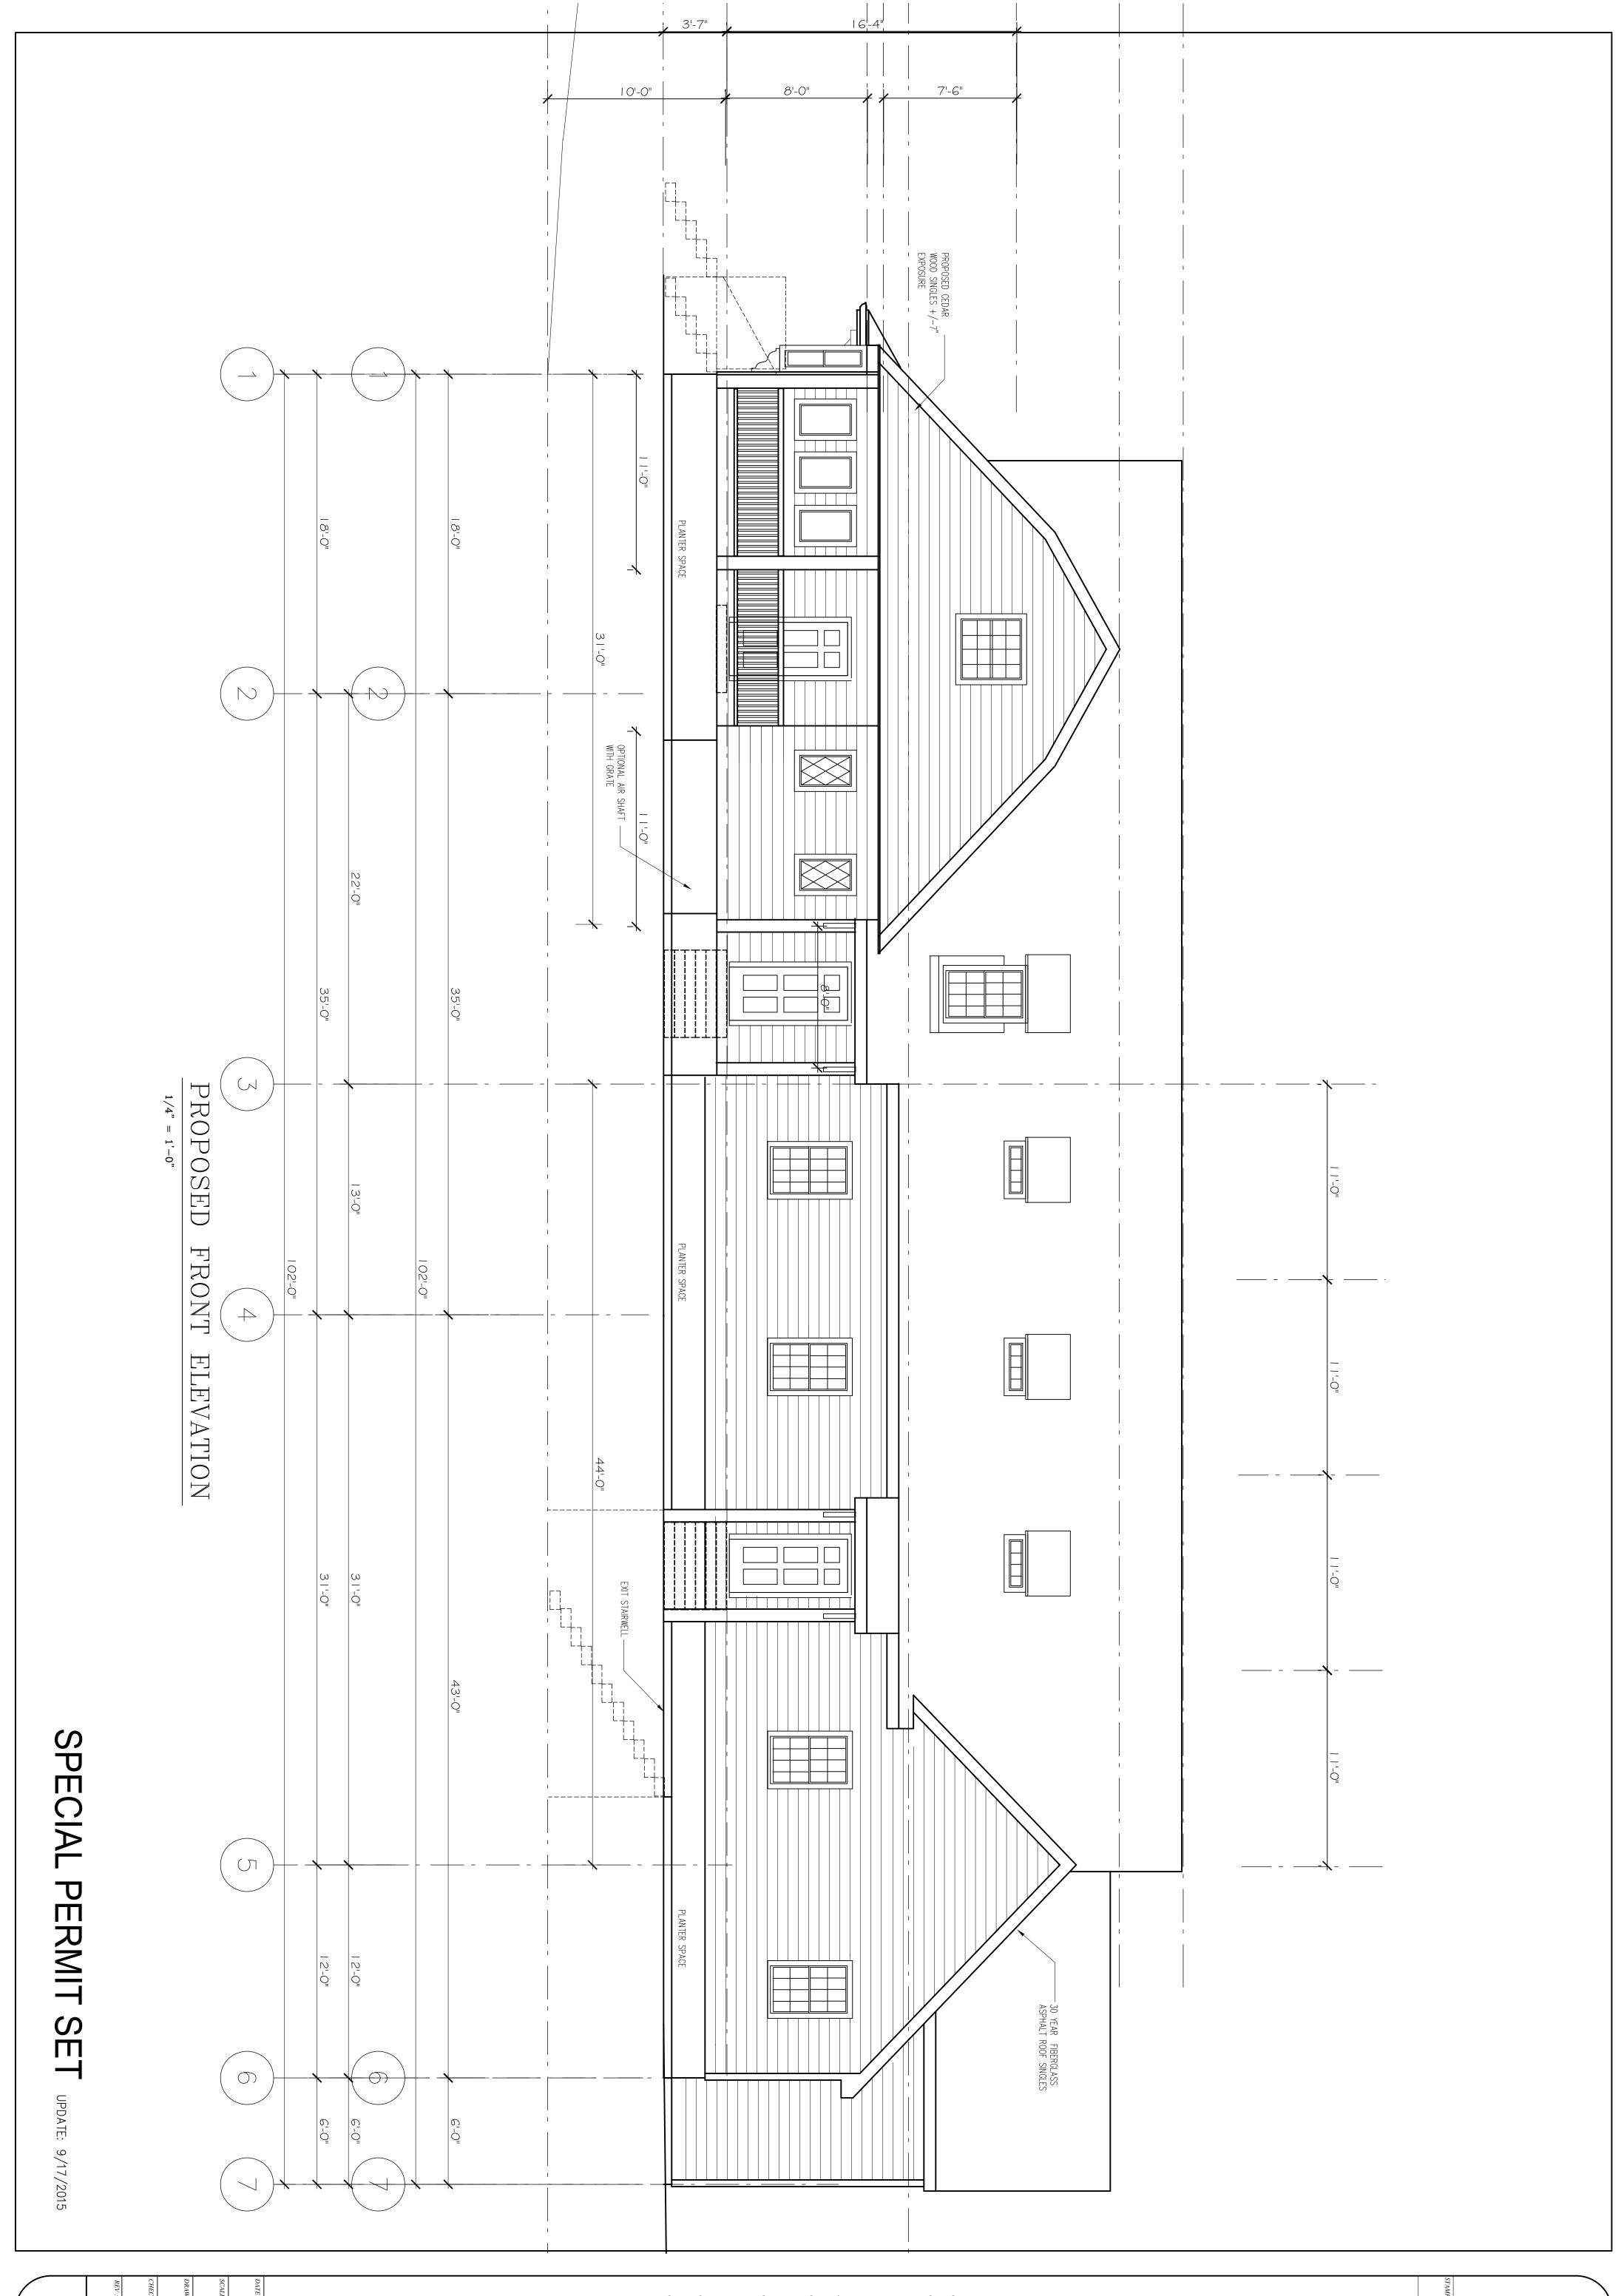
CHECKED BY:
R.J

REV: 6-6-2014

Ronald F. Jarek, Architect 487 Watertown Street Newtonville, MA 02460 PROJECT: RENOVATION & ALTERATIONS, 15 SOUTH GATE PARK, WEST NEWTON, MA 02465

CLIENT: 15 SOUTH GATE PARK WEST NEWTON, MA 02465 ROOF PLAN - SPECIAL PERMIT SET



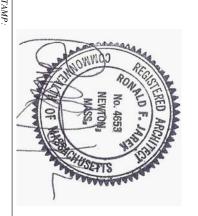

DATE: NOV. 24, 2014

SCALE: AS NOTED

DRAWN BY: N.G.H


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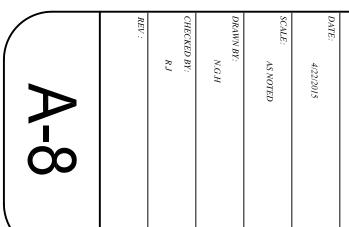
REV:

Ronald F. Jarek, Architect 487 Watertown Street Newtonville, MA 02460 PROJECT: RENOVATION & ALTERATIONS, 15 SOUTH GATE PARK, WEST NEWTON, MA 02465

CLIENT: 15 SOUTH GATE PARK WEST NEWTON, MA 02465 FRONT ELEVATION - SPECIAL PERMIT SET





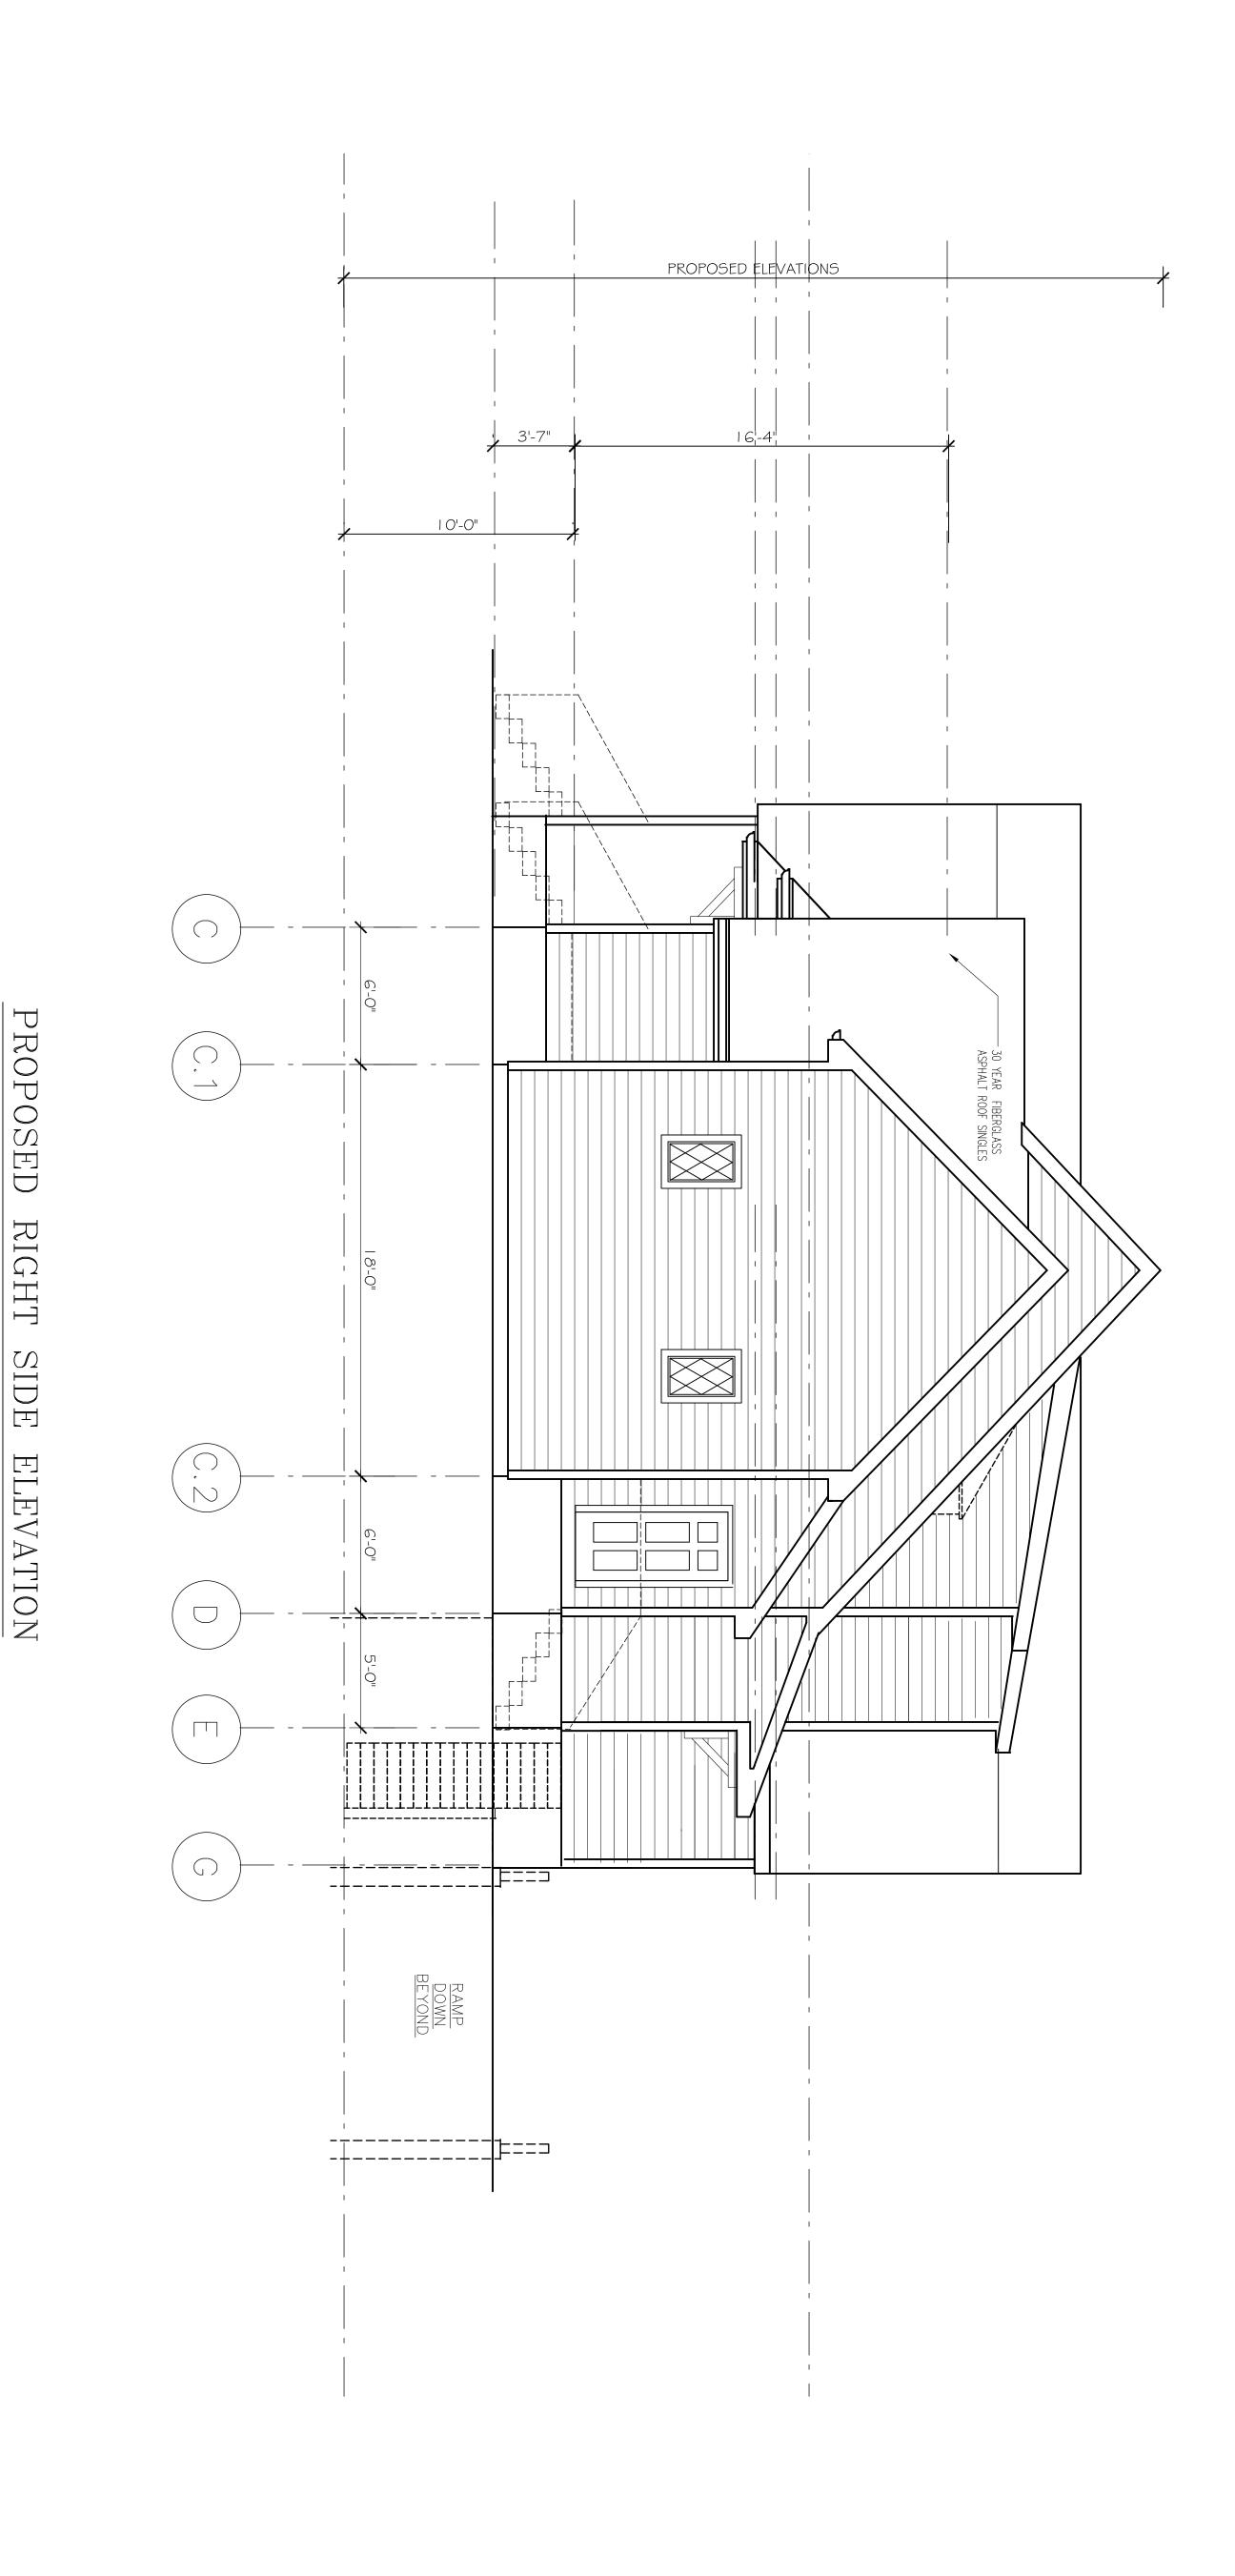

PROJECT: RENOVATION & ALTERATIONS, 15 SOUTH GATE PARK, WEST NEWTON, MA 02465

CLIENT: 15 SOUTH GATE PARK WEST NEWTON, MA 02465 RIGHT ELEVATION - SPECIAL PERMIT SET

AIE:

4/22/2015

CALE:

AS NOTED

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N.G.H


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R.J

LEV:

Ronald F. Jarek, Architect 487 Watertown Street Newtonville, MA 02460 PROJECT: RENOVATION & ALTERATIONS, 15 SOUTH GATE PARK, WEST NEWTON, MA 02465

CLIENT: 15 SOUTH GATE PARK WEST NEWTON, MA 02465 LEFT ELEVATIONS - SPECIAL PERMIT SET

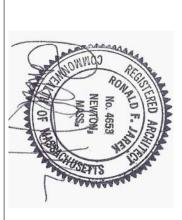

DATE: 4/22/2015

SCALE: AS NOTED

DRAWN BY: N.G.H


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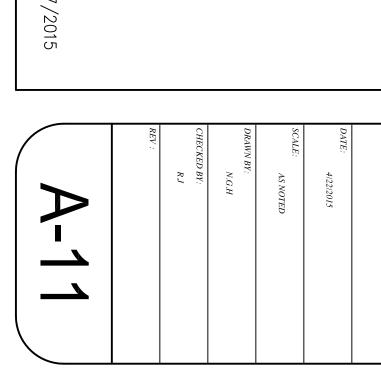
Ronald F. Jarek, Architect
487 Watertown Street
Newtonville, MA 02460

PROJECT: RENOVATION & ALTERATIONS, 15 SOUTH GATE PARK, WEST NEWTON, MA 02465

CLIENT: 15 SOUTH GATE PARK WEST NEWTON, MA 02465 REAR ELEVATION - SPECIAL PERMIT SET





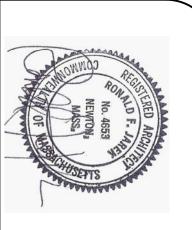


PROPOSED

RIGHT

SIDE


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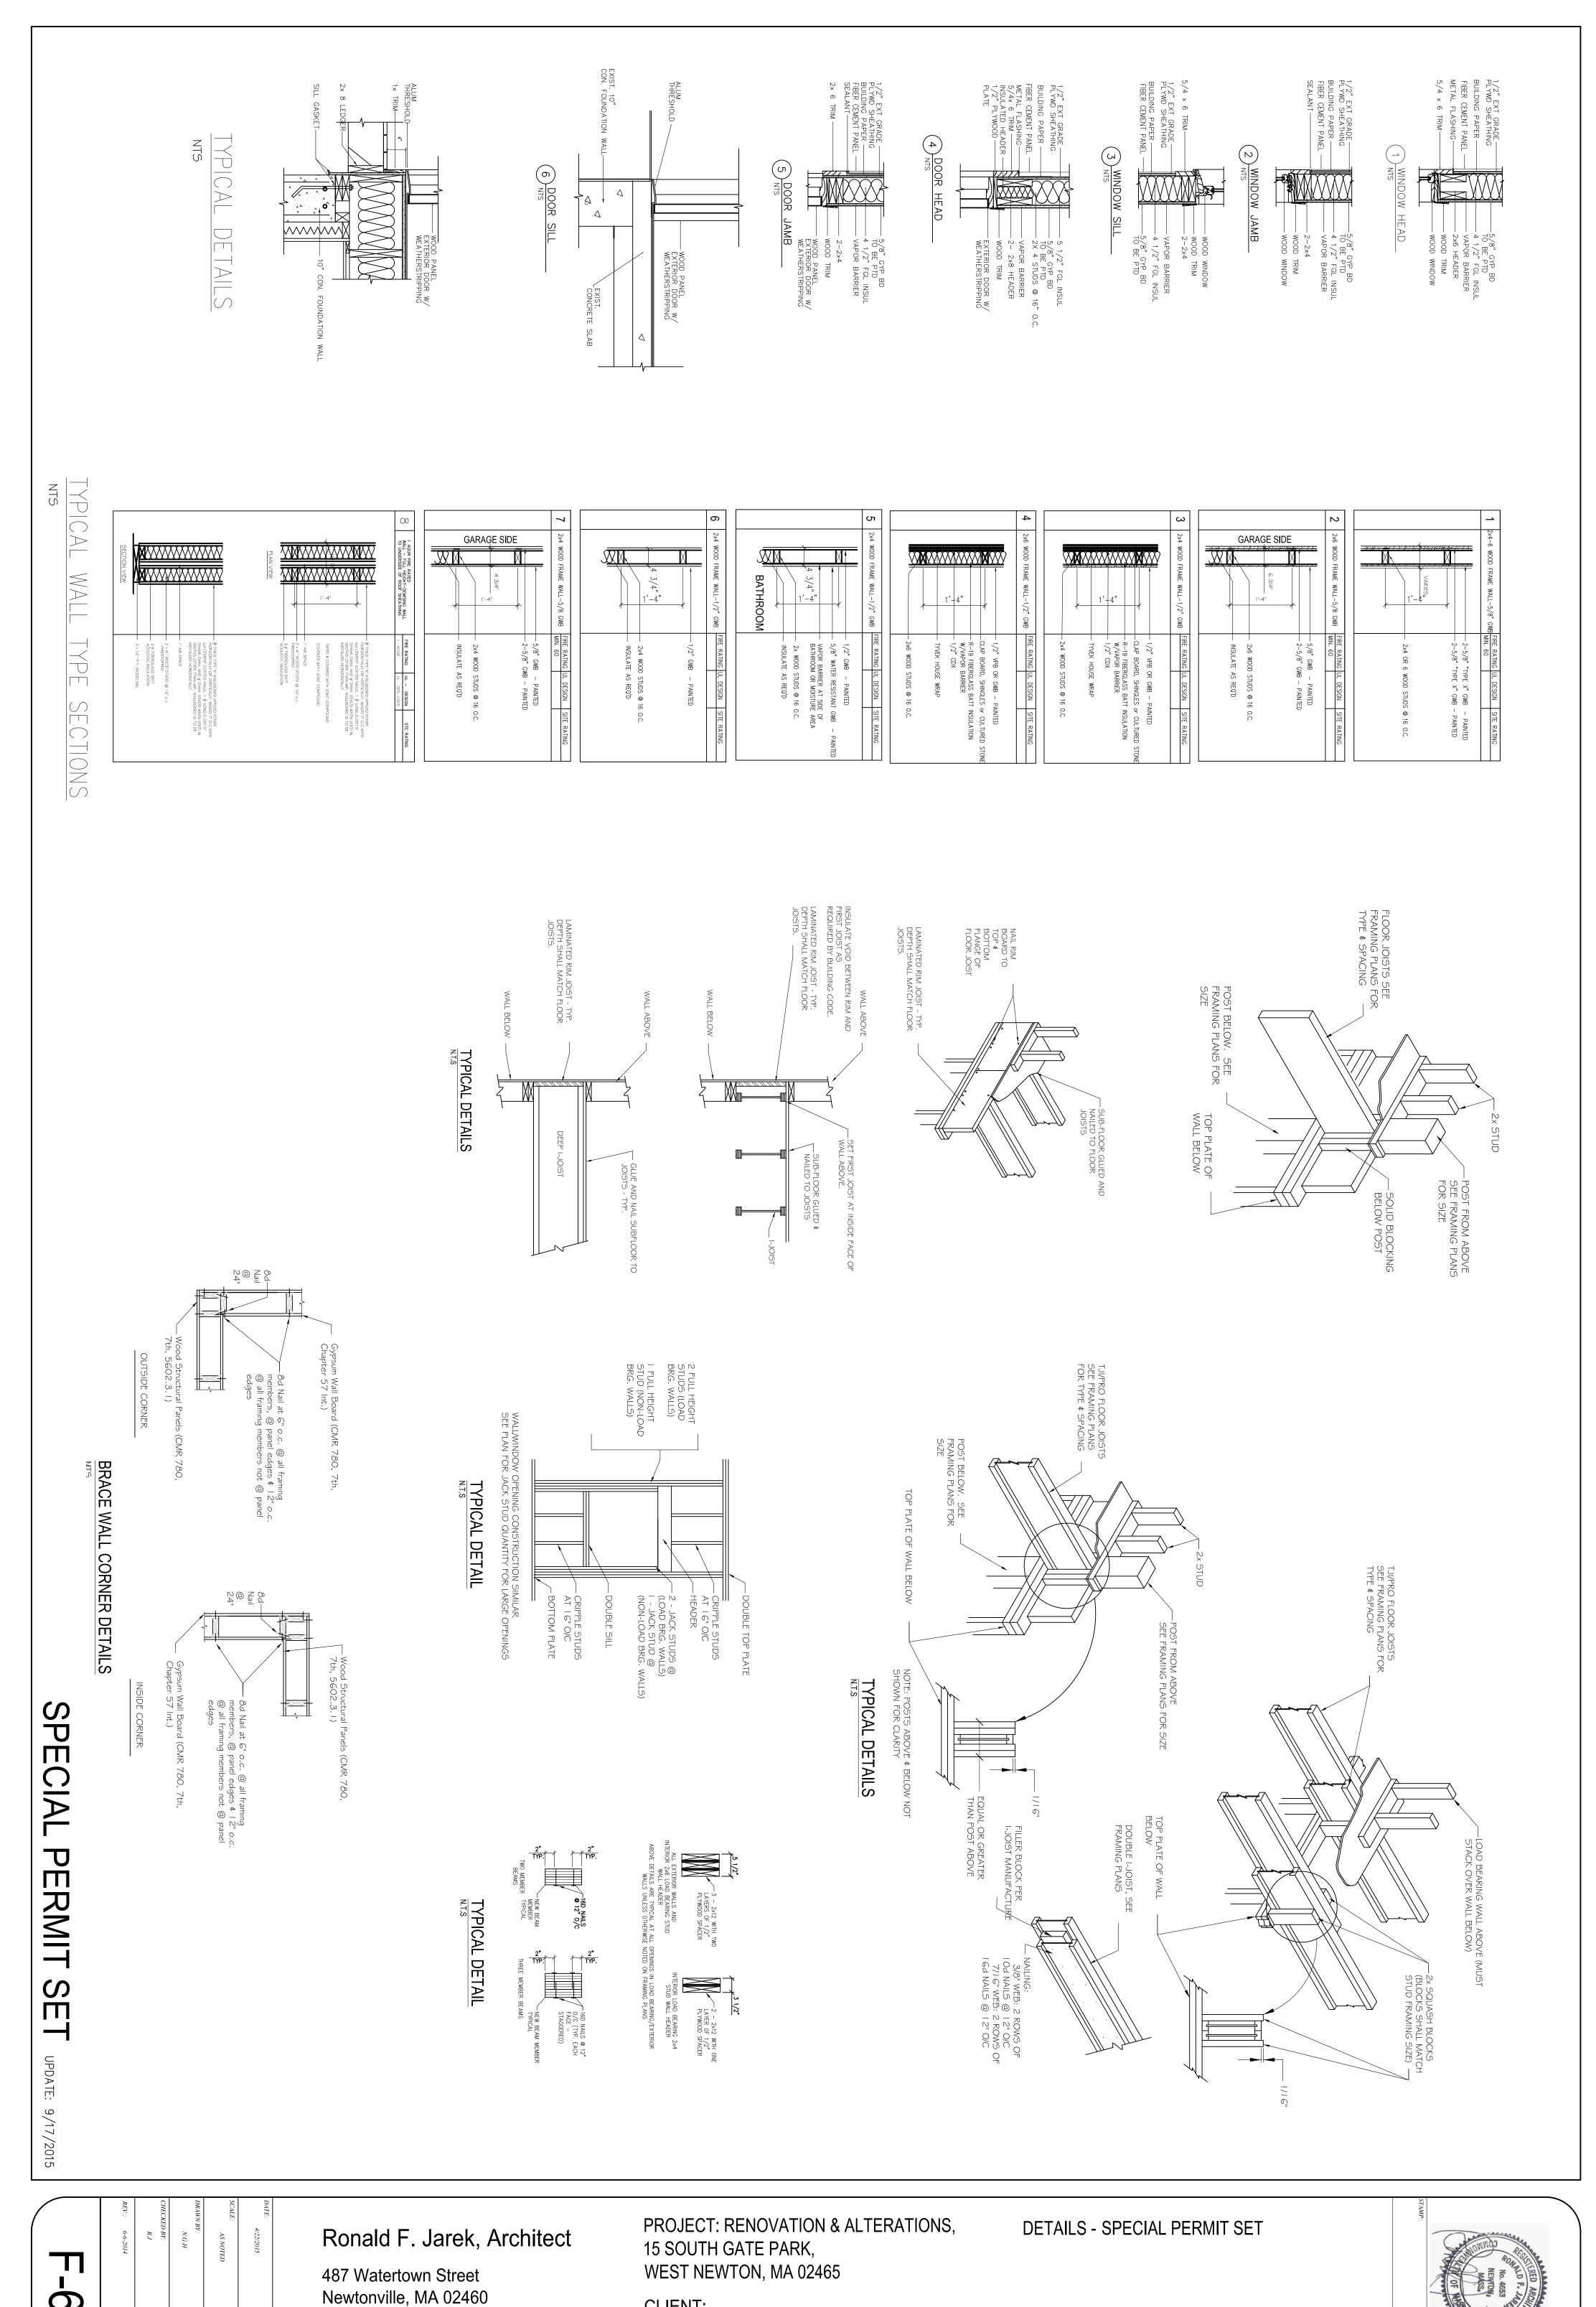
ELEVATION

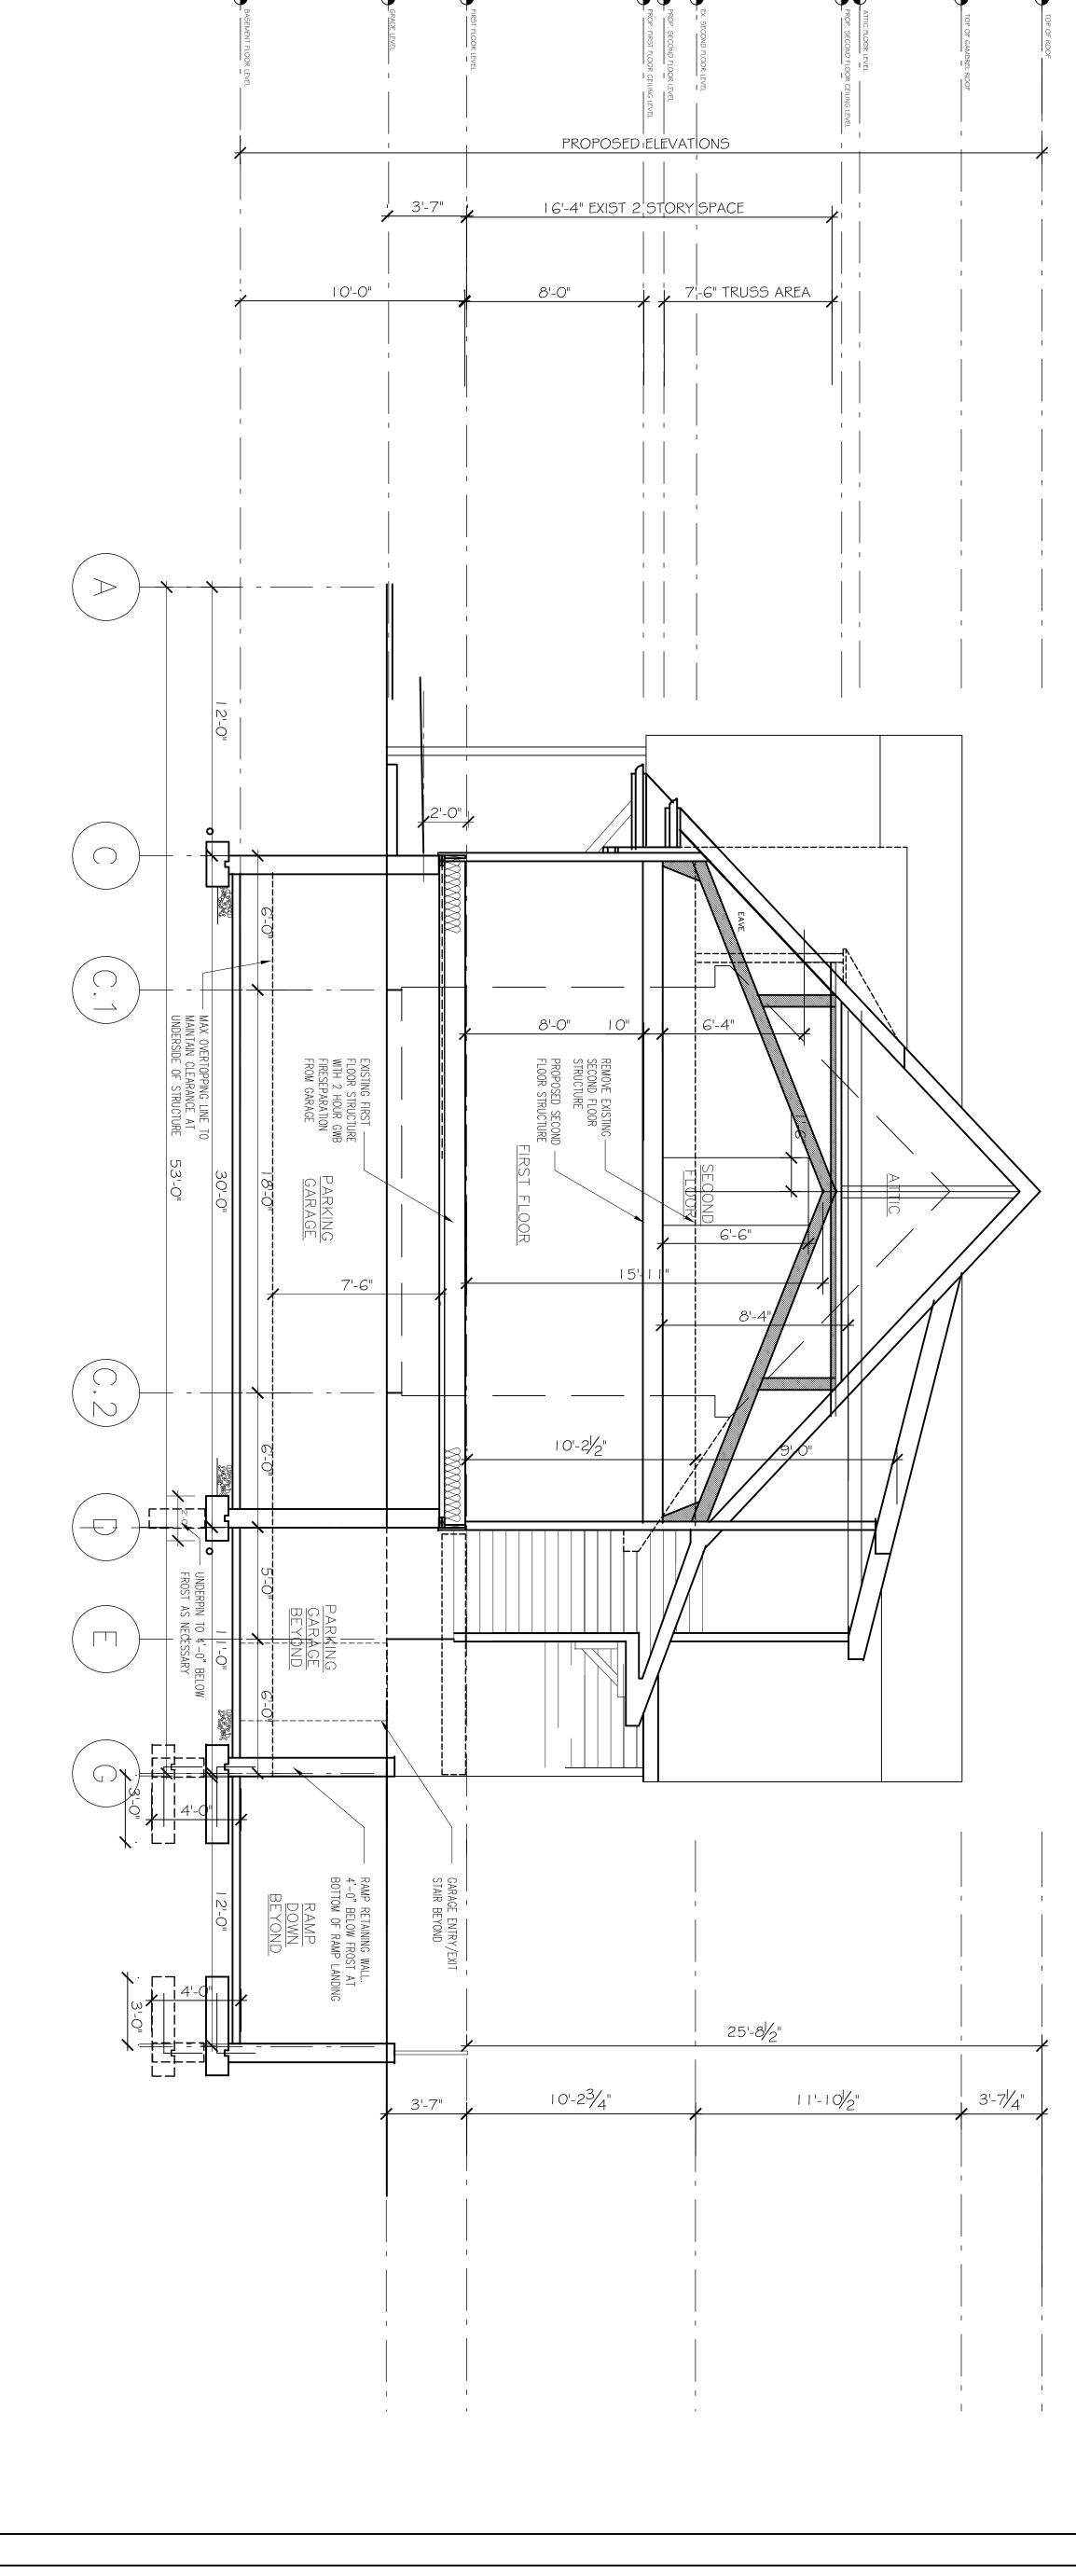

Ronald F. Jarek, Architect 487 Watertown Street Newtonville, MA 02460 PROJECT: RENOVATION & ALTERATIONS, 15 SOUTH GATE PARK, WEST NEWTON, MA 02465

CLIENT: 15 SOUTH GATE PARK WEST NEWTON, MA 02465 CROSS SECTION - SPECIAL PERMIT SET




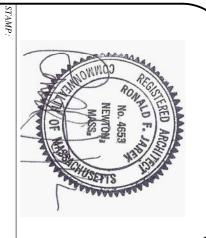


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CLIENT: 15 SOUTH GATE PARK WEST NEWTON, MA 02465







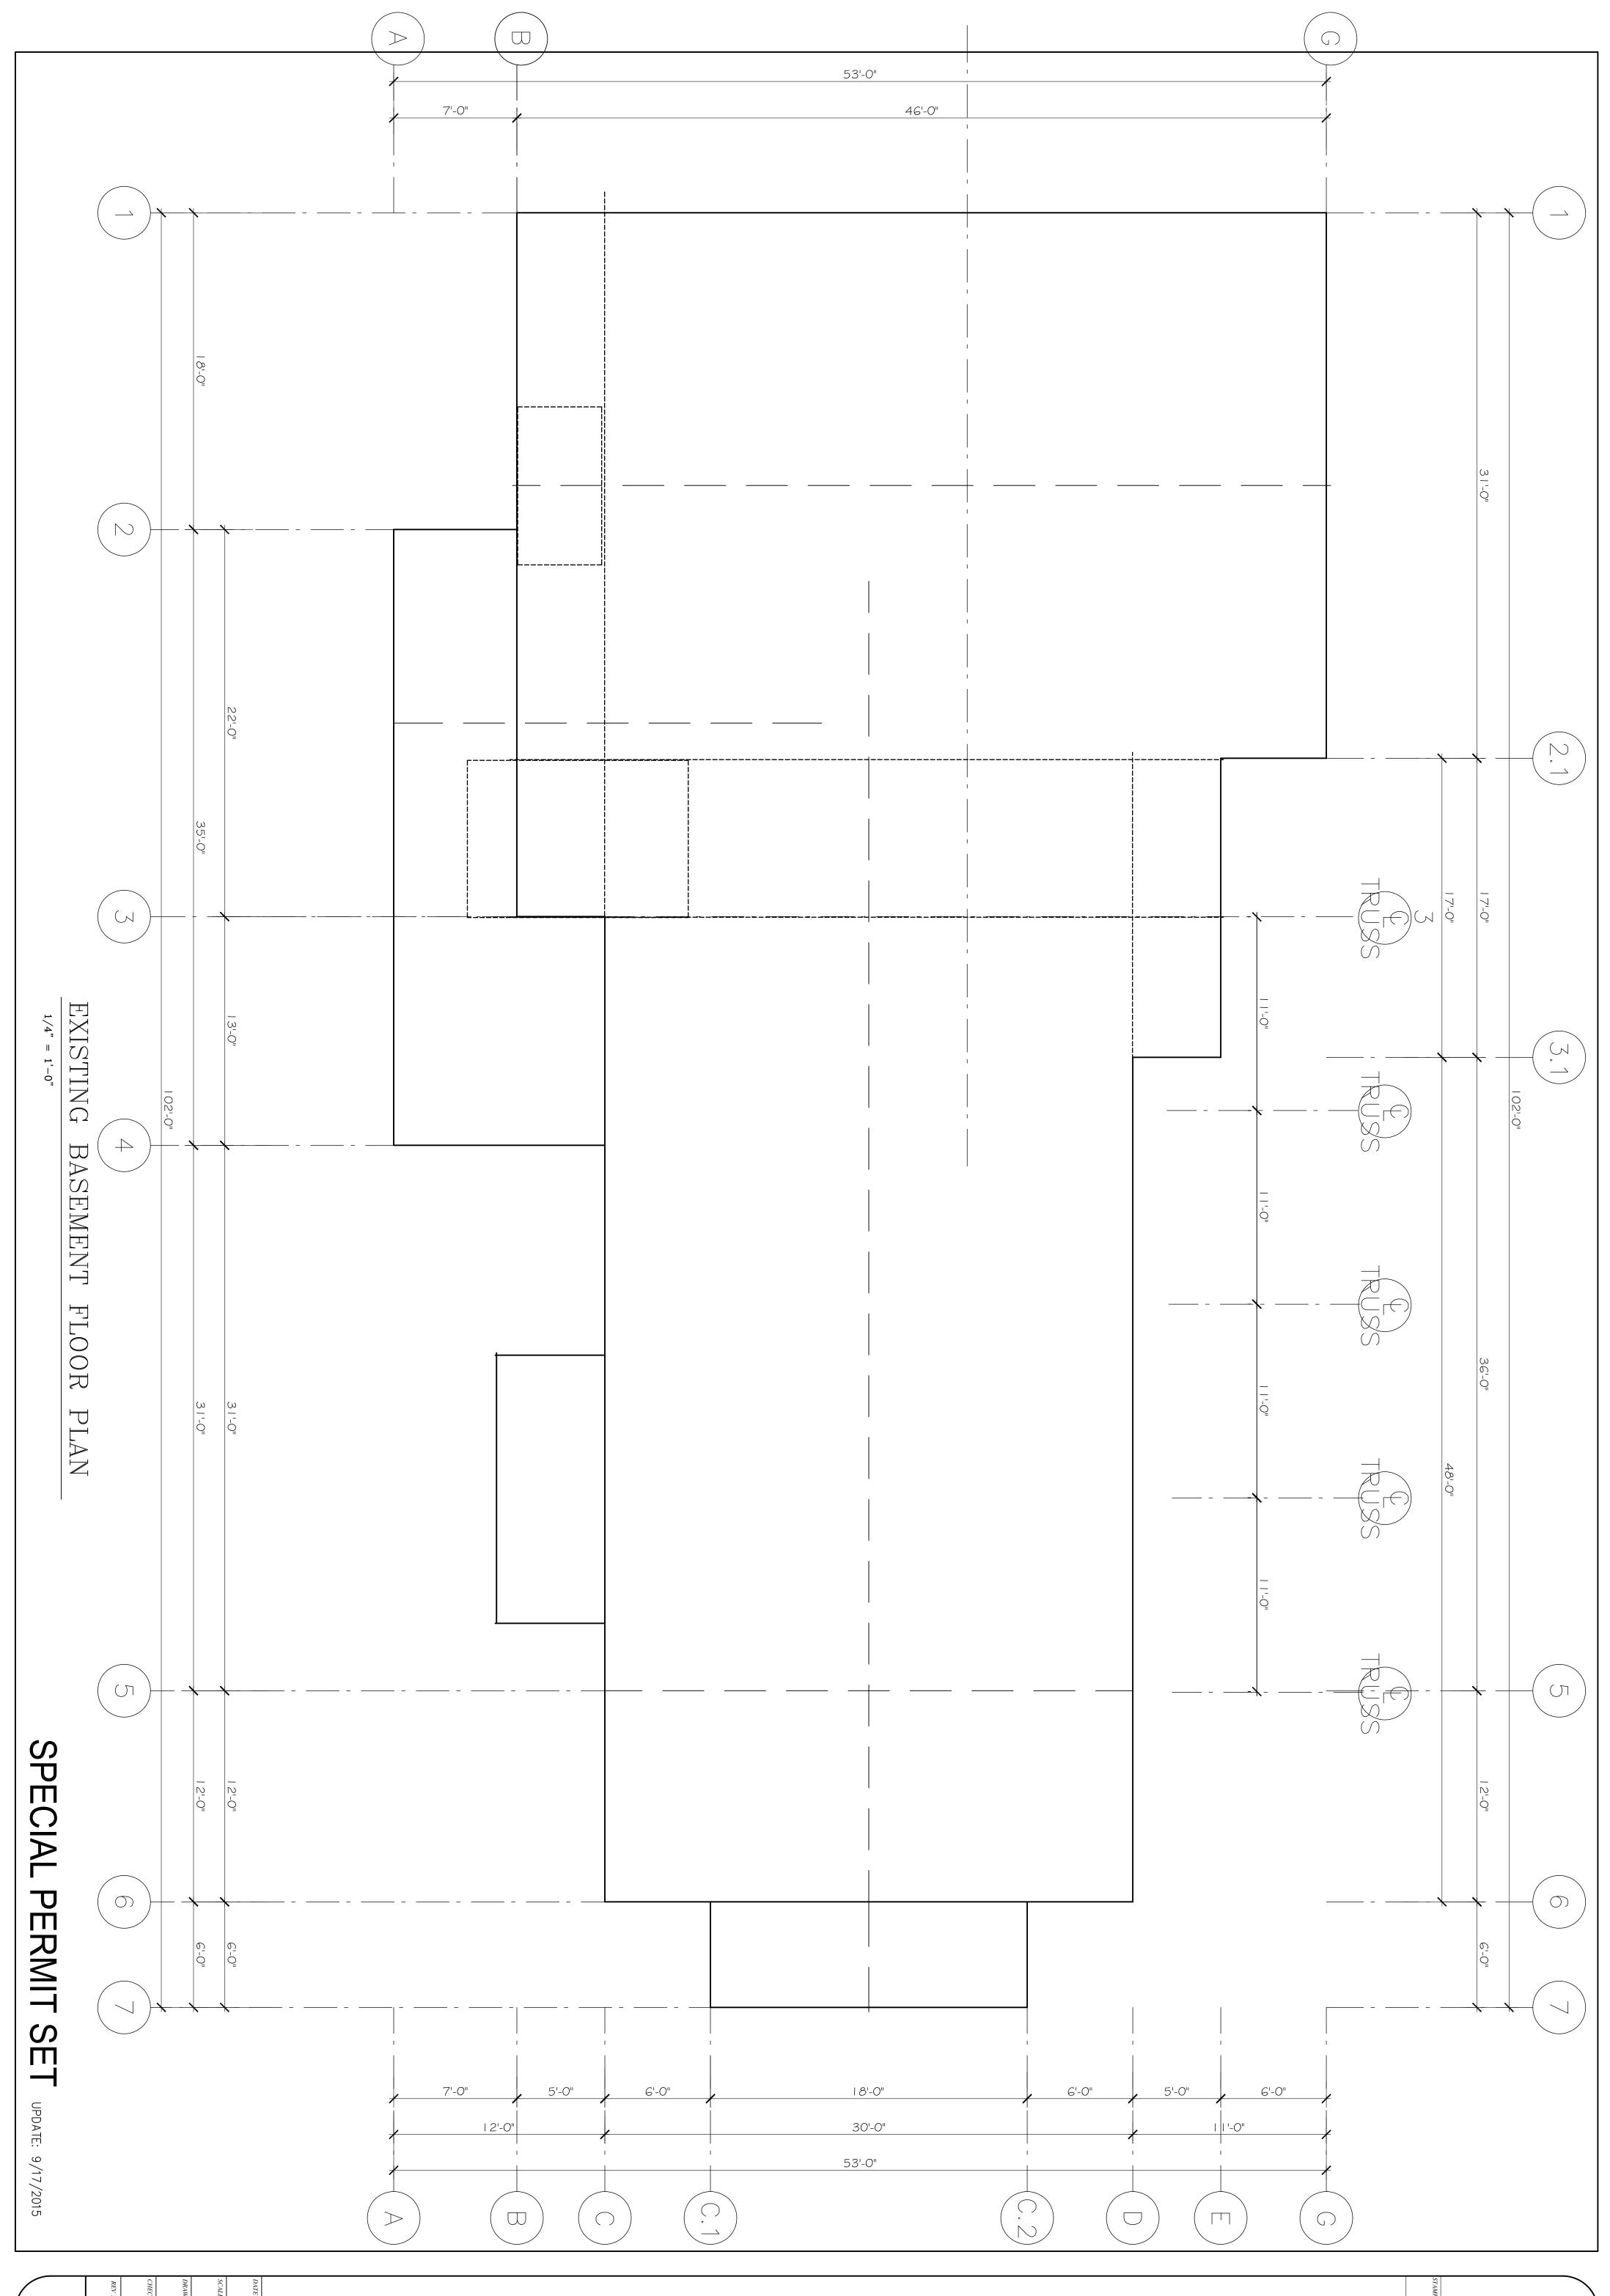


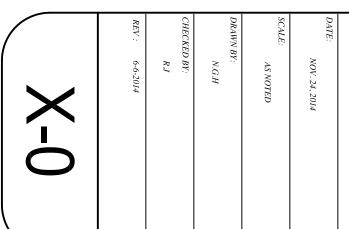PROJECT: RENOVATION & ALTERATIONS, 15 SOUTH GATE PARK, WEST NEWTON, MA 02465

CLIENT: 15 SOUTH GATE PARK WEST NEWTON, MA 02465 EXISTING BASEMENT PLAN - SPECIAL PERMIT SET FIRST FLOOR ABOVE SIMILAR

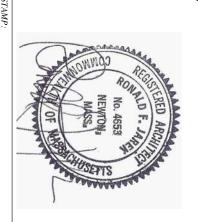


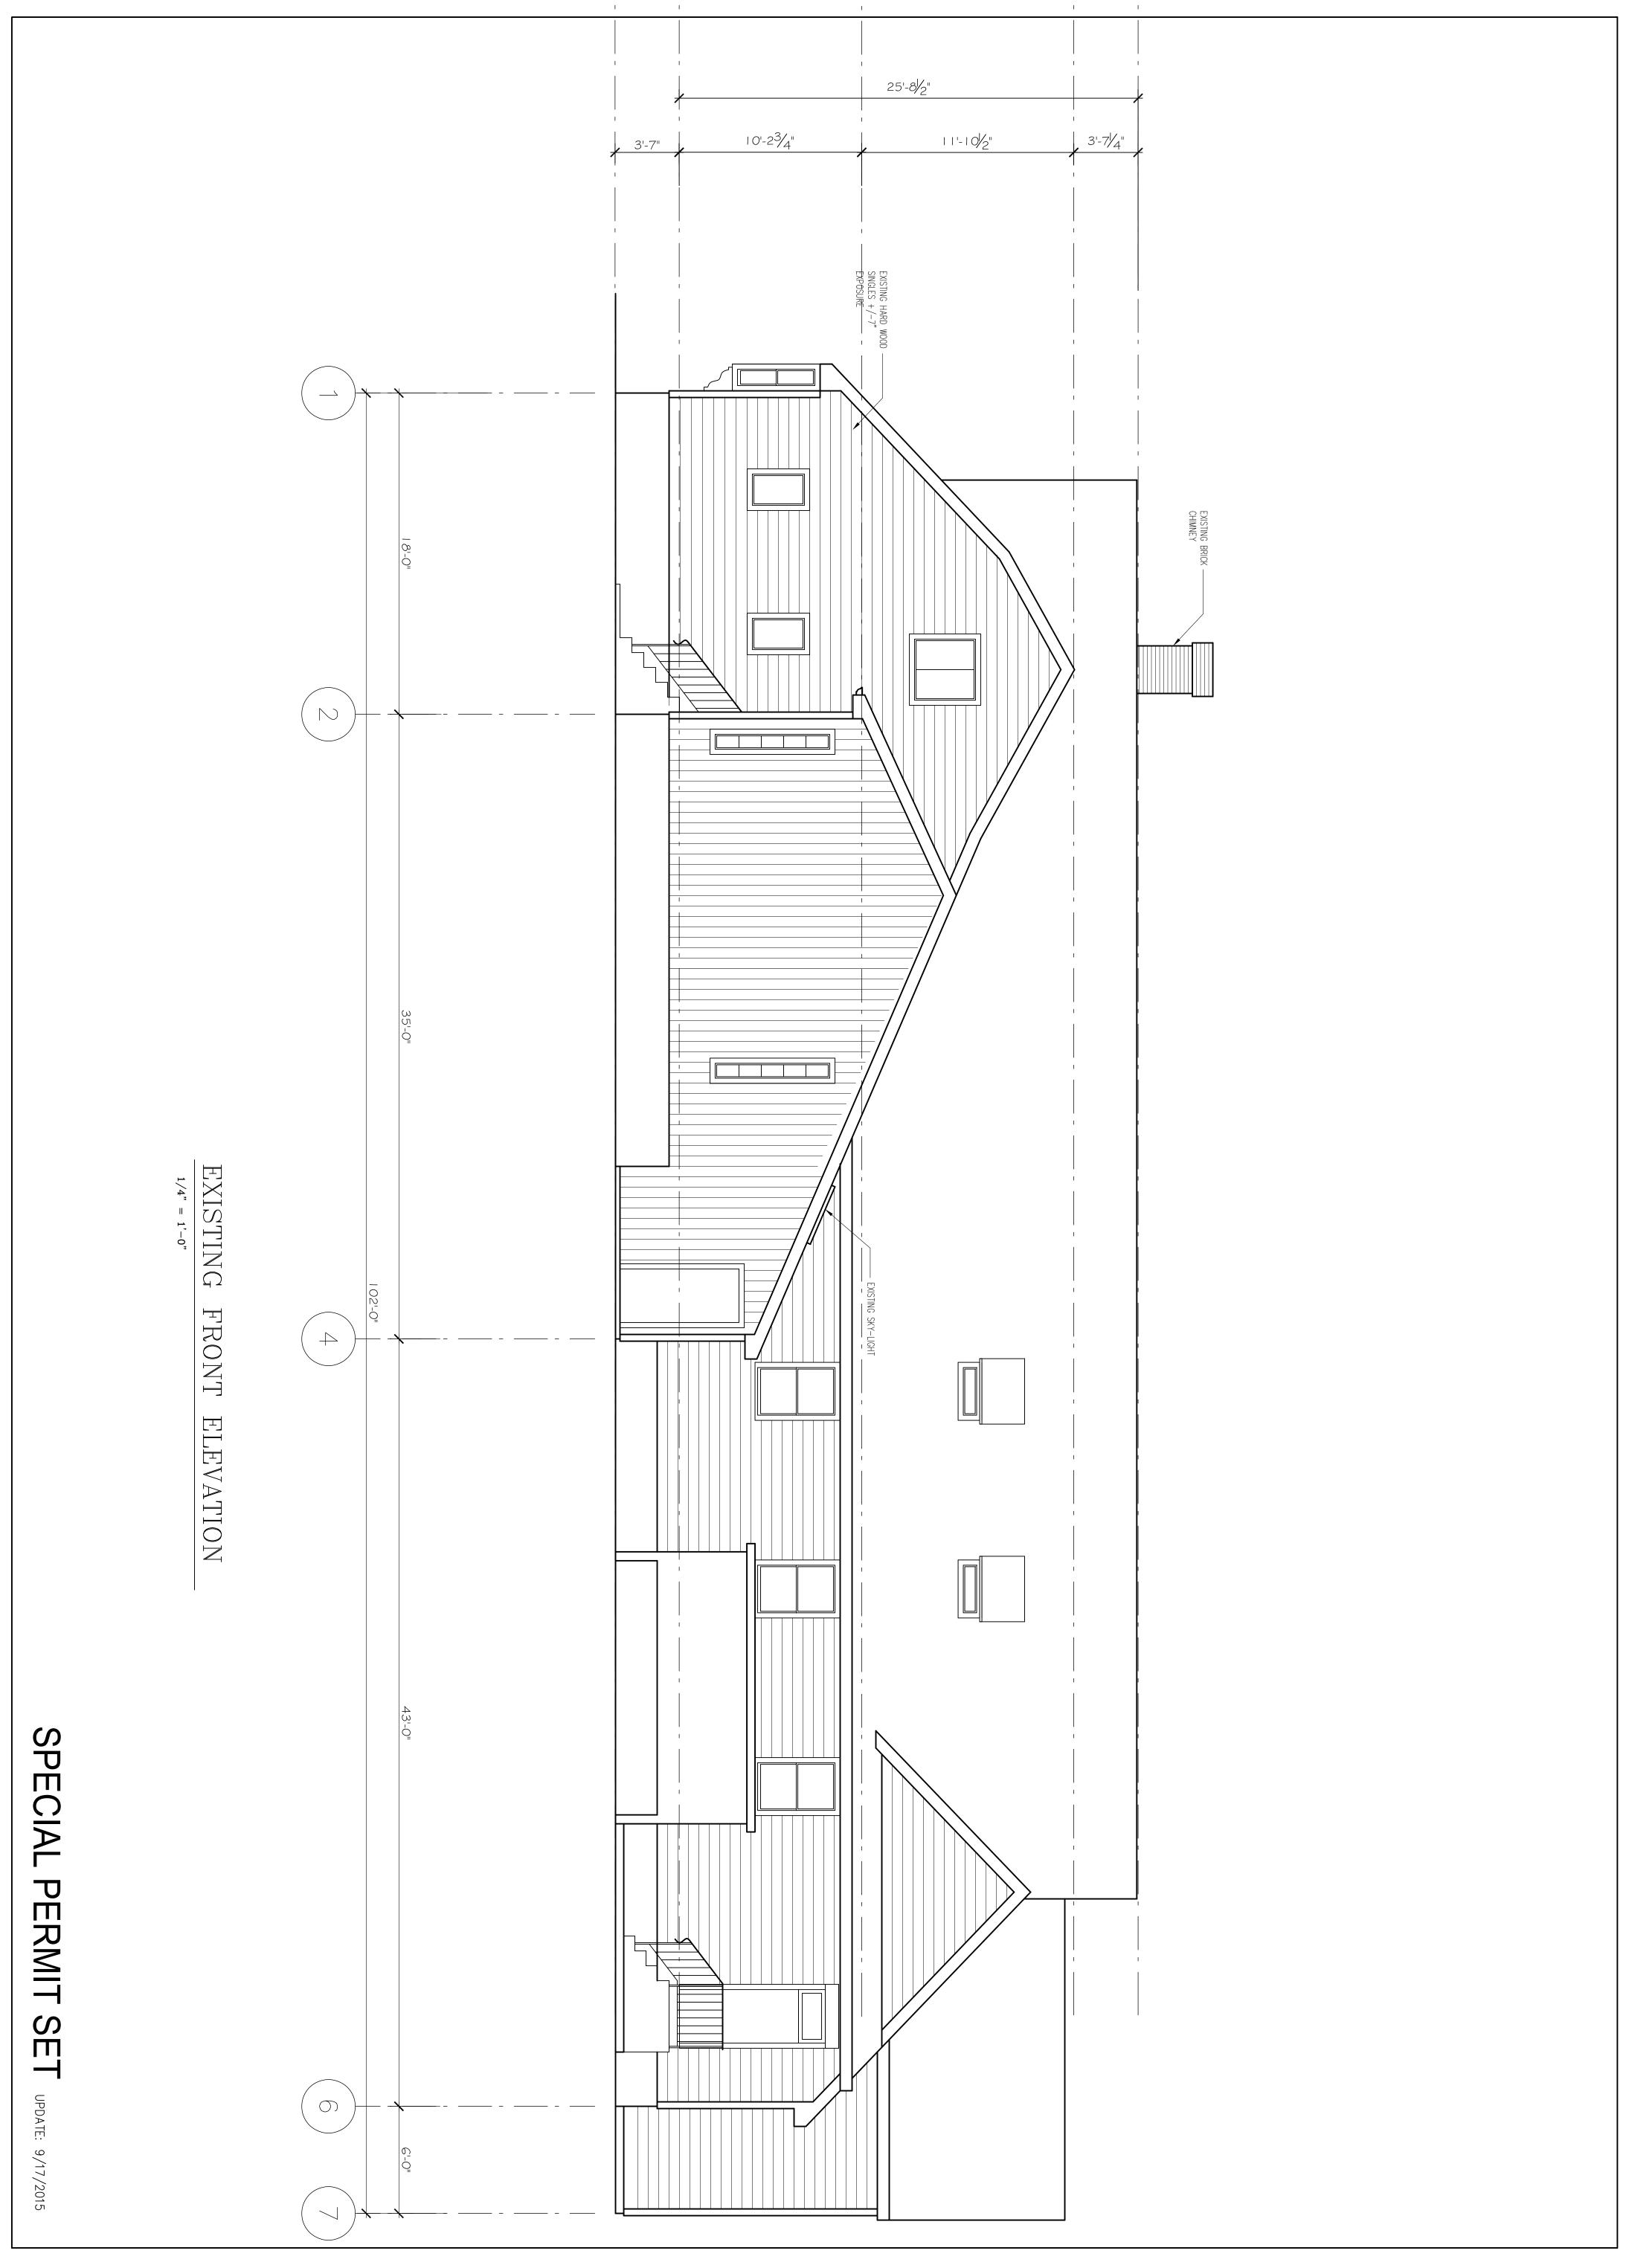

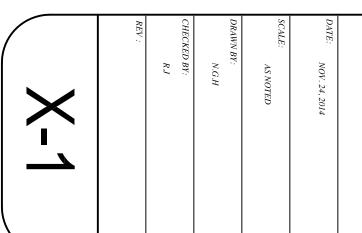



PROJECT: RENOVATION & ALTERATIONS, 15 SOUTH GATE PARK, WEST NEWTON, MA 02465

CLIENT: 15 SOUTH GATE PARK WEST NEWTON, MA 02465 EXISTING FRONT ELEVATION -SPECIAL PERMIT SET

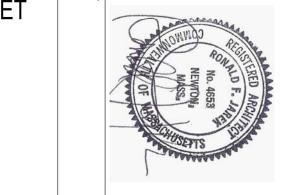




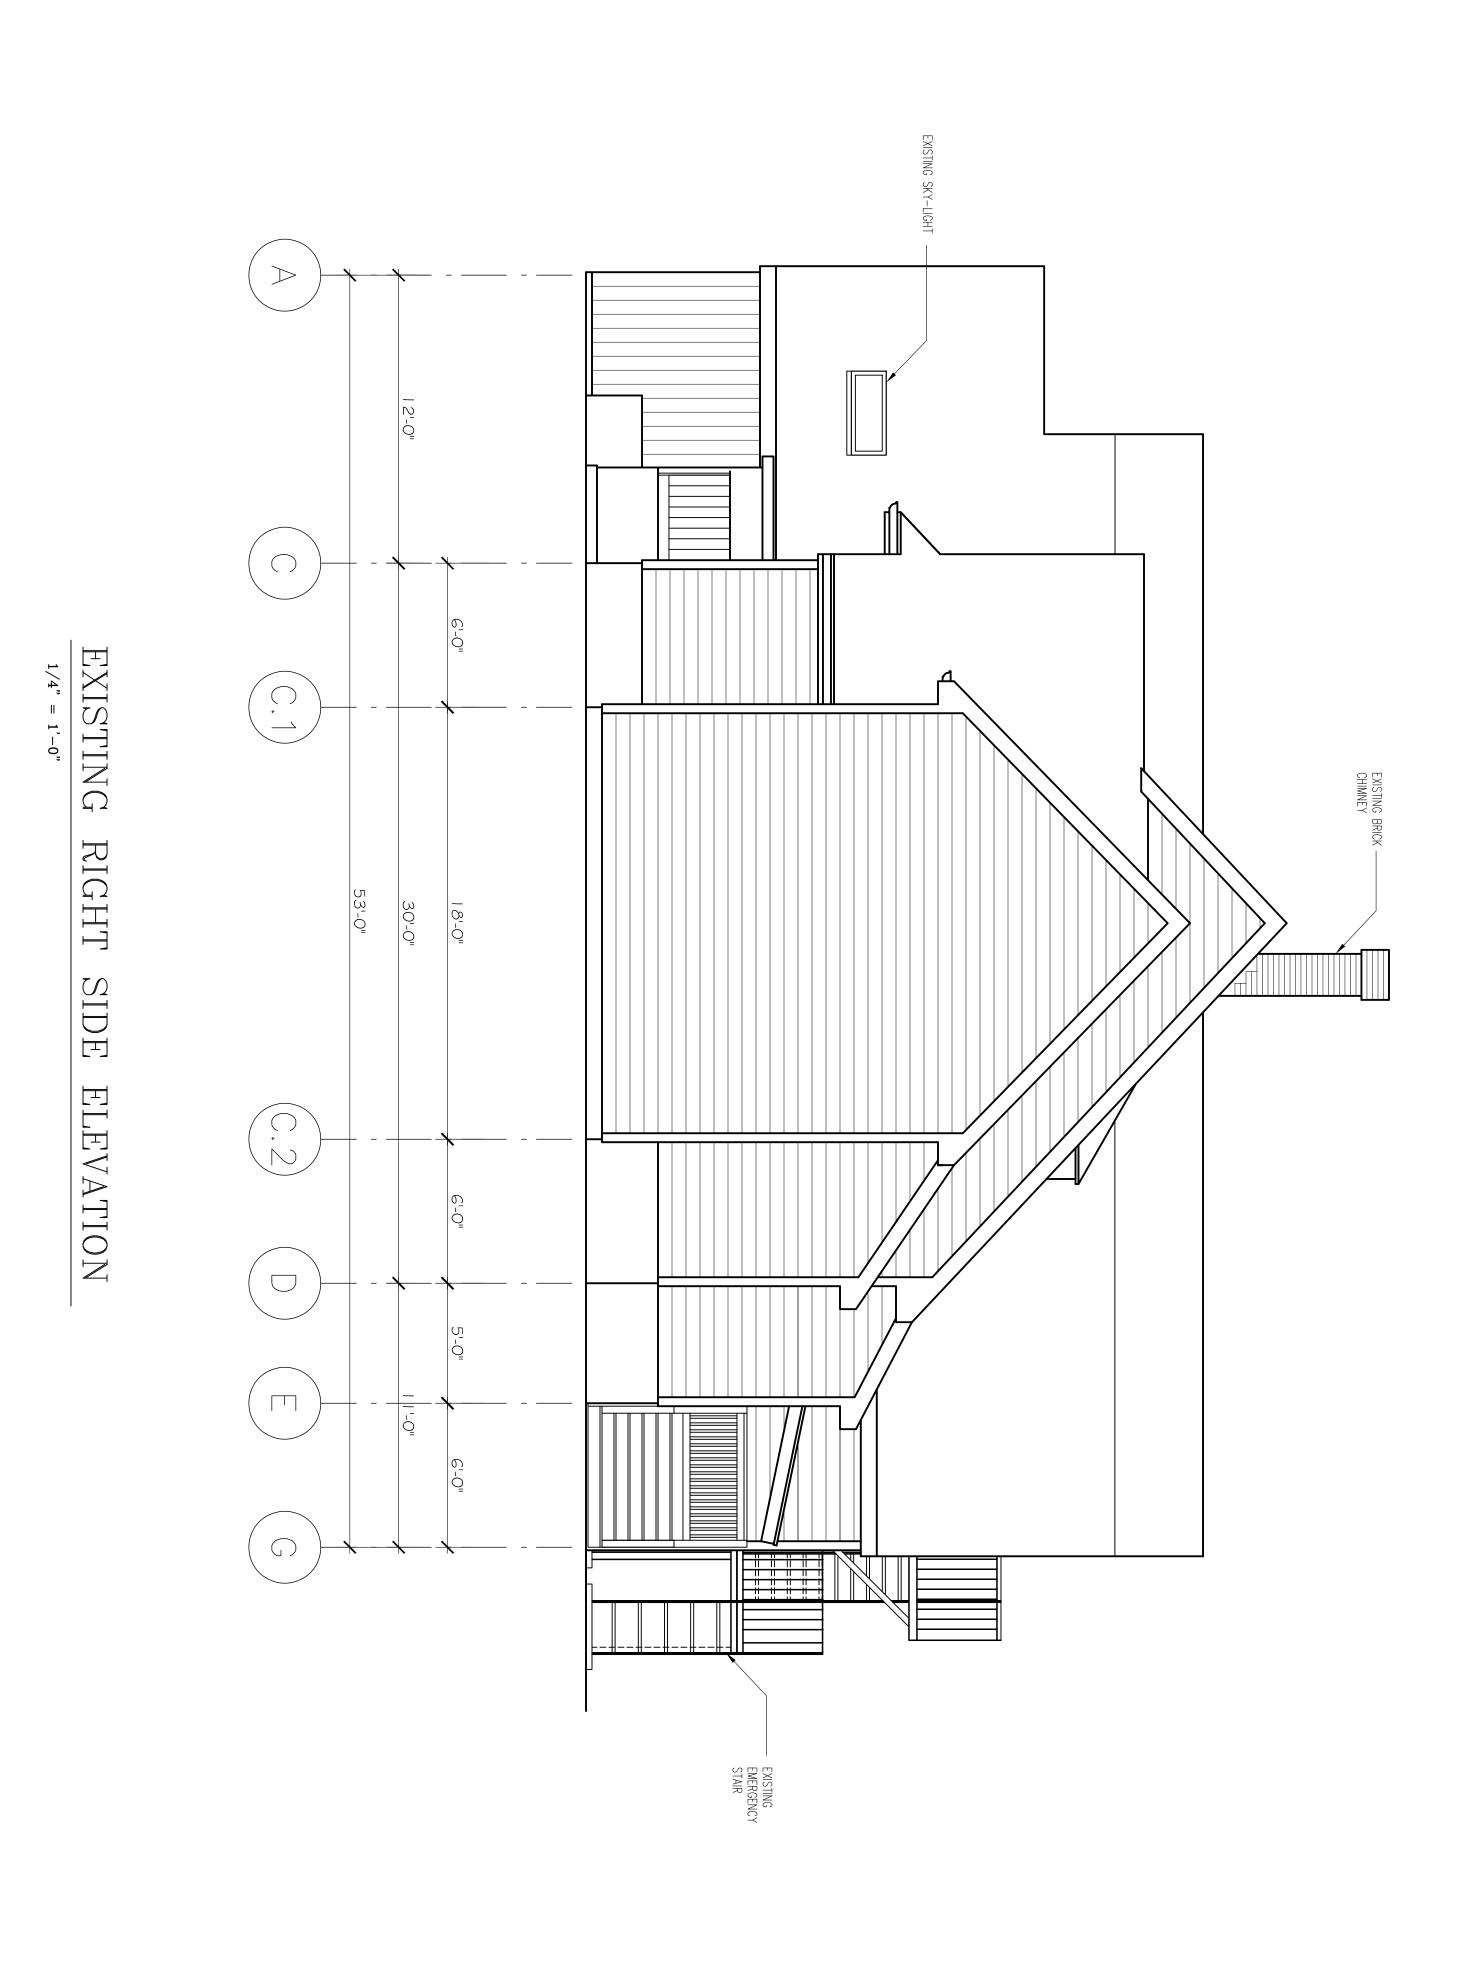


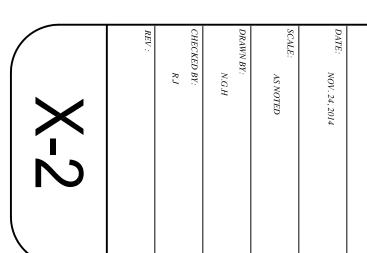


PROJECT: RENOVATION & ALTERATIONS, 15 SOUTH GATE PARK, WEST NEWTON, MA 02465

CLIENT: 15 SOUTH GATE PARK WEST NEWTON, MA 02465 EXISTING RIGHT SIDE ELEVATION - SPECIAL PERMIT SET

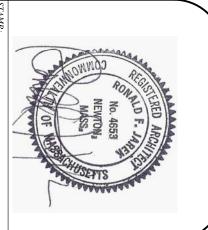

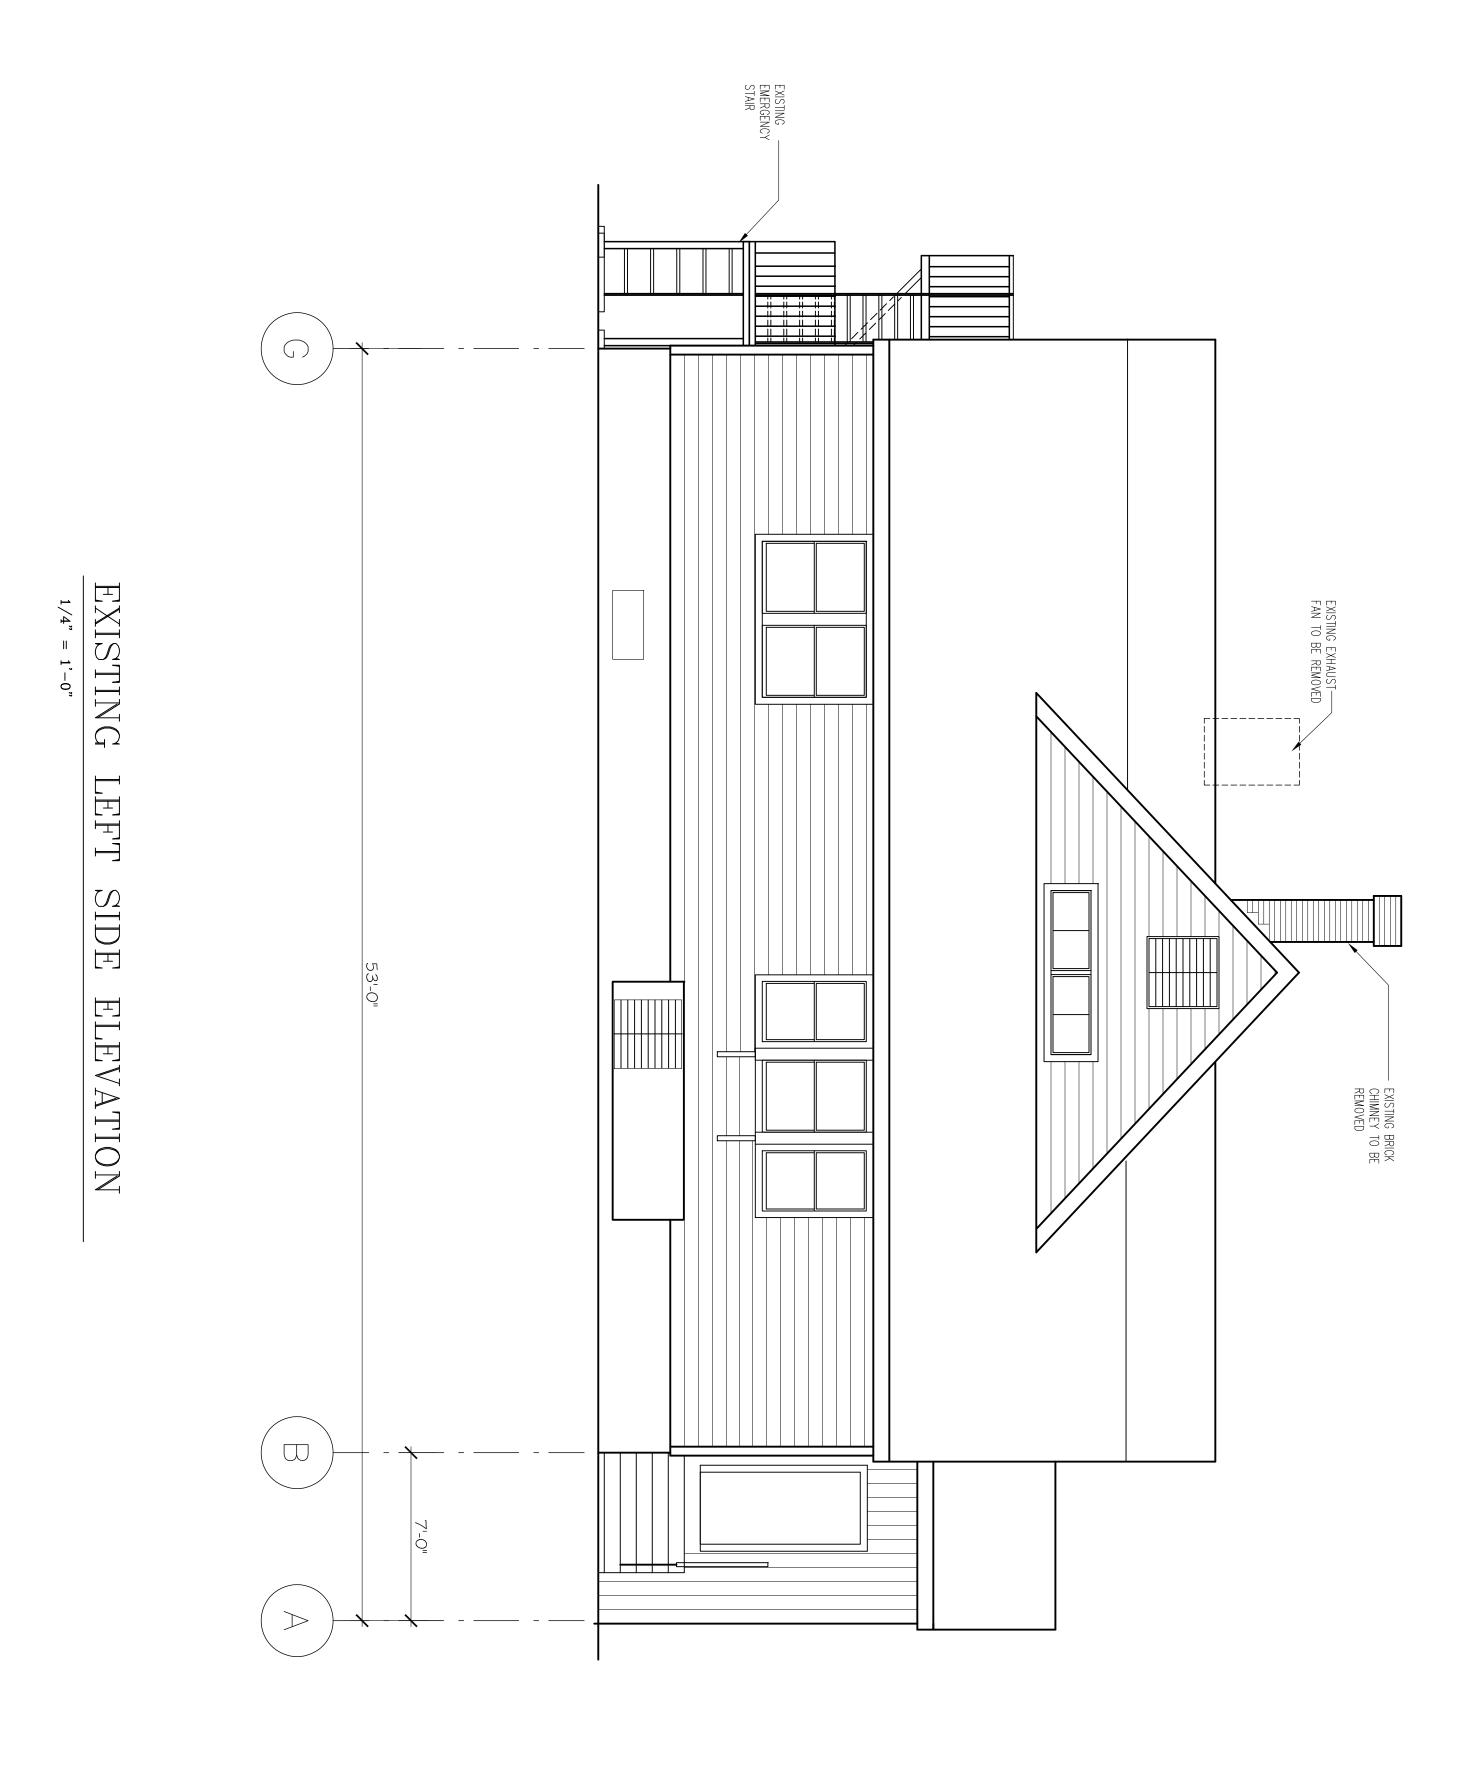


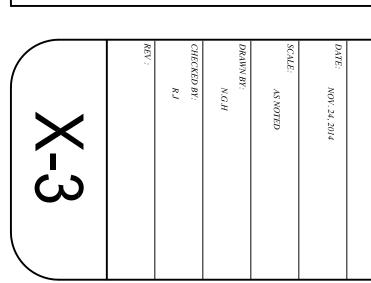

PROJECT: RENOVATION & ALTERATIONS, 15 SOUTH GATE PARK, WEST NEWTON, MA 02465


CLIENT: 15 SOUTH GATE PARK WEST NEWTON, MA 02465 EXISTING LEFT SIDE ELEVATION - SPECIAL PERMIT SET




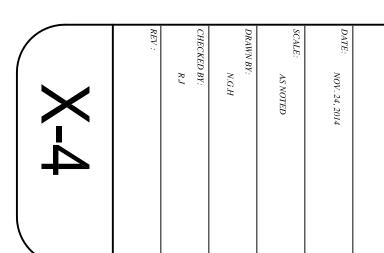

PROJECT: RENOVATION & ALTERATIONS, 15 SOUTH GATE PARK, WEST NEWTON, MA 02465

CLIENT: 15 SOUTH GATE PARK WEST NEWTON, MA 02465 EXISTING REAR ELEVATION - SPECIAL PERMIT SET

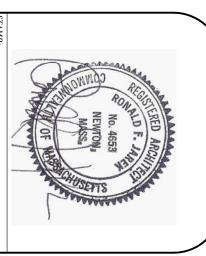

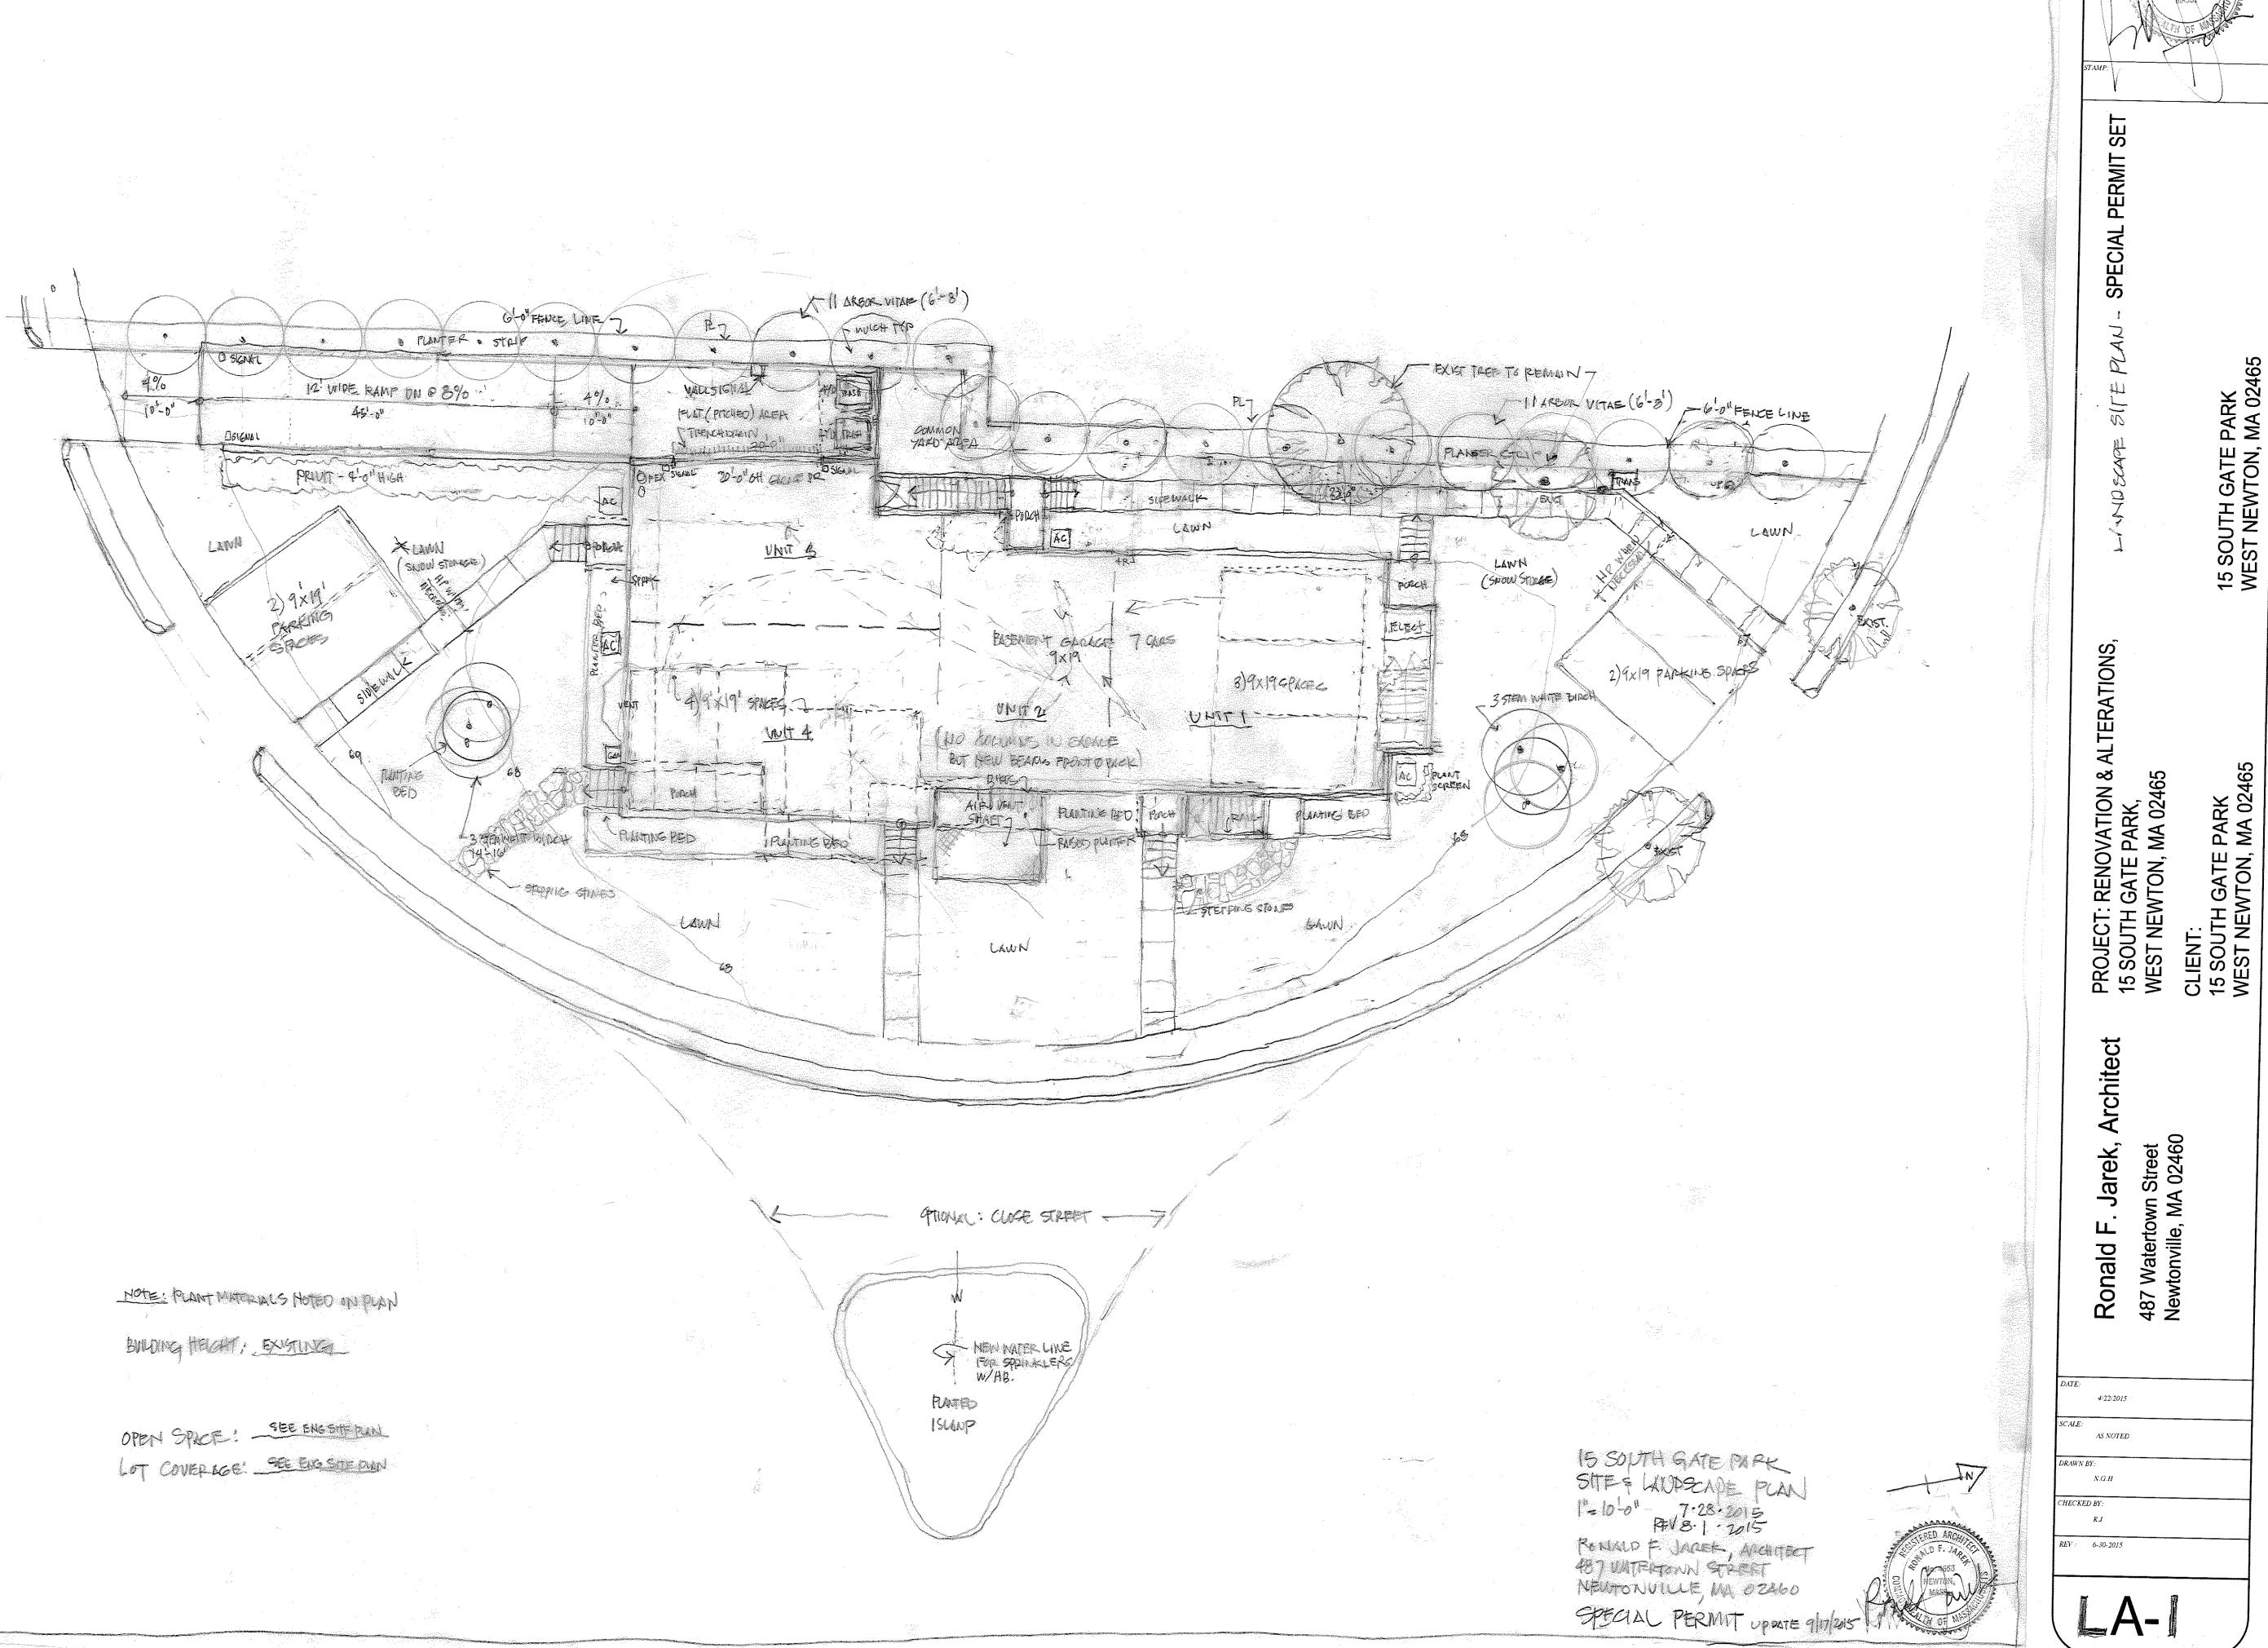

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