INSULATION GUIDELINES (if no HERS Rater) Code Checklist for Designers - Stretch Code Alterations, Renovations, or Repairs - HERS rating of ≤ 85 for house < 2000 ft2, HERS rating of ≤ 80 for house ≥ Fenestration:

Alterations, Renovations, or Repairs – HERS rating of ≤ 85 for house < 2000 ft2, HERS rating of ≤ 80 for house ≥ 2000 ft2, OR the following in all exposed or new areas Get a HERS rating, **OR** the follow this prescriptive list **Category Verification Source**

☐ Insulation

- Roof or joists of unfinished attic R-38, unless the existing rafters aren't deep enough, then R 3.5/inch. This MAY be triggered even if you just expose the sheathing. on plans, inspection, IECC 2009 402.1.1 (we're zone 5A), MA Bld Code 8th Ed. 115AA
- EXCEPTION up to 500 ft2 or 20%, whichever is less, of roof can be R-30 IECC 2009 402.2.2
- Existing walls fill full with R 3.5/inch material. New walls R-20. Use either 2x6 frame or 2x4 frame with 2" of rigid.
 on plans, inspection IECC 2009 402.1.1, MA Bld Code 8th Ed.
- Floors R-30, existing floors R 3.5/inch on plans, inspection IECC 2009 402.1.1
- Basement wall R-10 on the foundation wall, or R-13 in a framed wall
- on plans, inspection IECC 2009 402.1.1

115AA 101.4.3

- Slab R-10, slab perimeter R-10 on plans, inspection IECC 2009 402.1.1
- Crawl space wall R-10 on plans, inspection IECC 2009 402.1.1
- Mass walls (concrete/masonry) R-13 if >50% of insulation is outside wall, R-17 if <50% of insulation is outside wall on plans, inspection IECC 2009 402.1.1
- For additions all U-values must meet IECC 2009 standards. No R-3.5/inch exception for existing voids. on plans, inspection See Renovation section,

windows U-.30 or lower, doors: solid U.21 or lower, less than ½ glass U.27 or lower, more than ½ glass U.32 or lower; skylights U.55 or lower. Doors/hatches to unconditioned space must be gasketed + insulated., so avoid uninsulated space.
 window/door paperwork or copies of labels
 MA Bld Code 8th Ed

IECC 2009 402.2.3
Up to 15 ft2 of "glazed fenestration" can be exempt from U- factor requirements

115AA 401.3, Energy

Star window/door V.5,

IECC 2009 402.3.3 IECC 2009
o One opaque (no glass), side-hinged door, up to 24
ft2, can be exempt from U-factor requirements
IECC 2009 402.3.4 IECC 2009

☐ Air seals -

 all joints, seams, and penetrations between conditioned + unconditioned space to create continuous barrier. If tested must meet < 7 ACH 50 Blower door, or Energy Star thermal bypass checklist by contractor IECC 2009 402.4.2, 402.4.1 MA Bld Code

□ Lighting

8th Ed. Appendix 115AA 401.3

- Cans in roofs or unconditioned space IC rated and caulked or gasketed to finish surface inspection IECC 2009 402.4.5
- At least 80% of new lights must be high-efficiency on plans, inspection IECC 2009 404.1

HVAC

 Equipment sized using Manuals J, S and D. Do not oversize IECC 2009 403.6, IRC 1401.3

□ Labeling

401.3 Compliance checklist on plans. inspection IECC 103.1

SEE CURRENT VTP SURVEY SITE PLAN



50-52 ROWE ST., NEWTON, MA

TO BE REMOVED CLG Ceiling OPP Opposite CLR Clear P.LAM Plastic Lar COL Column PL Plaster CONC Concrete PTD Painted CONSTR Construction REQ Required CONSTR Continuous RO Rough Ope CPT Carpet SIM Similar CT Ceramic Tile SST Stainless CTR Center STD Stainless CTR Center STD Stainless CTR Center STD Stainless DET Detail No. DET Detail SECTION DETAIL SECTION			
TO BE REMOVED CLC Ceiling OPP Opposite CLR Clear P.LAM Plostic Lar COL Column PL Ploster CONC Concrete PTD Painted CONSIR Construction REQ Required CONT Continuous RO Rough Ope CPT Carpet SIM Similar CT Cercmic Title SST Stainless S CTR Center STD Stainless S CTR Center STD Stainland DET Detail STI Steel DIA Diameter STOR Storage DISP Dispenser SUSP Suspended DISP Dispenser SUSP Suspended DIA Down T&G Tongue & Tongue & DIA Down T&G Tongue			
TO BE REMOVED CLG Column COL Column PL Plaster CONC Concrete PTD Painted CONSTR Construction CONT Continuous RO Rough Ope CT COT COT Corret SIM Similar CT CT Ceramic Tile SST Stainless S CTR CORE CTR Center DEtail No. DET Detail No. DET Detail No. DET Detail No. DET Detail No. DETAIL SECTION DETAIL SECTION DETAIL SECTION DETAIL SECTION CLG CONC Concrete PTD Painted CONSTR Construction REQ Required CONT Continuous RO Rough Ope SIM Similar CT Ceramic Tile SST Stainless S CTR Center STD Standard DET Detail No. DET Detail No. DET Dispenser SUSP Suspended DN Down DWG Drawing THK Thick ELEC Electric(Electrical) TYP Typical EQ EQ EQual VCB Vinyl Cove Place Pla	WD Wood W/ With W/O Without		
TO BE REMOVED CLG Celling OPP Opposite CLR Clear COL Column PL Plaster CONC Concrete PTD Painted CONT CONT Continuous RO Rough Ope CPT Carpet SIM Similar CT CT Ceramic Tile SST Stainless S CTR Center STD Standard DET Detail No. Detail SECTION Detail No. Detail No. Detail No. Detail No. Detail SECTION Detail No. Detail No. Detail SECTION Detail No. Detail No. Detail SECTION Detail	TYP Typical VCB Vinyl Cove Base VPB Veneer Plaster Base	ster Base	
TO BE REMOVED CLG Ceiling OPP Opposite CLR Clear P.LAM Plastic Lar COL Column PL Plaster CONC Concrete PTD Painted CONT Continuous REQ Required CONT Continuous RO Rough Ope CPT Carpet SIM Similar CT Ceramic Tile SST Stainless ST CTR Center STD Standard	STOR Storage SUSP Suspended T&G Tongue & Groove		е
TO BE REMOVED CLG Ceiling OPP Opposite CLR Clear P.LAM Plastic Lar COL Column PL Plaster	RO Rough Opening SIM Similar SST Stainless Steel STD Standard		
BD Board NIC Not In Cor	NTS Not To Scale OPP Opposite P.LAM Plastic Laminate PL Plaster	ale	
	MISC Miscellaneous		



NEW 2) TWO FAMILY RESIDENCES


50-52 ROWE ST, NEWTON, MA 02466


LIST OF DRAWINGS

- A-0 TITLE SHEET
- 1 NOTES, MATERIALS LIST & FAR CALC.
- A-2 PROPOSED BASEMENT FLOOR PLAN UNIT 1&2
- A-3 PROPOSED FIRST FLOOR PLAN UNIT 1&2
- A-4 PROPOSED SECOND FLOOR PLAN UNIT 1&2
- A-5 PROPOSED ROOF PLAN UNIT 1&2
- PROPOSED FRONT & RIGHT SIDE ELEVATIONS UNIT 1&2
- A-7 PROPOSED REAR & LEFT SIDE ELEVATIONS UNIT 1 & 2
- A-8 PROPOSED BASEMENT & FIRST FLOOR PLANS UNIT 3 & 4
- A-9 PROPOSED SECOND FLOOR & ROOF PLANS UNIT 3 & 4
- A-10 PROPOSED FRONT & RIGHT SIDE ELEVATIONS UNIT 3 & 4
 A-11 PROPOSED REAR & LEFT SIDE ELEVATIONS UNIT 3 & 4
- A-12 PROPOSED CAR PORT
- A-13 PROPOSED SECTION A-A UNIT 1&2
- A-14 PROPOSED SECTION B-B UNIT 3&4
- EX-1 EXISTING BASEMENT & FIRST FLOOR PLANS UNIT 1&2
- EX-2 EXISTING SECOND FLOOR & ROOF PLANS UNIT 1&2
- EX-3 EXISTING ELEVATIONS UNIT 1&2

Architect: Ronald F. Jarek

487 Watertown Street Newtonville, MA 02460 (617) 818-4540

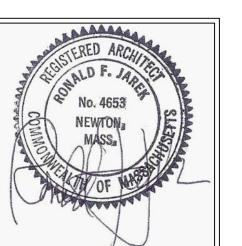

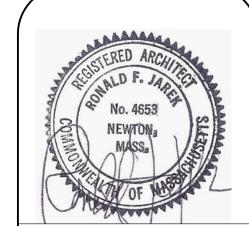

1-2-3-4 PROPOSED & DRAWINGS LIST

02466 TITLE & [50 - 52 ROV

NEW 2) TWO FAMILY RESIDENCES 50 - 52 ROWE STREET, NEWTON, I

Ronald F. Jarek, Archite

TE:
April 18, 2016

ALE:
AS NOTED

RAWN BY:
N.G.H

MECKED BY:
R.J

ALL WORK SHALL COMPLY WITH THE COMMONWEALTH OF MASSACHUSETTS STATE BUILDING CODE (IRC 2009), THE REQUIREMENTS OF THE CITY OF NEWTON, THE OCCUPATIONAL SAFETY AND HEALTH STANDARDS AND ALL OTHER APPLICABLE REGULATIONS, LAWS, ORDINANCES, ETC. GOVERNING THIS WORK INCLUDING THE STRETCH CODE

PRIOR TO SUBMITTING BID, CONTRACTOR MUST THOROUGHLY EXAMINE THE DRAWINGS, AND INSPECT THE BUILDING TO FULLY UNDERSTAND THE FACILITY, DIFFICULTIES AND RESTRICTIONS AFFECTING THE EXECUTION OF THE WORK UNDER THIS CONTRACT. THE FAILURE OF THE CONTRACTOR TO RECEIVE OR EXAMINE ANY FORM OF INSTRUMENT OR DOCUMENT OR TO VISIT THE SITE SHALL IN NO WAY RELIEVE ANY OBLIGATION WITH RESPECT TO THIS WORK. NO CLAIMS FOR ANY ADDITIONAL COST WILL BE ALLOWED DUE TO LACK OF FULL KNOWLEDGE OF

CONTRACTOR'S BID PRICE SHALL REFLECT ALL SPECIFIED WORK.

DRAWN INFORMATION IS TAKEN FROM EXISTING CONDITIONS AND RANDOM FIELD MEASUREMENTS AND IS PROVIDED ONLY TO ASSIST THE CONTRACTOR IN ESTABLISHING THE SCOPE OF WORK ALL EXISTING CONDITIONS AND PLAN AND DETAIL DIMENSIONS SHOULD BE VERIFIED IN THE FIELD PRIOR TO COMMENCING THE WORK. THE

CONTRACTOR SHALL NOTIFY THE OWNER OF ANY DISCREPANCIES FOUND IN THE PLANS OR SPECIFICATIONS BEFORE PROCEEDING WITH THE AFFECTED PART OF THE WORK.

DO NOT SCALE THESE DRAWINGS FOR QUANTITIES, LENGTHS, SIZES, AREAS ETC

IT IS NOT INTENDED THAT THESE DRAWINGS SHOW EVERY CUT, CONDITION ETC. OF THIS SYSTEM, HOWEVER, THE CONTRACTOR SHALL FURNISH A COMPLETE PRODUCT IN ACCORDANCE WITH THE BEST PRACTICE OF THE TRADE TO THE SATISFACTION OF THE ARCHITECT AND THE OWNER, AND IN STRICT CONFORMANCE WITH ALL APPLICABLE LOCAL AND STATE BUILDING CODE REGULATIONS.

CONTRACTOR SHALL REPAIR ALL AREAS DAMAGED BY DEMOLITION PRIOR TO INSTALLATION OF NEW MATERIAL.

IF HAZARDOUS WASTE IS ENCOUNTERED, STOP WORK & CONTACT THE OWNER & ARCHITECT IMMEDIATELY TO INITIATE ABATEMENT PROCEDURES IN ACCORDANCE WITH OSHA STANDARDS

GENERAL NOTES STRUCTURAL

1. ALL WORK SHALL COMPLY WITH THE STATE OF MASSACHUSETTS BUILDING CODE, (IRC 2009) REQUIREMENTS OF THE CITY OF NEWTON, AND ALL OTHER LOCAL, STATE AND FEDERAL STANDARDS AND REGULATIONS

2. DO NOT SCALE THIS DRAWING. REFER TO ARCHITECTURAL DRAWINGS FOR DIMENSIONS, LIMITS AND LOCATIONS REGARDING LAYOUT OF ALL

STRUCTURAL FRAMING MEMBERS AND COMPONENTS. REFER TO ARCH. DWGS. FOR ALL ELEVATIONS. 3. THE STRUCTURAL DRAWINGS SHALL BE USED IN CONJUNCTION WITH THE ARCHITECTURAL, MECHANICAL AND ELECTRICAL DRAWINGS AND THESE DRAWINGS SHALL BE REFERED TO FOR SIZE AND LOCATION OF APPURTENANCES

4. DIMENSIONS SHOWN ON THE DRAWINGS MUST BE COORDINATED WITH ARCHITECTURAL DRAWINGS PRIOR TO DETAILING, FABRICATION AND

5. EXISTING LAYOUT, ITEMS AND CONDITIONS MAY DIFFER FROM AS SHOWN. ALL EXISTING CONDITIONS AND DIMENSIONS MUST BE VERIFIED IN FIELD PRIOR TO COMMENCING THE WORK. ANY DISCREPENCIES FOUND SHALL BE BROUGHT TO THE ATTENTION OF THE ENGINEER BEFORE PROCEEDING WITH THE AFFECTED PART OF THE WORK.

6. IT IS THE BIDDER'S RESPONSIBILITY TO VERIFY ALL DIMENSIONS AND EXISTING CONDITIONS AT THE SITE PRIOR TO BIDDING. FAILURE TO SO EXAMINE THE SITE AND THE CONTRACT DOCUMENTS WILL NOT RELIEVE THE BIDDER FROM ANY OBLIGATION UNDER THE BID AS SUBMITTED. 7. FABRICATOR FOR EACH STRUCTURAL TRADE SHALL PREPARE SHOP DRAWINGS SHOWING LOCATION, LIMITS, DIMENSIONS AND EXTENT OF ALL MEMBERS, CONNECTIONS AND DETAILS TO BE SUBMITTED FOR APPROVAL. NO ERECTION SHALL BE PERFORMED WITHOUT THE APPROVAL OF SHOP DRAWINGS.

8. THE CONTRACTOR SHALL TAKE ADEQUATE PRECAUTIONS AT ALL TIMES TO PROTECT ADJOINING PROPERTY FROM DAMAGE. ALL ABUTTING WORK SHALL BE RESTORED TO PRESENT CONDITION

9. CONTRACTOR SHALL SUBMIT SHOP DRAWINGS FOR ALL ITEMS FOR APPROVAL.

FOUNDATION NOTES

FOOTINGS SHALL BE CARRIED TO ELEVATIONS SHOWN ON THE DRAWINGS AND DEEPER IF NECESSARY TO OBTAIN A SAFE BEARING PRESSURE OF AT LEAST 2000 POUNDS PER SQUARE FOOT. CONTRACTOR SHALL VERIFY THE DESIGN BEARING CAPACITY THROUGH <u>GEOTECHNICAL SERVICES PRIOR TO PLACING CONCRETE AND AFTER PLACEMENT HAS BEEN APPROVED</u> . NO FOUNDATIONS SHALL BE PLACED ON FROZEN SOIL OR WATER. PROVIDE PROPER DRAINAGE OF EXCAVATION WITH PLASTIC PIPE TO PROTECT AGAINST WATER. WHERE IT IS NECESSARY TO RAISE THE GRADE BELOW SLAB DUE TO OVER EXCAVATION, STRUCTURAL FILL SHALL BE

PLACED AND COMPACTED TO 95% DRY DENSITY. 3. PROVIDE PROPER DRAINAGE OF EXCAVATION OR COVER EXCAVATION WITH PLASTIC TO PROTECT AGAINST WATER.

PLYWOOD NOTES

1. ALL PLYWOOD SHEATHING SHALL BE APA RATED STRUCTURAL I. PLYWOOD USED FOR ROOF SHEATHING SHALL BE EXTERIOR GRADE.

2. ALL PLYWOOD SHALL HAVE A MINIMUM THICKNESS OF 3/4".

2. ALL EDGES SHALL BE TONGUE AND GROOVE JOINTED OR CONTINUOUSLY SUPPORTED WITH WOOD BLOCKING.

CONCRETE NOTES

1. ALL WORK AND MATERIALS SHALL CONFORM TO THE LATEST EDITION OF AMERICAN CONCRETE INSTITUTE'S ACI 318 (BUILDING CODE REQUIREMENTS FOR REINFORCED CONCRETE). CONCRETING SHALL FOLLOW REQUIREMENTS OF ACI 306 R FOR COLD WEATHER CURING AND ACI 305 R FOR HOT WEATHER CURING.

2. CONCRETE STRENGTH SHALL BE AS FOLLOWS: ALL CONCRETE - MIN. COMPRESSIVE STRENGTH = 4000 PSI 3. ALL BAR REINFORCEMENT SHALL CONFORM TO ASTM A615 - GRADE 60.

4. ALL WELDED WIRE FABRIC SHALL CONFORM TO ASTM A185 AND SHALL BE SUPPLIED IN FLAT SHEETS. WELDED WIRE FABRIC SHALL BE 6x6-W4xW4 UNLESS NOTED.

5. MINIMUM CONCRETE CLEARANCES FOR PROTECTION OF REINFORCING:

SLABS: TOP - 2" WALL: ALL SIDES - 2" (MIN.)

6. ALL EXPOSED CONCRETE EDGES SHALL HAVE 3/4" CHAMFER, USING EDGING TOOL WHERE NEEDED. EXPOSED CONCRETE SURFACES SHALL HAVE A PLYWOOD FINISH. JOINTS AND FINS SHALL BE SACKED TO A UNIFORM TEXTURE WHILE CONCRETE IS STILL GREEN, TO PRODUCE A

SURFACE ACCEPTABLE TO THE DESIGNERS & OWNER. 7. CONSTRUCTION JOINT SPACING SHALL BE AS SHOWN ON THE DRAWINGS.

8. BONDING AGENT FOR ADHERING NEW CONCRETE TO EXISTING CONCRETE SHALL BE APPLIED PRIOR TO POURING NEW CONCRETE. BONDING AGENT SHALL BE "WELDCRETE" AS MANUFACTURED BY LARSEN PRODUCTS CORP. OF ROCKVILLE, MD, OR APPROVED EQUAL.

9. DOWELLING OF NEW REINFORCEMENT INTO EXISTING CONCRETE SHALL BE ACHIEVED BY USING THE HILTI HVA "ADHESIVE ANCHOR METHOD". ALL INSTALLATION SHALL BE IN ACCORDANCE WITH MANUFACTURER'S PRINTED INSTRUCTIONS.

10. CONTROL JOINTS SHALL BE PLACED THROUGHOUT AND EQUALLY SPACED NOT EXCEEDING 10' ON CENTER, IN ANY DIRECTION.

WOOD NOTES

1. ALL STRUCTURAL WOODWORK, MATERIALS AND WORKMANSHIP SHALL CONFORM TO THE LATEST EDITION OF THE AMERICAN INSTITUTE OF TIMBER CONSTRUCTION'S SPECIFICATION FOR DESIGN, FABRICATION AND ERECTION OF WOOD STRUCTURES. 2. ALL STRUCTURAL LUMBER SHALL BE SOUTHERN PINE, DOUGLAS FIR, GRADE 1 OR APPROVED EQUAL WITH MINIMUM PROPERTIES OF: E = 1,800,000 PSI, Fb = 1500 PSI, Fv = 190 PSI.

NOTE - DIMENSION

ALL DIMENSIONS ARE APPROXIMATE. CONTRACTOR MUST VERIFY ALL EXISTING DIMENSIONS AND PREPARE A LAYOUT DRAWING WITH ALL EXISTING CONDITION PRIOR TO PROCEEDING WITH ANY NEW WORK.

• SEE MATERIALS LIST, DETAILS AND SCHEDULES

MATERIALS LIST

50-52 Rowe Street, Newton, MA 02466

ROOF:

- Estate Gray 30 year Fiberglass Asphalt Shingles
- Corrugated (Black) Ridge Vent
- Black Vent Pipes
- Heating Exahaust Stacks, blend to sidewall color

TRIM:

 Painted Pine Rake, Cornice, Frieze, Water-table, Belt, Brackets, Dentals, Corner and /or Running Trim

SIDING:

- Hardie Plank, 4.5" to weather, rough side out
- Azek or Equal Siding Trim on Dormers, Bays and /or Tower
- Direct Vent Exhaust Block Outs, Lighting Block outs Azek to blend with body color
- Painted Side-wall Vents (Dryer, Exhaust Fans) to blend with body color

DOWN SPOUTS AND GUTTERS:

 Baked on Color Finish, Aluminium Box Style (6" K profile) w/ Rectangular Leader and **Fittings**

WINDOWS:

 Vinyl Ext. Paint Wood Int, Insul Glass, Sim 2 over 1 Divided Lites (narrow mutin, black spacer

DOORS:

Synthetic Wood Style Panel Entry Units with Simulated Divided Vision Lites

Synthetic Insulated Panel Style Garage Doors

COLUMNS:

Synthetic Round with without Plinth and Capital

PORCH, DECK AND STEPS:

- Synthetic Trex Board Porch, Deck and Stair Treads
- Synthetic Trex Boad Exposed Stair Risers and Stringers
- Synthetic Ball Style Balustrade and Newel Post

LIGHTING:

Oxidized Bronze Wall Mounted Lantern Style

HARDWARE:

- Oxidized Bronze Knob, Lever w/ Thumb Latch Style
- Mail Boxes Oxidized Bronze
- House Numbers Oxidized Bronze

WALKS:

Reddish Pavers at Entry Points

DRIVEWAY:

Bituminous


FOUNDATION

Concrete Parged

50-52 Rowe Street Special Permit FAR Calculations LOT SIZE: 19,321SF							
<u>AREA</u>	UNIT 1	UNIT 2	UNIT 3	UNIT 4	FAR TOTAL S.F. ALLOWED by SP	FAR TOTAL S.F. PROVIDED	
BASE (Not Req'd)							
FIRST FLOOR	1301 SF.	1063 SF.	480 SF.	720 SF.		3564 SF.	
SECOND FLOOR	1212 SF.	892 SF.	480 SF.	720 SF.		3304 SF.	
ATTIC Not (Req'd)							
MASS BELOW GR.	*300 SF.	*300 SF.				*600 SF.	
TOTAL SQ. FT **.	*2813 SF.	*2255 SF.	*960 SF.	*1440 SF.	*7700 SF.	*7468 SF.	

^{*} INCLUDES 1 1/2" SHEATHING AND SIDING THICKNESS



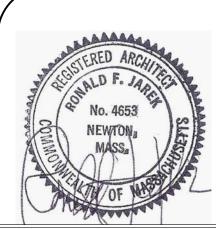

PROPOSED S.P. SUB


UNITS 1-2-3-4 CONDITIONS


02466 RESIDENCES STREE **FAMILY**


) TWO F V 2) 52 F NEW 50 - 5 Architect

Jarek, Ronald 487 New

ORAWN BY: CHECKED BY:

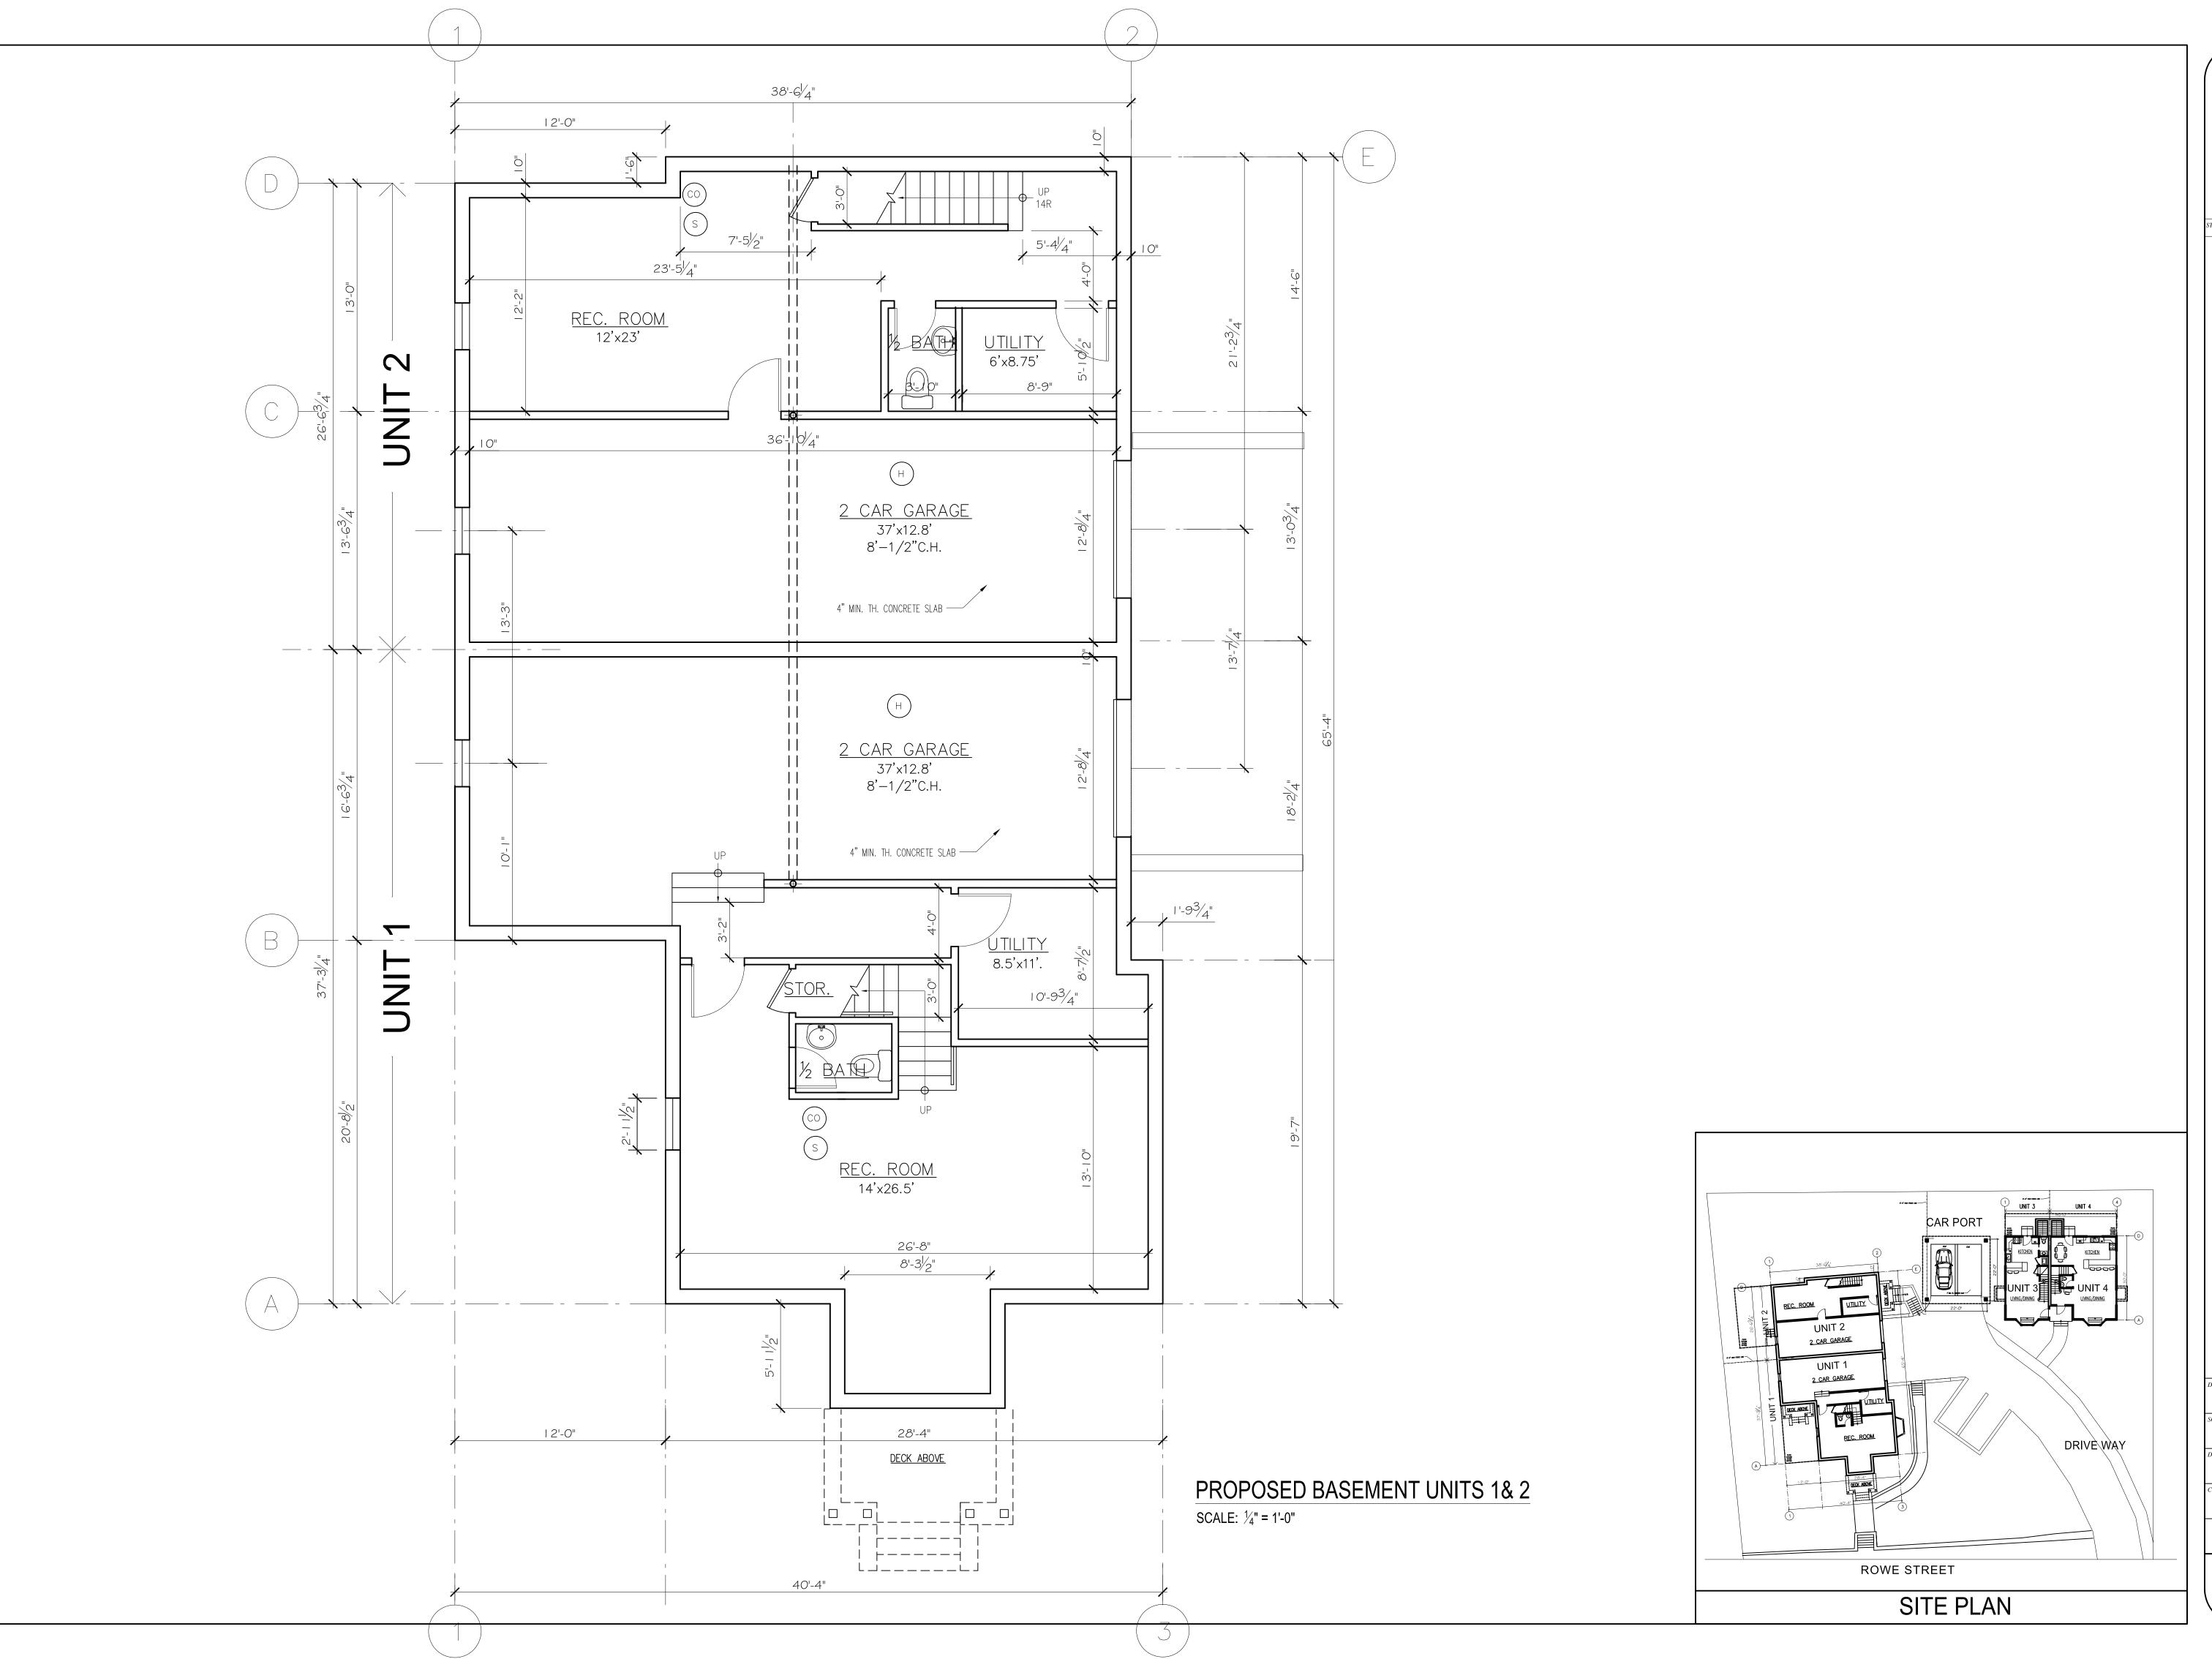

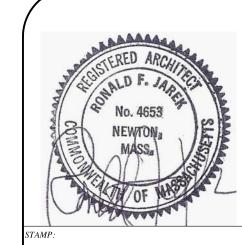

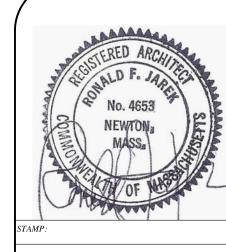

UNITS 1-2 PROPOSED BASEMENT FLOOR PLANS


50 - 52 ROWE ST. NEWTON, MA 02466


OWNER: NEW NEWTON, LLC 2193 COMMONWEALTH AVE, BRIGHTON, MA 02135

NEW 2) TWO FAMILY RESIDENCES 50 - 52 ROWE STREET, NEWTON, MA

Architect 487 Watertown Street Newtonville, MA 02460 Ronald F. Jarek,

April 28, 2016 DRAWN BY:

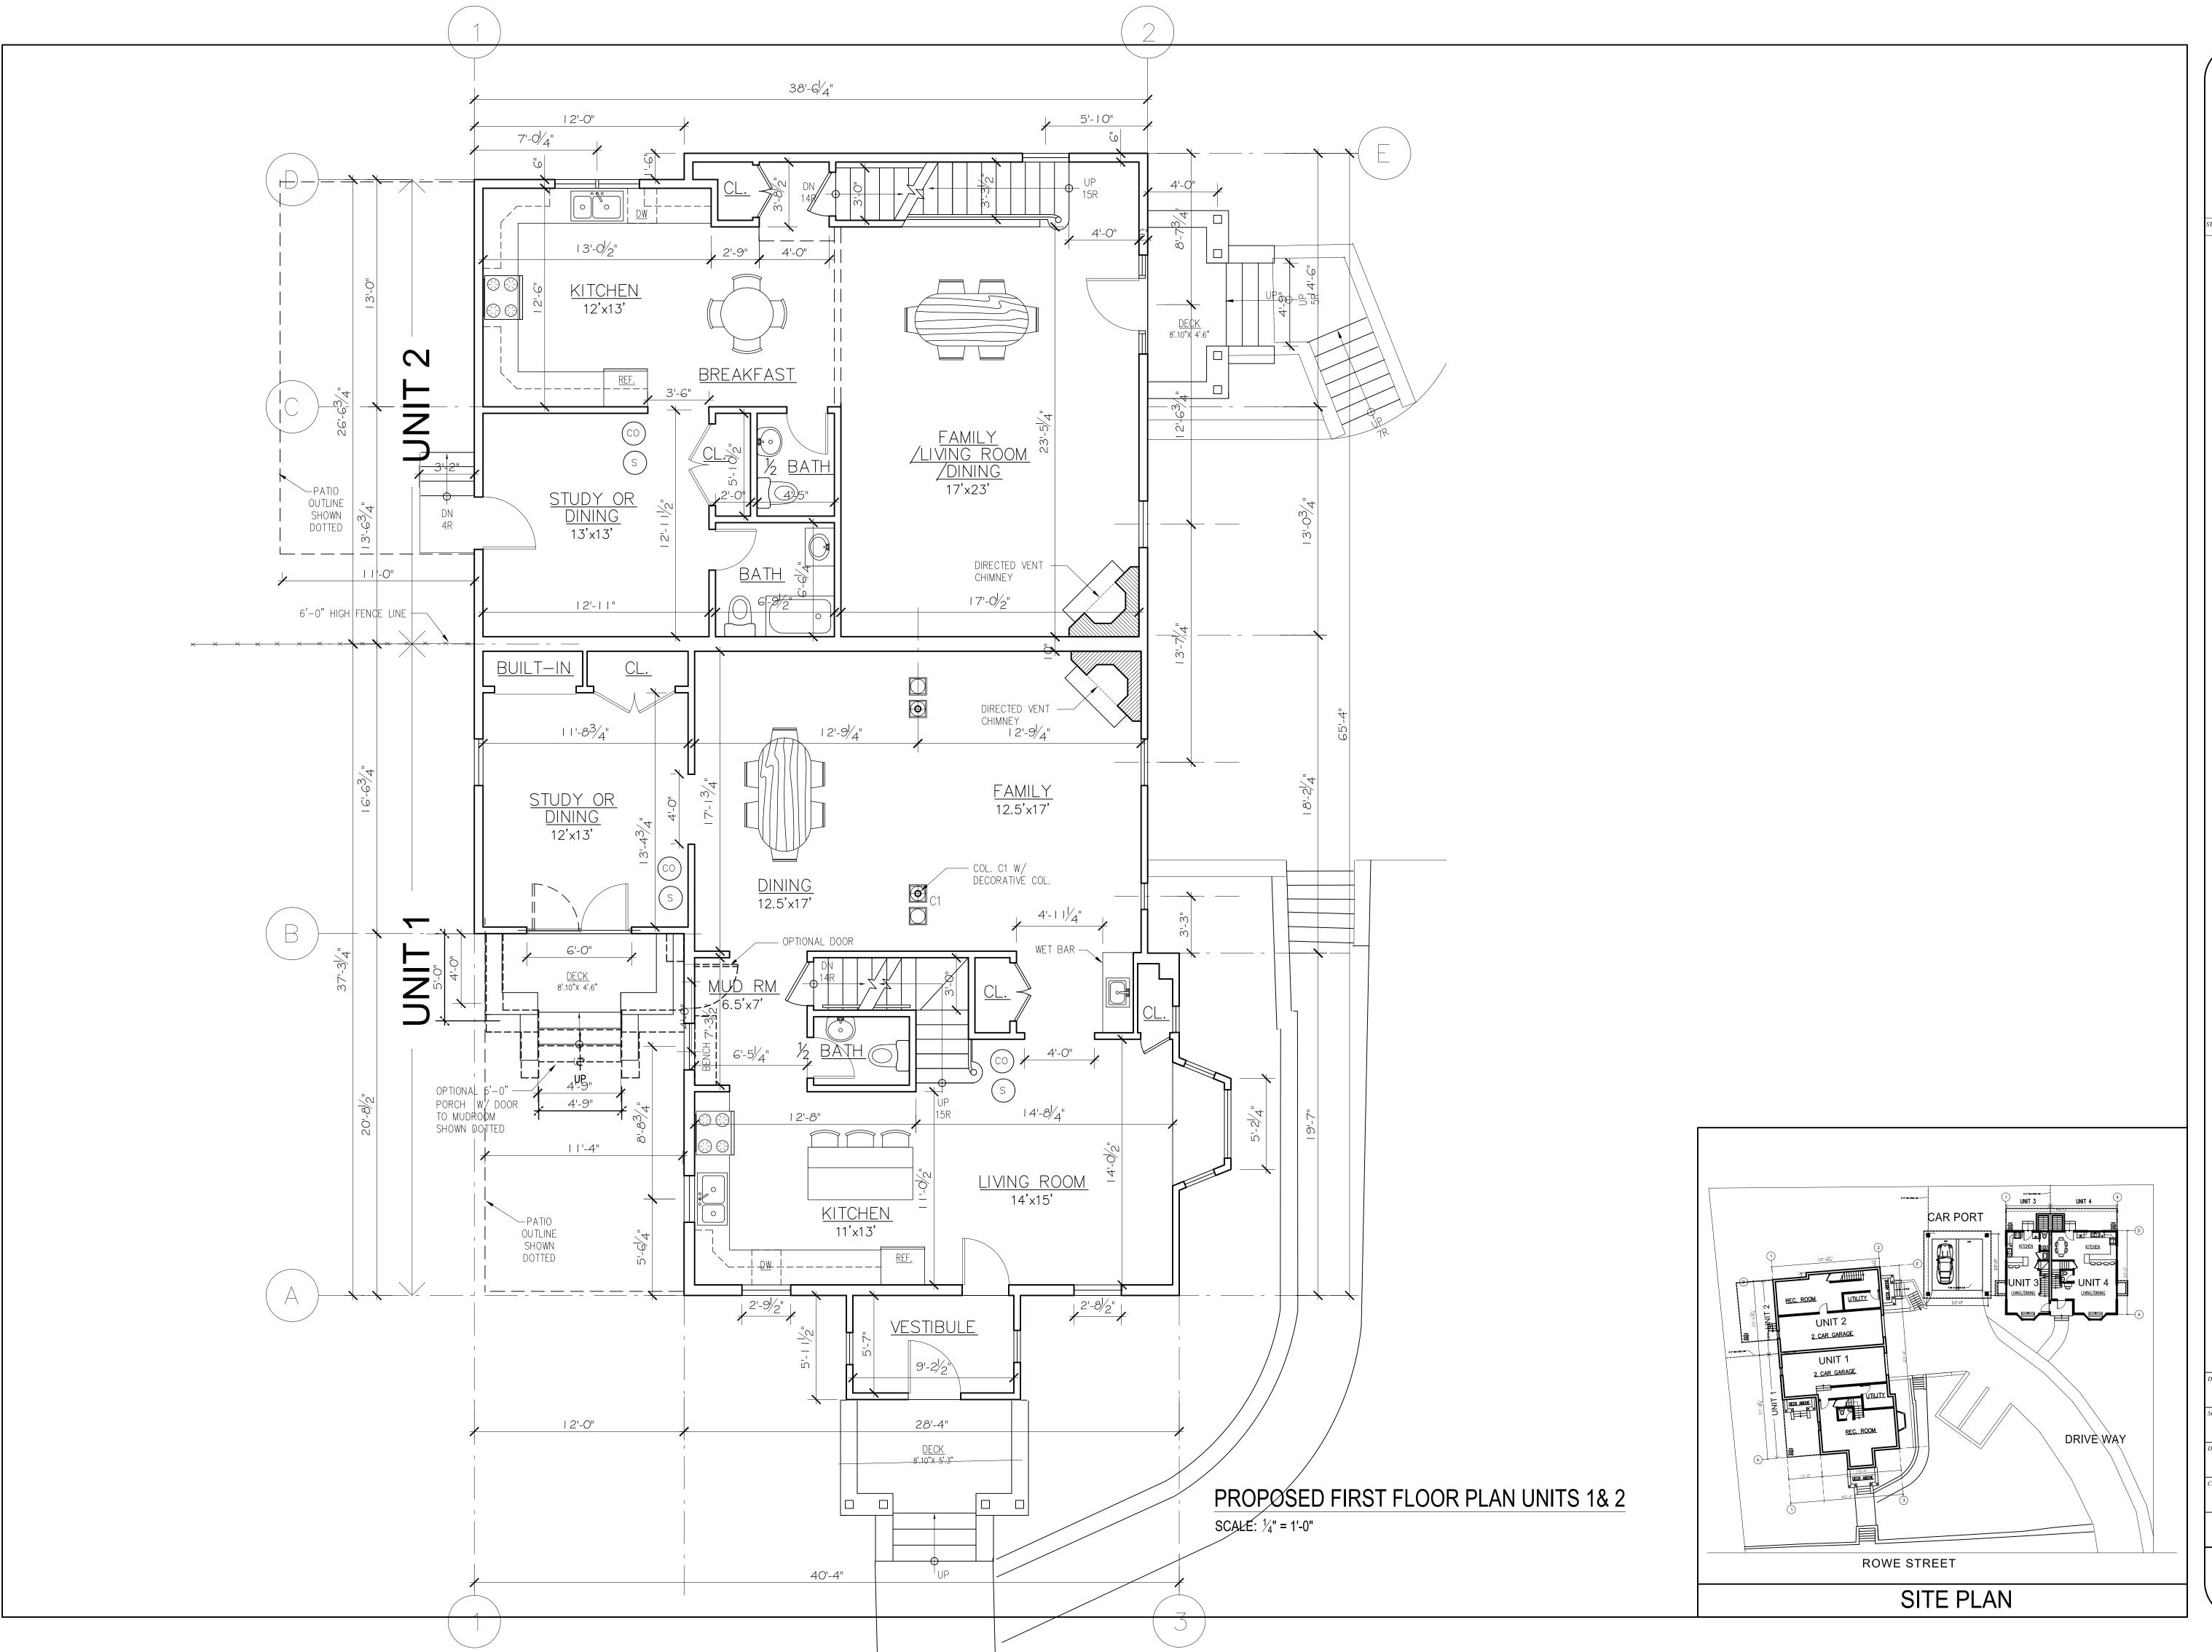

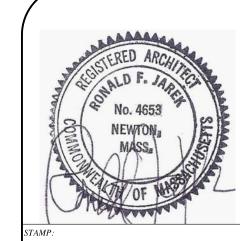

UNITS 1-2 PROPOSED FIRST FLOOR PLAN


50 - 52 ROWE ST. NEWTON, MA 02466



NEW 2) TWO FAMILY RESIDENCES 50 - 52 ROWE STREET, NEWTON, MA 02466 OWNER: NEW NEWTON, LLC 2193 COMMONWEALTH AVE, BRIGHTON, MA 02135 Architect

487 Watertown Street Newtonville, MA 02460 Ronald F. Jarek,

April 28, 2016 DRAWN BY: CHECKED BY:

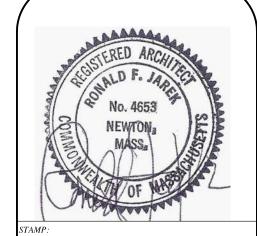

OF

UNITS 1-2 PROPOSED SECOND FLOOR PLAN

50 - 52 ROWE ST. NEWTON, MA 02466

/ 2) TWO FAMILY RESIDENCES 52 ROWE STREET, NEWTON, MA 02466

> Ronald F. Jarek, Architect 487 Watertown Street Newtonville, MA 02460

DATE:

April 28, 2016

SCALE:

AS NOTED

DRAWN BY:


N.G.H


CHECKED BY:

R.J

A-4

DRIVE WAY

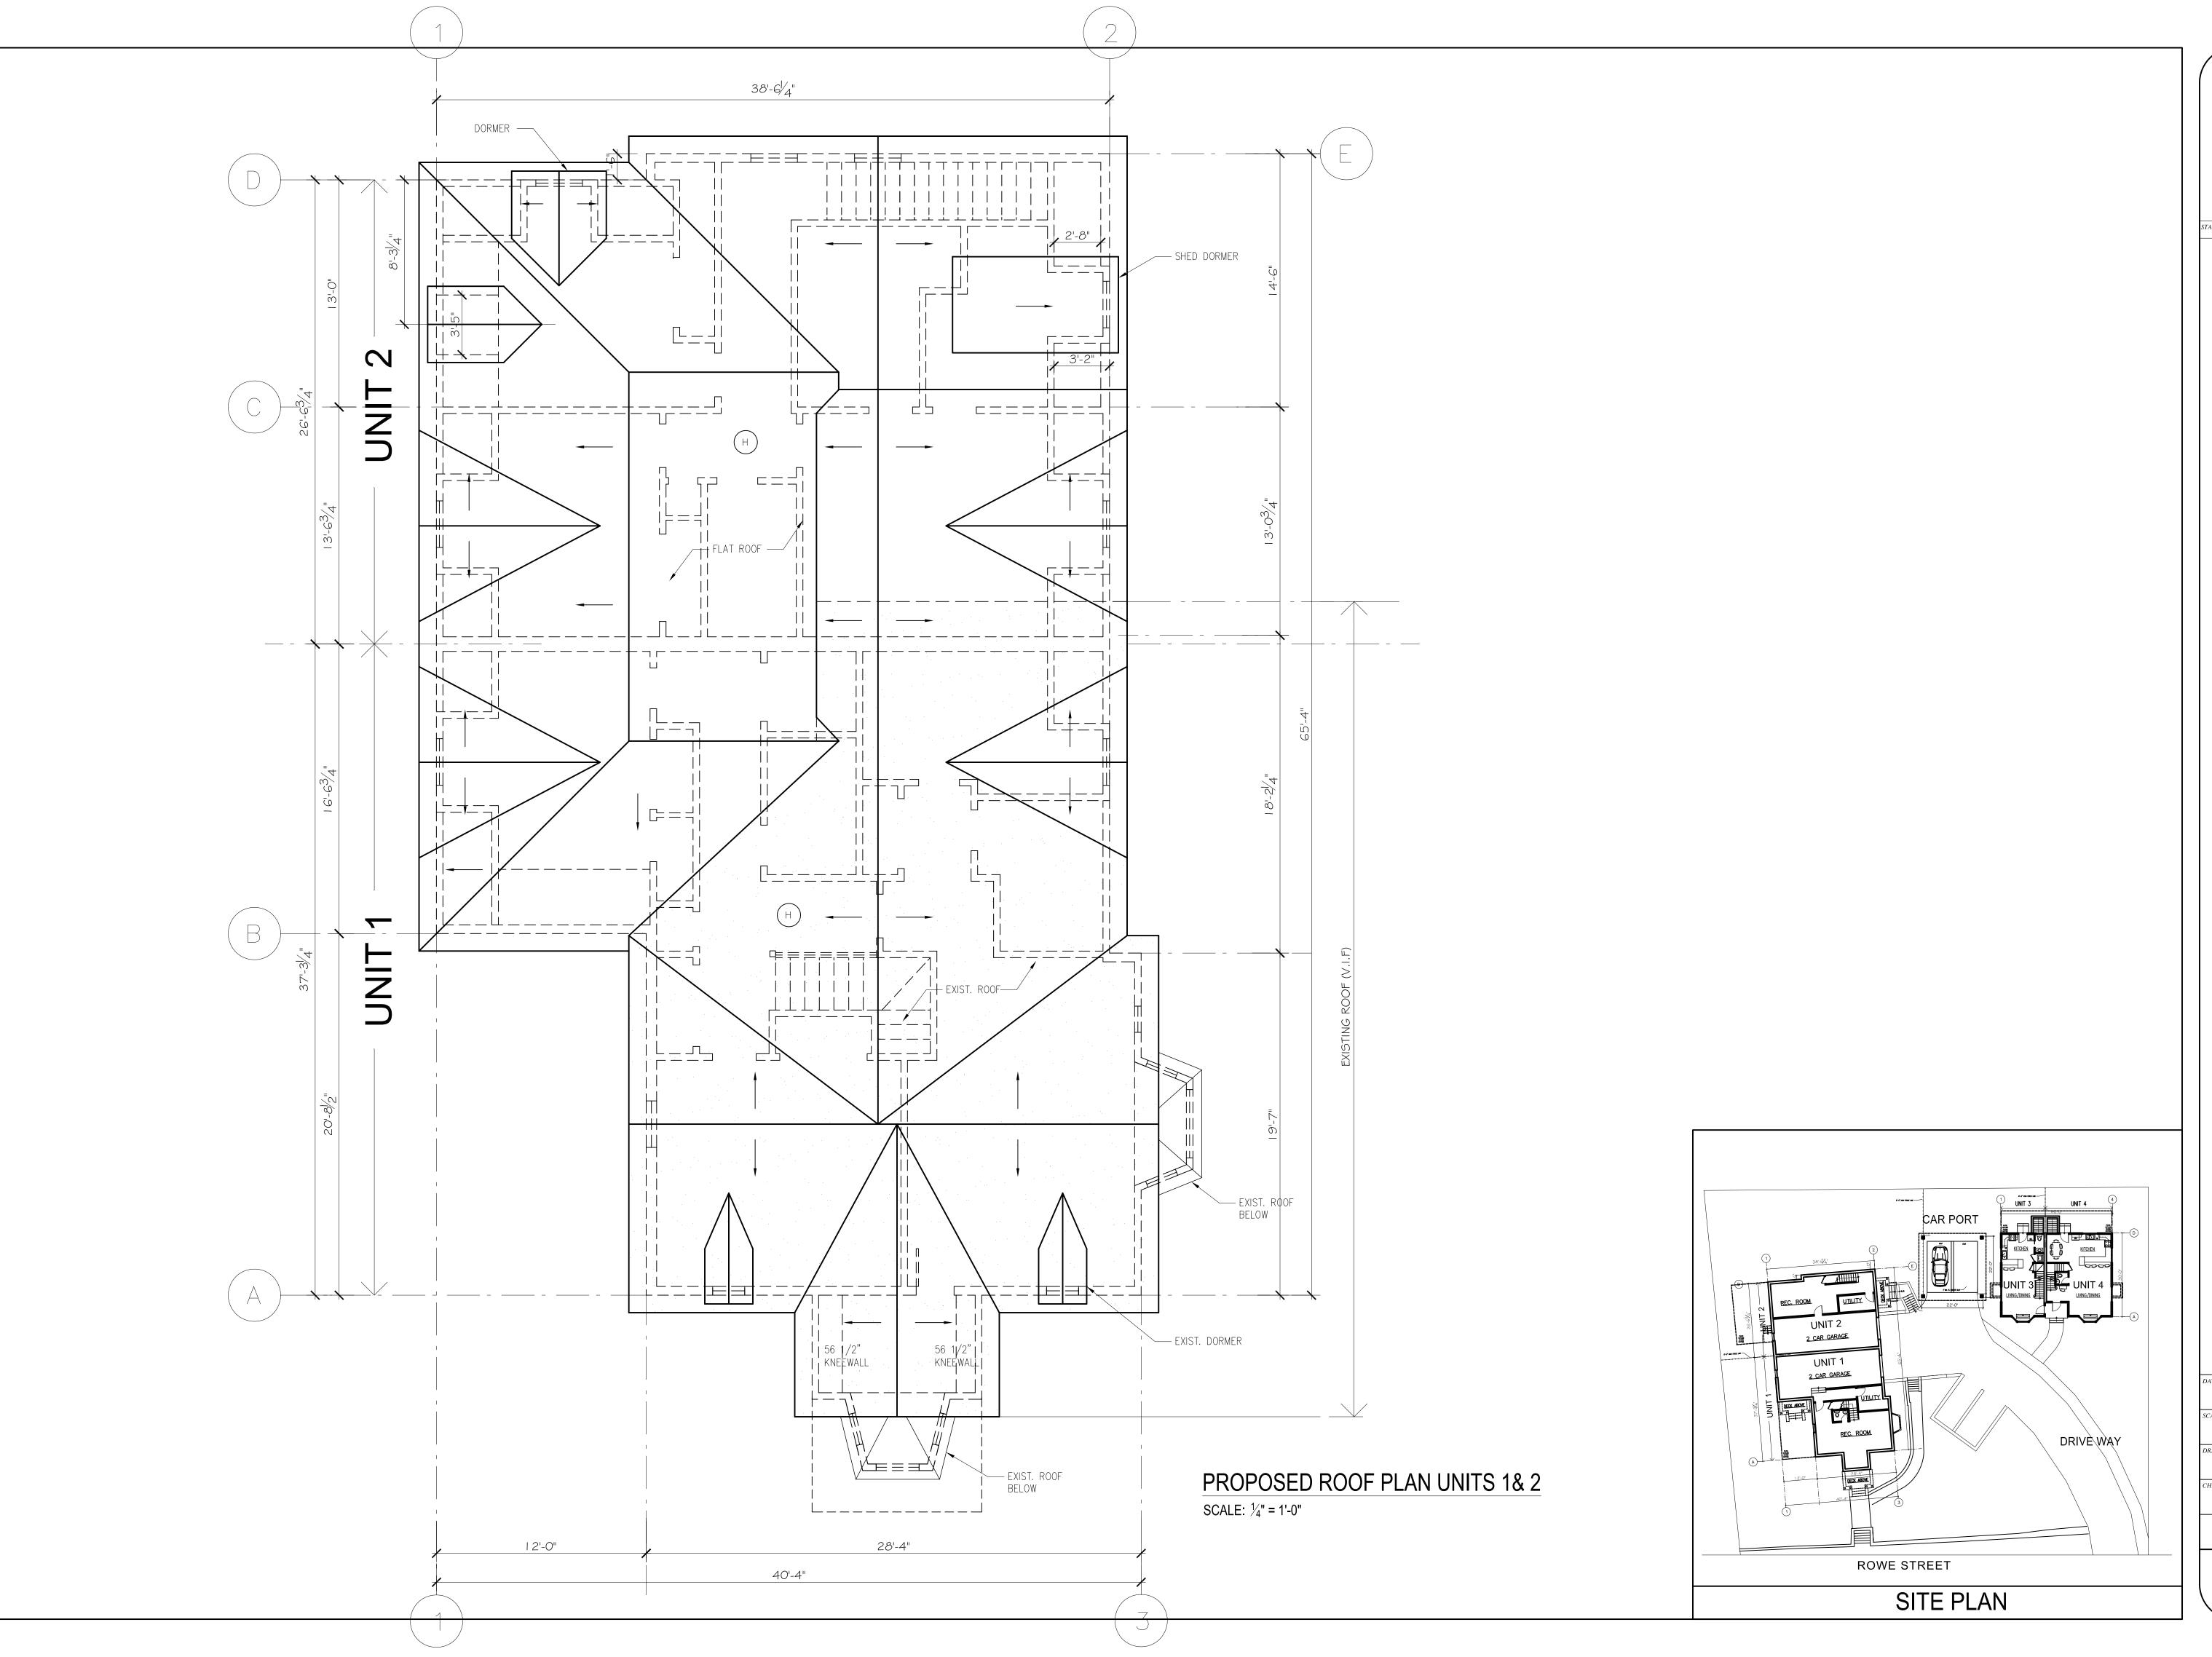

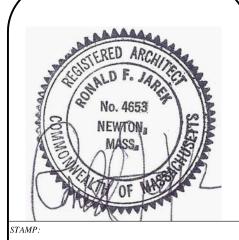



UNITS 1-2 PROPOSED ROOF PLAN 50 - 52 ROWE ST. NEWTON, MA 02466 NEW 2) TWO FAMILY RESIDENCES 50 - 52 ROWE STREET, NEWTON, MA


OWNER: NEW NEWTON, LLC 2193 COMMONWEALTH AVE, BRIGHTON, MA 02135 Architect

487 Watertown Street Newtonville, MA 02460 Ronald F. Jarek, April 28, 2016 AS NOTED

DRAWN BY: CHECKED BY:

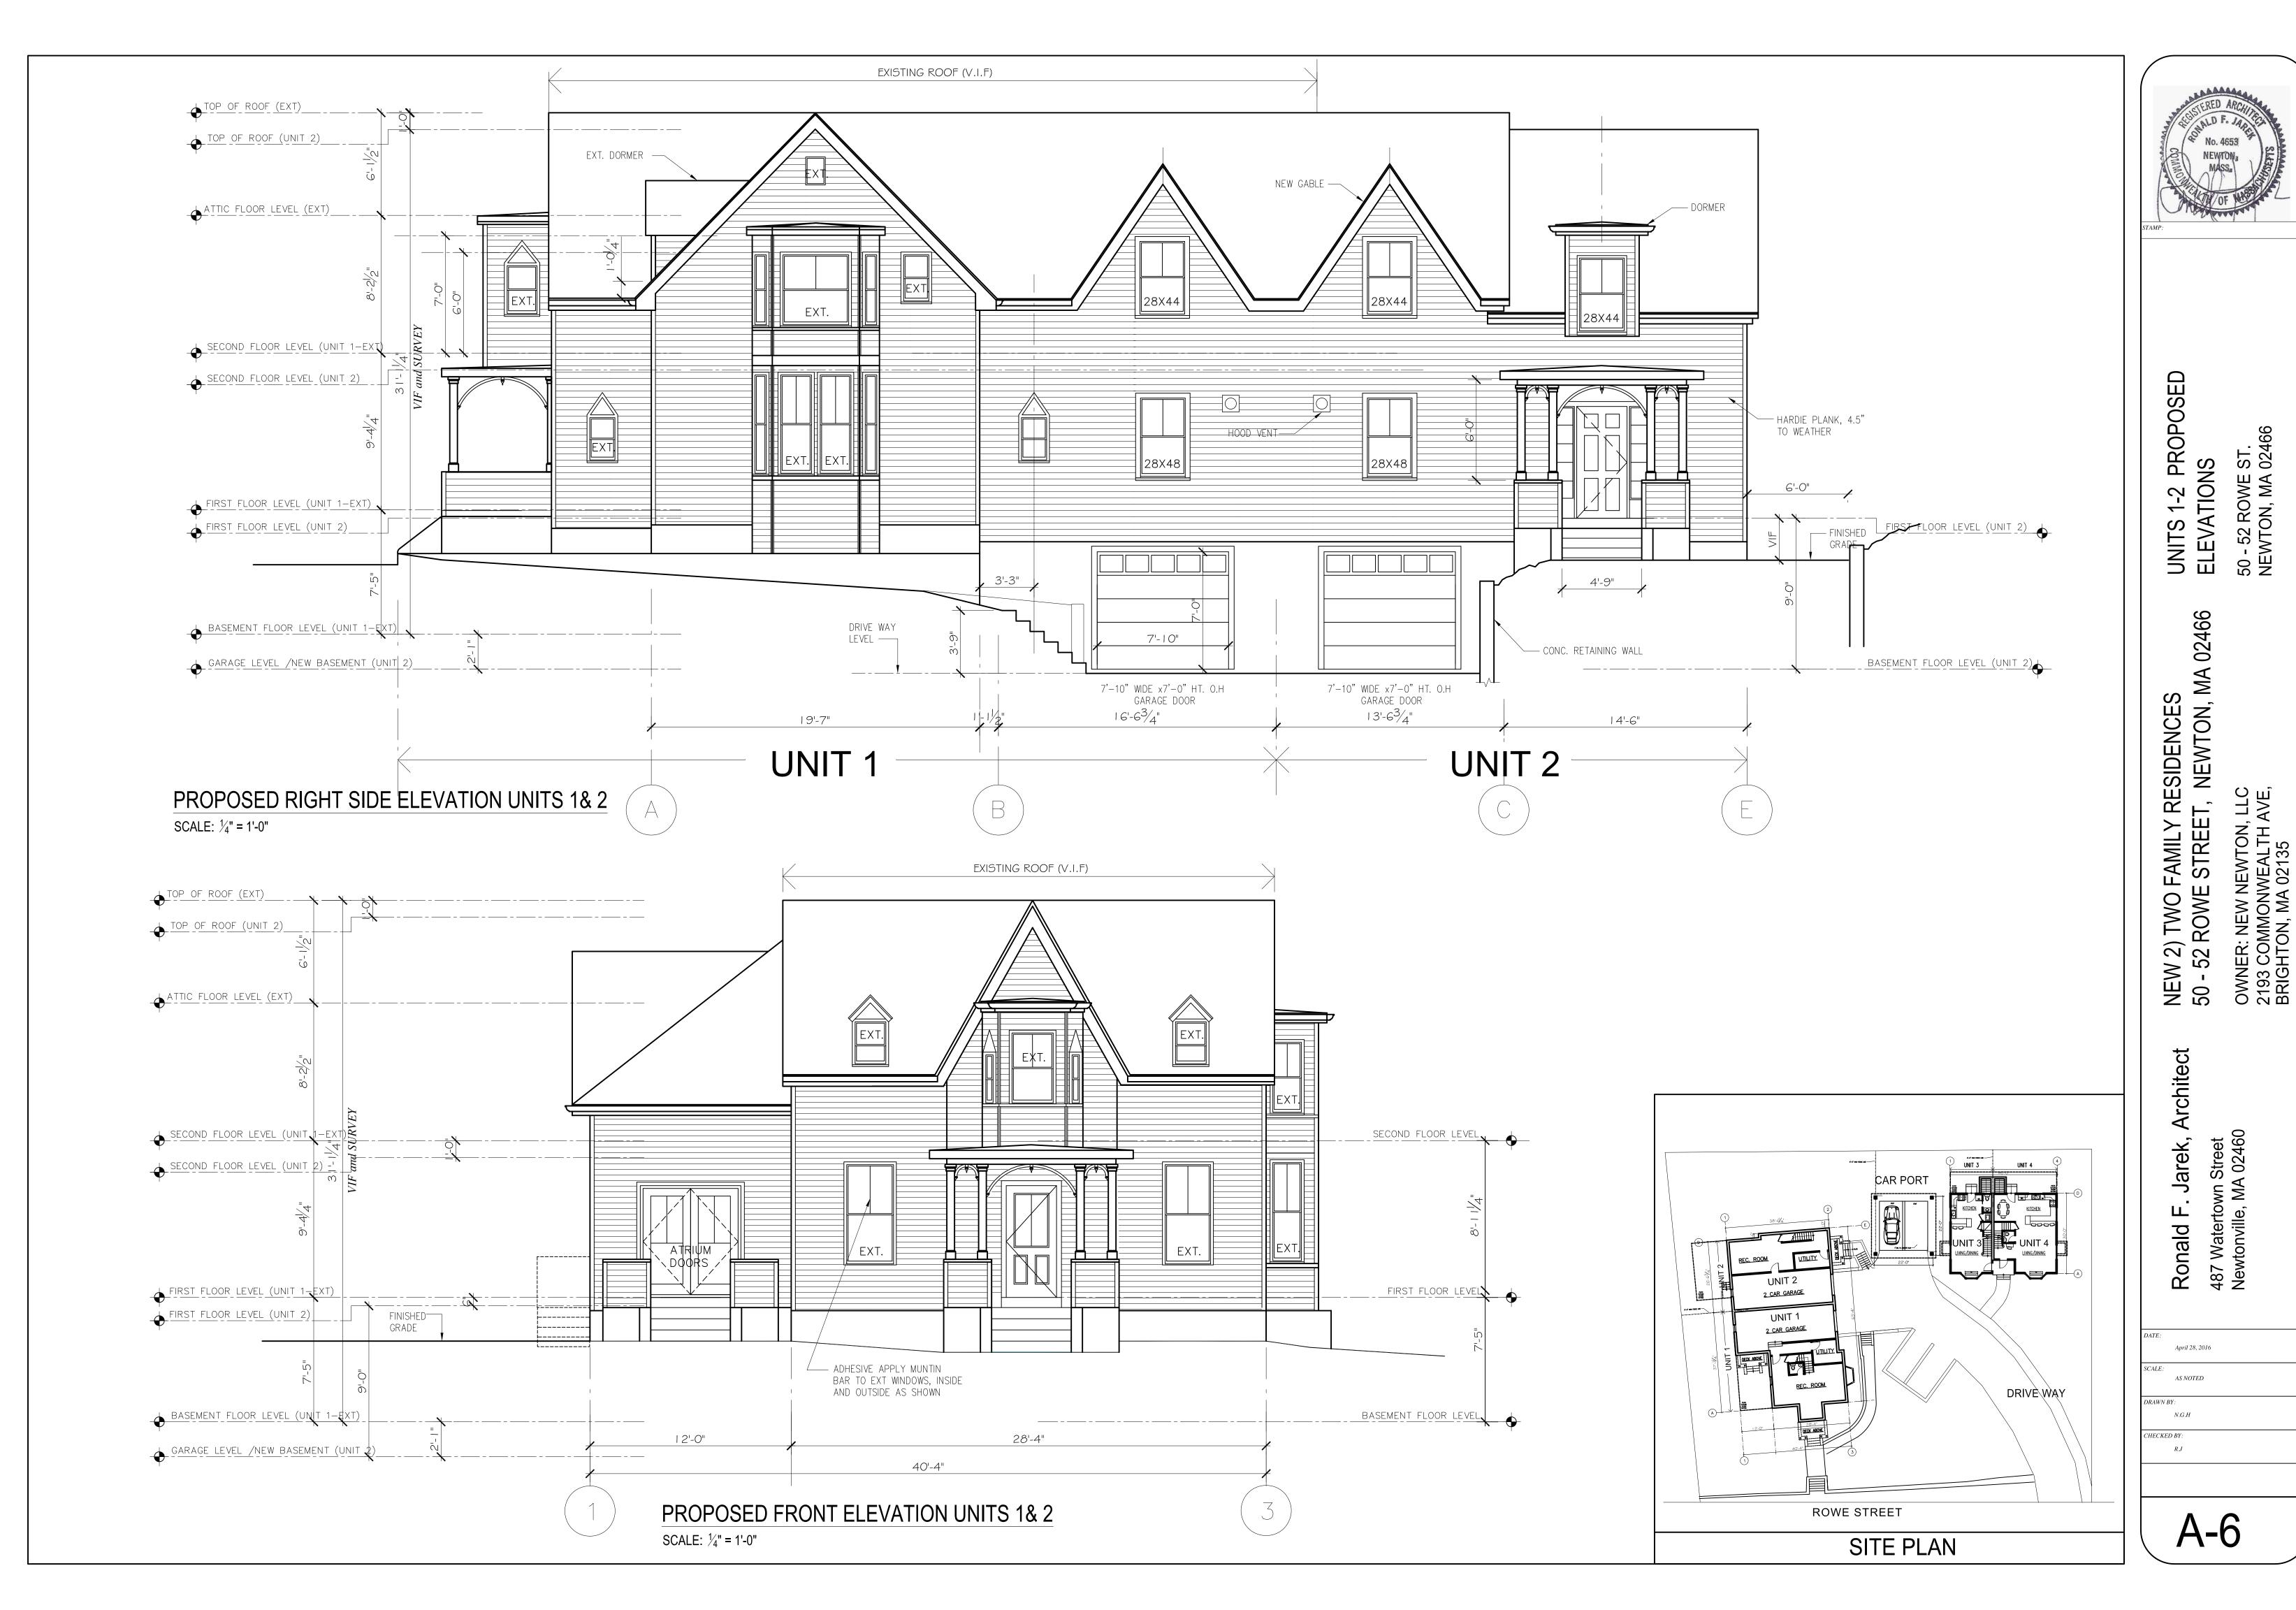

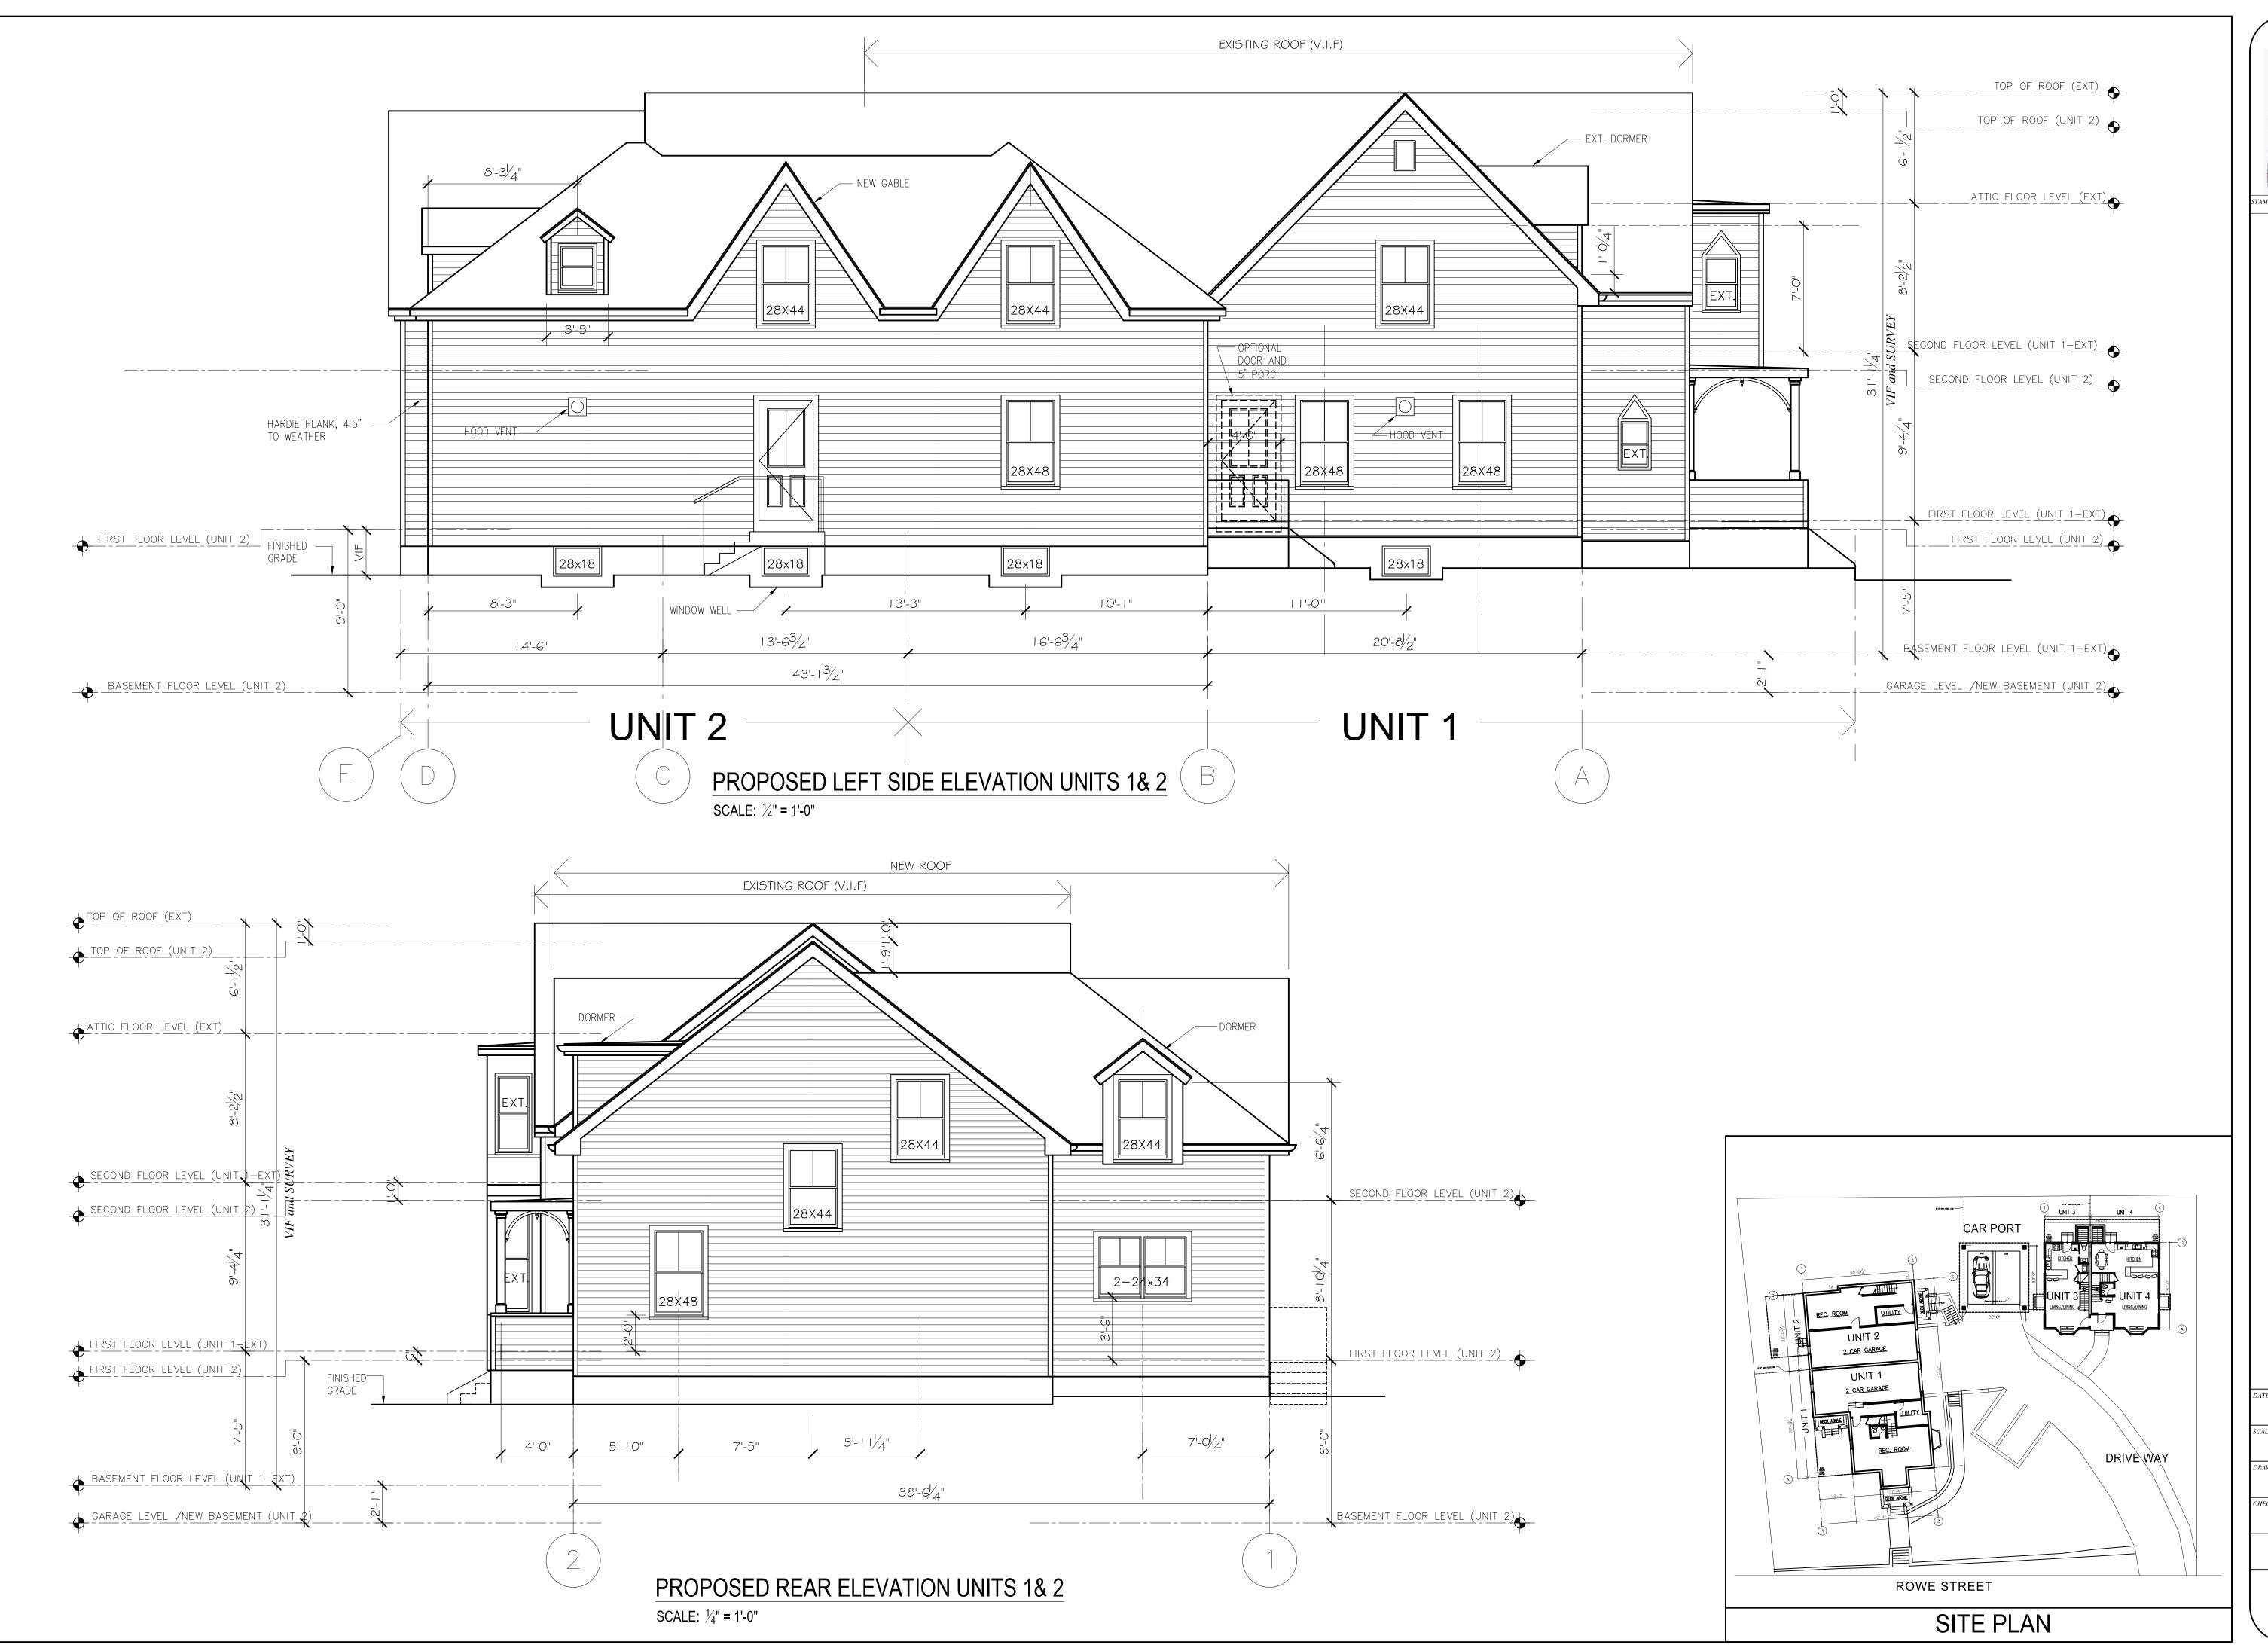

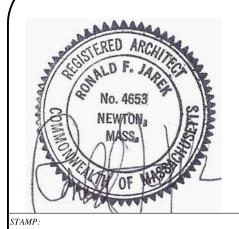

UNITS 1-2 PROPOSED ELEVATIONS


50 - 52 ROWE ST. NEWTON, MA 02466

NEW 2) TWO FAMILY RESIDENCES 50 - 52 ROWE STREET, NEWTON, MA Architect

OWNER: NEW NEWTON, LLC 2193 COMMONWEALTH AVE, BRIGHTON, MA 02135


487 Watertown Street Newtonville, MA 02460 Ronald F. Jarek,


April 28, 2016 DRAWN BY: CHECKED BY:

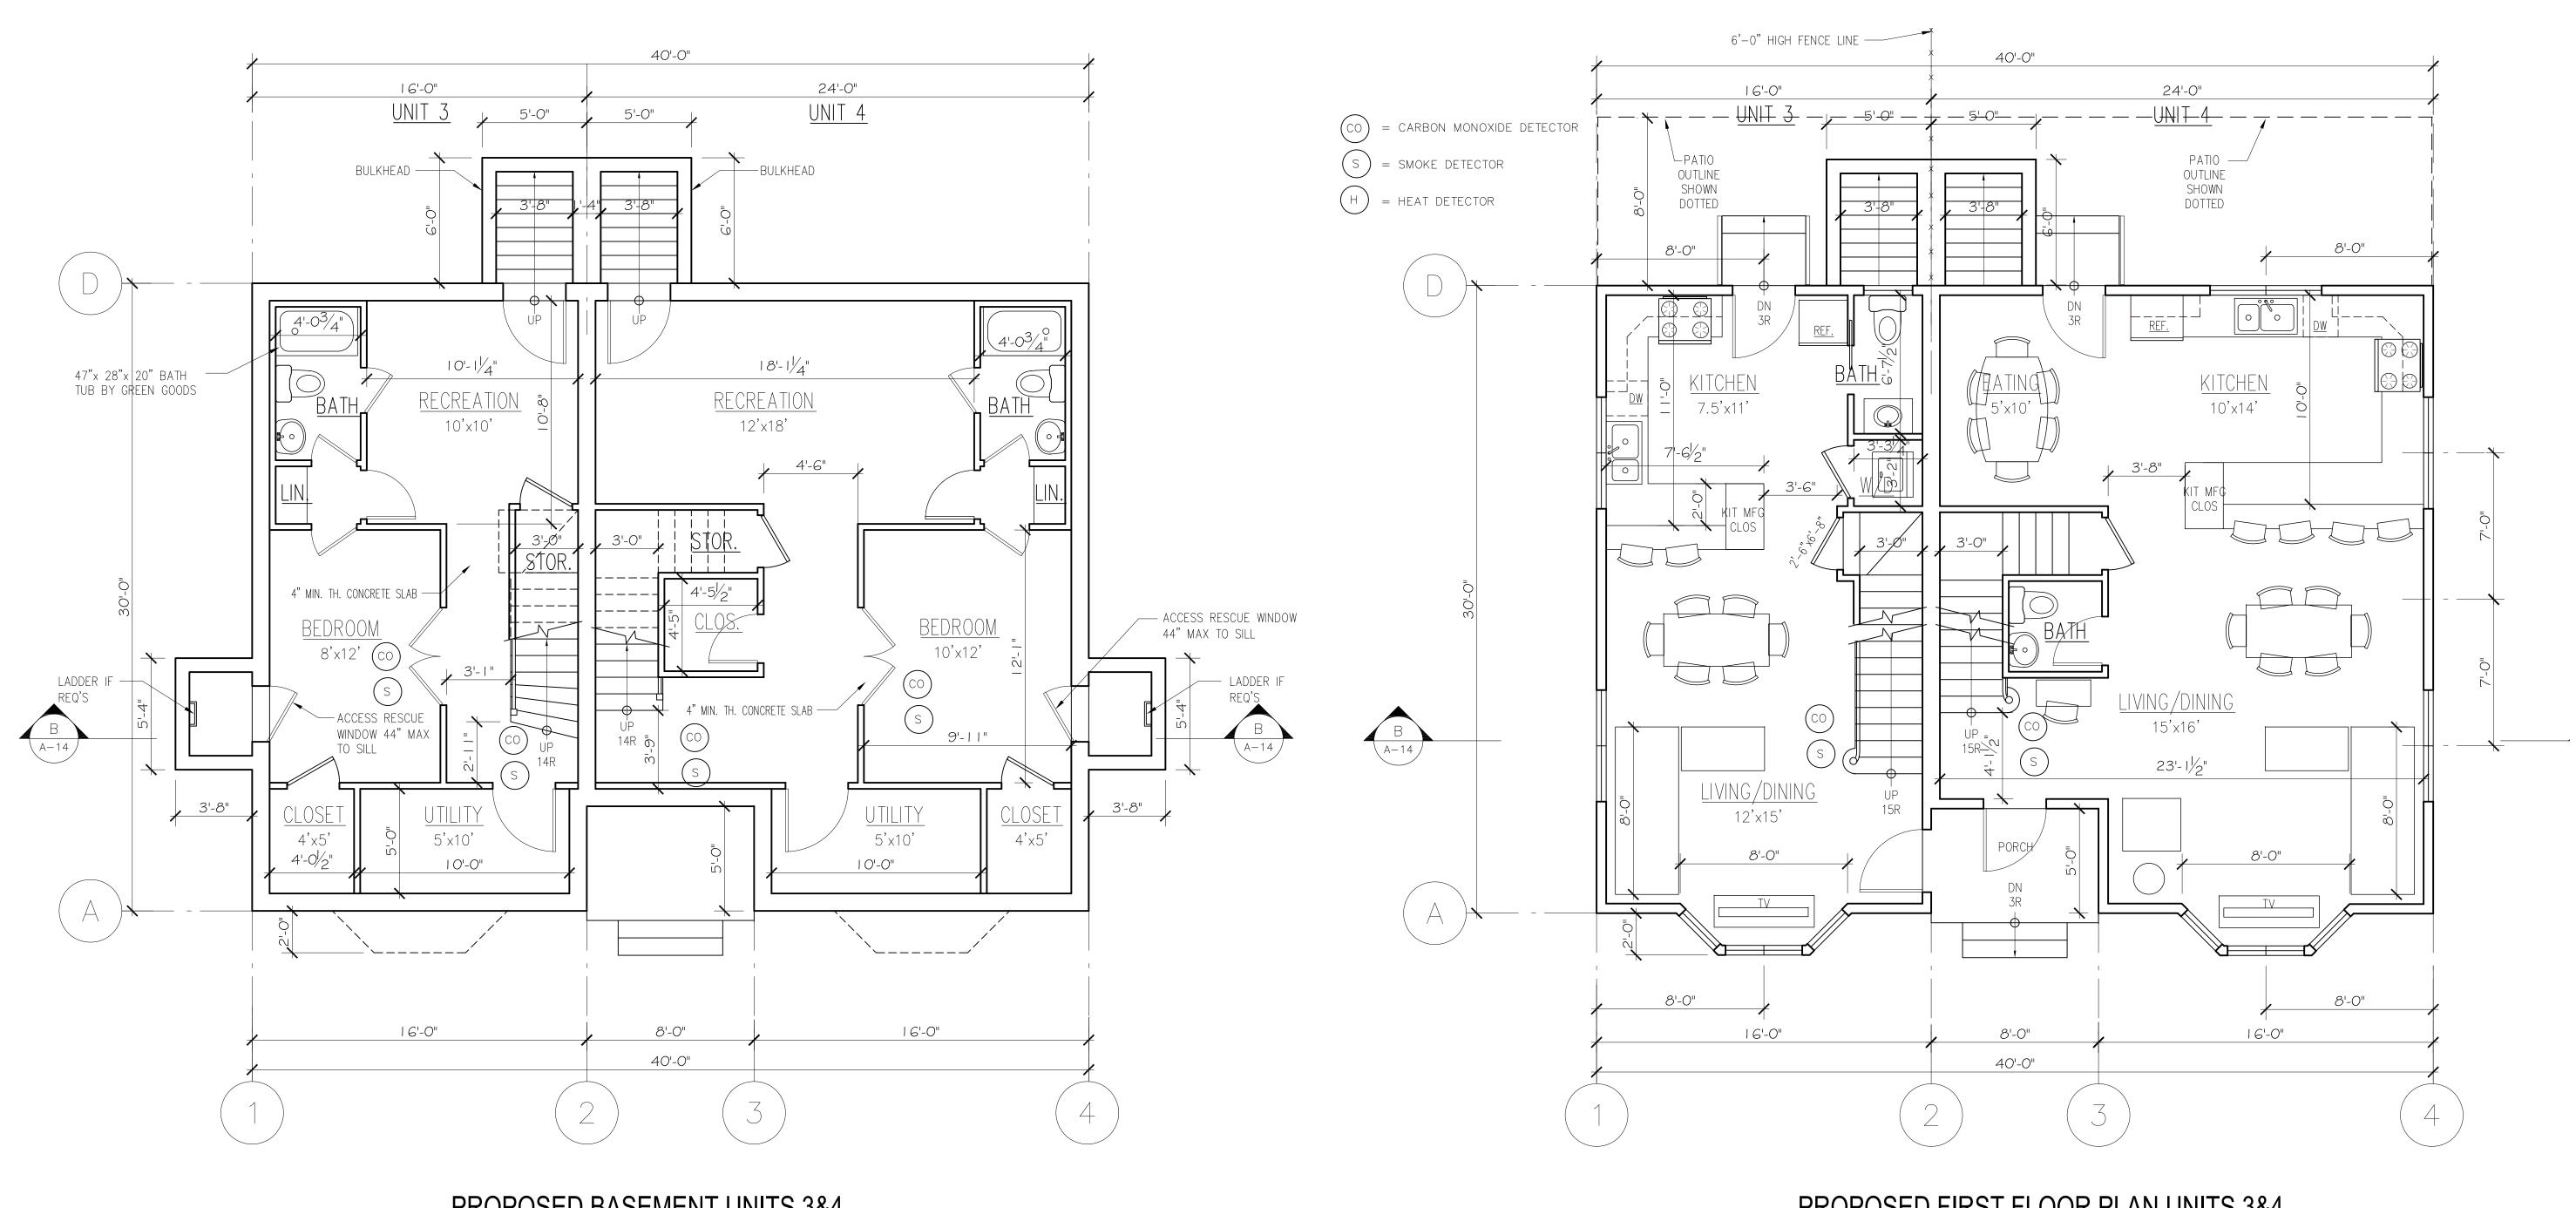

PROPOSED BASEMENT UNITS 3&4 SCALE: 1/4" = 1'-0"

PROPOSED FIRST FLOOR PLAN UNITS 3&4 SCALE: 1/4" = 1'-0"

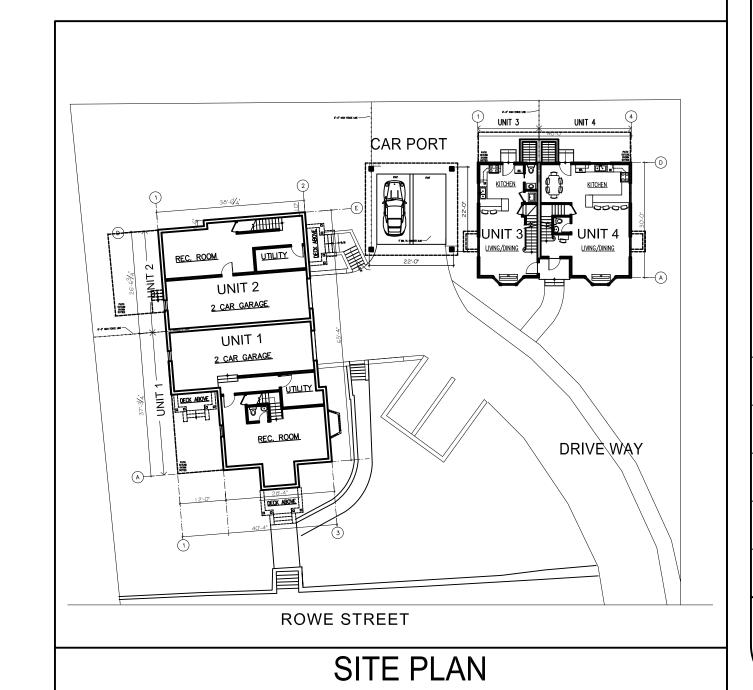

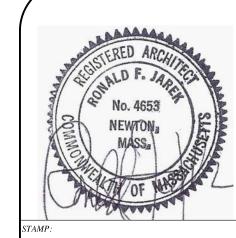


UNITS 3-4 PROPOSED BASEMENT & FIRST FLOOR

50 - 52 ROWE ST. NEWTON, MA 02466


NEW 2) TWO FAMILY RESIDENCES 50 - 52 ROWE STREET, NEWTON, MA OWNER: NEW NEWTON, LLC 2193 COMMONWEALTH AVE, BRIGHTON, MA 02135

Architect 487 Watertown Street Newtonville, MA 02460 Ronald F. Jarek,


April 28, 2016 AS NOTED DRAWN BY:

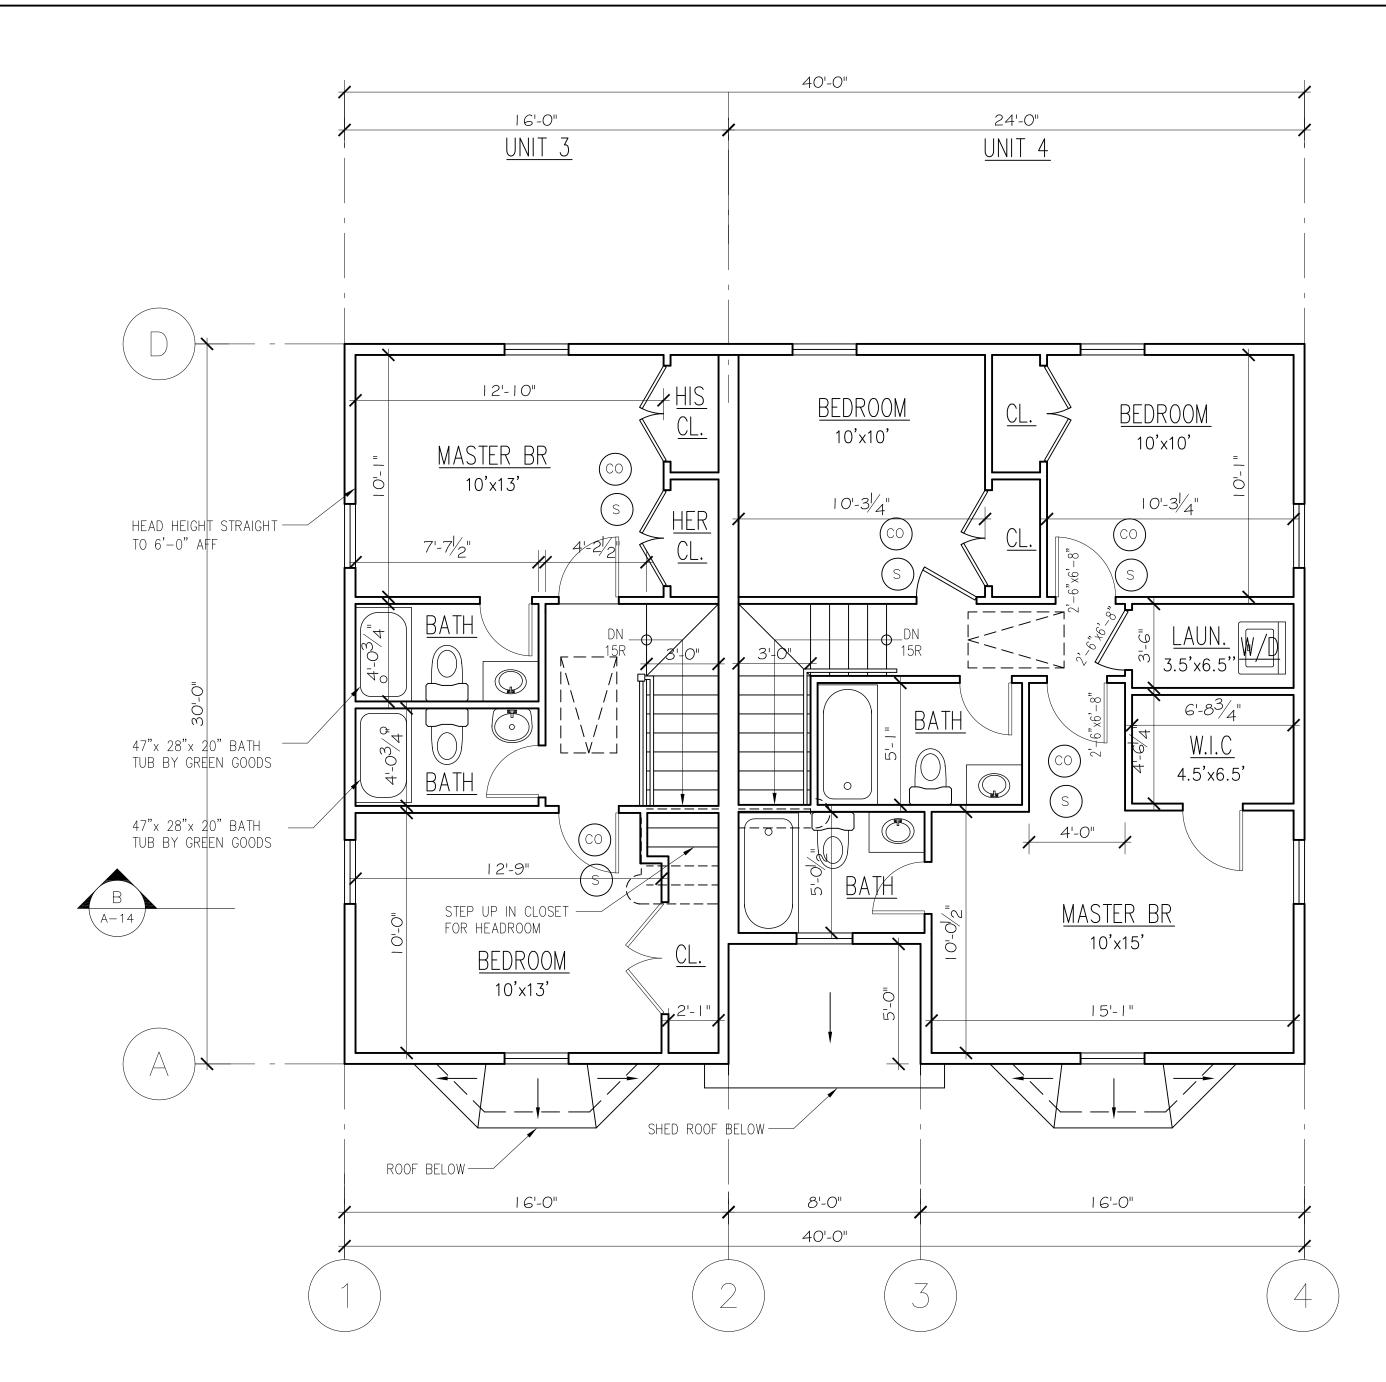


PROPOSED SECOND FLOOR PLAN UNITS 3&4 SCALE: 1/4" = 1'-0"

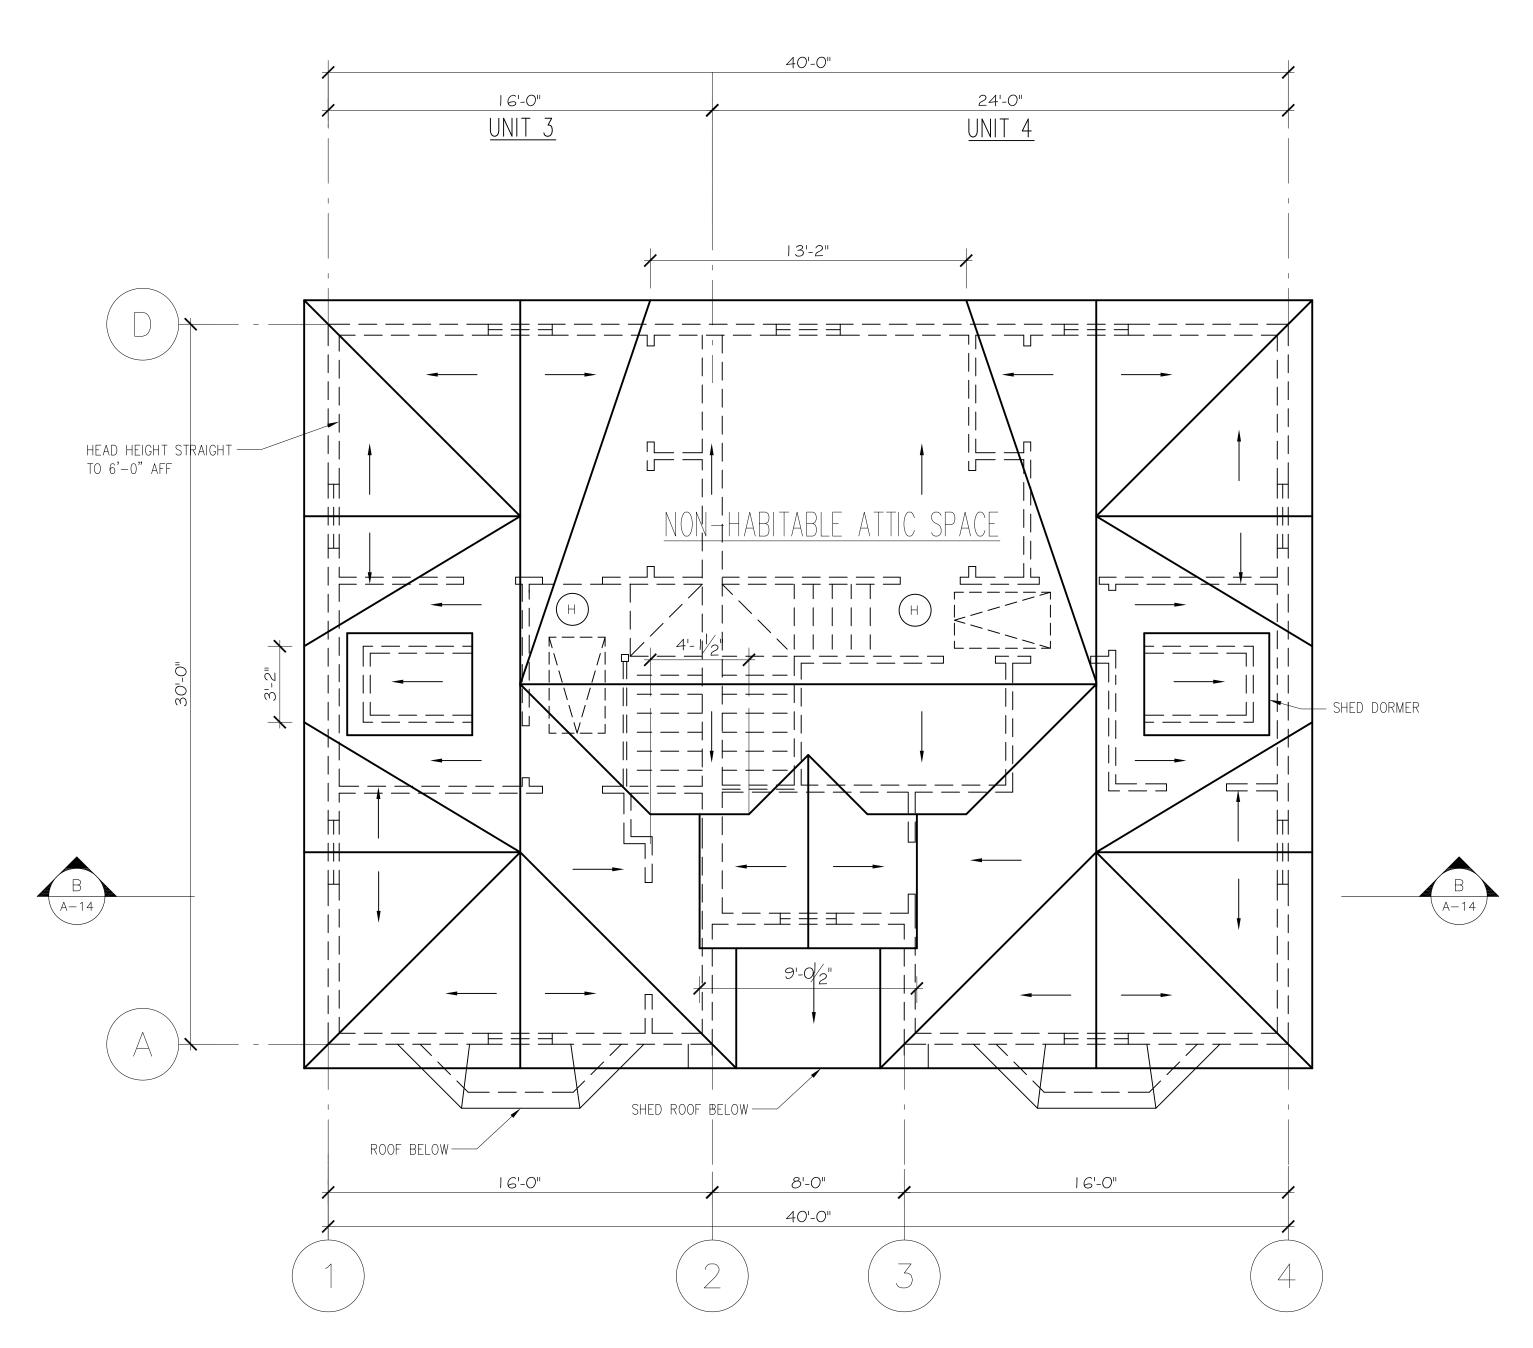

PROPOSED ROOF PLAN UNITS 3&4 SCALE: 1/4" = 1'-0"

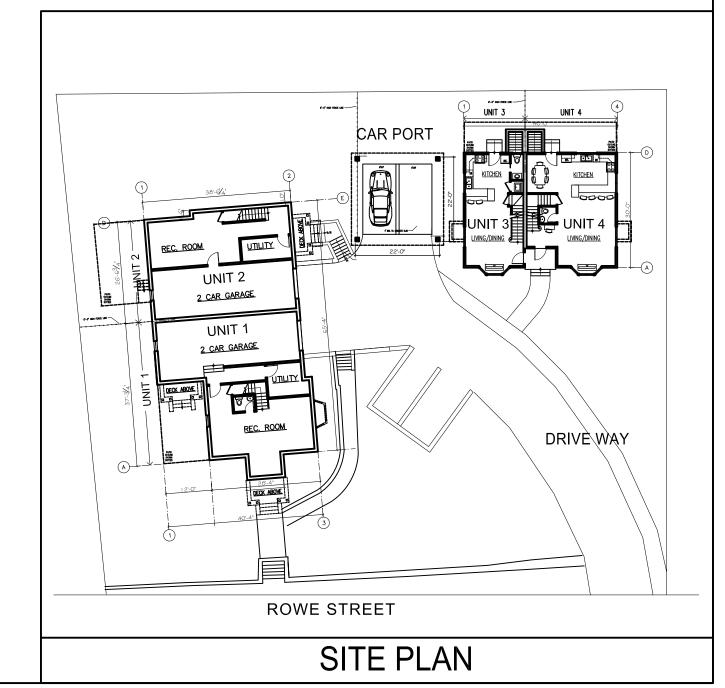

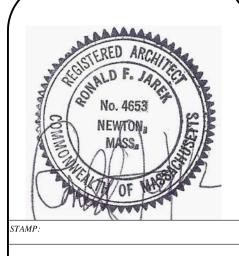

NEW 2) TWO FAMILY RESIDENCES 50 - 52 ROWE STREET, NEWTON, MA

UNITS 3-4 PROPOSED SECOND & ROOF FLOOR


50 - 52 ROWE ST. NEWTON, MA 02466

OWNER: NEW NEWTON, LLC 2193 COMMONWEALTH AVE, BRIGHTON, MA 02135

Architect 487 Watertown Street Newtonville, MA 02460 Jarek, Ronald F.

April 28, 2016 DRAWN BY:



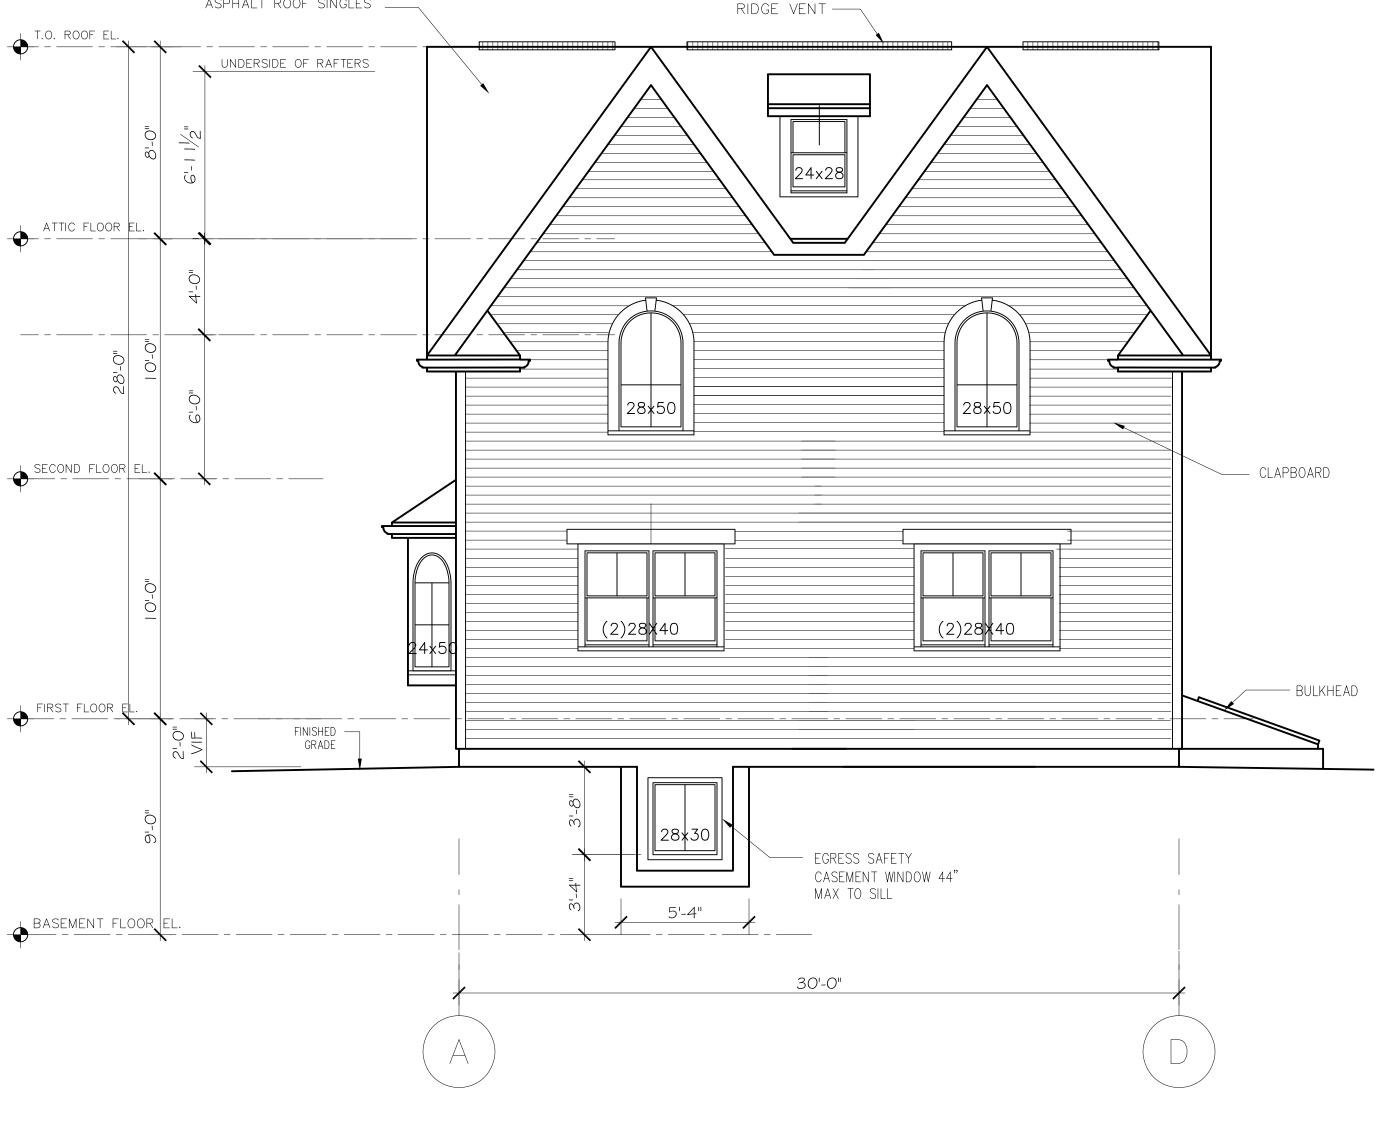


30 YEAR ARCHITECTURAL ASPHALT ROOF SINGLES ___


PROPOSED FRONT ELEVATION UNITS 3&4

SCALE: 1/4" = 1'-0"

PROPOSED RIGHT SIDE ELEVATION UNITS 3&4

SCALE: 1/4" = 1'-0"

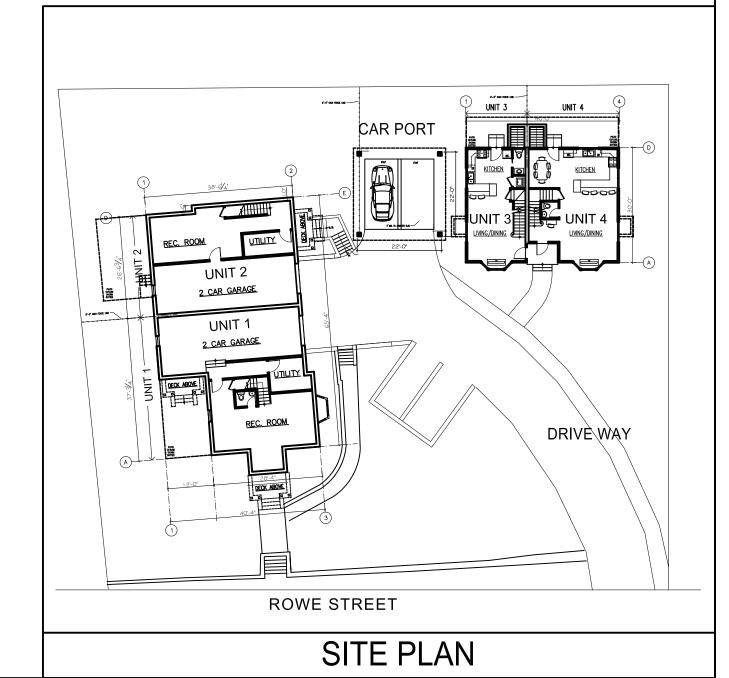

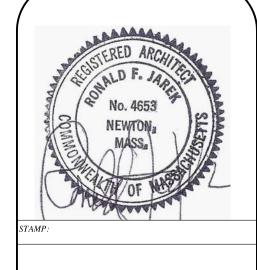

UNITS 3-4 PROPOSED FRONT & RIGHT SIDE ELEVATION

50 - 52 ROWE ST. NEWTON, MA 02466

NEW 2) TWO FAMILY RESIDENCES
50 - 52 ROWE STREET, NEWTON, MA 0
2193 COMMONWEALTH AVE,
BRIGHTON, MA 02135

Ronald F. Jarek, Architect
487 Watertown Street

DATE:

April 28, 2016

SCALE:


AS NOTED

DRAWN BY:

N.G.H

CHECKED BY:

R.J

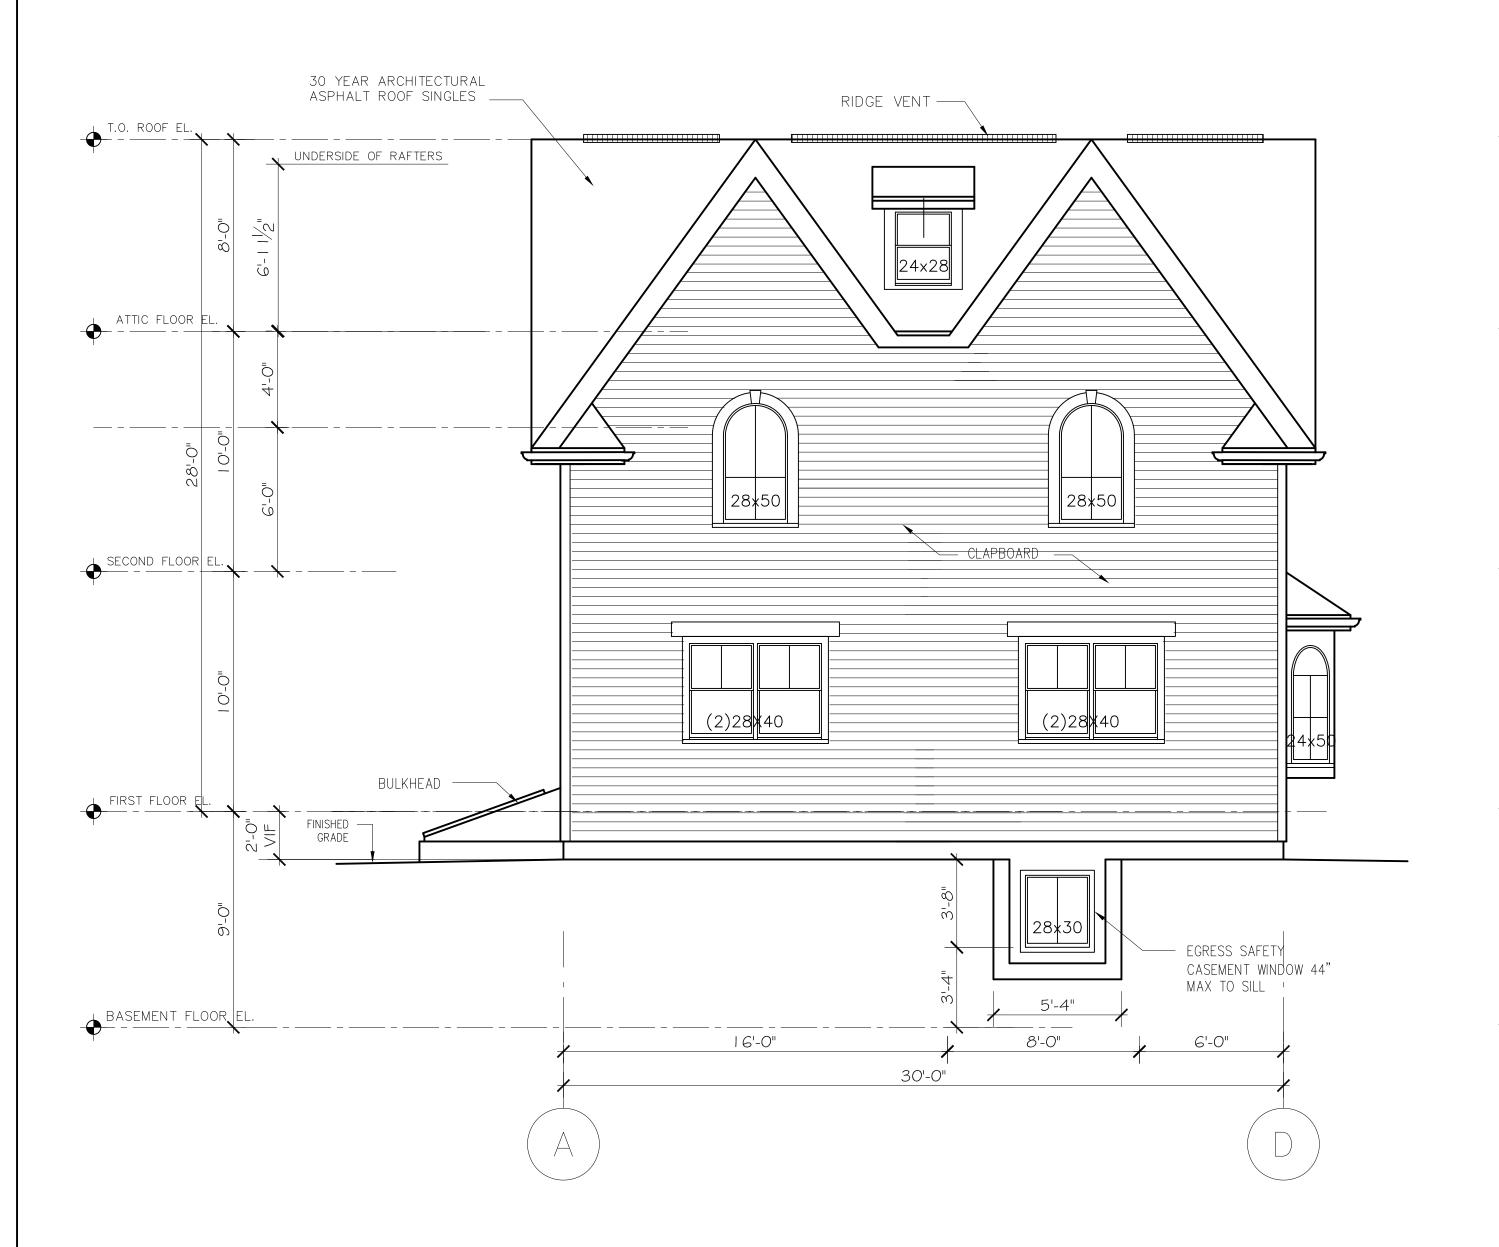



PROPOSED LEFT SIDE ELEVATION UNITS 3&4

SCALE: 1/4" = 1'-0"

PROPOSED REAR ELEVATION UNITS 3&4 SCALE: 1/4" = 1'-0"

CAR PORT

UNIT 2
2.086.GABAGE

UNIT 1
2.086.GABAGE

ROWE STREET

SITE PLAN

NEW 2) TWO FAMILY RESIDENCES 50 - 52 ROWE STREET, NEWTON, MA 03

UNITS 3-4 PROPOSED LEFT SIDE & REAR ELEVATIONS

50 - 52 ROWE ST. NEWTON, MA 02466

d F. Jarek, Architect NEW 2) TV fertown Street own Street own Street

Ronald F. Jarek,


487 Watertown Street
Newtonville, MA 02460

DATE:
April 28, 2016

SCALE:
AS NOTED


DRAWN BY:
N.G.H

CHECKED BY:
R.J

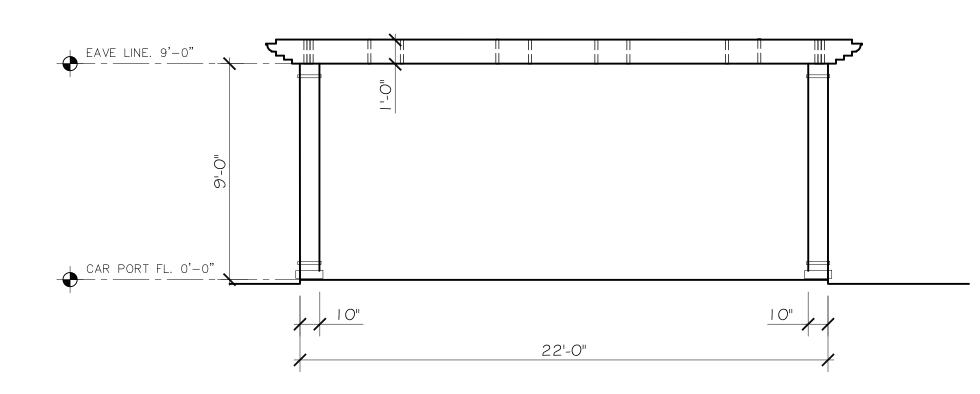


PROPOSED FRONT & REAR ELEVATION

SCALE: 1/4" = 1'-0"

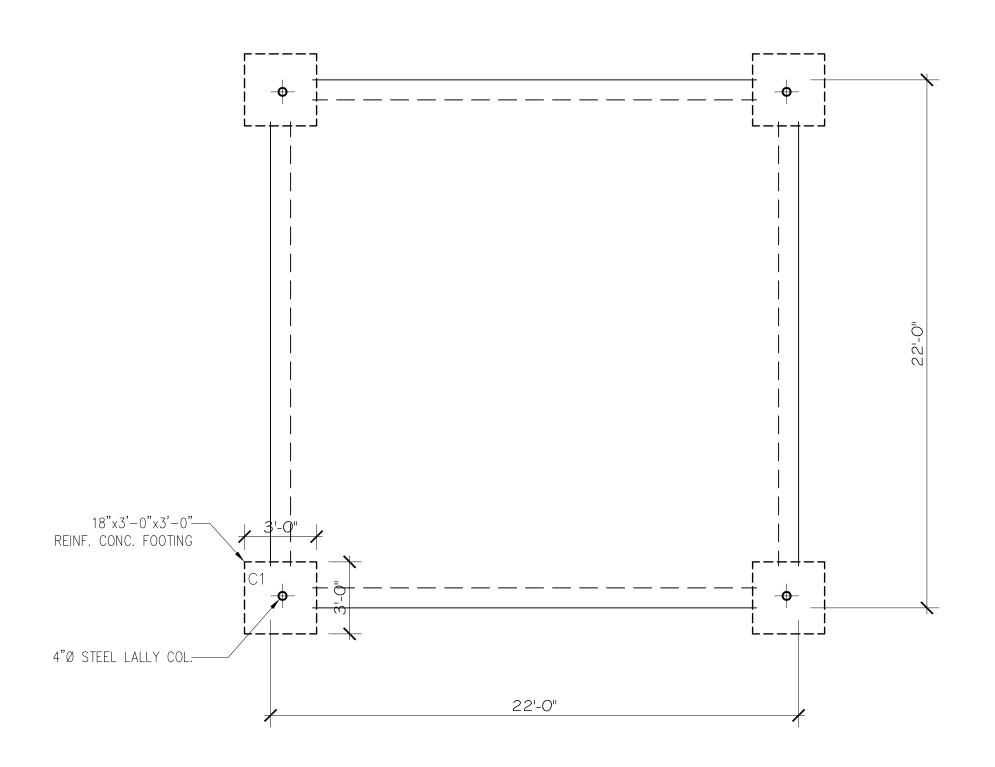


PROPOSED FOUNDATION PLAN

SCALE: ½" = 1'-0"

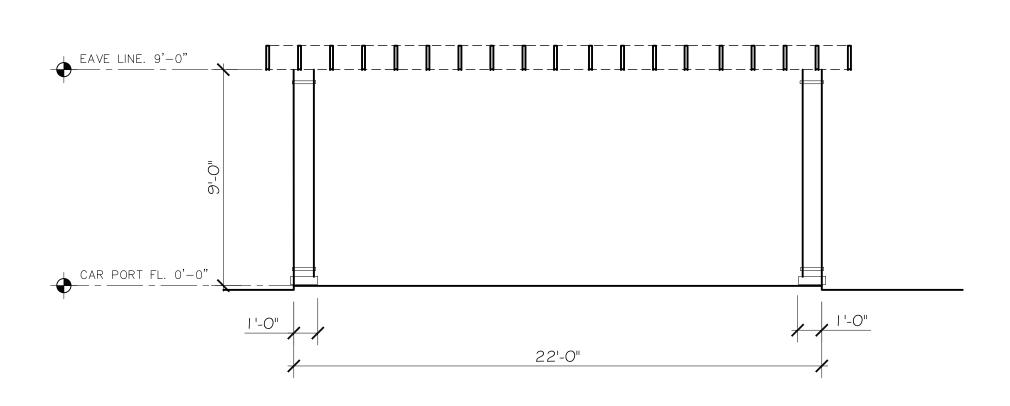


PROPOSED RIGHT & LEFT SIDE ELEVATION

SCALE: 1/4" = 1'-0"

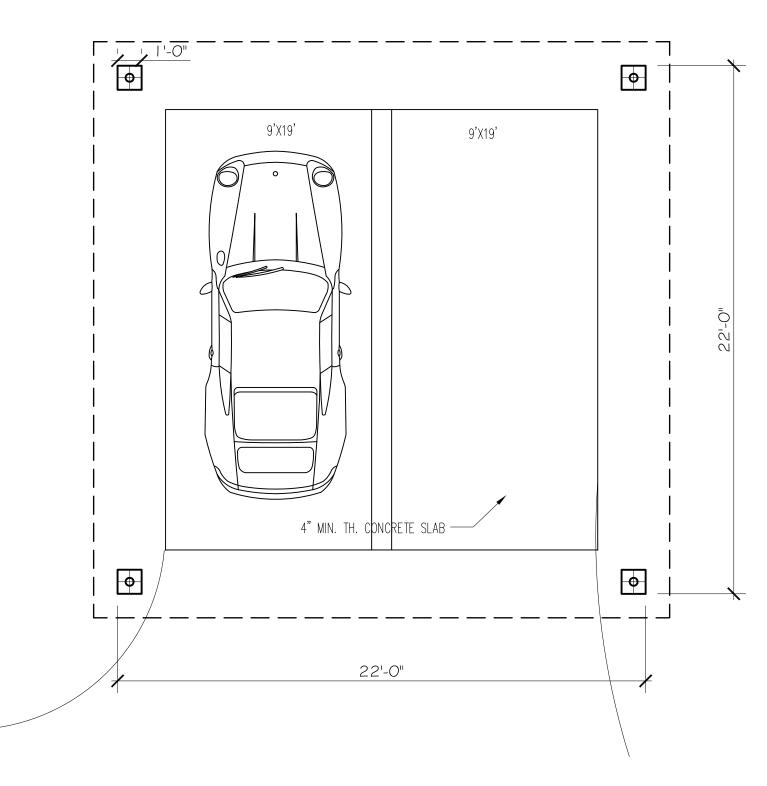


PROPOSED GROUND PLAN


SCALE: 1/4" = 1'-0"

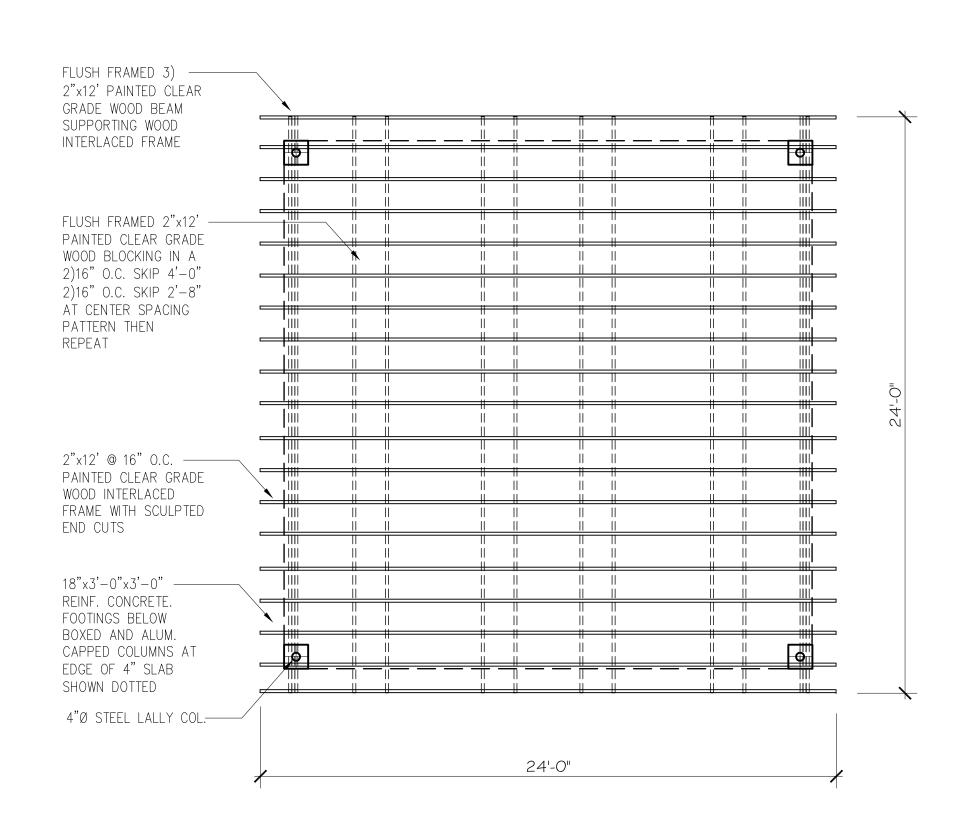

PROPOSED ROOF PLAN

SCALE: 1/4" = 1'-0"

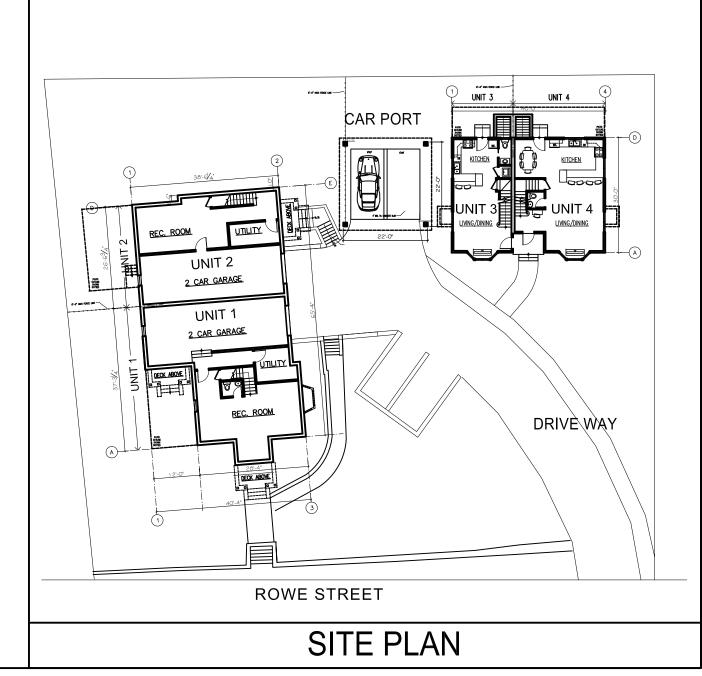

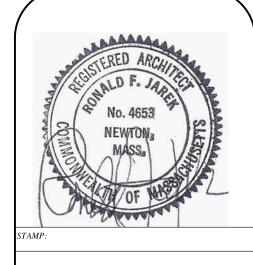

3-4 PROPOSED)RT

50 - 52 ROWE ST. NEWTON, MA 0246

NEW 2) TWO FAMILY RESIDENCES
50 - 52 ROWE STREET, NEWTON, MA 0
2193 COMMONWEALTH AVE,
BRIGHTON, MA 02135


Ronald F. Jarek, Architect

DATE:
April 28, 2016

SCALE:
AS NOTED

DRAWN BY:
N.G.H

CHECKED BY:
R.J

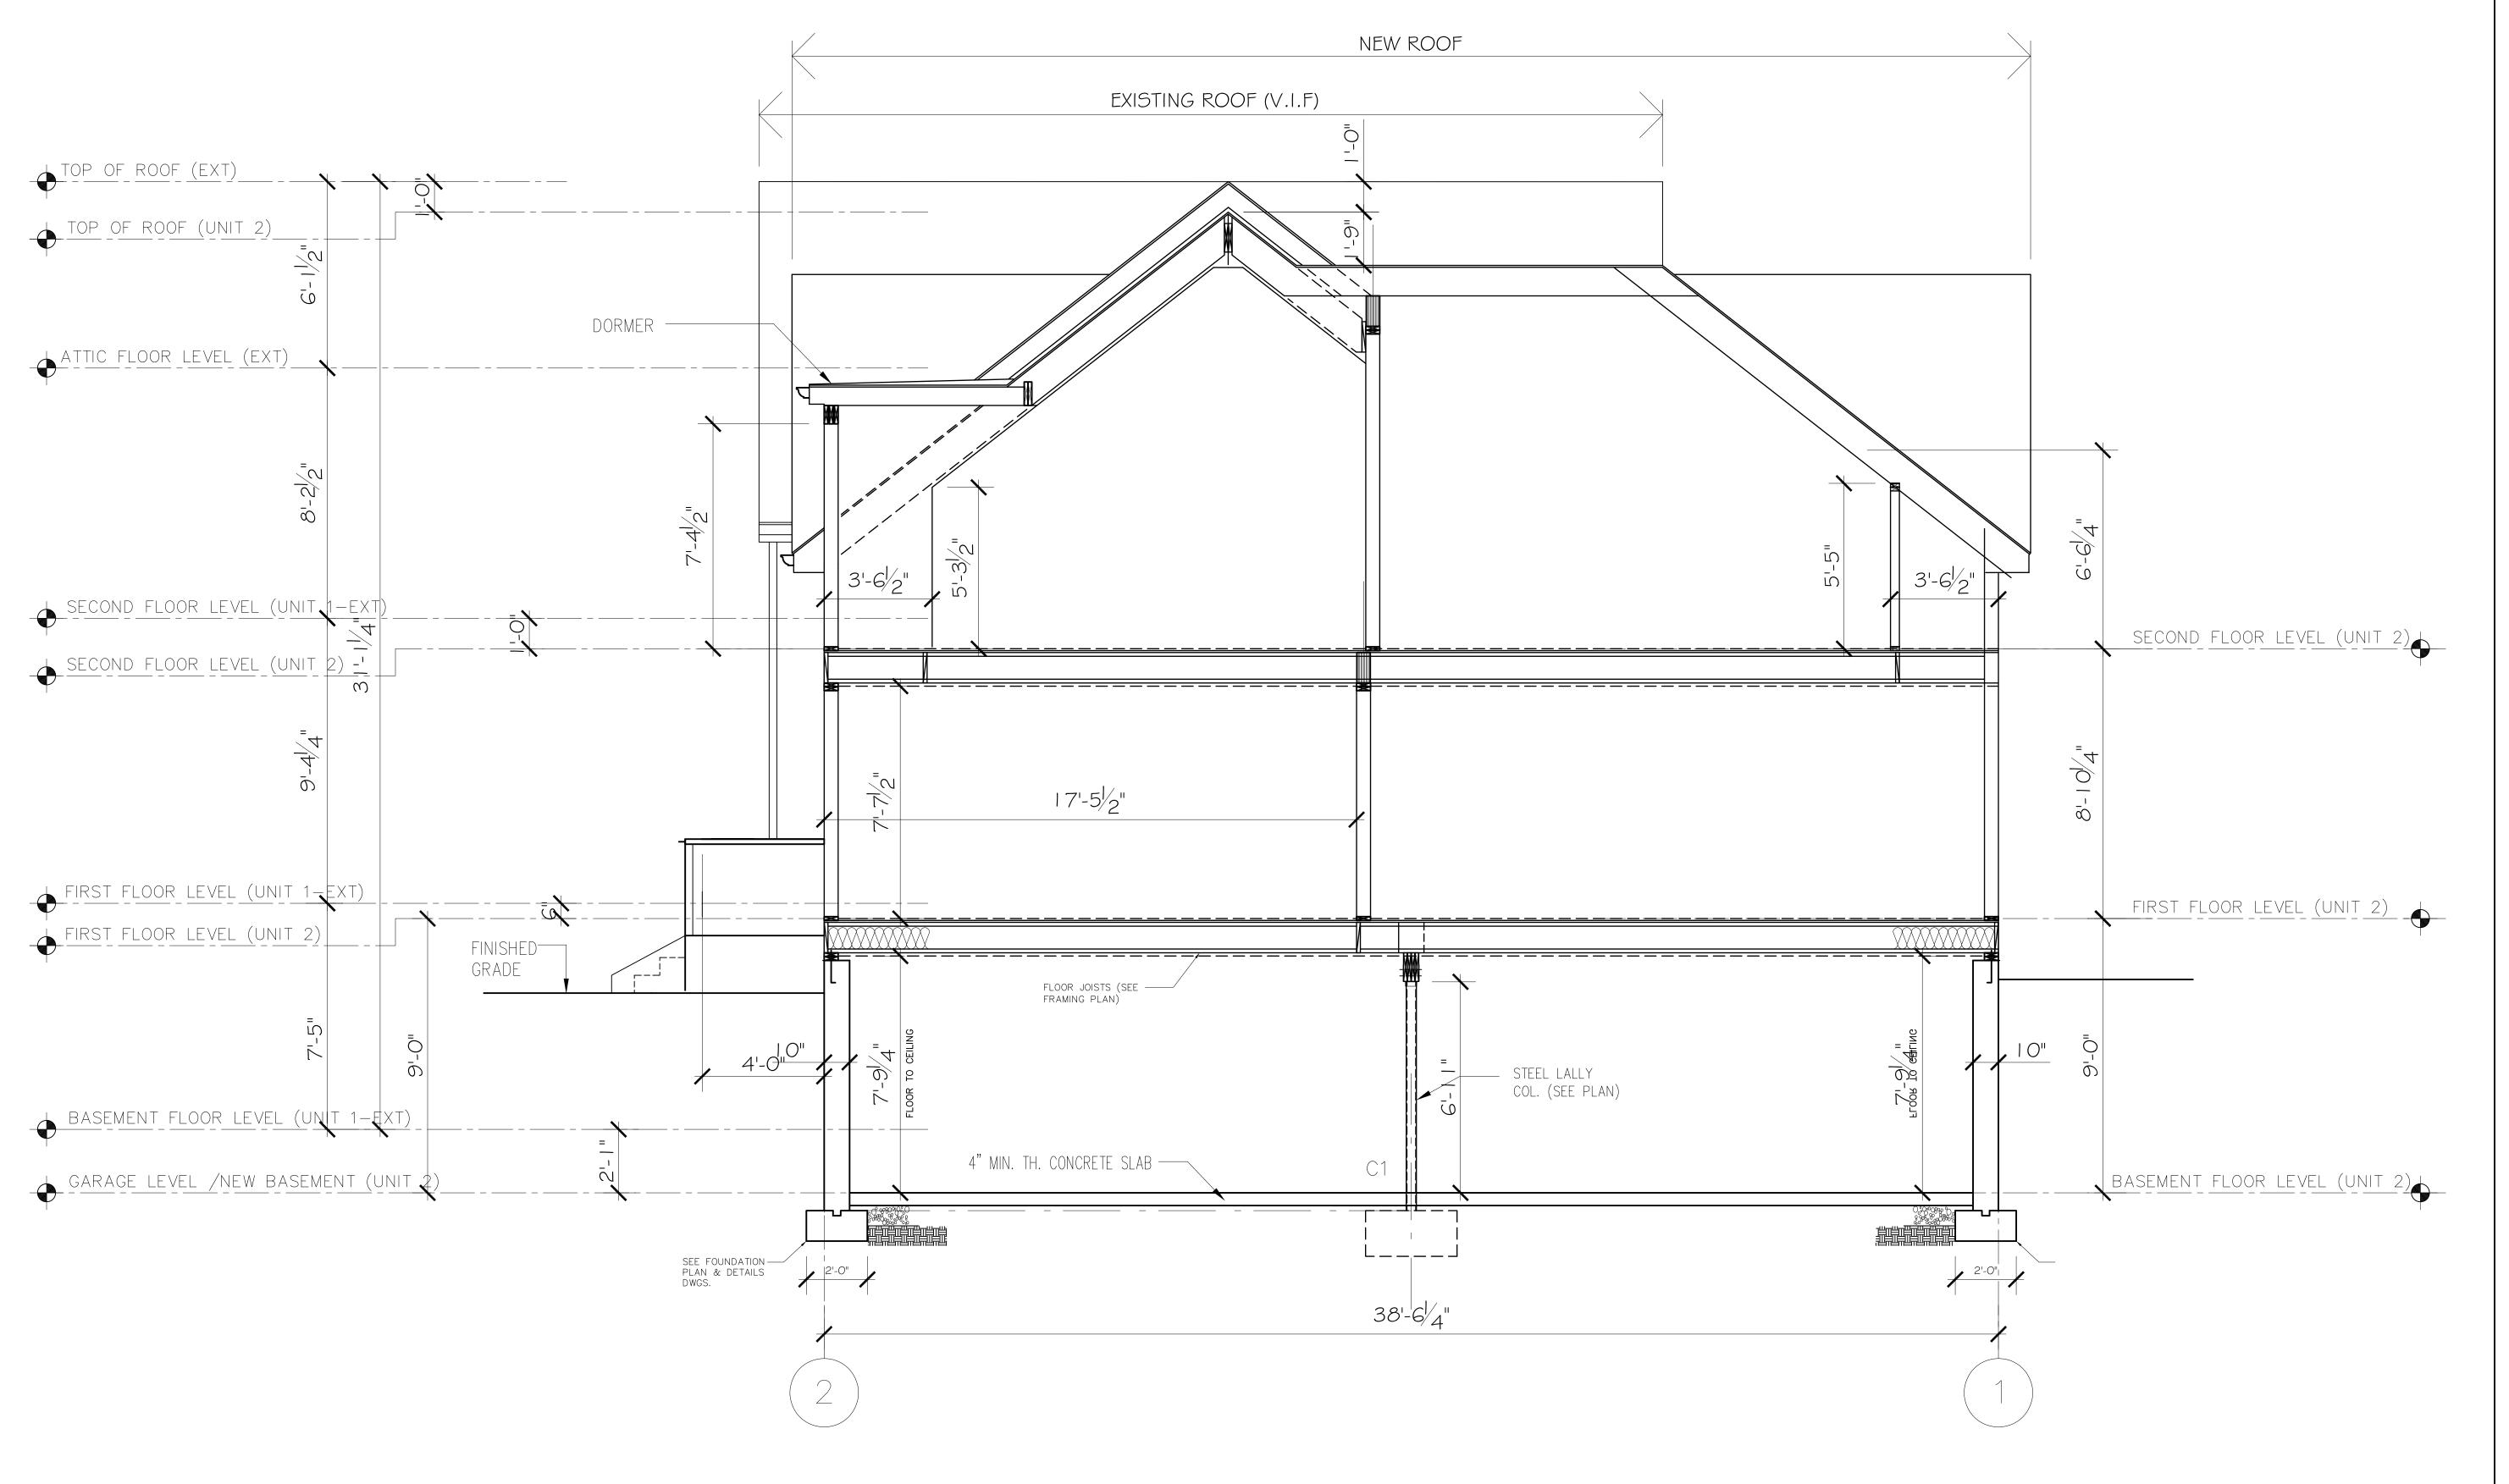

SECTION A-A (UNIT 1-2)

SCALE: 3/8" = 1'-0"

PROPOSED

UNITS 1-2 PR SECTION A-A

NEW 2) TWO FAMILY RESIDENCES 50 - 52 ROWE STREET, NEWTON, MA


OWNER: NEW NEWTON, LLC 2193 COMMONWEALTH AVE, BRIGHTON, MA 02135

50 - 52 ROWE ST. NEWTON, MA 02466

Architect 487 Watertown Street Newtonville, MA 02460 Ronald F. Jarek,

April 28, 2016

DRAWN BY: CHECKED BY:

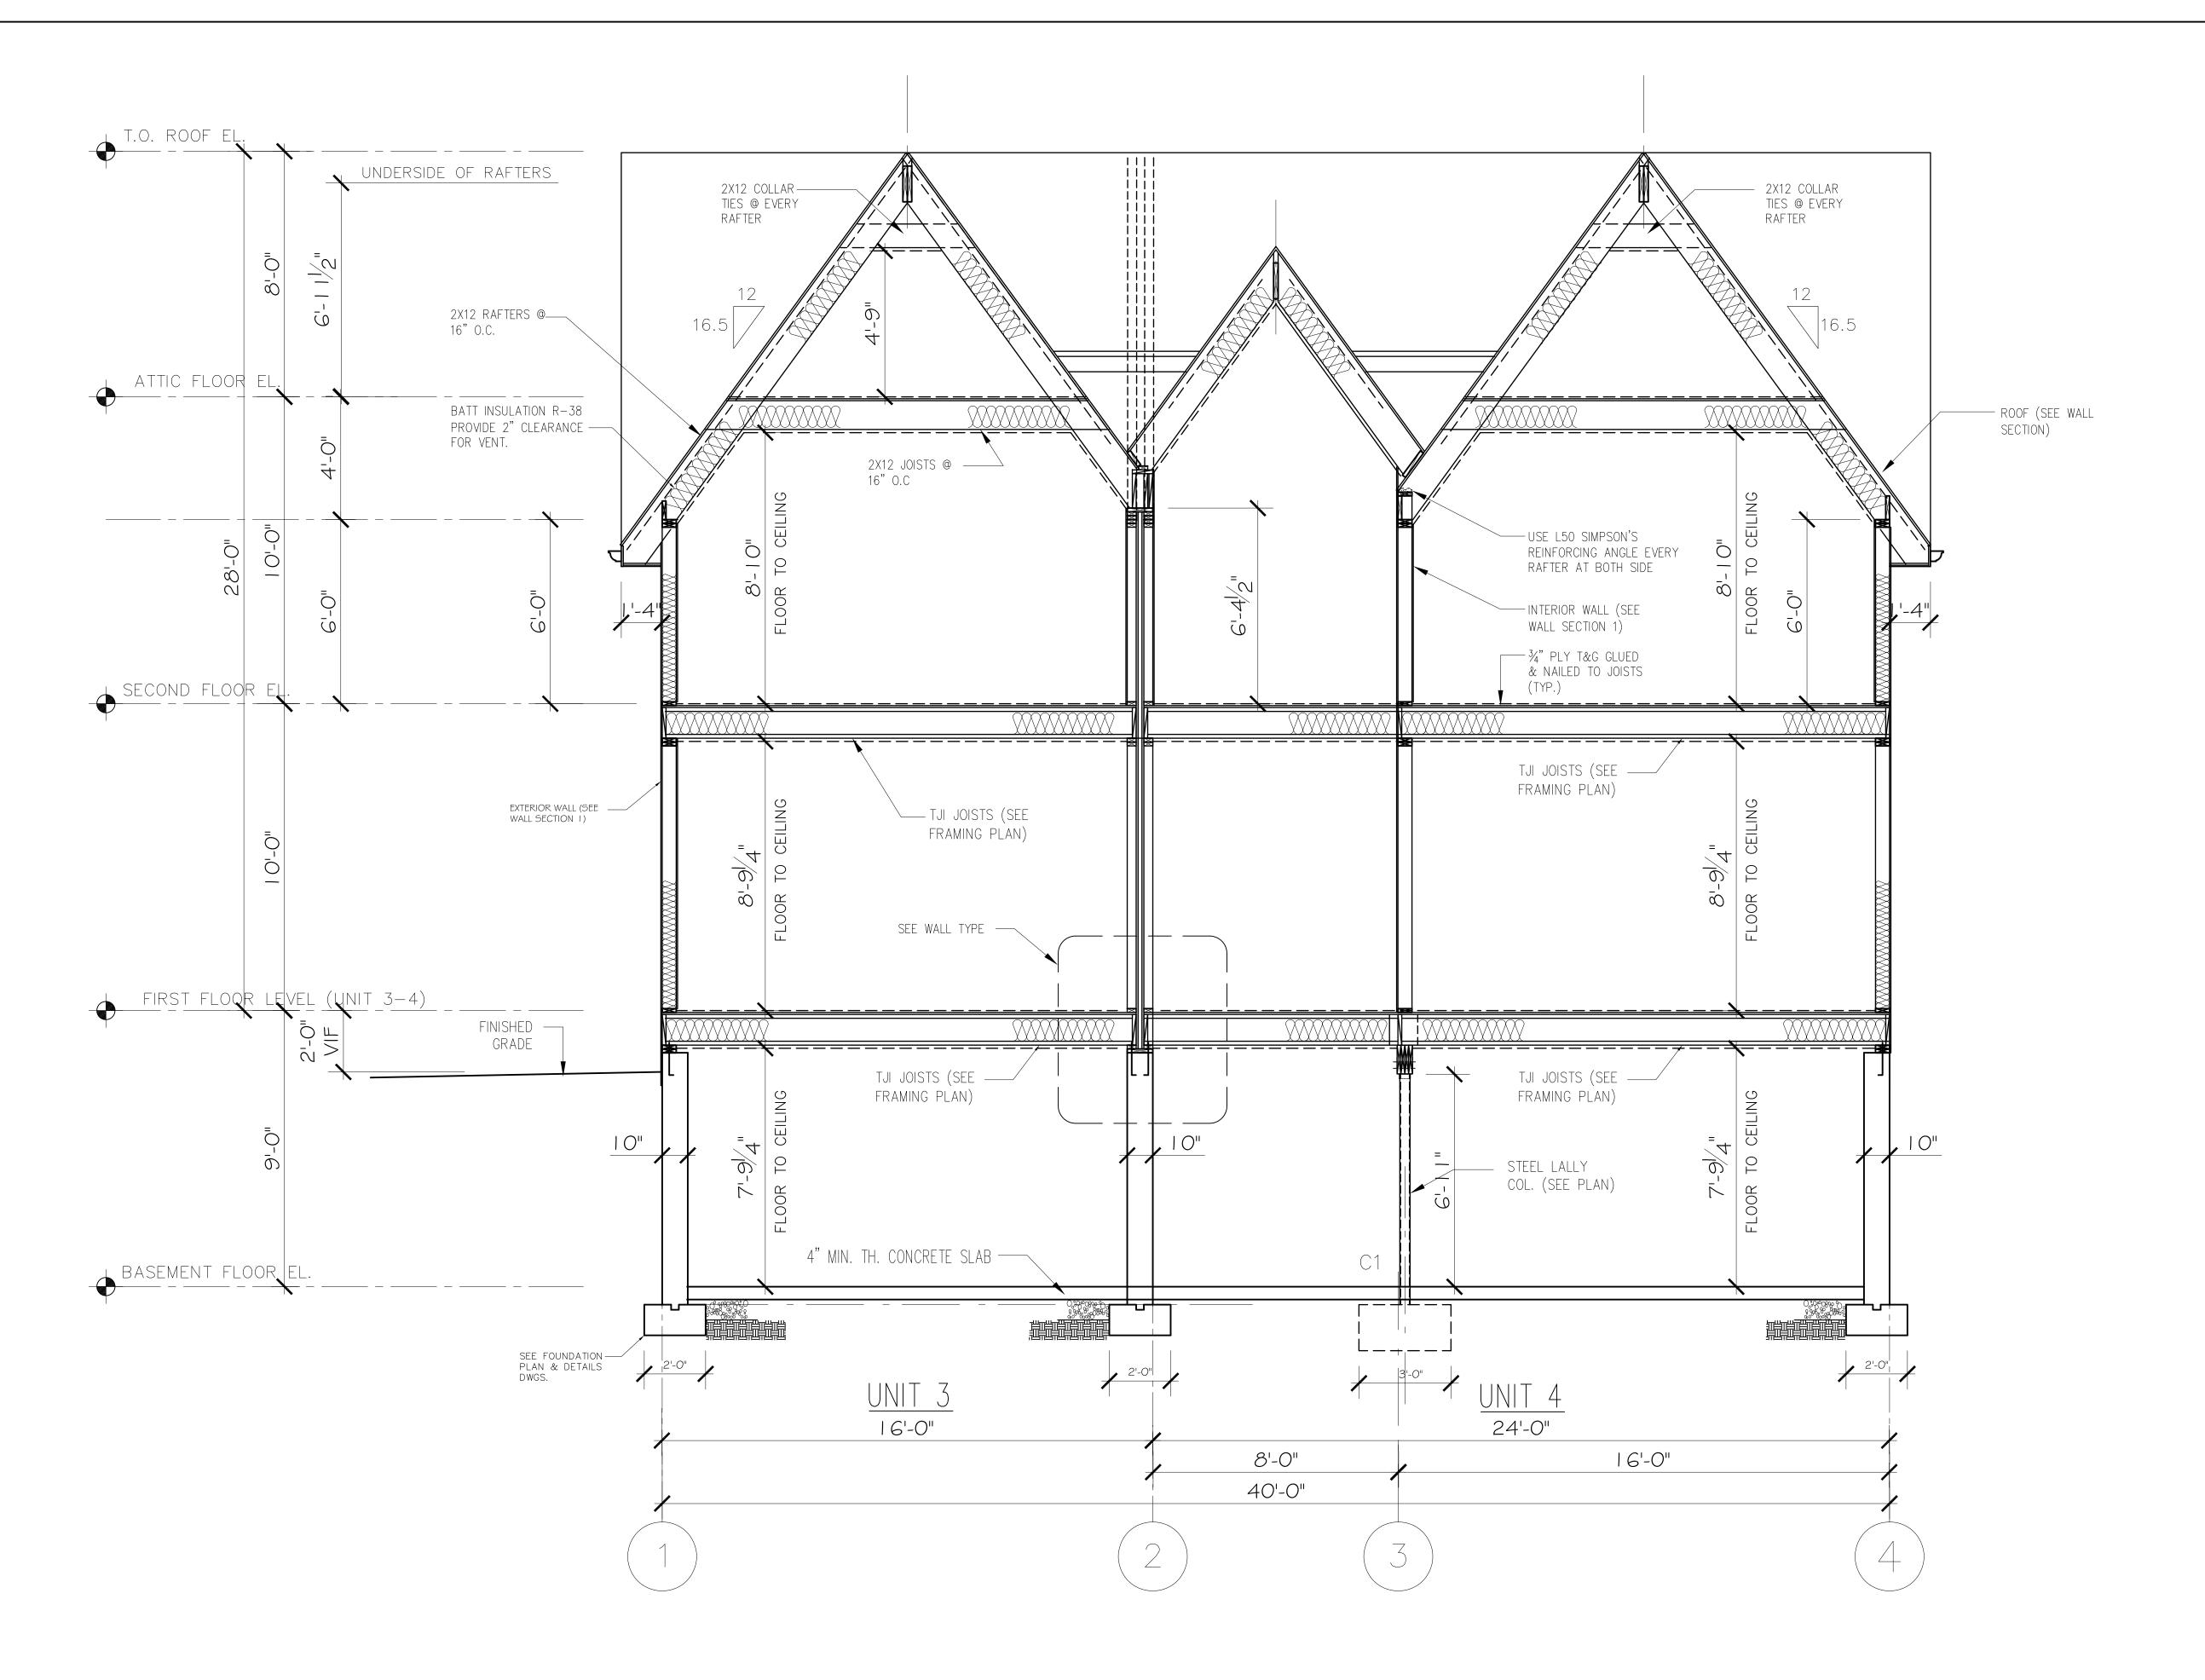

SECTION B-B (UNIT 3-4)

SCALE: 3/8" = 1'-0"



UNITS 3-4 PROPOSED SECTION B-B


50 - 52 ROWE ST. NEWTON, MA 02466


OWNER: NEW NEWTON, LLC 2193 COMMONWEALTH AVE, BRIGHTON, MA 02135


NEW 2) TWO FAMILY RESIDENCES 50 - 52 ROWE STREET, NEWTON, MA

Architect 487 Watertown Street Newtonville, MA 02460 Ronald F. Jarek,

April 28, 2016 DRAWN BY: CHECKED BY:

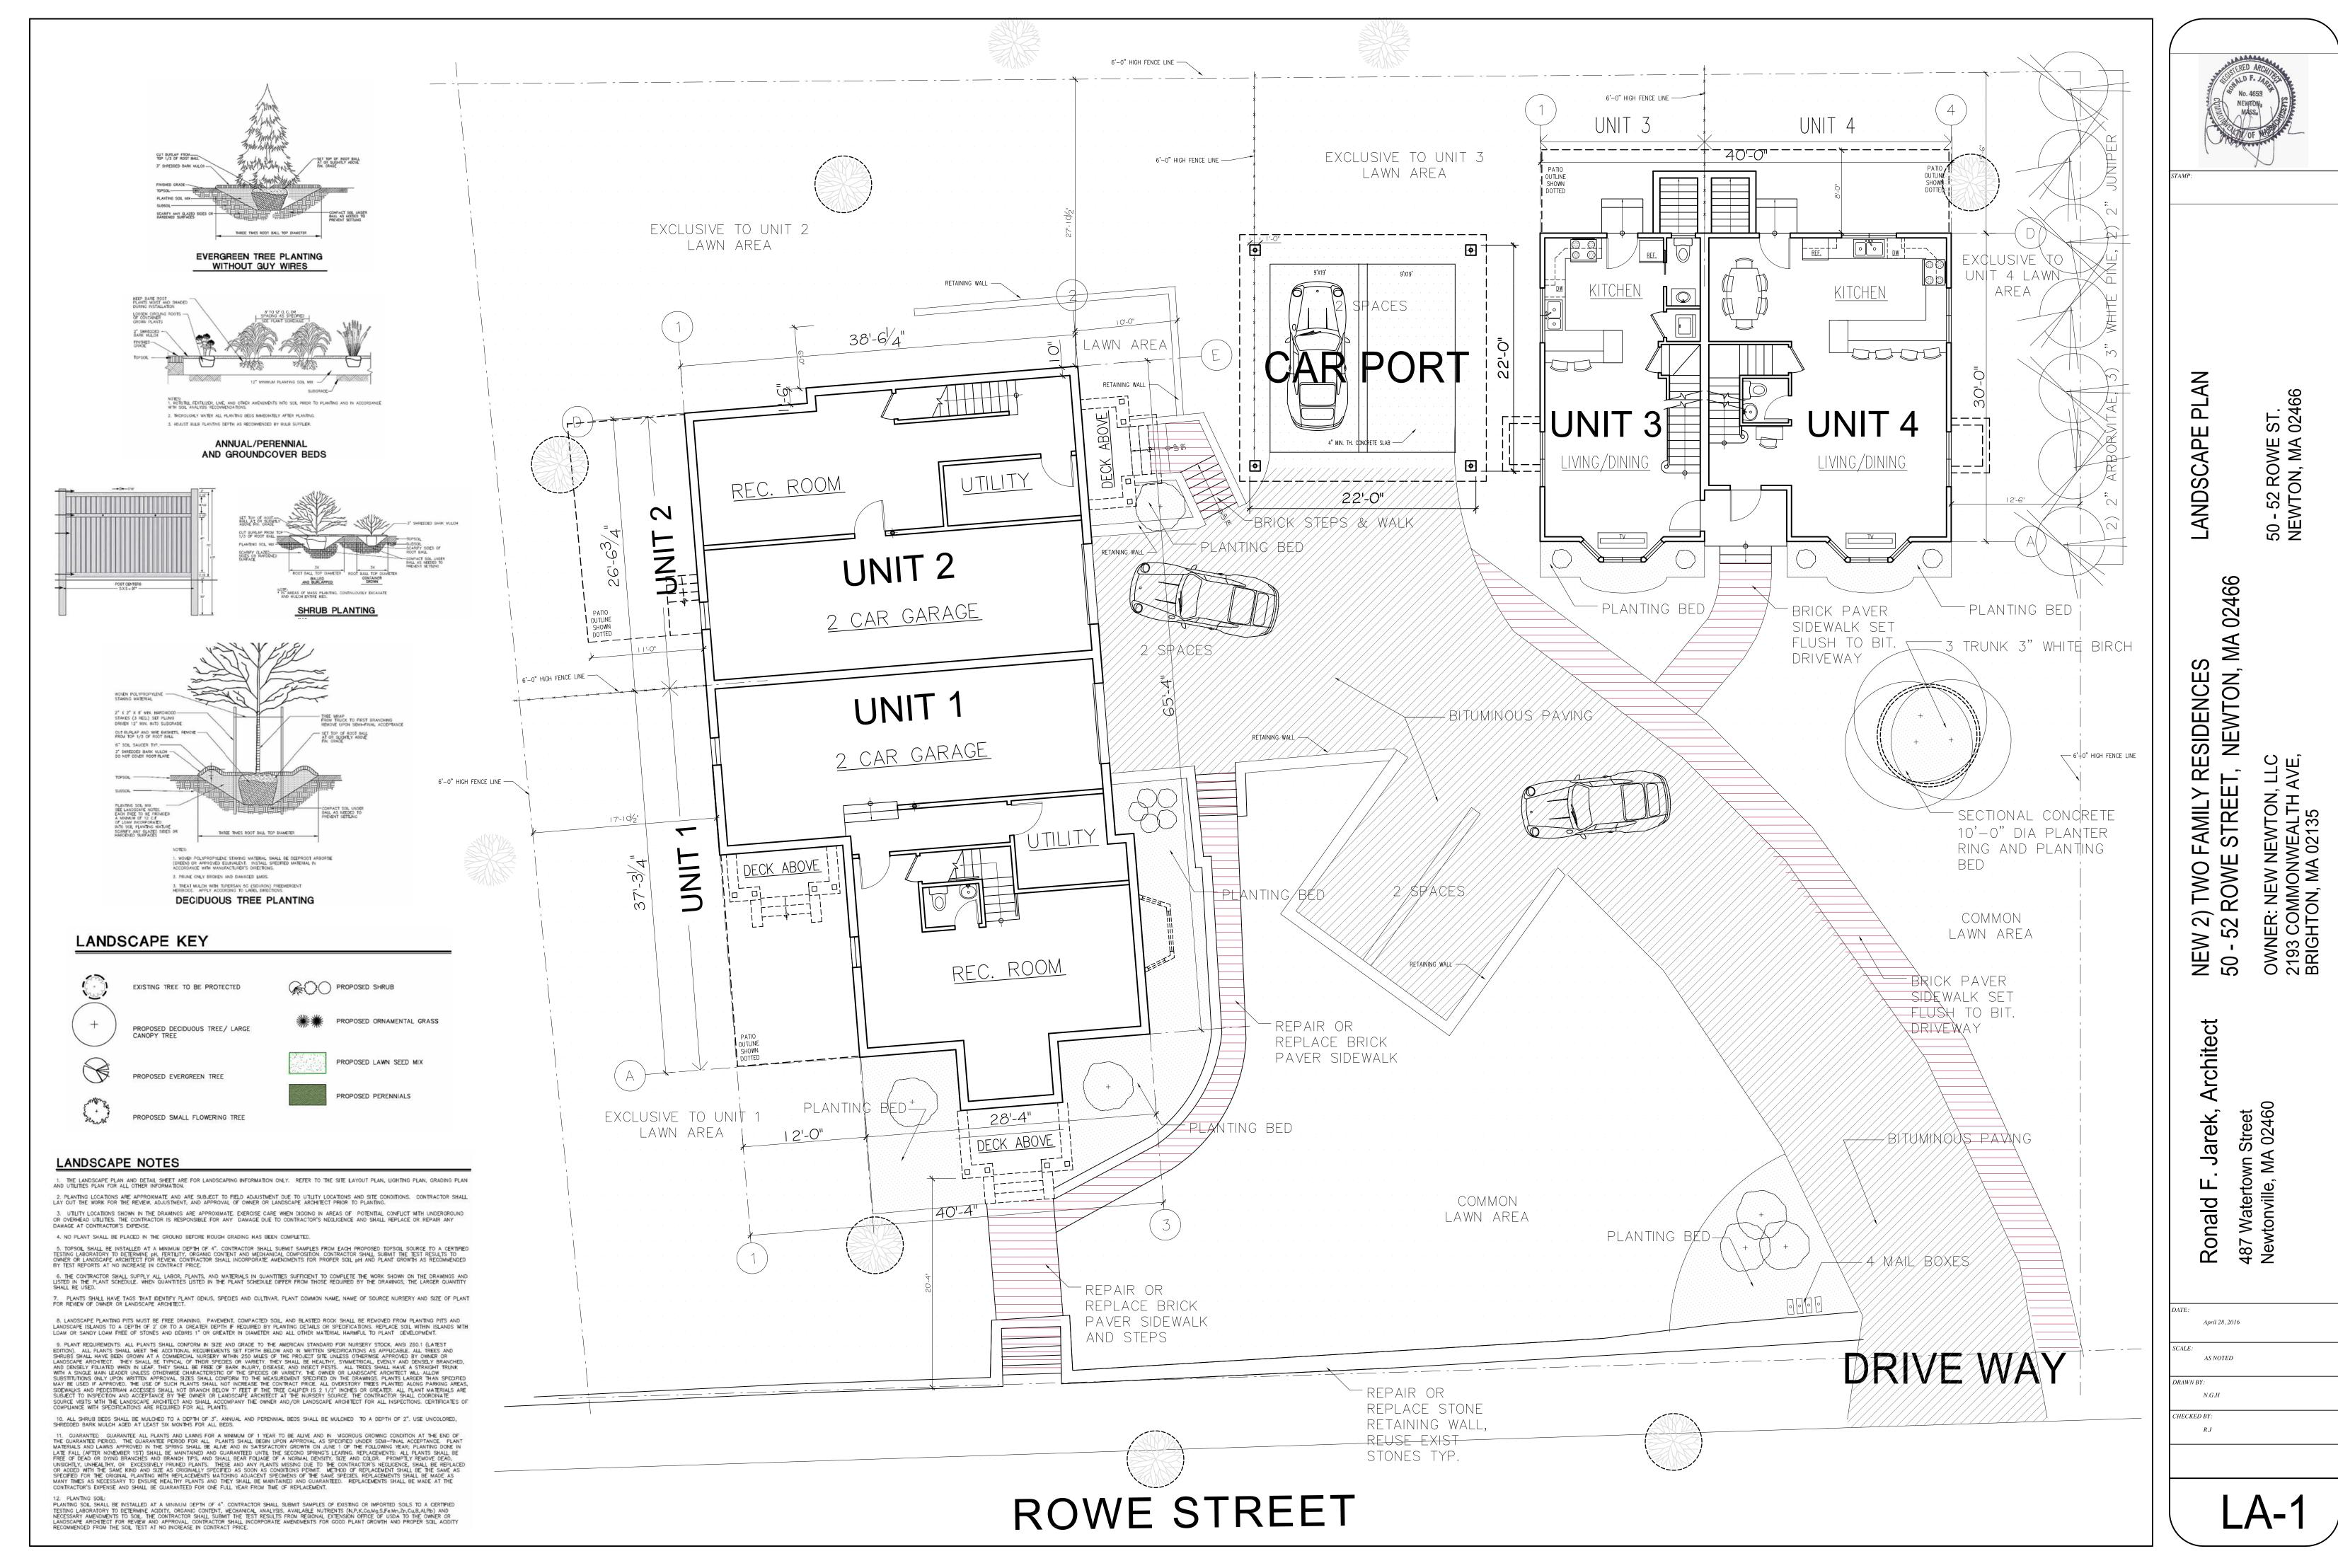

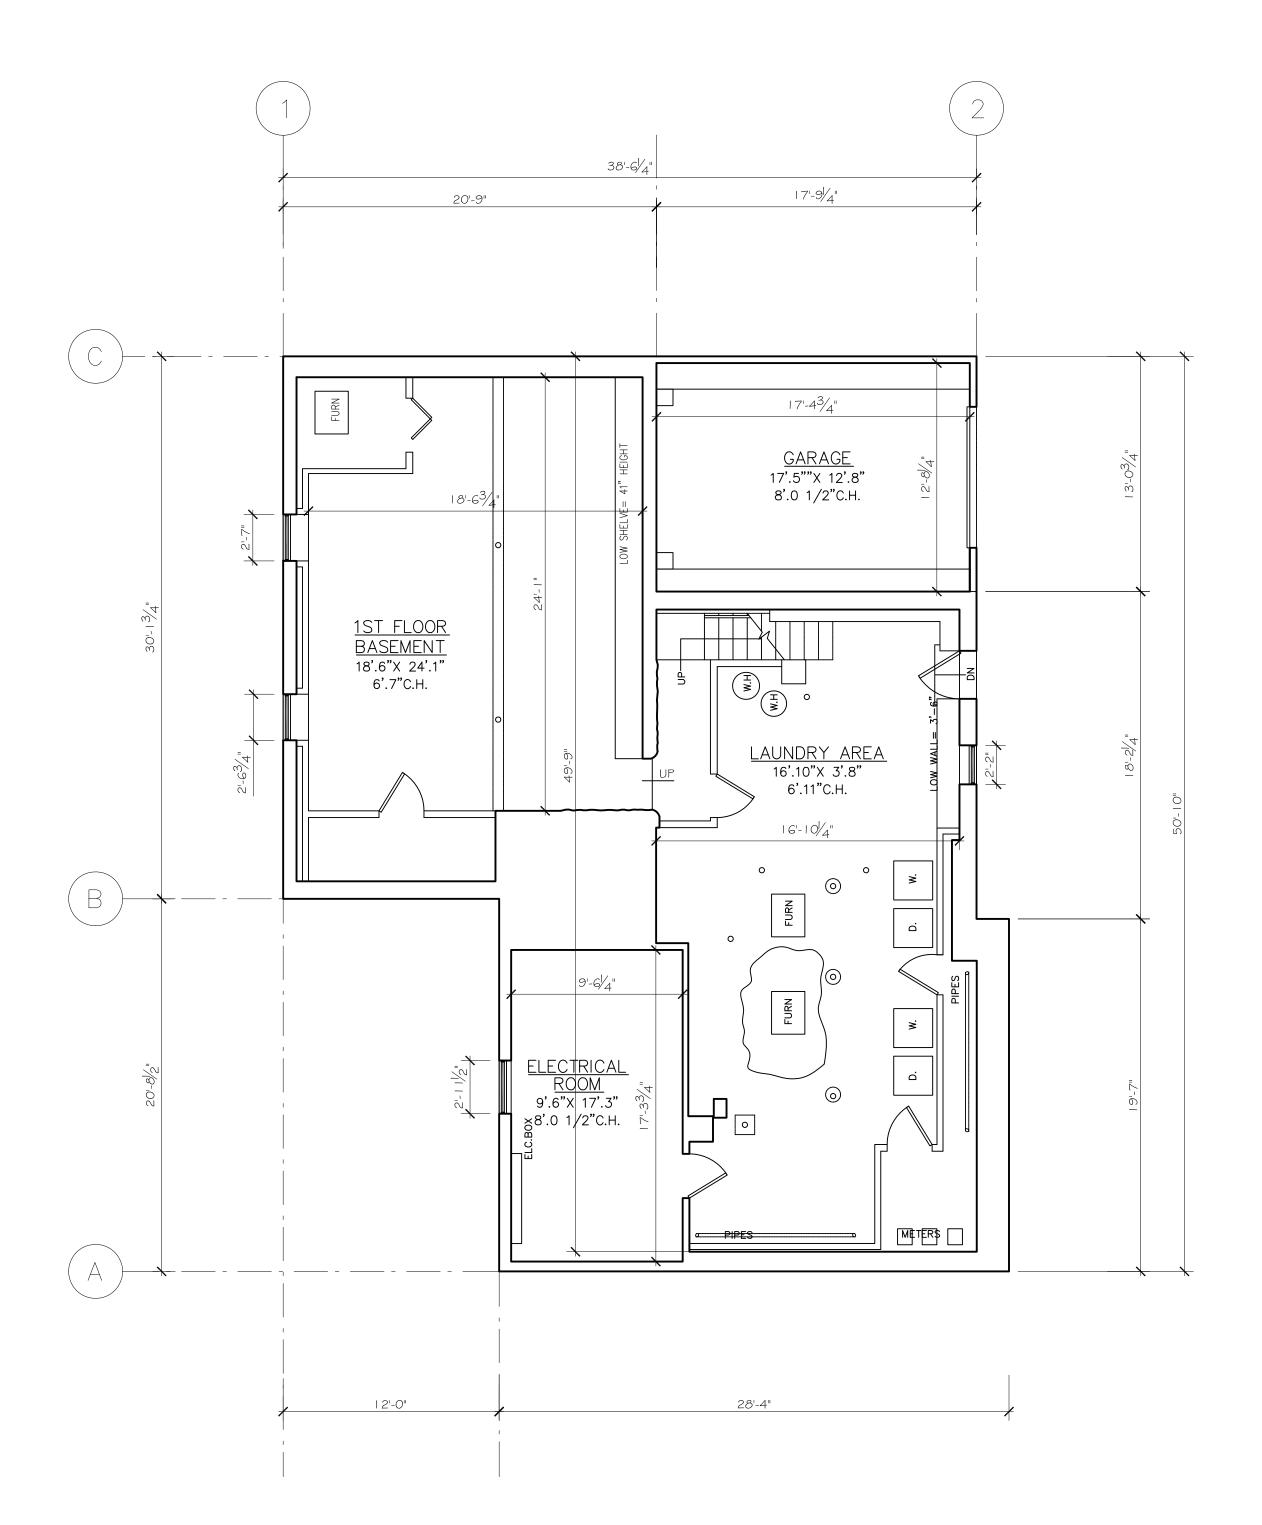

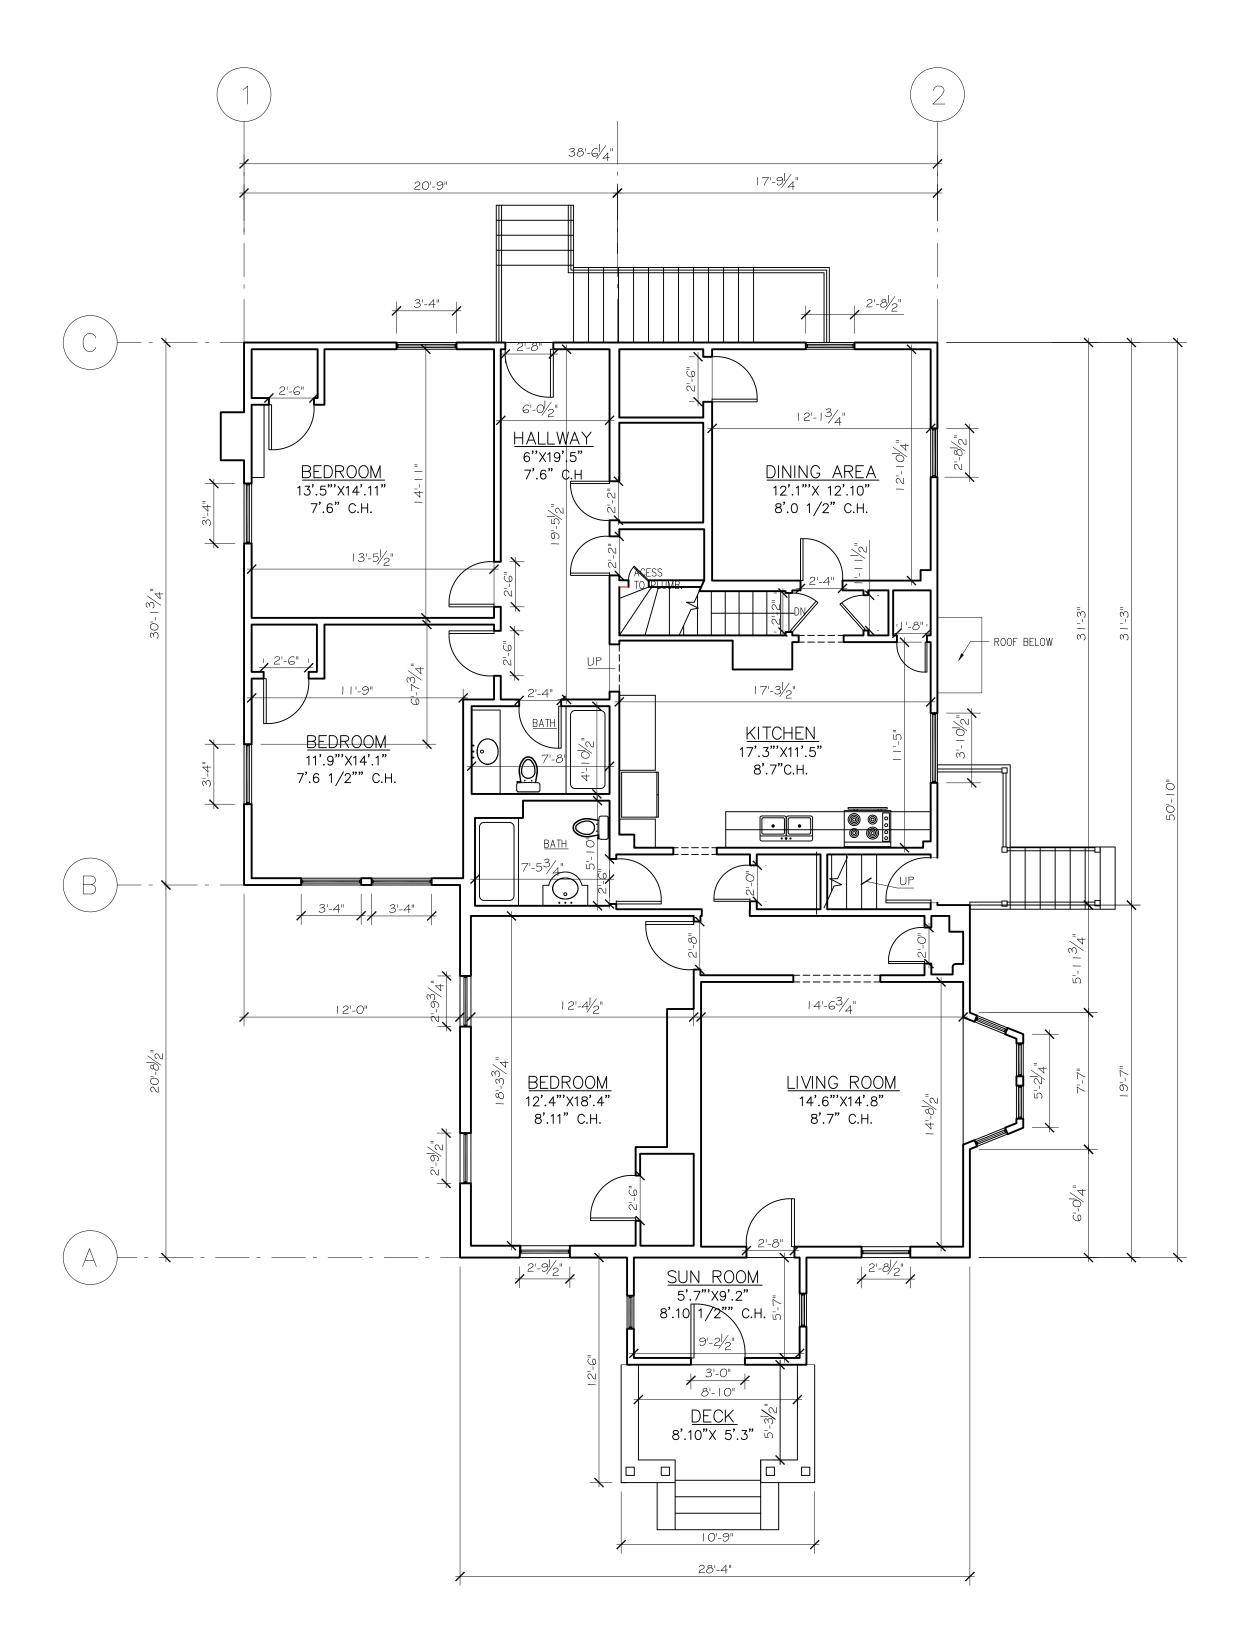

EXISTING BASEMENT UNITS 1& 2

EXISTING FIRST FLOOR PLAN UNITS 1& 2

NTS

Ronald F. Jarek, Architect


487 Watertown Street
Newtonville, MA 02460

UNITS 1-2 EXISTING BASEMENT & FIRST FLOOR PLANS


NEW 2) TWO FAMILY RESIDENCES 50 - 52 ROWE STREET, NEWTON, MA 02466 50 - 52 ROWE ST. NEWTON, MA 02466

OWNER: NEW NEWTON, LLC 2193 COMMONWEALTH AVE, BRIGHTON, MA 02135


EX-1

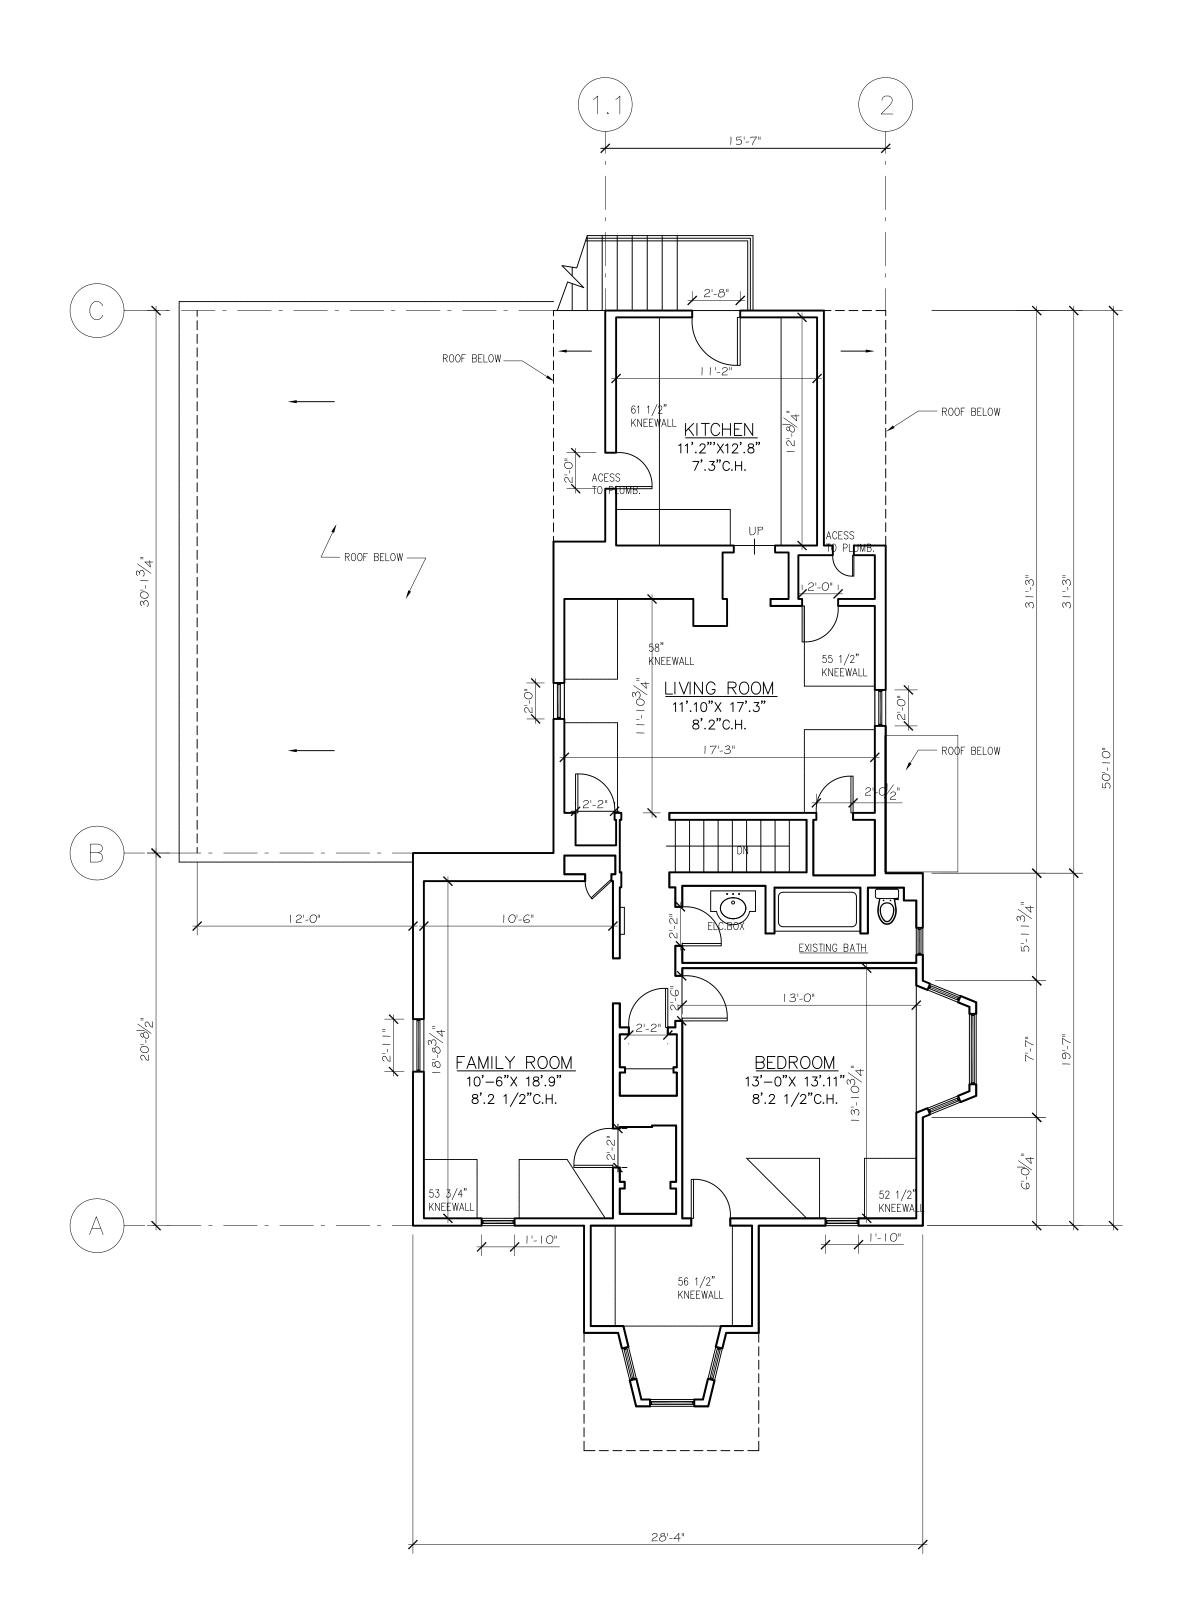

EXISTING SECOND FLOOR PLAN UNITS 1& 2

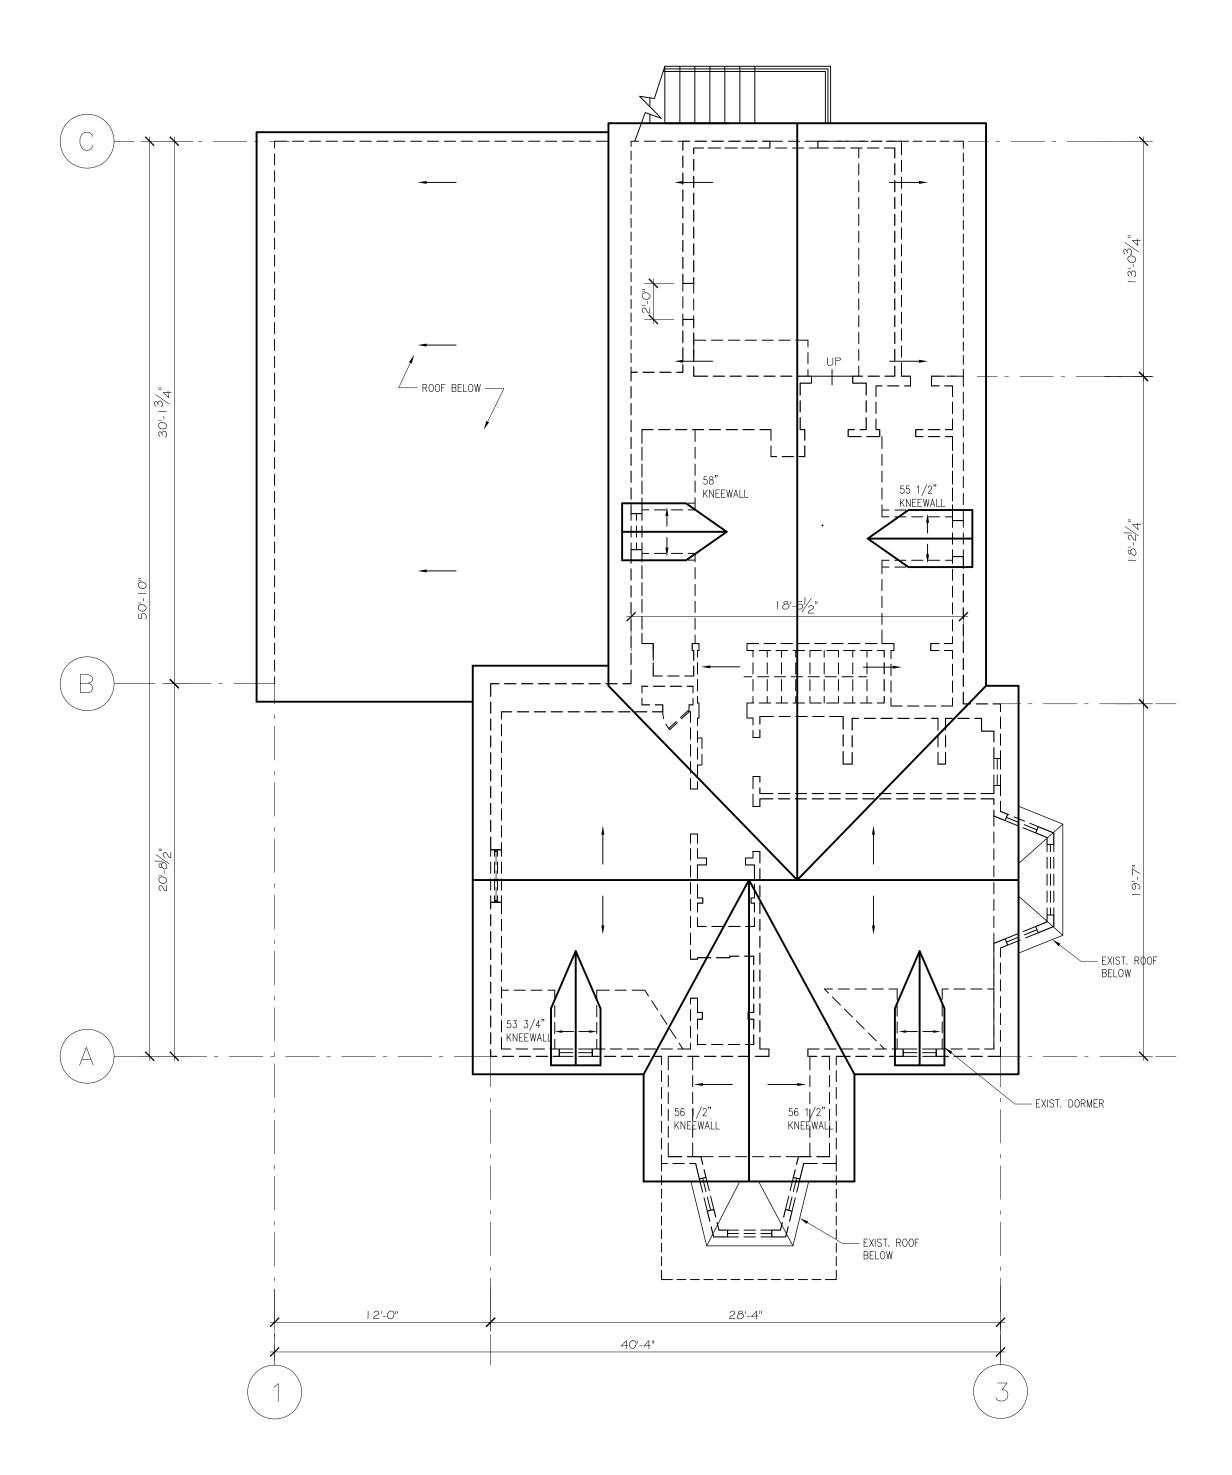

EXISTING ROOF PLAN UNITS 1& 2 NTS

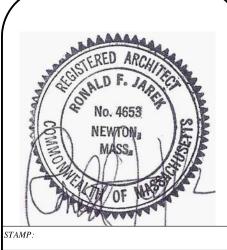

NEW 2) TWO FAMILY RESIDENCES 50 - 52 ROWE STREET, NEWTON, MA

UNITS 1-2 EXISTING SECOND FLOOR & ROOF

50 - 52 ROWE ST. NEWTON, MA 02466

OWNER: NEW NEWTON, LLC 2193 COMMONWEALTH AVE, BRIGHTON, MA 02135

Ronald F. Jarek, Architect


EX-2




EXISTING FRONT ELEVATION UNITS 1& 2



EXISTING RIGHT SIDE ELEVATION UNITS 1& 2

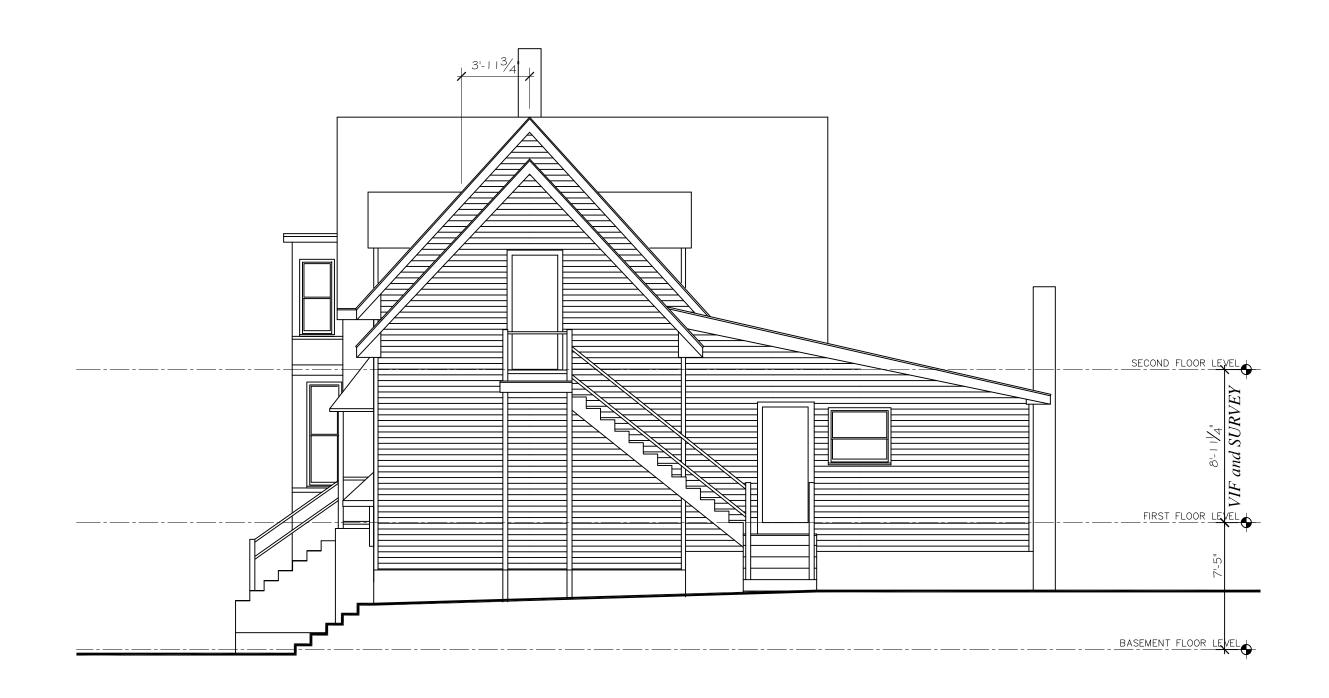

EXISTING REAR ELEVATION UNITS 1& 2

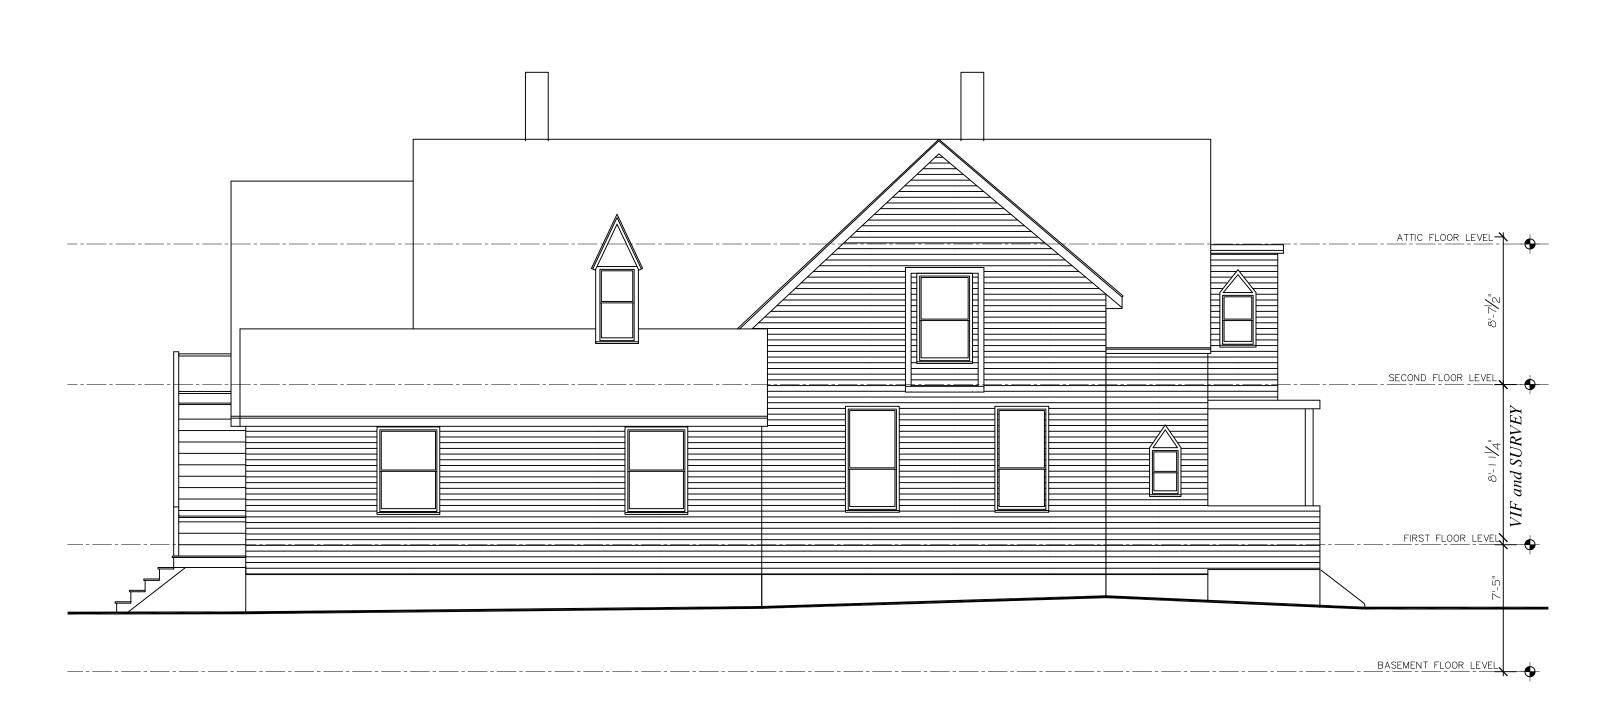

EXISTING LEFT SIDE ELEVATION UNITS 1& 2



UNITS 1-2 EXISTING ELEVATIONS

50 - 52 ROWE ST. NEWTON, MA 02466

NEW 2) TWO FAMILY RESIDENCES 50 - 52 ROWE STREET, NEWTON, MA 02466 NEWTON, LLC WEALTH AVE, 02135

, Architect Ronald F. Jarek,

EX-3