
	Architectural Drawing List					
Sheet Number	Sheet Name	Sheet Issue Date	Current Revision Date			
0 - Cover Sheet						
A-000	Cover Sheet	06/30/2017				
1 - Civil						
1	Civil Plan	06/09/2017				
2	Details	06/09/2017				
3	Details	06/09/2017				
2 - Architecture						
A-001	General Notes & Abreviations	06/30/2017				
A-002	Existing Conditions	06/30/2017				
A-010	Code Review & Egress Calculations	06/30/2017				
A-020	Architectural Site Plan	06/30/2017	06/05/2018			
A-100	Basement & First Floor Plans	06/30/2017	06/05/2018			
A-101	Second Floor & Attic Plans	06/30/2017	04/12/2018			
A-300	Elevations	06/30/2017	02/05/2018			
A-310	Perspectives	06/30/2017				
A-400	Building Longitudinal & Cross Sections	06/30/2017	04/12/2018			
A-410	Wall Sections & Section Details	07/05/2017	04/05/2018			
A-520	Typical Roof Details-Sloped	06/30/2017				
A-600	Typical Stair Details	06/30/2017				
A-700	Door & Window Schedules	06/30/2017	02/05/2018			
A-710	Typical Door & Window Details	06/30/2017				
A-800	Partition Types	06/30/2017	02/05/2018			
3-Structural						
S-001	Foundation Plan	06/29/2017	07/05/2017			
S-002	First Floor Framing	06/29/2017	07/05/2017			
S-003	Second Floor Framing	06/29/2017				
S-004	Third Floor & Roof Framing	06/29/2017				

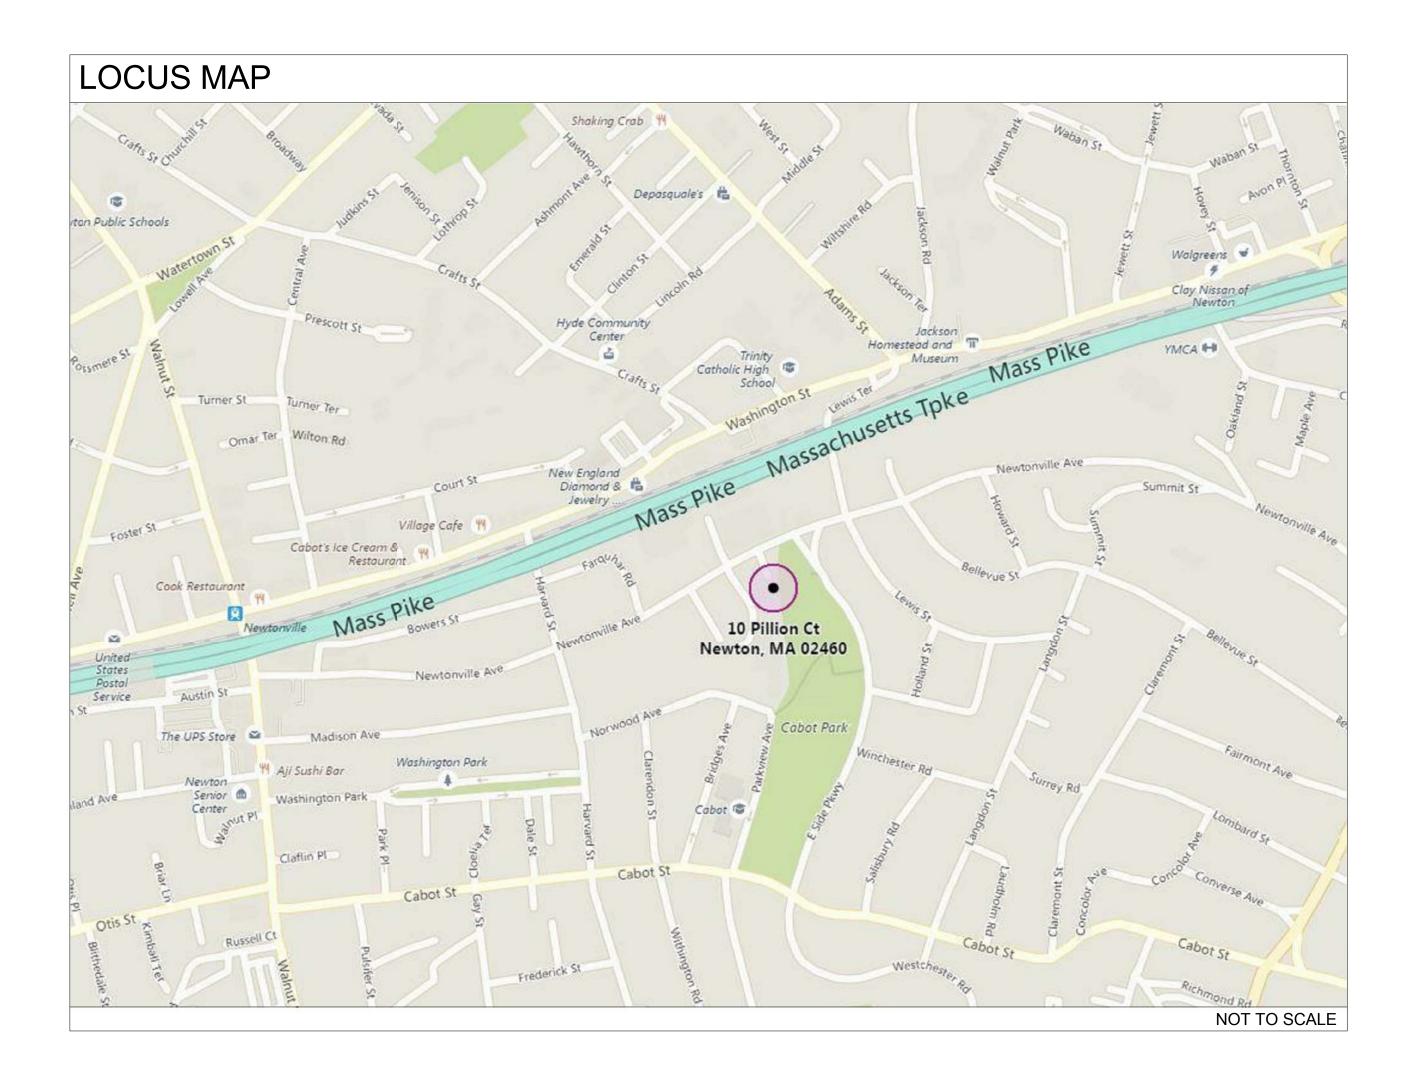



# PROJECT: 10 Pillion Court Residences

PROJECT ADDRESS: 10 PILLION COURT NEWTON MASSACHUSETTS

ARCHITECT KHALSA DESIGN INC. ADDRESS: 17 IVALOO STREET, SUITE 400 SOMERVILLE, MA 02143

STRUCTURAL ENGINEER EDMOND SPRUHAN ADDRESS: 80 JEWETT ST., UNIT 1 NEWTON, MA PHONE: 617-816-0722


> SPECIAL PERMIT SET 07.05.2017 REV. 4.5-2 6.5.2018


CLIENT GFC DEVELOPMENT INC. CHARLES AGGOURAS ADDRESS: 1167 BROADWAY SOMERVILLE, MA 02144

CIVIL ENGINEER PETER NOLAN & ASSOCIATES LLC ADDRESS: 697 CAMBRIDGE STREET, SUITE 103 BRIGHTON, MA 02135 PHONE: 857-891-7478/617-782-1533


PROJECT NAME 10 PILLION CT
RESIDENCES
PROJECT ADDRESS
NEWTON, MA
CLIENT
GFC DEVELOPMENT INC.
ARCHITECT
QESIGZ
KHALSA
17 IVALOO STREET SUITE 400 SOMERVILLE, MA 02143 TELEPHONE: 617-591-8682 FAX: 617-591-2086
CONSULTANTS:
COPYRIGHT KDI © 2017 THESE DRAWINGS ARE NOW AND DO REMAIN THE SOLE PROPERTY OF KHALSA DESIGN INC. USE OF THESE PLANS OR ANY
FORM OF REPRODUCTION OF THIS DESIGN IN WHOLE OR IN PART WITHOUT EXPRESS WRITTEN CONSENT IS PROHIBITED AND SHALL RESULT IN THE FULLEST EXTENT OF
PROSECUTION UNDER LAW
STERED ARCHITE
NO. CONS. EL
Project number 17001
Date07/05/2017Drawn byERS, NBChecked byJSK
Scale REVISIONS
No. Description Date
Cover Sheet
<b>A-000</b>


10 PILLION CT RESIDENCES

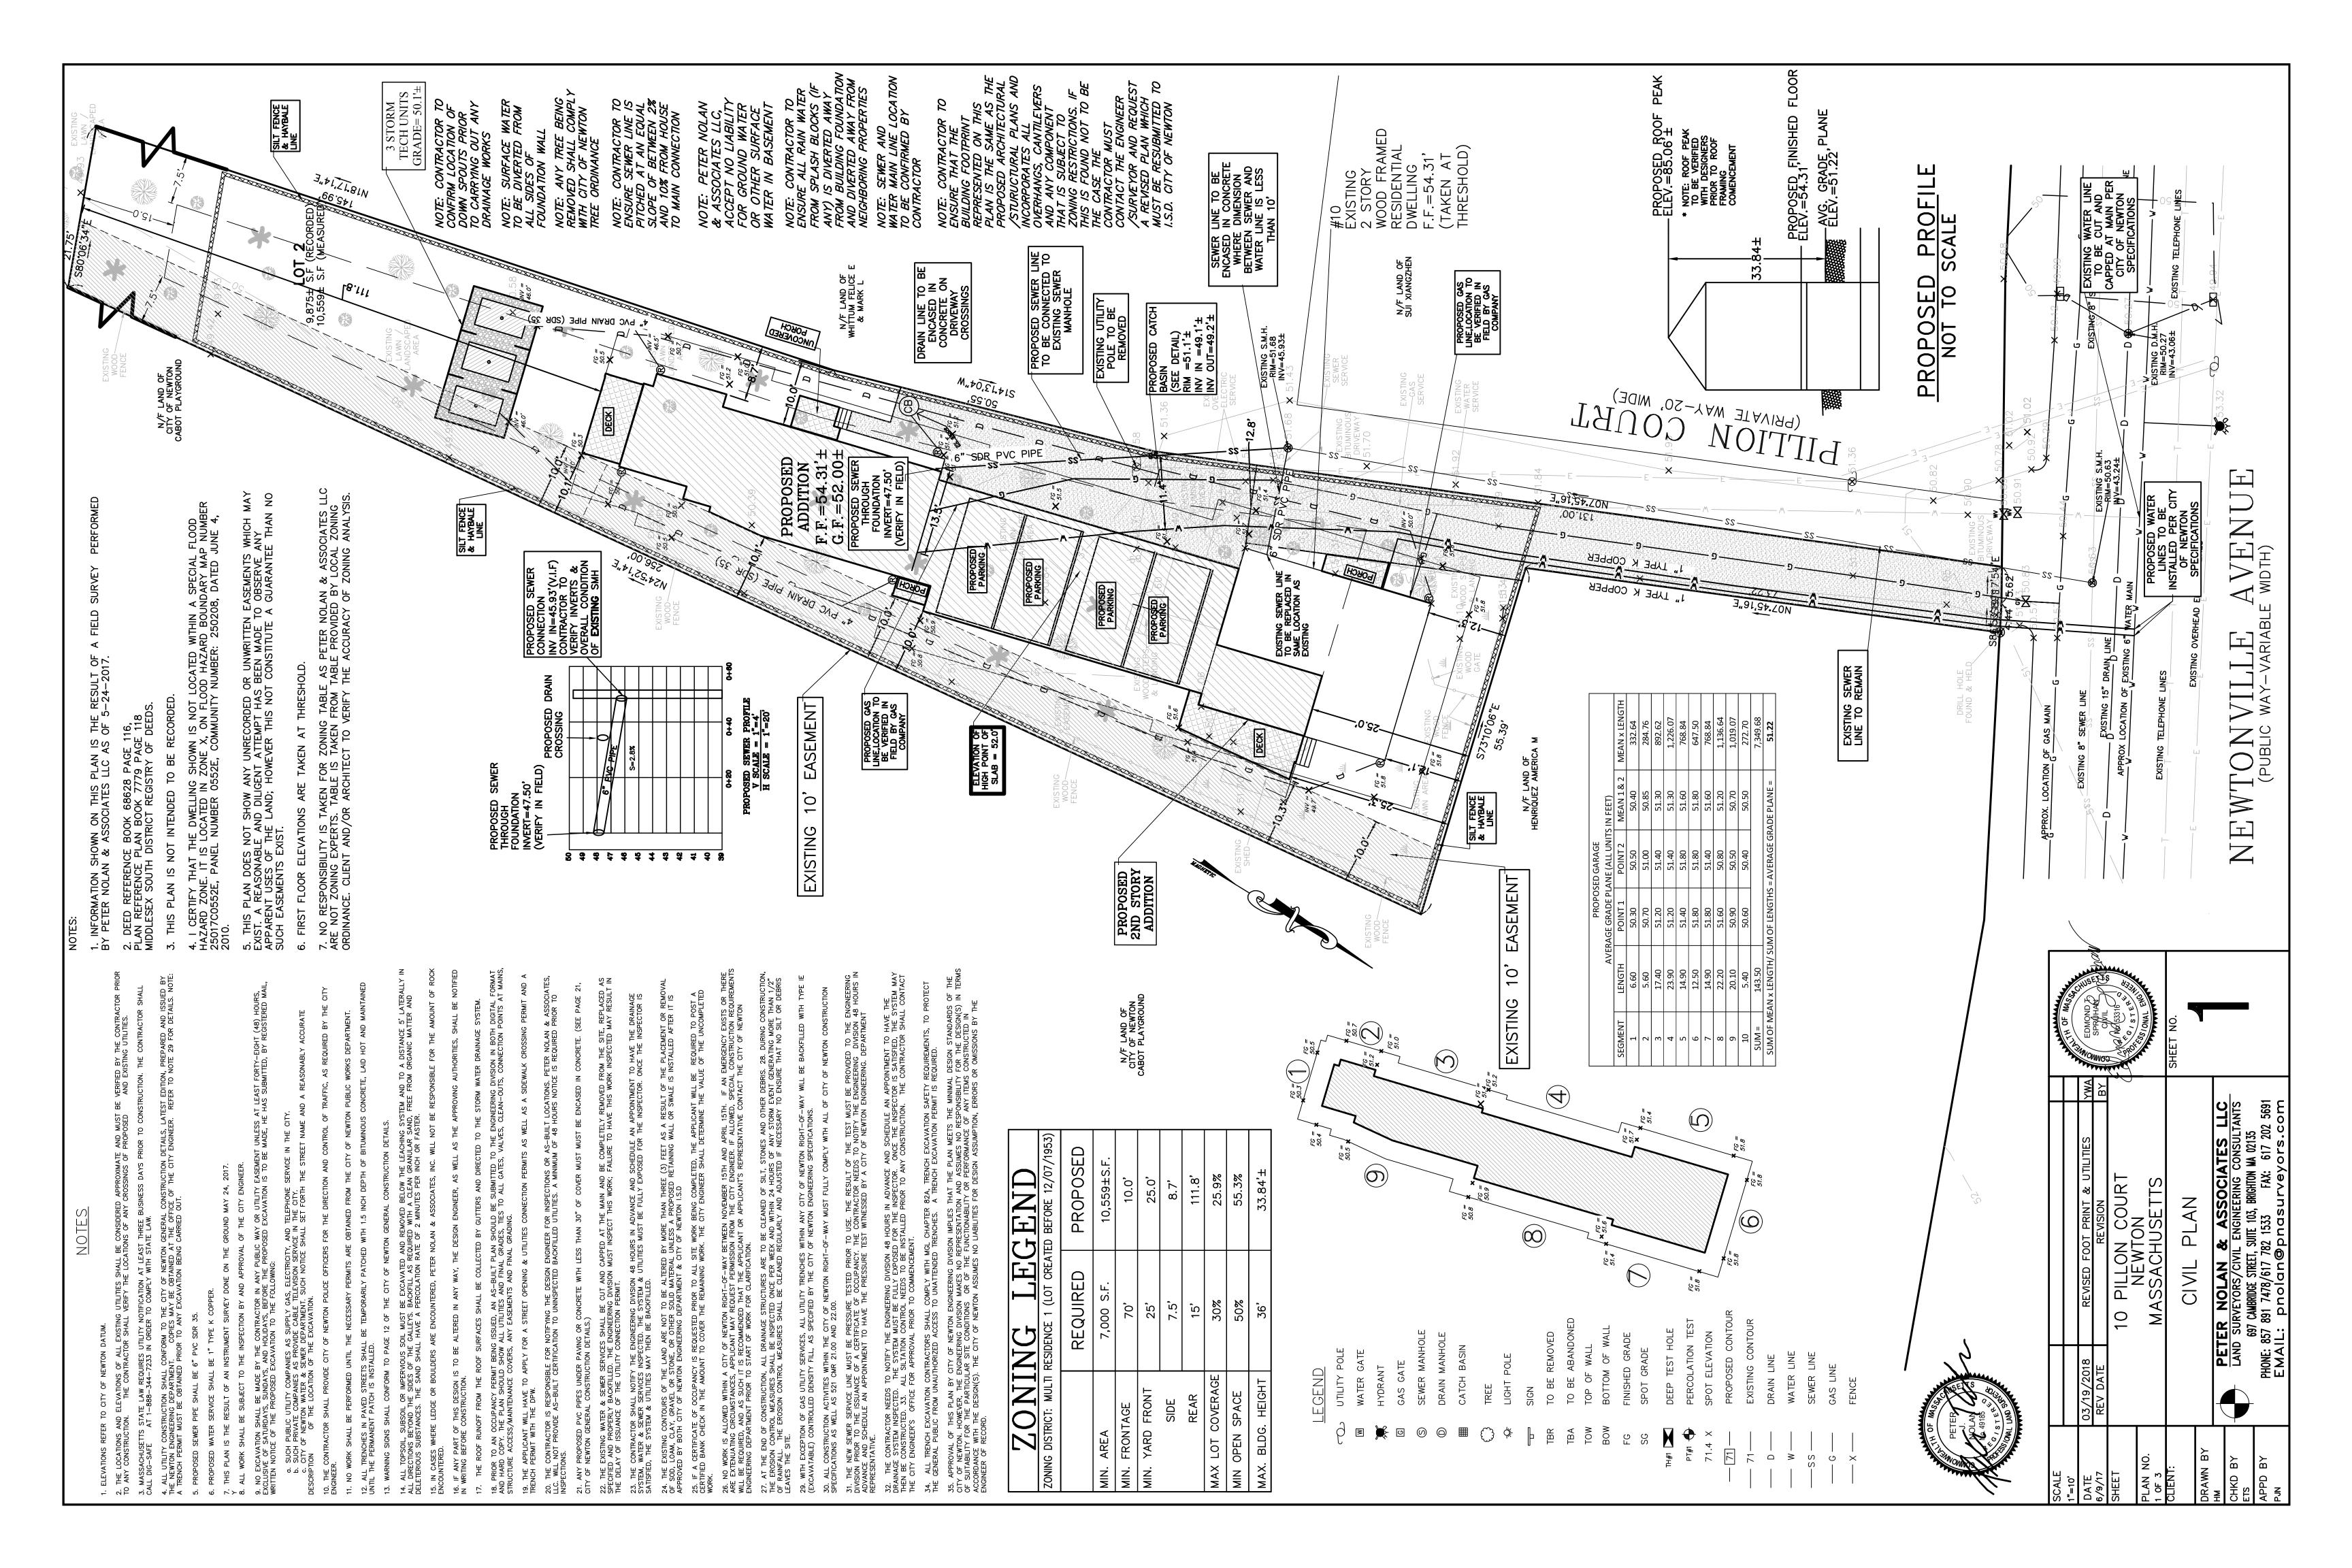

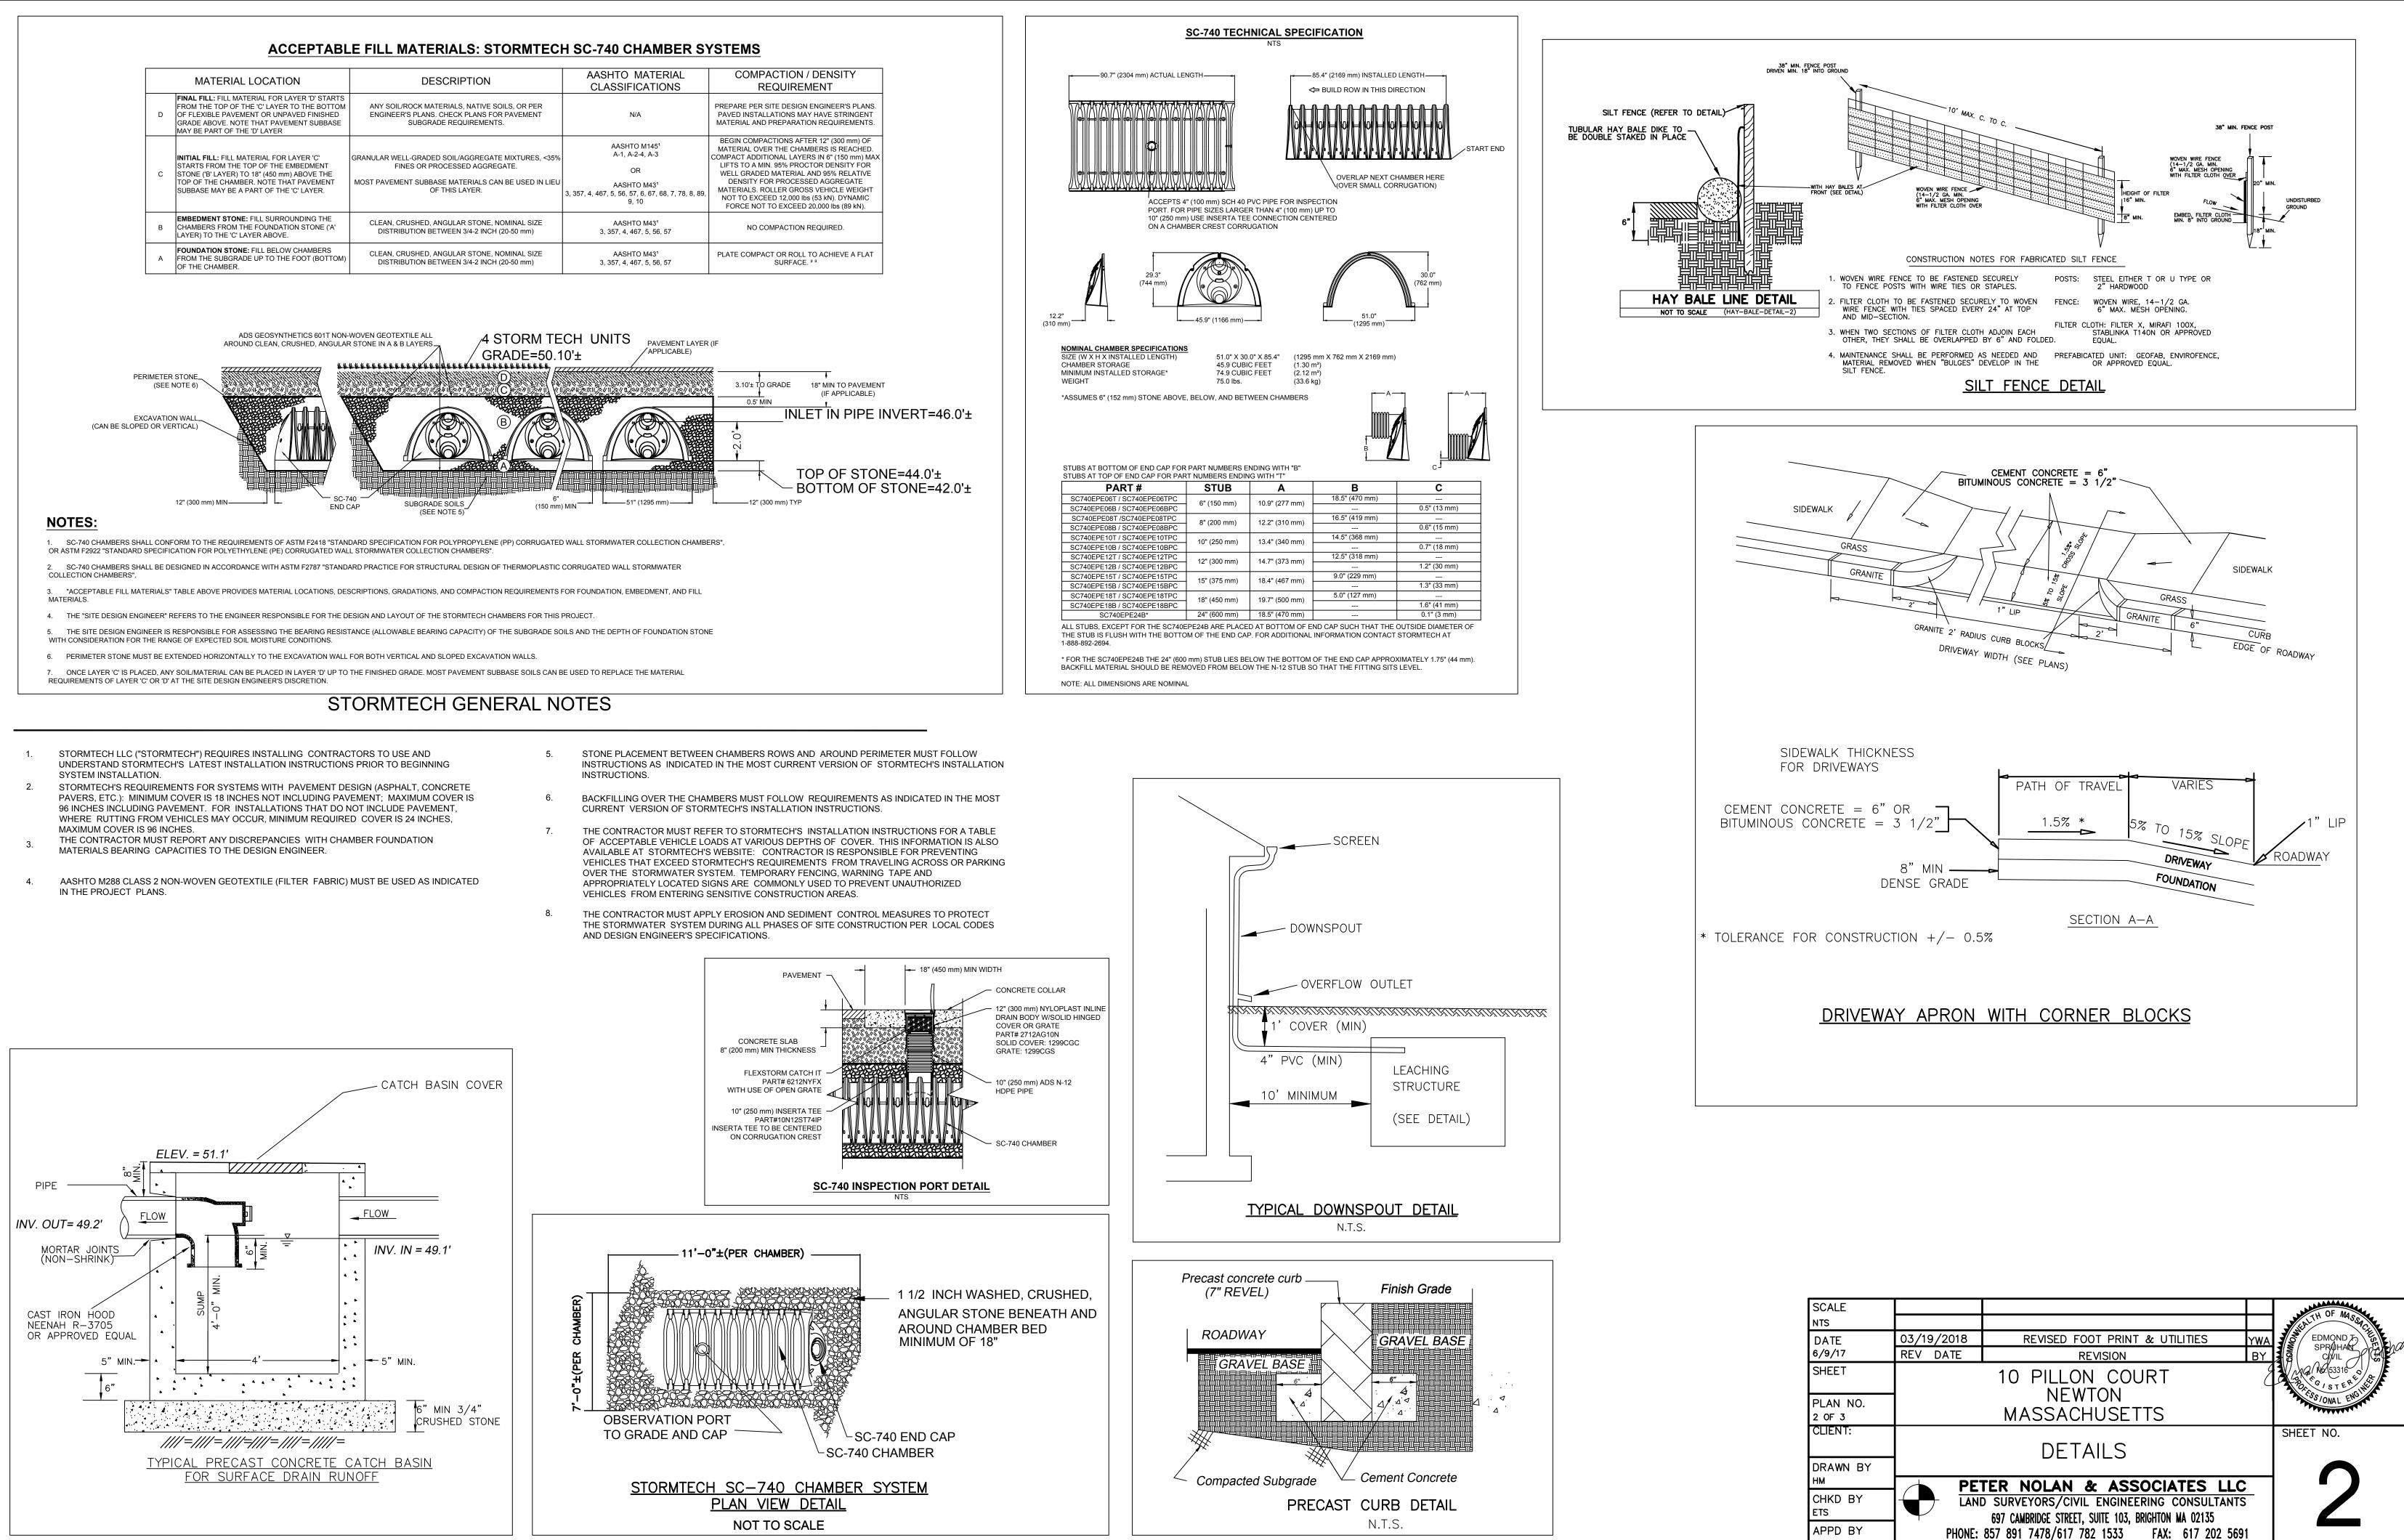

SCALE NTS				EDMOND TO SPRUHARD CIVIL
DATE	03/19/2018	REVISED FOOT PRINT & UTILITIES	YWA	EDMOND J
6/9/17	REV DATE	REVISION	BY	CIVIL CIVIL
SHEET		10 PILLON COURT	Č	AND NO.53316
PLAN NO.		NEWTON		535/ONAL END
2 OF 3		MASSACHUSETTS		
CLIENT:		DETAILS		SHEET NO.
DRAWN BY				
НМ	PE'	TER NOLAN & ASSOCIATES L	LC	
CHKD BY		D SURVEYORS/CIVIL ENGINEERING CONSULTA	NTS	
ETS		697 CAMBRIDGE STREET, SUITE 103, BRIGHTON MA 02135		
APPD BY	PHONE:	857 891 7478/617 782 1533 FAX: 617 202	5691	
PJN				

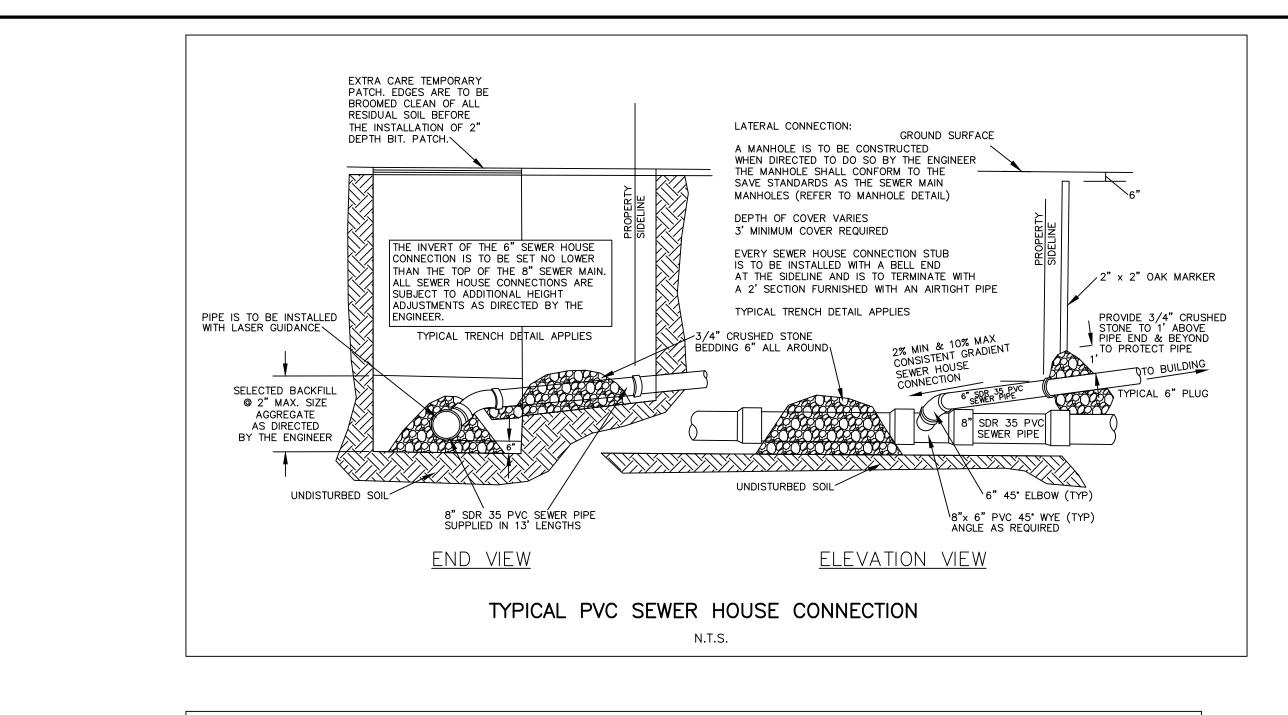


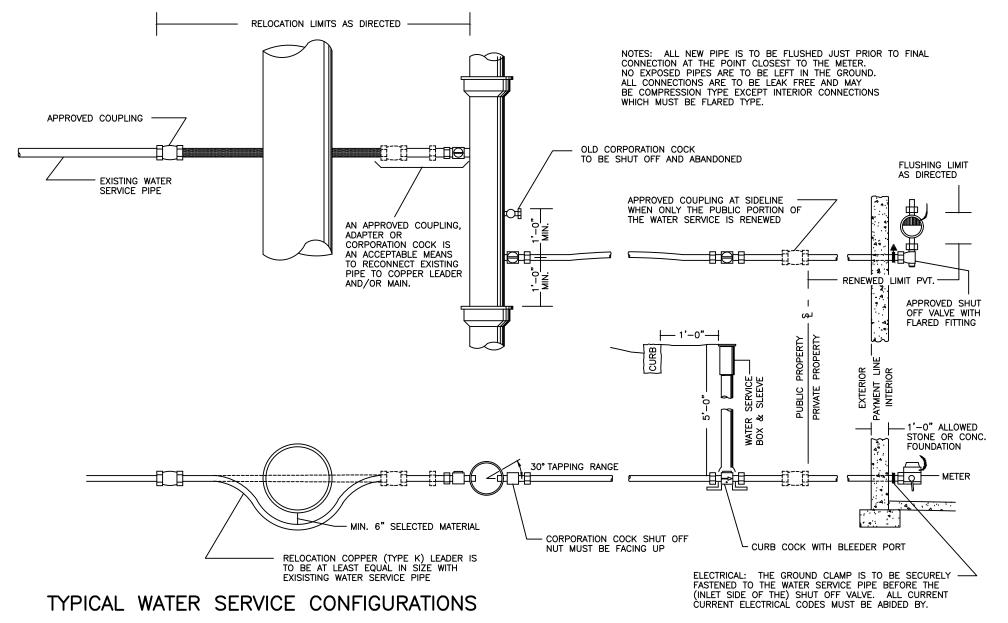



<u>DEEP OBSERVATION HOLE LOG</u> GENERAL SOIL CONDITIONS FOR THE AREA PERFORMED AT 10 PILLION CT BY PETER NOLAN & ASSOCIATES, LLC. HOLE NUMBER: TP - 1 DATED: 6/8/17 GENERAL SITE CONDITIONS: GRASS AND TREES. <u>PERCOLATION TEST HOLE PT - 1</u>


PERCOLATION	RATE	=2	MIN/IN
-------------	------	----	--------


DEPTH	HORIZON	TEXTURE	COLOR	MOTTLING	OTHER
0" - 12"	Α	L	10 YR 3/2	NO	NONE
12" – 36"	В	FILL	10 YR 6/6	NO	BRICKS
36" – 48"	C1	PEAT	10 YR 5/6	NO	NONE
48" – 120"	C2	LSnd	10 YR 5/6	NO	NONE

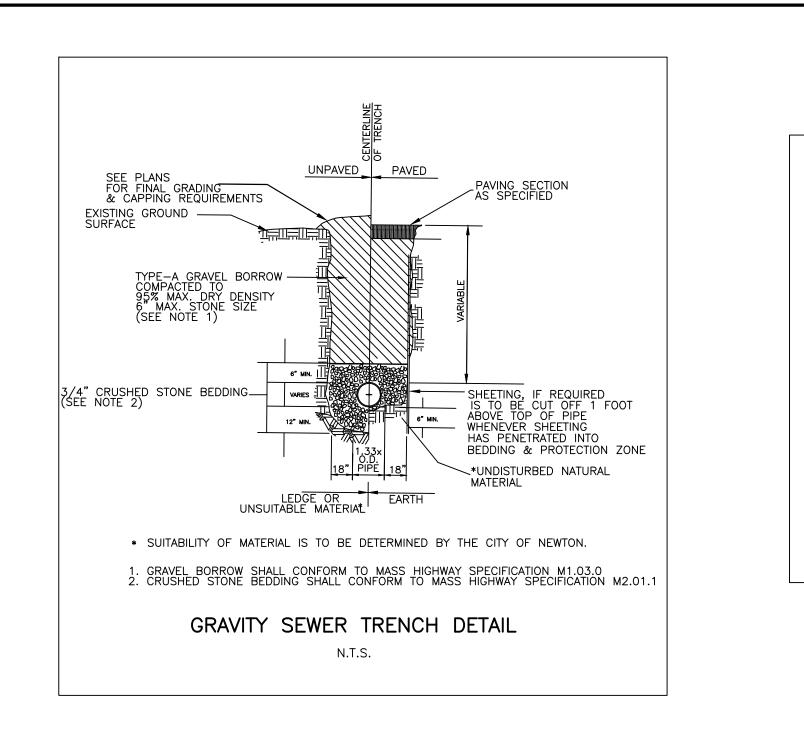

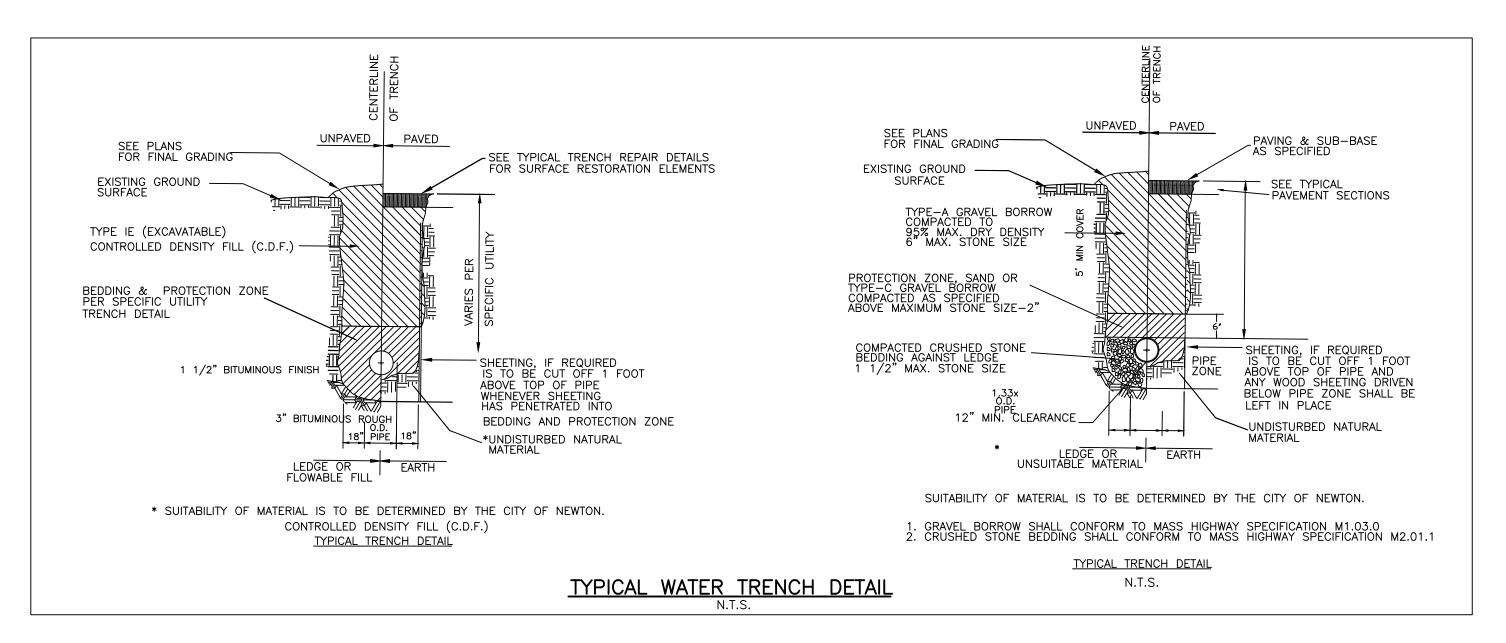

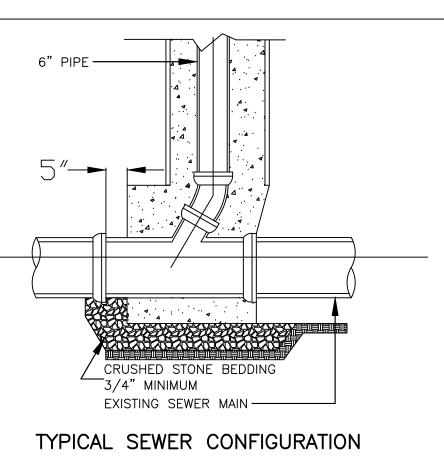

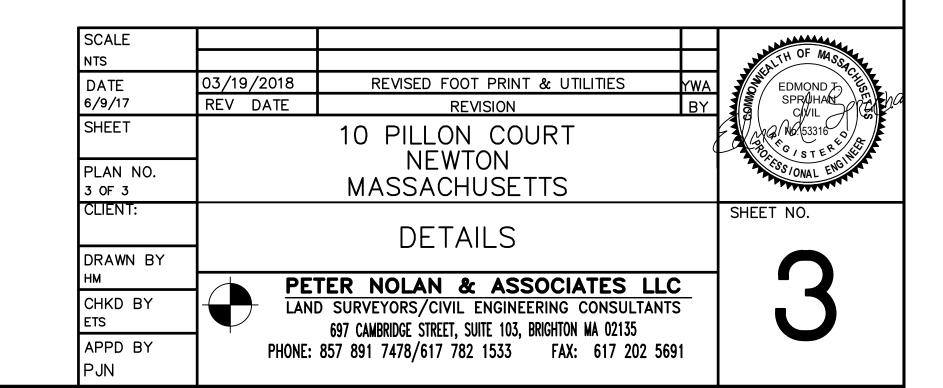

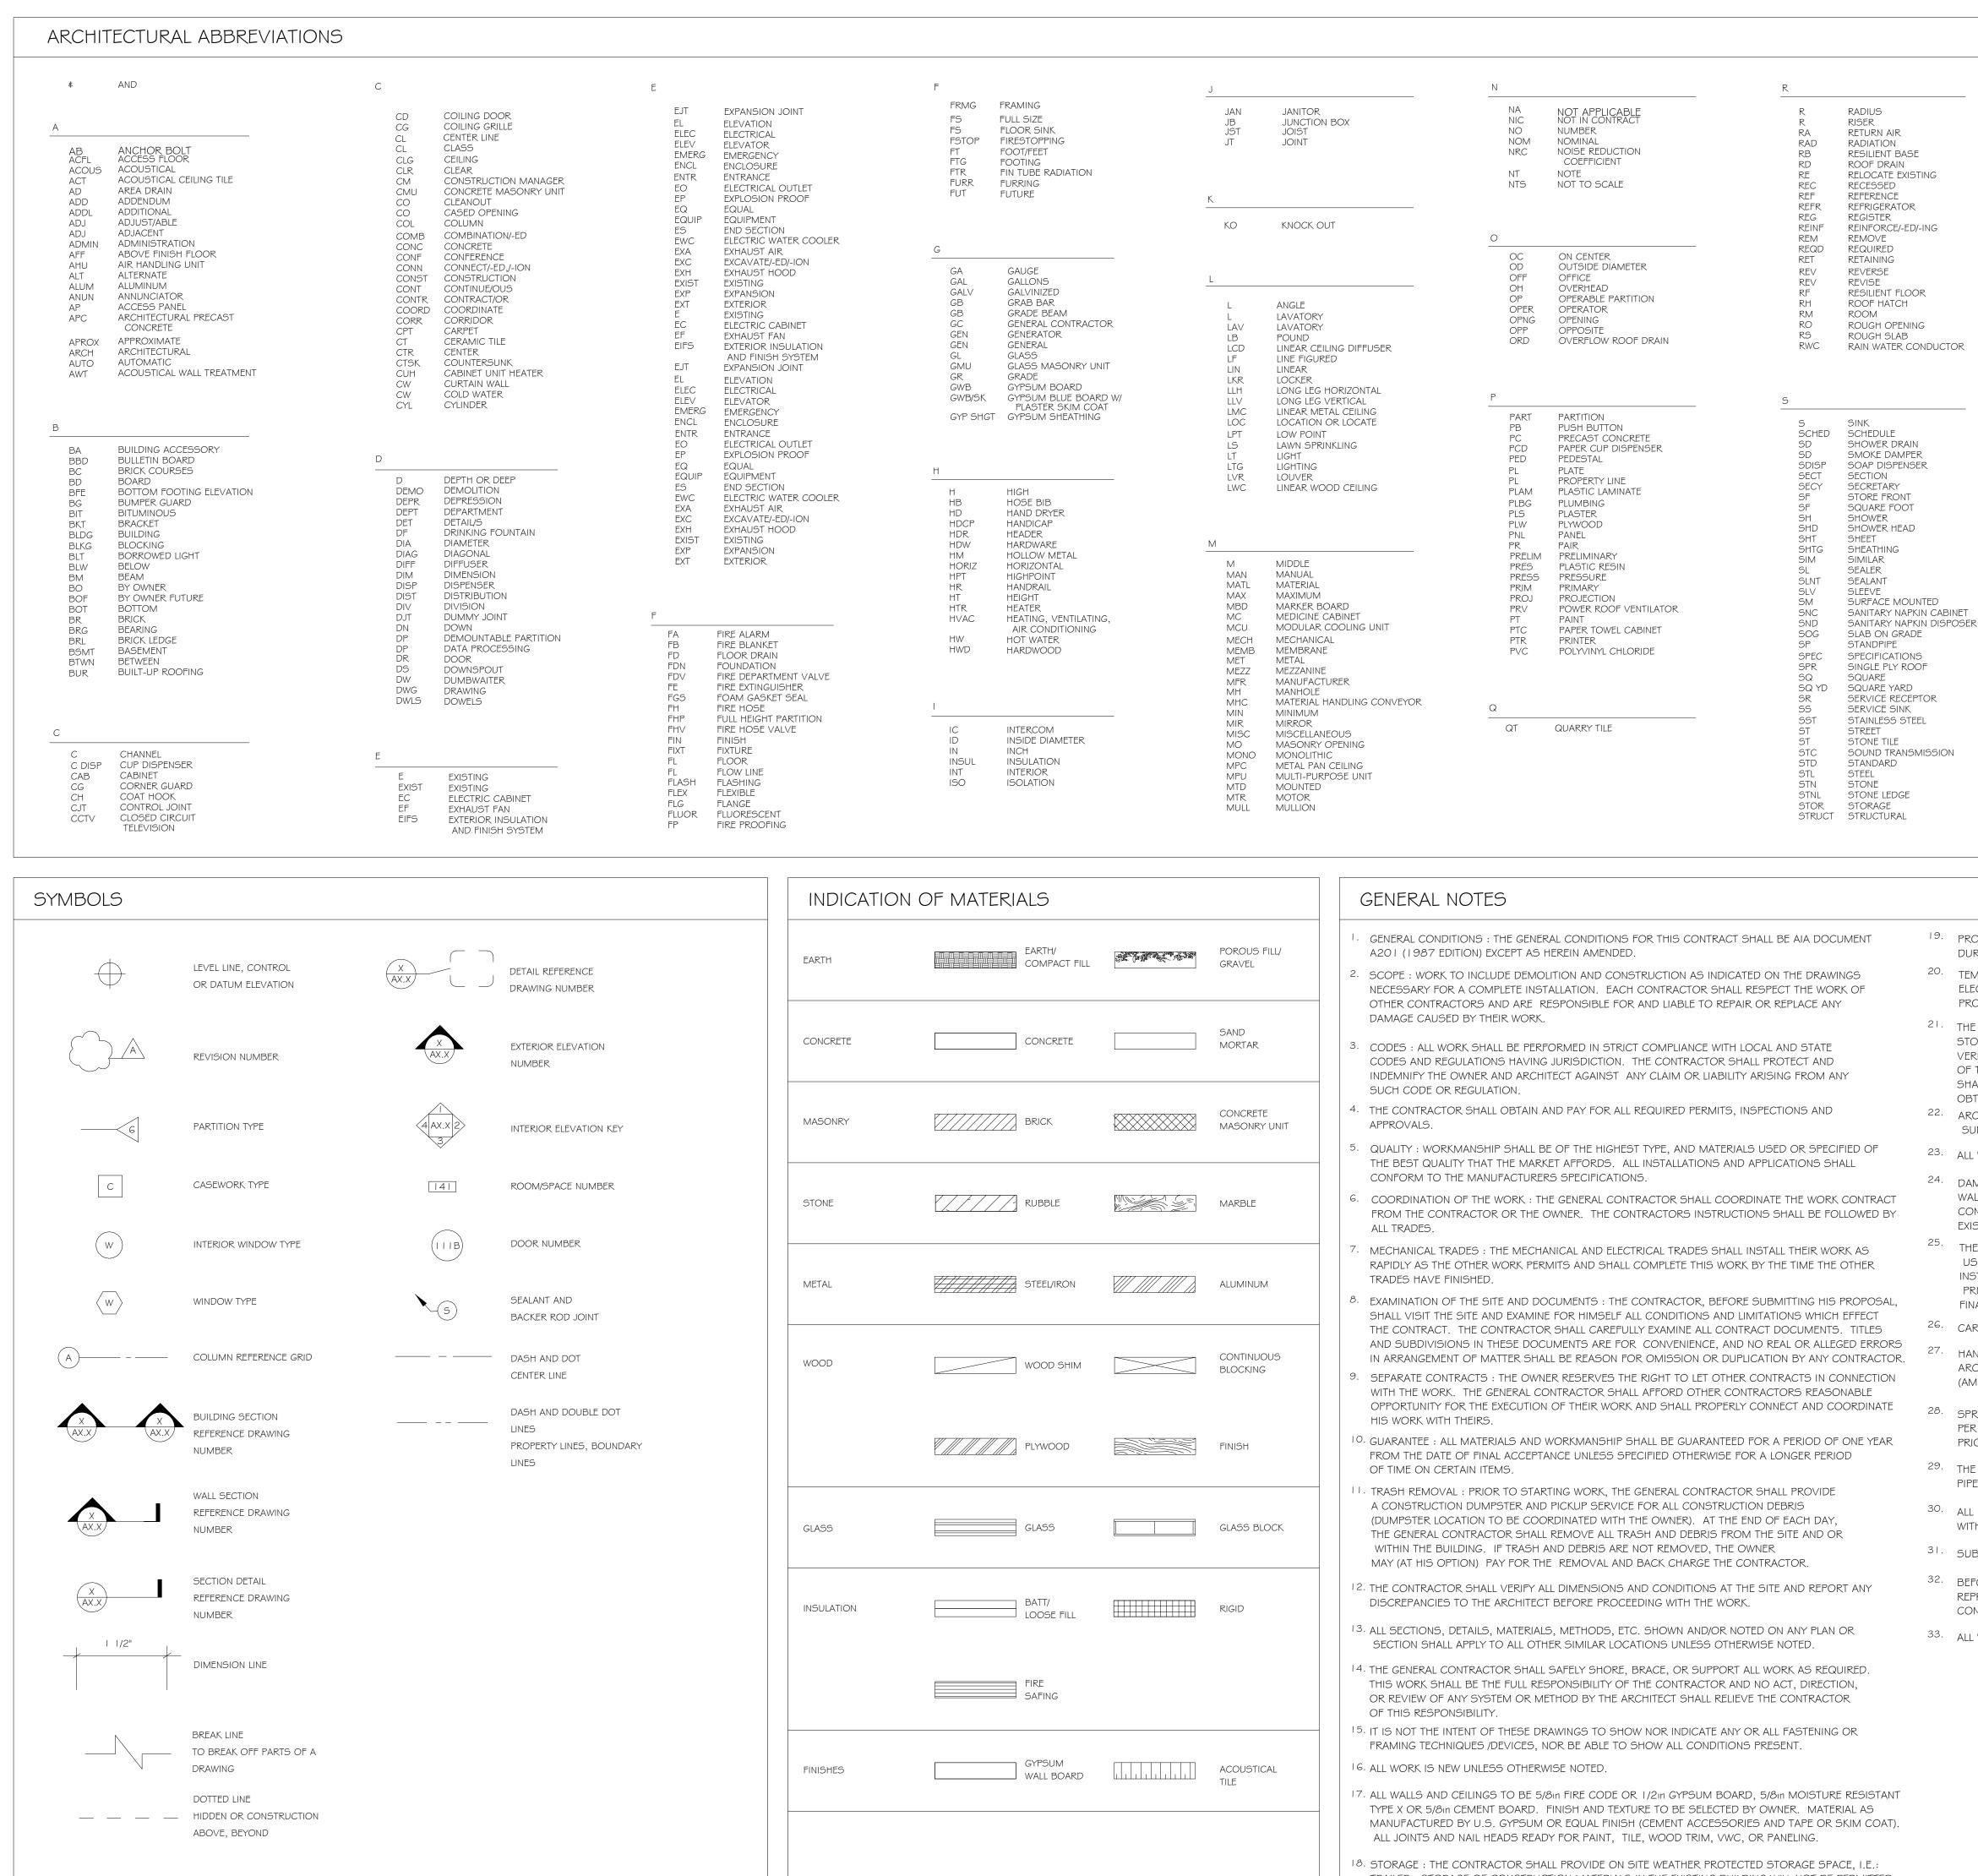



MATERIALS		GENERAL NOTES		
EARTH/	POROUS FILL/	<ol> <li>GENERAL CONDITIONS : THE GENERAL CONDITIONS FOR THIS CONTRACT SHALL BE AIA DOCUMENT A201 (1987 EDITION) EXCEPT AS HEREIN AMENDED.</li> </ol>	19.	PROTECTION : THI DURING CONSTRL
COMPACT FILL	GRAVEL	2. SCOPE : WORK TO INCLUDE DEMOLITION AND CONSTRUCTION AS INDICATED ON THE DRAWINGS NECESSARY FOR A COMPLETE INSTALLATION. EACH CONTRACTOR SHALL RESPECT THE WORK OF OTHER CONTRACTORS AND ARE RESPONSIBLE FOR AND LIABLE TO REPAIR OR REPLACE ANY	20.	TEMPORARY SER ELECTRICITY) AND PROJECT.
	SAND	DAMAGE CAUSED BY THEIR WORK.	21.	THE CONTRACTOR
CONCRETE	MORTAR	3. CODES : ALL WORK SHALL BE PERFORMED IN STRICT COMPLIANCE WITH LOCAL AND STATE CODES AND REGULATIONS HAVING JURISDICTION. THE CONTRACTOR SHALL PROTECT AND INDEMNIFY THE OWNER AND ARCHITECT AGAINST ANY CLAIM OR LIABILITY ARISING FROM ANY SUCH CODE OR REGULATION.		STORM DRAINS, VERIFY ACTUAL IN OF TRENCHING AN SHALL BE REPORT OBTAINED FROM
BRICK	CONCRETE MASONRY UNIT	4. THE CONTRACTOR SHALL OBTAIN AND PAY FOR ALL REQUIRED PERMITS, INSPECTIONS AND APPROVALS.	22.	ARCHITECTURAL, SUBMIT SHOP D
		5. QUALITY : WORKMANSHIP SHALL BE OF THE HIGHEST TYPE, AND MATERIALS USED OR SPECIFIED OF THE BEST QUALITY THAT THE MARKET AFFORDS. ALL INSTALLATIONS AND APPLICATIONS SHALL CONFORM TO THE MANUFACTURERS SPECIFICATIONS.	23.	ALL WORK IS NEW
			24.	DAMAGE : THE GE WALLS, CEILINGS,
RUBBLE	MARBLE	6. COORDINATION OF THE WORK : THE GENERAL CONTRACTOR SHALL COORDINATE THE WORK CONTRACT FROM THE CONTRACTOR OR THE OWNER. THE CONTRACTORS INSTRUCTIONS SHALL BE FOLLOWED BY ALL TRADES.		CONSTRUCTION T EXISTING ADJACE
STEEL/IRON	ALUMINUM	7. MECHANICAL TRADES : THE MECHANICAL AND ELECTRICAL TRADES SHALL INSTALL THEIR WORK AS RAPIDLY AS THE OTHER WORK PERMITS AND SHALL COMPLETE THIS WORK BY THE TIME THE OTHER TRADES HAVE FINISHED.	25.	THE GENERAL CO USED ON THIS JO INSTRUCTION MA PRIOR TO FINAL
		8. EXAMINATION OF THE SITE AND DOCUMENTS : THE CONTRACTOR, BEFORE SUBMITTING HIS PROPOSAL, SHALL VISIT THE SITE AND EXAMINE FOR HIMSELF ALL CONDITIONS AND LIMITATIONS WHICH EFFECT	26.	FINAL ACCEPTANC
	CONTINUOUS	THE CONTRACT. THE CONTRACTOR SHALL CAREFULLY EXAMINE ALL CONTRACT DOCUMENTS. TITLES AND SUBDIVISIONS IN THESE DOCUMENTS ARE FOR CONVENIENCE, AND NO REAL OR ALLEGED ERRORS IN ARRANGEMENT OF MATTER SHALL BE REASON FOR OMISSION OR DUPLICATION BY ANY CONTRACTOR.	27.	HANDICAPPED RE
WOOD SHIM	BLOCKING	9. SEPARATE CONTRACTS : THE OWNER RESERVES THE RIGHT TO LET OTHER CONTRACTS IN CONNECTION WITH THE WORK. THE GENERAL CONTRACTOR SHALL AFFORD OTHER CONTRACTORS REASONABLE		ARCHITECTURAL A
		OPPORTUNITY FOR THE EXECUTION OF THEIR WORK AND SHALL PROPERLY CONNECT AND COORDINATE HIS WORK WITH THEIRS.	28.	SPRINKLER HEAD
PLYWOOD	FINISH	<sup>10.</sup> GUARANTEE : ALL MATERIALS AND WORKMANSHIP SHALL BE GUARANTEED FOR A PERIOD OF ONE YEAR FROM THE DATE OF FINAL ACCEPTANCE UNLESS SPECIFIED OTHERWISE FOR A LONGER PERIOD		PER CODE. SHOF PRIOR TO INSTALI
		OF TIME ON CERTAIN ITEMS.	29.	THE GENERAL CON PIPES, INSERTS,
		11. TRASH REMOVAL : PRIOR TO STARTING WORK, THE GENERAL CONTRACTOR SHALL PROVIDE A CONSTRUCTION DUMPSTER AND PICKUP SERVICE FOR ALL CONSTRUCTION DEBRIS		
GLASS	GLASS BLOCK	(DUMPSTER LOCATION TO BE COORDINATED WITH THE OWNER). AT THE END OF EACH DAY,	30.	ALL INTERIOR FINIS WITH A FLAME SP
GLASS	GLASS BLOCK	THE GENERAL CONTRACTOR SHALL REMOVE ALL TRASH AND DEBRIS FROM THE SITE AND OR WITHIN THE BUILDING. IF TRASH AND DEBRIS ARE NOT REMOVED, THE OWNER		
		MAY (AT HIS OPTION) PAY FOR THE REMOVAL AND BACK CHARGE THE CONTRACTOR.	31.	SUBMIT SAMPLES
BATT/	RIGID	<sup>12.</sup> THE CONTRACTOR SHALL VERIFY ALL DIMENSIONS AND CONDITIONS AT THE SITE AND REPORT ANY DISCREPANCIES TO THE ARCHITECT BEFORE PROCEEDING WITH THE WORK.	32.	BEFORE COMMEN REPRESENTATIVE CONSTRUCTION N
		<sup>13.</sup> ALL SECTIONS, DETAILS, MATERIALS, METHODS, ETC. SHOWN AND/OR NOTED ON ANY PLAN OR SECTION SHALL APPLY TO ALL OTHER SIMILAR LOCATIONS UNLESS OTHERWISE NOTED.	33.	ALL WOODS BLOC
FIRE SAFING		<sup>14.</sup> THE GENERAL CONTRACTOR SHALL SAFELY SHORE, BRACE, OR SUPPORT ALL WORK AS REQUIRED. THIS WORK SHALL BE THE FULL RESPONSIBILITY OF THE CONTRACTOR AND NO ACT, DIRECTION, OR REVIEW OF ANY SYSTEM OR METHOD BY THE ARCHITECT SHALL RELIEVE THE CONTRACTOR		
		OF THIS RESPONSIBILITY. <sup>15.</sup> IT IS NOT THE INTENT OF THESE DRAWINGS TO SHOW NOR INDICATE ANY OR ALL FASTENING OR FRAMING TECHNIQUES /DEVICES, NOR BE ABLE TO SHOW ALL CONDITIONS PRESENT.		
GYPSUM	ACOUSTICAL	16. ALL WORK IS NEW UNLESS OTHERWISE NOTED.		
WALL BOARD	 TILE	<sup>17.</sup> ALL WALLS AND CEILINGS TO BE 5/8 <sup>in</sup> FIRE CODE OR 1/2 <sup>in</sup> GYPSUM BOARD, 5/8 <sup>in</sup> MOISTURE RESISTANT TYPE X OR 5/8 <sup>in</sup> CEMENT BOARD. FINISH AND TEXTURE TO BE SELECTED BY OWNER. MATERIAL AS MANUFACTURED BY U.S. GYPSUM OR EQUAL FINISH (CEMENT ACCESSORIES AND TAPE OR SKIM COAT). ALL JOINTS AND NAIL HEADS READY FOR PAINT, TILE, WOOD TRIM, VWC, OR PANELING.		
		<sup>18.</sup> STORAGE : THE CONTRACTOR SHALL PROVIDE ON SITE WEATHER PROTECTED STORAGE SPACE, I.E.: TRAILER. STORAGE OF CONSTRUCTION MATERIALS IN THE EXISTING BUILDING WILL NOT BE PERMITTED.		


6		PROJECT NAME 10 PILLION CT RESIDENCES
STSSTEEL STRUCTURESUPVSUPERVISORSUSPSUSPENDEDSWSTEEL WINDOWSSWSWITCHSWDSOFTWOODSYMSYMMETRICAL	W WIDTH/WIDE W WIDE FLANGE W/ WITH W/O WITHOUT WC WATER CLOSET WC WALL COVERING WD WOOD WDW WINDOW WG WALL GUARD WH WALL HYDRANT WHCH WHEELCHAIR	PROJECT ADDRESS 10 PILLION COURT NEWTON, MA
T TOP TAN TANGENT TBD TACKBOARD TC TIME CLOCK TCAB TOWEL CABINET TDISP TISSUE DISPENSER TDR TRENCH DRAIN TEL TELEPHONE	WHTRWATER HEATERWPWATERPROOFWRWASTE RECEPTACLEWSWEATHERSTRIPWSCTWAINSCOTWTWINDOW TREATMENTWTWEIGHTWWWOOD WINDOWWWFWELDED WIRE FABRIC	CLIENT GFC DEVELOPMENT INC.
TEL TELLFHONE TEMP TEMPERATURE TER TERRAZZO TG TONGUE & GROOVE THRES THRESHOLD TPG TEMPERED PLATE GLASS TPH TOILET PAPER HOLDER TR TREAD TRANSF TRANSFORMER TS TUBE SECTION TV TELEVISION TVP TYPICAL		ARCHITECT
U URINAL UC UNDERCUT UFD UNDER FLOOR DUCT UG UNDERGROUND UH UNIT HEATER UNFIN UNFINISHED UNO UNLESS NOTED OTHERWISE US UTILITY SHELF UTIL UTILITY		KHALSA
V VC VALVE CABINET VENT VENTILATION VERT VERTICAL VEST VESTIBULE VR VAPOR RETARDER VTR VENT THROUGH ROOF		17 IVALOO STREET SUITE 400 SOMERVILLE, MA 02143 TELEPHONE: 617-591-8682 FAX: 617-591-2086 CONSULTANTS:
THE CONTRACTOR SHALL PROTECT ALL PUBLIC TRUCTION. ERVICES : THE CONTRACTOR WILL PAY FOR EXI AND WILL TURN OVER THESE SERVICES TO THE FOR SHALL VERIFY LOCATION AND ACTUAL DEP 6, GAS AND WATER MAINS, ELECTRIC LINES AN INVERTS OF SANITARY AND STORM LINES BY AND CONSTRUCTION. ANY DISCREPANCY IN T DRTED TO THE ARCHITECT. ALL NECESSARY PE IM PROPER AUTHORITIES. AL, MECHANICAL, ELECTRICAL, ELEVATOR, & SPI ORAWINGS TO THE ARCHITECT FOR APPROV/ IEW UNLESS OTHERWISE NOTED.	STING SERVICES (WATER, TELEPHONE AND OWNER UPON FINAL ACCEPTANCE OF THIS TH OF ALL EXISTING SANITARY PIPING, ND PIPES. HE IS ALSO ADVISED TO HAND DUG TEST PITS WELL IN ADVANCE THIS PLAN AND ACTUAL FIELD CONDITIONS RMITS AND APPROVALS MUST BE RINKLER : EACH CONTRACTOR SHALL AL PRIOR TO FABRICATION.	COPYRIGHT KDI © 2017 THESE DRAWINGS ARE NOW AND DO REMAIN THE SOLE PROPERTY OF KHALSA DESIGN INC. USE OF THESE PLANS OR ANY FORM OF REPRODUCTION OF THIS DESIGN IN WHOLE OR IN PART WITHOUT EXPRESS WRITTEN CONSENT IS PROHIBITED AND SHALL RESULT IN THE FULLEST EXTENT OF PROSECUTION UNDER LAW
GENERAL CONTRACTOR IS RESPONSIBLE FOR GS, FLOORS, FURNITURE AND FURNISHINGS. N TO BE PATCHED, REPAIRED AND/OR REPLACE CENT SURFACES AT NO ADDITIONAL COST TO CONTRACTOR SHALL PREPARE A BOOKLET CON 3 JOB WITH NAMES, ADDRESSES AND TELEPHO MANUALS FOR EQUIPMENT AND MATERIALS IN AL ACCEPTANCE OF BUILDING, AND PRESENT B	DAMAGED SURFACES DUE TO ED AS REQUIRED AND BLEND TO MATCH OWNER. ITAINING : LIST OF SUBCONTRACTORS DNE NUMBERS. ALL WARRANTIES AND STALLED WILL BE ISSUED TO THE OWNER	
ANCE OF OWNER. IR TILE : CARPET AND/OR TILE AS SELECTED AS REQUIREMENTS : THE GENERAL CONTRACTOR AL ACCESS BOARD (AAB) CODE FOR THE STATE /ITH DISABILITIES ACT) TO ENSURE THAT THIS	WILL ACQUAINT HIMSELF WITH THE E OF MASSACHUSETTS AND THE ADA	Project number 17001
AD LOCATION : REFER TO N.F.P.A. STANDARDS 10P DRAWINGS ARE REQUIRED TO BE SUBMIT TALLATION.		Date 07/05/2017 Drawn by KDI Checked by JSK
ALLATION. CONTRACTOR SHALL COORDINATE THE LOCATIO 5, BOXES, HANGERS, ETC.	ON AND SIZE OF OPENINGS FOR VENTS,	Scale     1:1       REVISIONS
INISHES AND FURNISHINGS FOR CEILINGS, WA SPREAD RATING OF 0 TO .25.	LL AND FLOORS SHALL BE CLASS 1 in	No. Description Date
LES OF ALL PAINTS AND STAINS FOR APPROVA MENCING WORK, THE GENERAL CONTRACTOR W VE TO OUTLINE PHASING OF CONSTRUCTION A N MATERIALS AND/OR EQUIPMENT. LOCKING TO BE PRESSURE TREATED, FIRE RETA	ILL MEET WITH THE APPOINTED COMPANY ND DISPOSITION OF EXISTING	
		General Notes & Abreviations
		A-001


**10 PILLION CT RESIDENCES** 



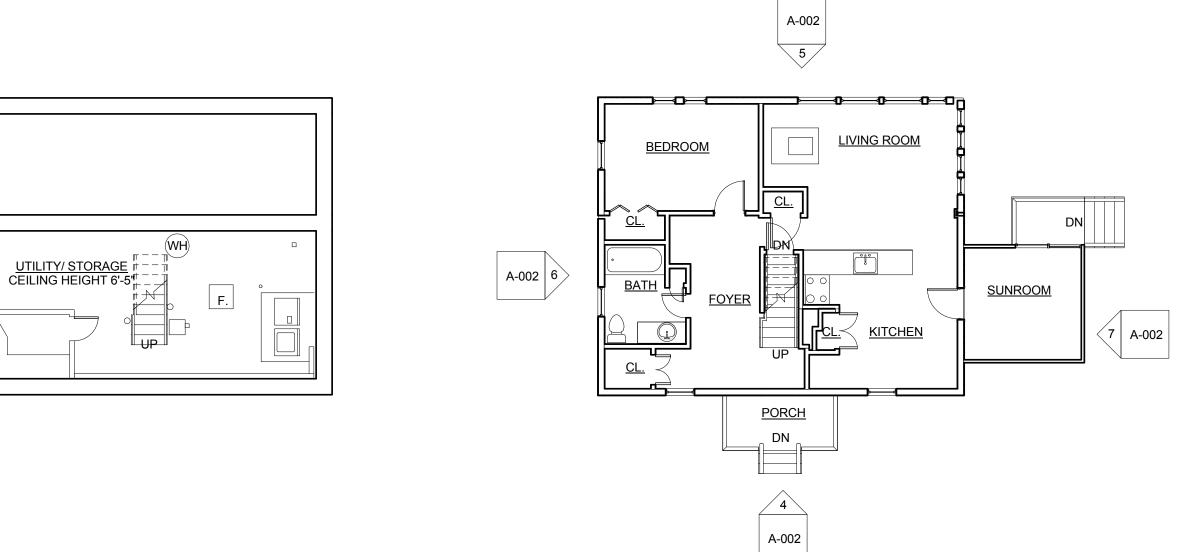


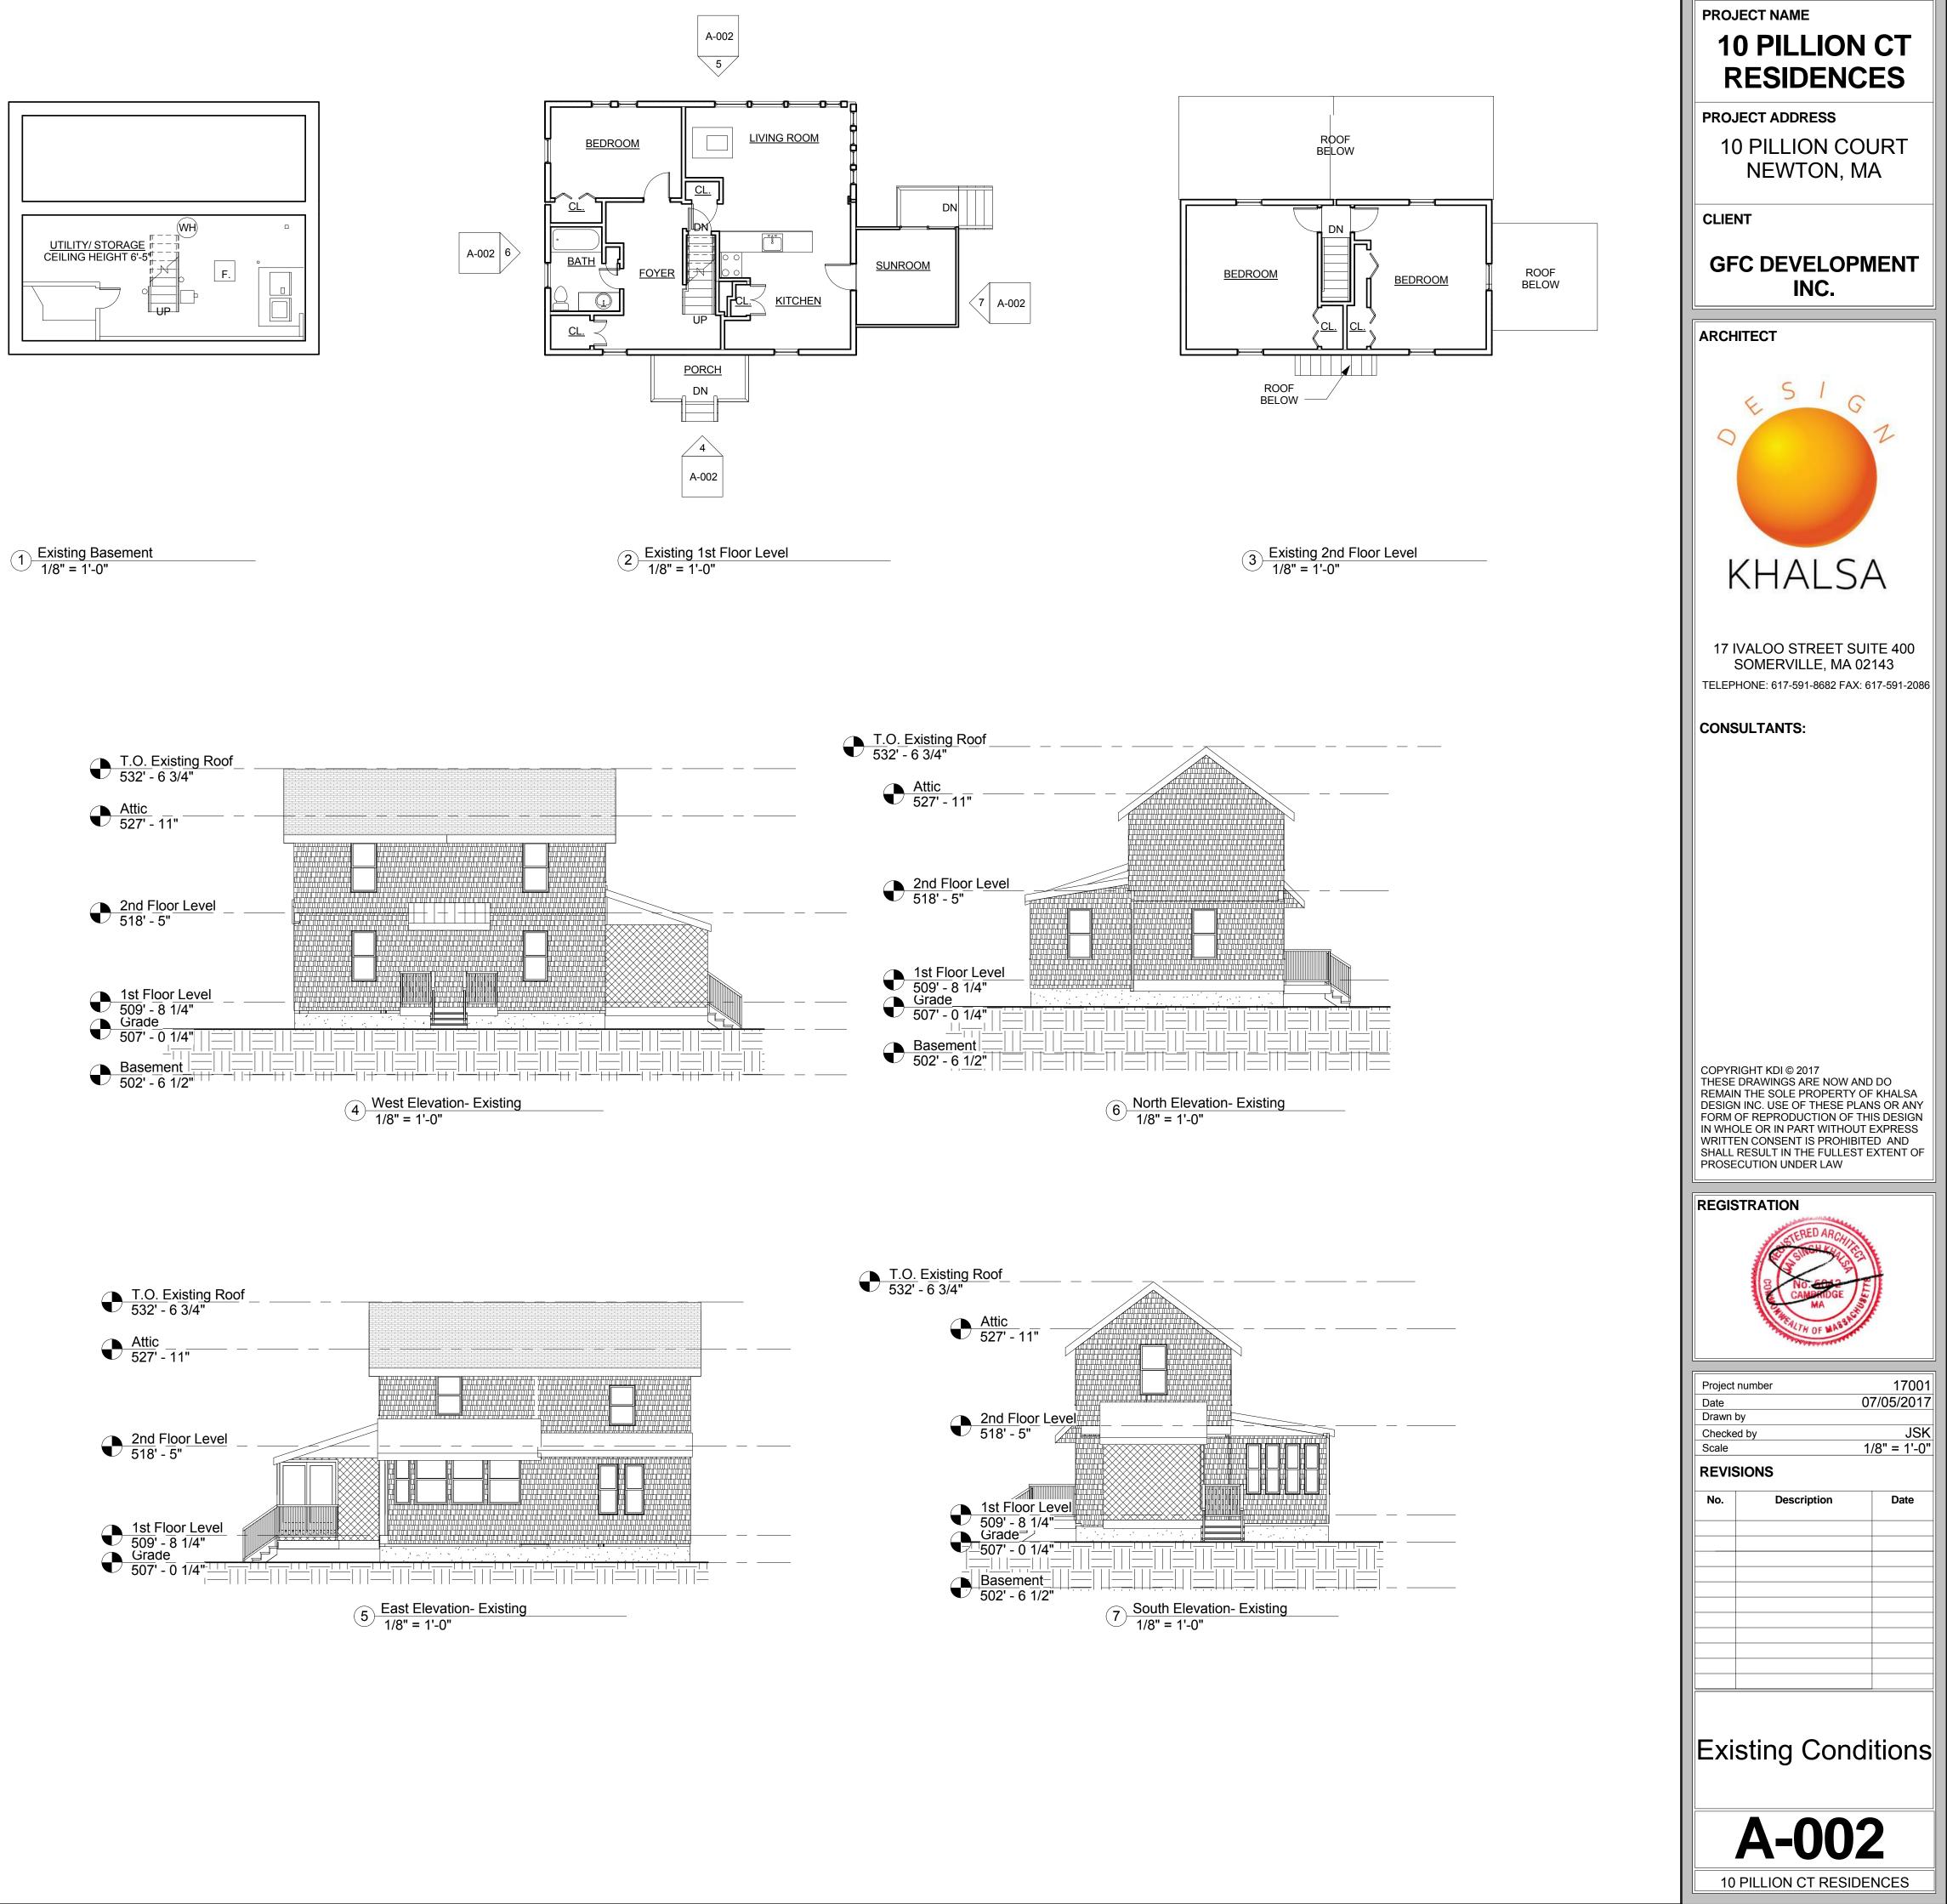

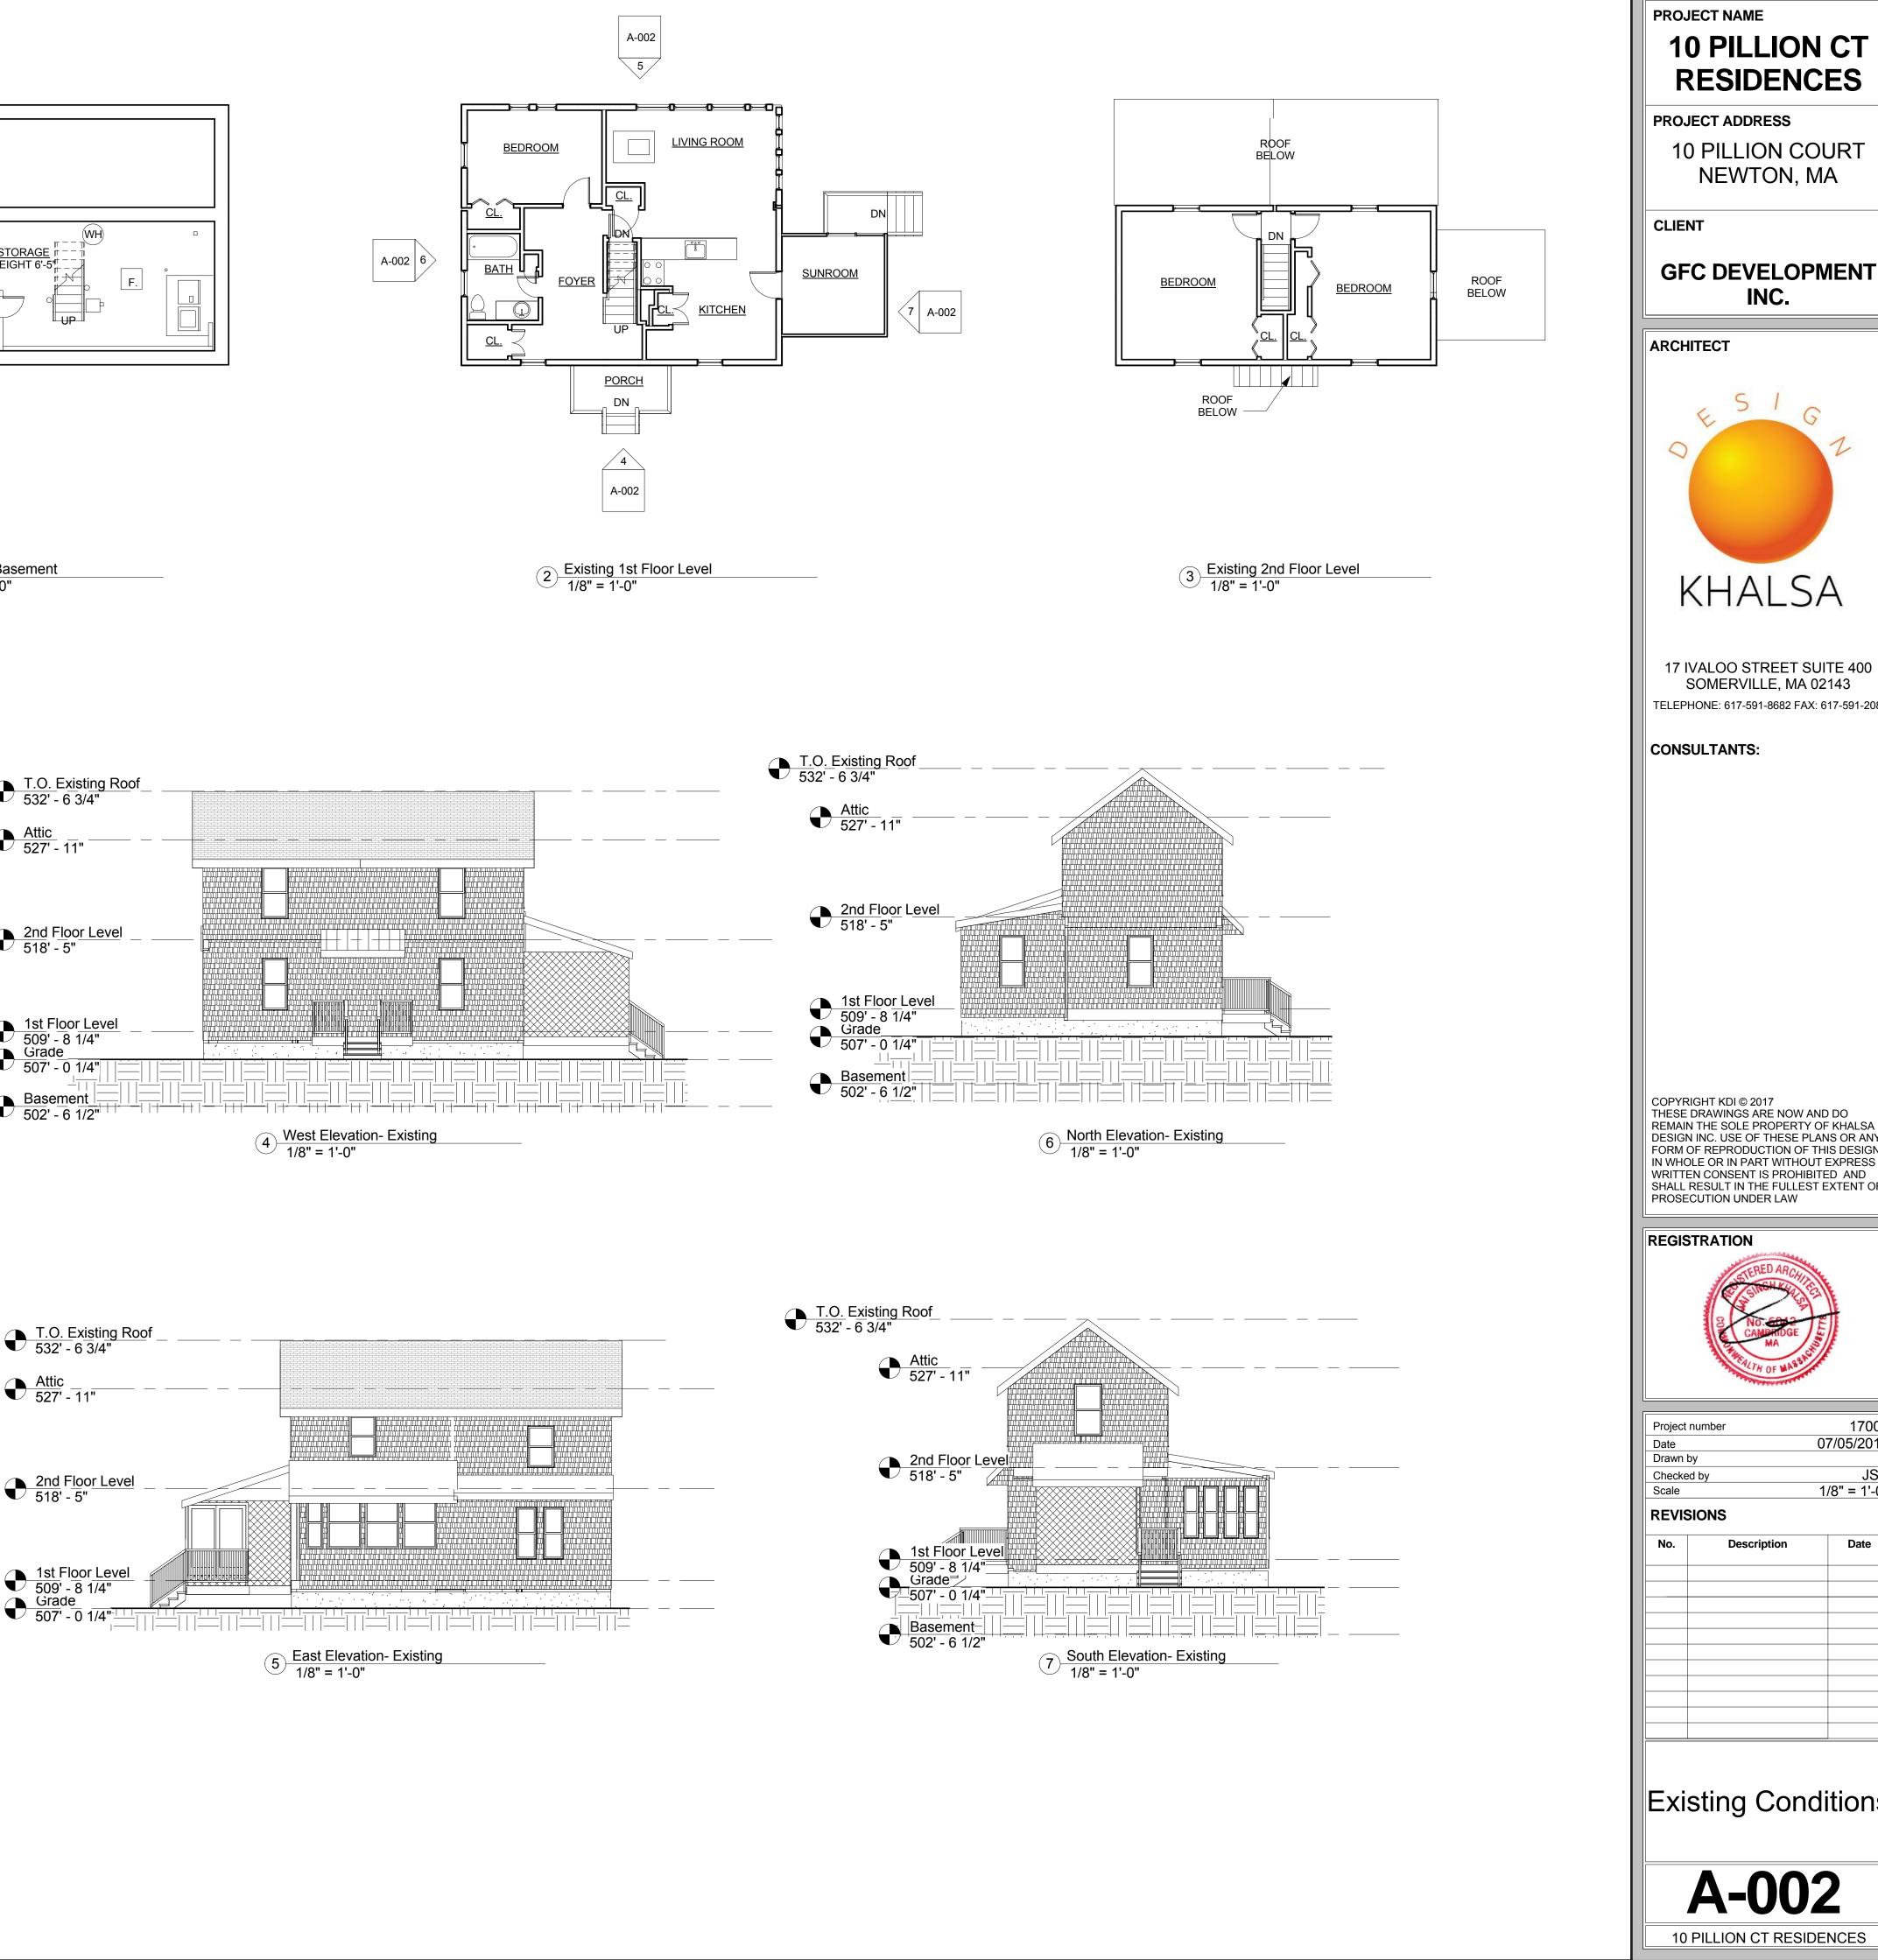


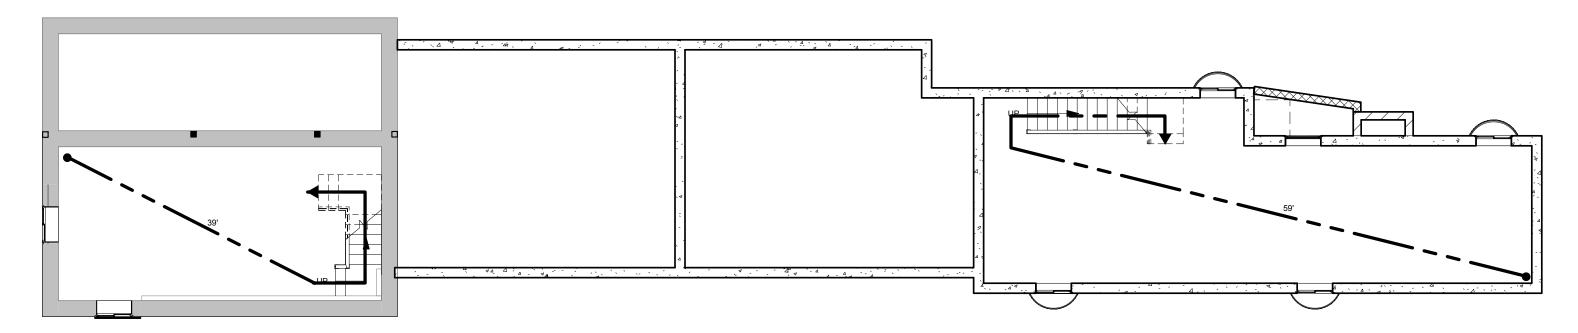


1 Code Review - Basement 1/8" = 1'-0"

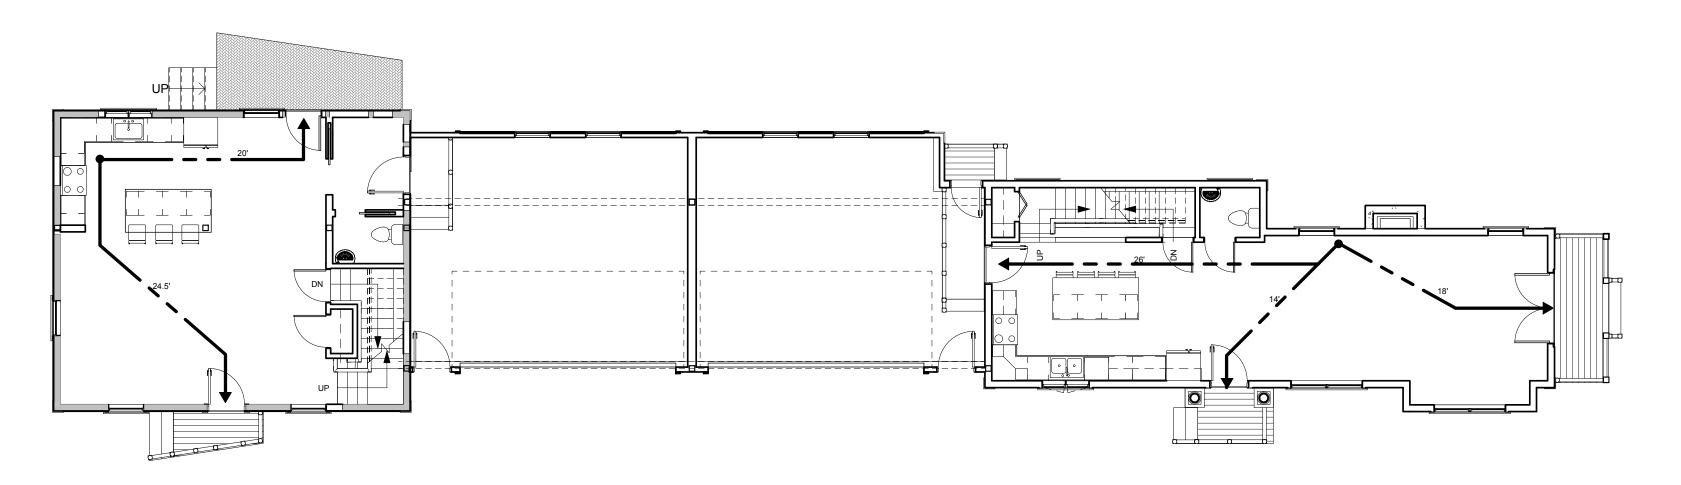


2 Code Review - 1st Floor Level 1/8" = 1'-0"

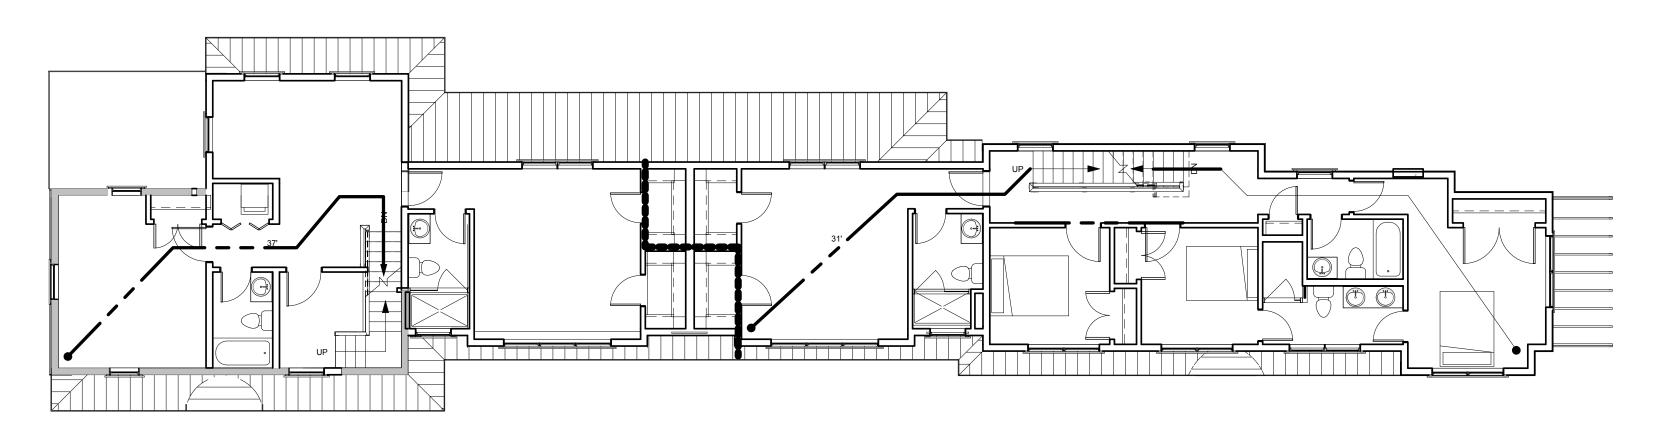

3 Code Review - 2nd Floor Level 1/8" = 1'-0"

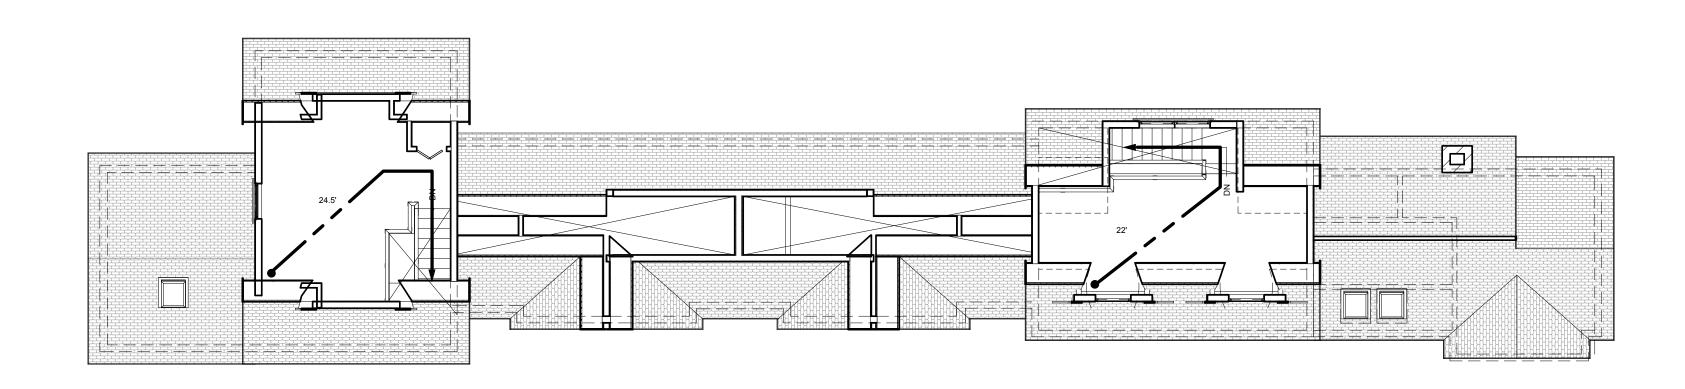

4 <u>Code Review - 3rd Floor</u> 1/8" = 1'-0"

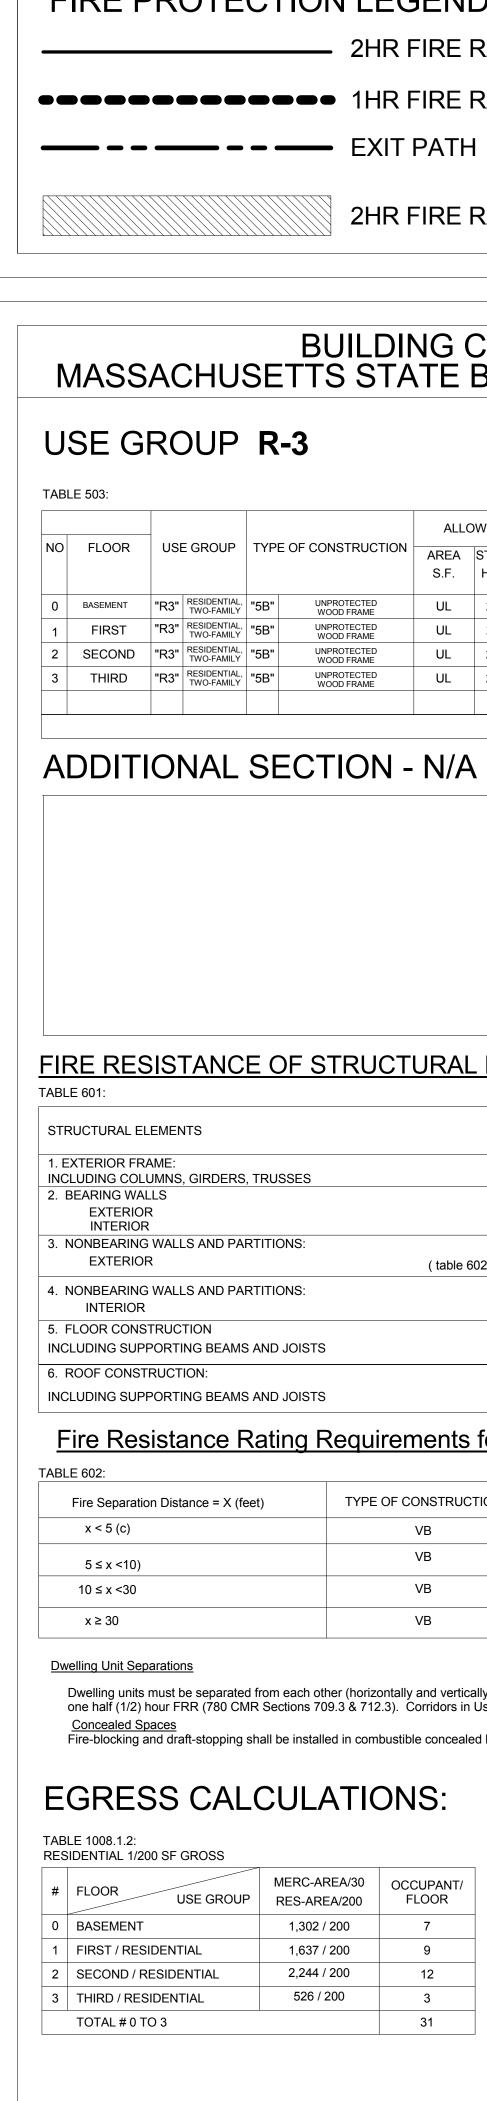

## FIRE PROTECTION LEGEND

- 2HR FIRE RATED WALL/ PARTITION
- - EXIT PATH
  - 2HR FIRE RATED FLOOR CEILING ASSEMBLY

## BUILDING CODE REVIEW MASSACHUSETTS STATE BUILDING CODE-6TH EDITION

	ALLOWED		INCREASE		TOTAL	PRO	VIDED	
ONSTRUCTION	AREA	STORIES/	AREA		ALLOWED	AREA	STORIES/	REMARKS
	S.F.	HEIGHT	S.F.	STORIES		S.F.	HEIGHT	
NPROTECTED VOOD FRAME	UL	2.5/36'	NOT USED	0	UL	1,302	0/32'-4"	
NPROTECTED VOOD FRAME	UL	2.5/36'	NOT USED	0	UL	1,637	1/32'-4"	
NPROTECTED VOOD FRAME	UL	2.5/36'	NOT USED	0	UL	2,244	1/32'-4"	
NPROTECTED VOOD FRAME	UL	2.5/36'	NOT USED	0.5	UL	526	0.5/32'-4"	
TOTAL BUILDING AREA = 5,709 S.F.								

TRUCTURAL	ELEMENTS:

	TYPE OF CONSTRUCTION	FIRE RATING FILE #
	VB	FIRE RATING FILE #
	0HR	
	0HR 1HR	
( table 602)	0HR	
	0HR	
	0HR	
	0HR	

## Fire Resistance Rating Requirements for Exterior Walls

TYPE OF CONSTRUCTION	NOT USED	Occupancy R, S-2 & U Type VA,B
VB		1
VB		1
VB		0
VB		0

Dwelling units must be separated from each other (horizontally and vertically) and the rest of the building by construction that provides at least a one half (1/2) hour FRR (780 CMR Sections 709.3 & 712.3). Corridors in Use Group R-3 are required to provide a 30 minute FRR per Table 1018.1.

Fire-blocking and draft-stopping shall be installed in combustible concealed locations in accordance with 780 CMR 717.0

EA/30 A/200	OCCUPANT/ FLOOR
200	7
200	9
200	12
00	3
	31

#       STAIR       0.2 * OCCUPANTS       ALLOWED         STAIR (TYP.)       3.1"       36"       36"         TYP. ALL BLDGS.	ТАВ	TABLE 1009.2							
#       STAIR       0.2 * OCCUPANTS       ALLOWED         STAIR (TYP.)       3.1"       36"       36"         TYP. ALL BLDGS.	WIDTH IN INCHES								
O.2 * OCCUPANTS     ALLOWED       STAIR (TYP.)     3.1"     36"       36"     36"       TYP. ALL BLDGS.     0       DOOR WIDTH     0       WIDTH IN INCHES     000RS 0.15/OCCUPANT       #     DOOR       CORRIDOR     0.15 * OCCUPANTS       ALLOWED     36"	#		EGRESS CAPACITY	WIDTH IN INCH	WIDTH PROVIDED				
TYP. ALL BLDGS.     Image: Construction of the second		STAIR	0.2 * OCCUPANTS	ALLOWED					
DOOR WIDTH         WIDTH IN INCHES         DOORS 0.15/OCCUPANT         #       DOOR         EGRESS CAPACITY       WIDTH IN INCH         OOR       EGRESS CAPACITY         WIDTH IN INCH       O.15 * OCCUPANTS         ALLOWED       ALLOWED		STAIR (TYP.)	3.1"	36"	36"				
DOOR WIDTH         WIDTH IN INCHES         DOORS 0.15/OCCUPANT         #       DOOR         EGRESS CAPACITY       WIDTH IN INCH         OOR       EGRESS CAPACITY         WIDTH IN INCH       O.15 * OCCUPANTS         ALLOWED       ALLOWED									
DOOR WIDTH         WIDTH IN INCHES         DOORS 0.15/OCCUPANT         #       DOOR         CORRIDOR       EGRESS CAPACITY         WIDTH IN INCH       WIDTH PROVIDE         EXIT       2.25"         32"       36"									
WIDTH IN INCHES         DOORS 0.15/OCCUPANT         #       DOOR       EGRESS CAPACITY       WIDTH IN INCH       WIDTH PROVIDE         EXIT       2.25"       2.25"       32"       36"       7         Image: Second Sec	TY	P. ALL BLDGS.							
#         CORRIDOR         0.15 * OCCUPANTS         ALLOWED           EXIT         2.25"         2.25"         32"         36"         7	WIDTH IN INCHES								
EXIT 2.25" 2.25" 32" 36" 7	#	DOOR	EGRESS CAPACITY	WIDTH IN INCH	WIDTH PROVIDED				
		CORRIDOR	0.15 * OCCUPANTS	ALLOWED					
		EXIT	2.25" 2.25"	32" 36"	36" 72"				
EXTERIOR EGRESS DOORS 2.25" 32" 36"	EX	TERIOR EGRESS	S DOORS 2.25"	32"	36"				

PROJECT NAME 10 PILLION CT RESIDENCES						
PROJECT ADDRESS 10 PILLION COURT NEWTON, MA						
CLIENT						
GFC DEVELOPMENT INC.						
ARCHITECT						
Q E S I G Z						
KHALSA						
17 IVALOO STREET SUITE 400 SOMERVILLE, MA 02143 TELEPHONE: 617-591-8682 FAX: 617-591-2086						
CONSULTANTS:						
COPYRIGHT KDI © 2017 THESE DRAWINGS ARE NOW AND DO REMAIN THE SOLE PROPERTY OF KHALSA DESIGN INC. USE OF THESE PLANS OR ANY FORM OF REPRODUCTION OF THIS DESIGN IN WHOLE OR IN PART WITHOUT EXPRESS WRITTEN CONSENT IS PROHIBITED AND SHALL RESULT IN THE FULLEST EXTENT OF PROSECUTION UNDER LAW						
REGISTRATION						
B No. Sol 2 CAMPRODE MA MA MA MA MA MA MA MA MA MA MA MA MA						
Project number         17001           Date         07/05/2017						
Drawn by     NB       Checked by     JSK       Scale     As indicated						
REVISIONS						
No. Description Date						
Code Review & Egress Calculations						
A-010						

ZONING CHART ZONE MR1							
MIN. LOT SIZE	15,000 S.F	10,559 +/- S.F	10,559 +/- S.F	PRE-EXIST. NON-CONFORMING	CREATE OR BE USED IN		
LOT AREA PER UNIT	4,000 S.F.	1DU= 10,559 S.F	20U= 5,279 S.F/DU	COMPLIES	2. AN INCRE WITH AND N NEIGHBORH		
LOT COVERAGE (MAX.)	25% / 2,640 SF	9.4% / 993 SF	25% / 2,624 SF	COMPLIES	<u>3.2.12 REAR</u> A. SPECIAL		
FRONTAGE (MIN.)	80'	10' / 65'-6" (3.2.12.A.)	10'	PRE-EXIST. NON-CONFORMING	THAT SATIS		
OPEN SPACE (MIN.)	50% / 5,280 SF		55.7% / 5,886 SF	COMPLIES	B. DIMENSIO 1. VE		
MIN. YARD SETBACKS					FEET WIDE		
FRONT (MIN.)	25' (3.2.12 3A)	12.1'	12'-2"	PRE-EXIST. NON-CONFORMING	UTILIZED PERCENT C		
LEFT SIDE (MIN.)	7.5'	14.8'	10'-0"	COMPLIES	2. LO MEASURED		
RIGHT SIDE (MIN.)	7.5'	12.8'	8'-9"	COMPLIES	3. SE		
REAR (MIN.)	15'	202'-5"	111'-7"	COMPLIES	THAN		
					BUILDING T		
BUILDING HEIGHT (MAX.)	36' SLOPED ROOF/ 30' FLAT ROOF	25.6' (SLOPED ROOF)	32'-8" (SLOPED ROOF)	COMPLIES	MINIMUM DI		
NO. OF STORIES (MAX.) 2.5		1.5	2.5	COMPLIES	BUILDING MINIMUM		
STORIES BY SPECIAL PERMIT (MAX.)	3				4. HE CON		
FLOOR AREA RATIO MAX. (F.A.R.)	0.48 (5,068 S.F.)	0.13/ 1,324 SF	0.48/ 5,052 SF	COMPLIES	STRUCTURI		
PARKING	2 PER DU	XX	4 SPACES	COMPLIES			


ALLOWABLE F.A.R. CALCULATION					
LOT AREA	10,559 SF				
EASEMENT AREA	1,396 SF				
ALLOWABLE FAR	10,559 SF X 0.48 = 5,068 SF PROPOSED FAR <b>5,052 SF</b> (COMPLIES)				


F.A.R Area Proposed Level Area							


1st Floor Level	2435 SF
2nd Floor Level	2116 SF
Attic	501 SF
	5052 SF


		EXISTING	F.A.R.
--	--	----------	--------

BASEMENT LEVEL	0 SF
FIRST FLOOR	858 SF
SECOND FLOOR	466 SF
ATTIC	0 SF
TOTAL	1,324 SF

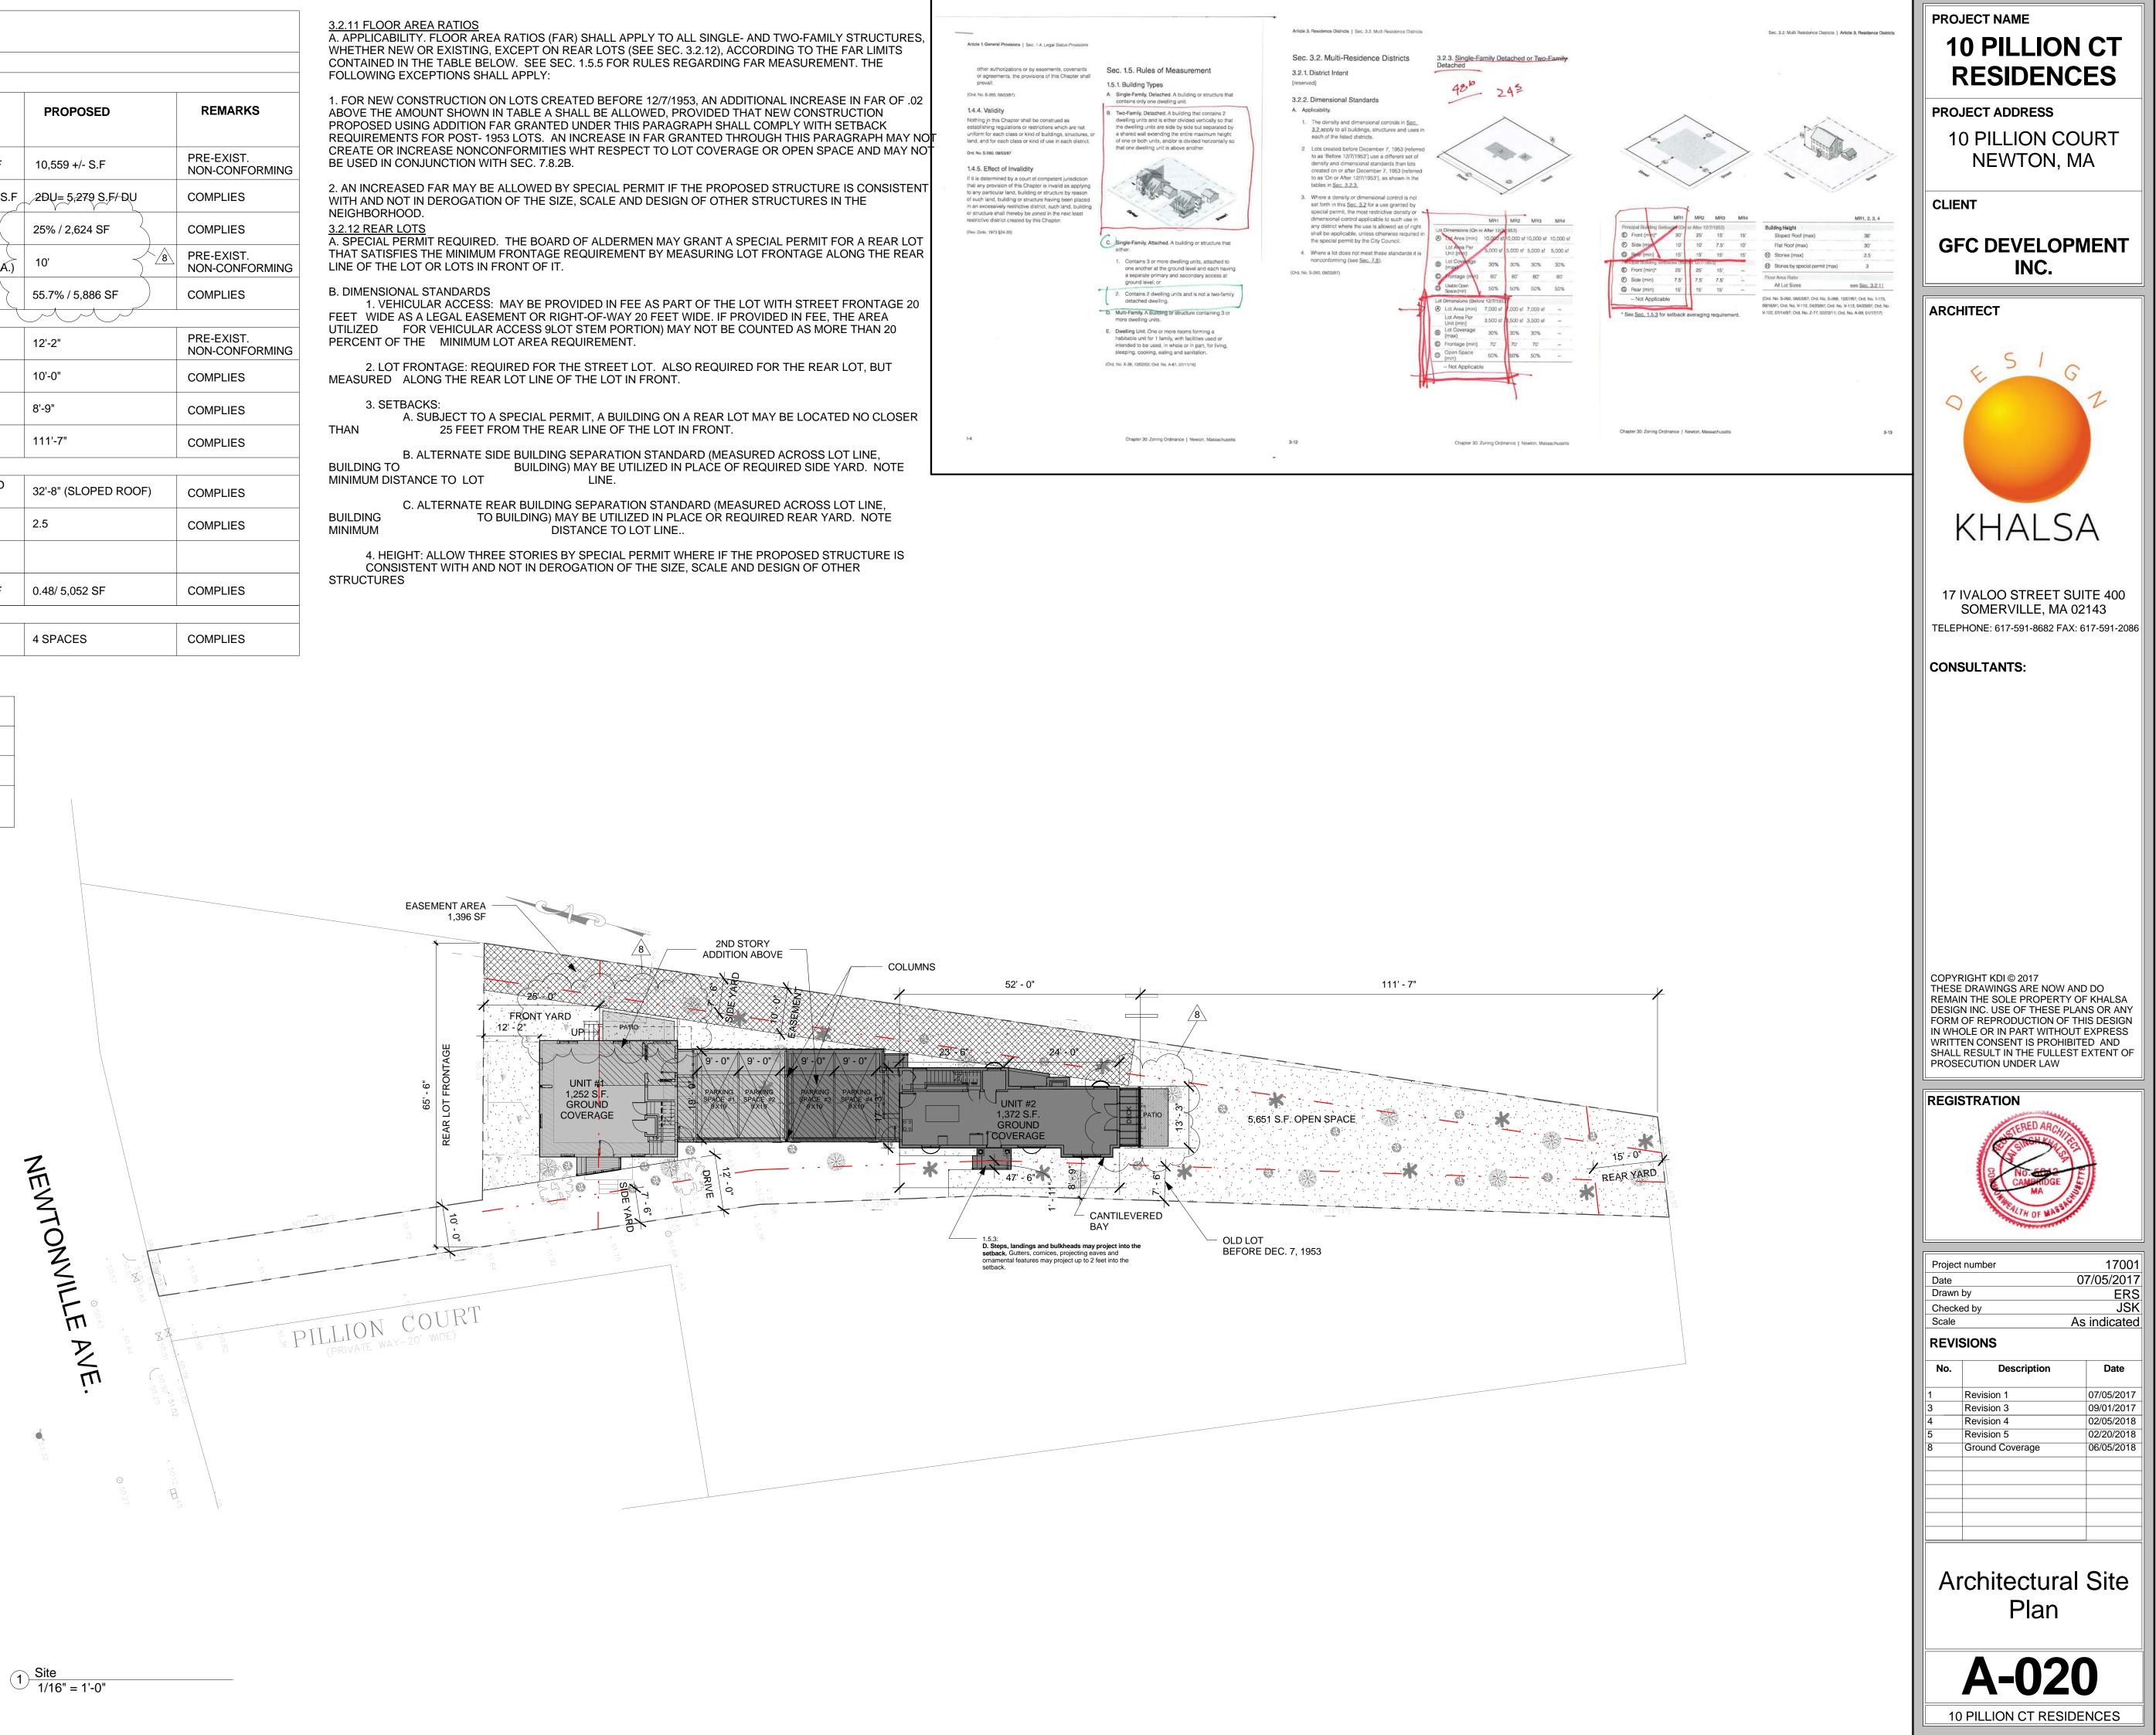

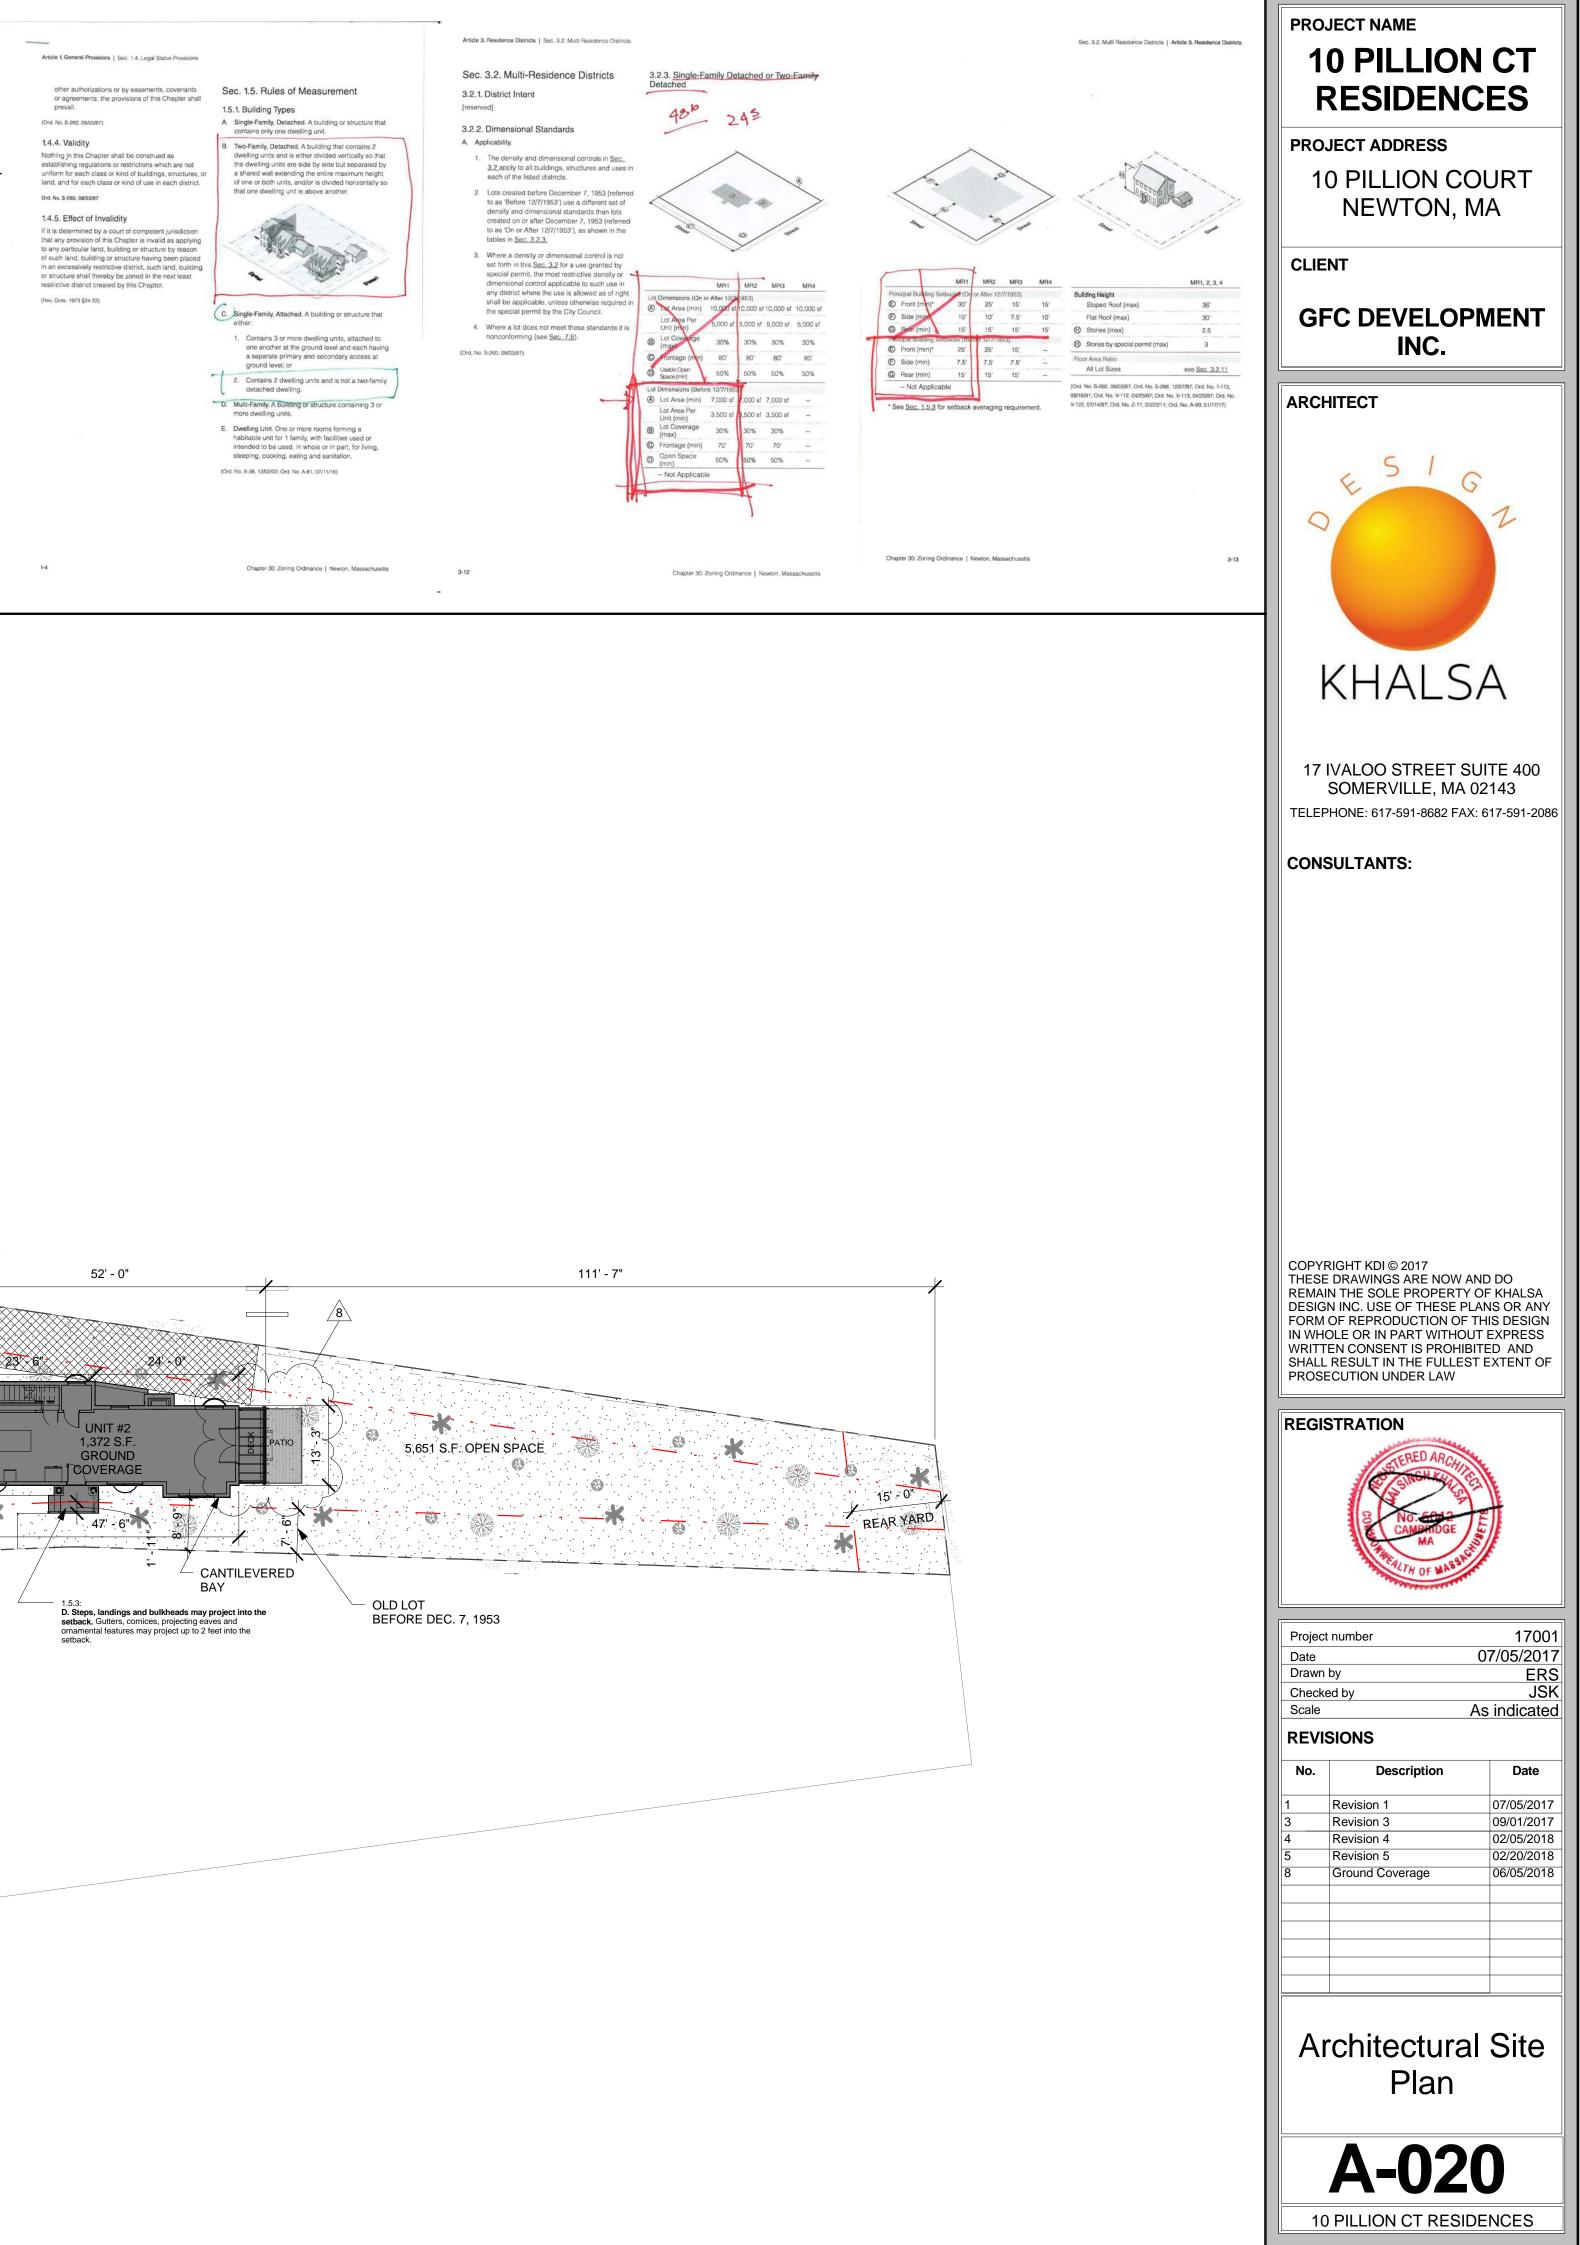

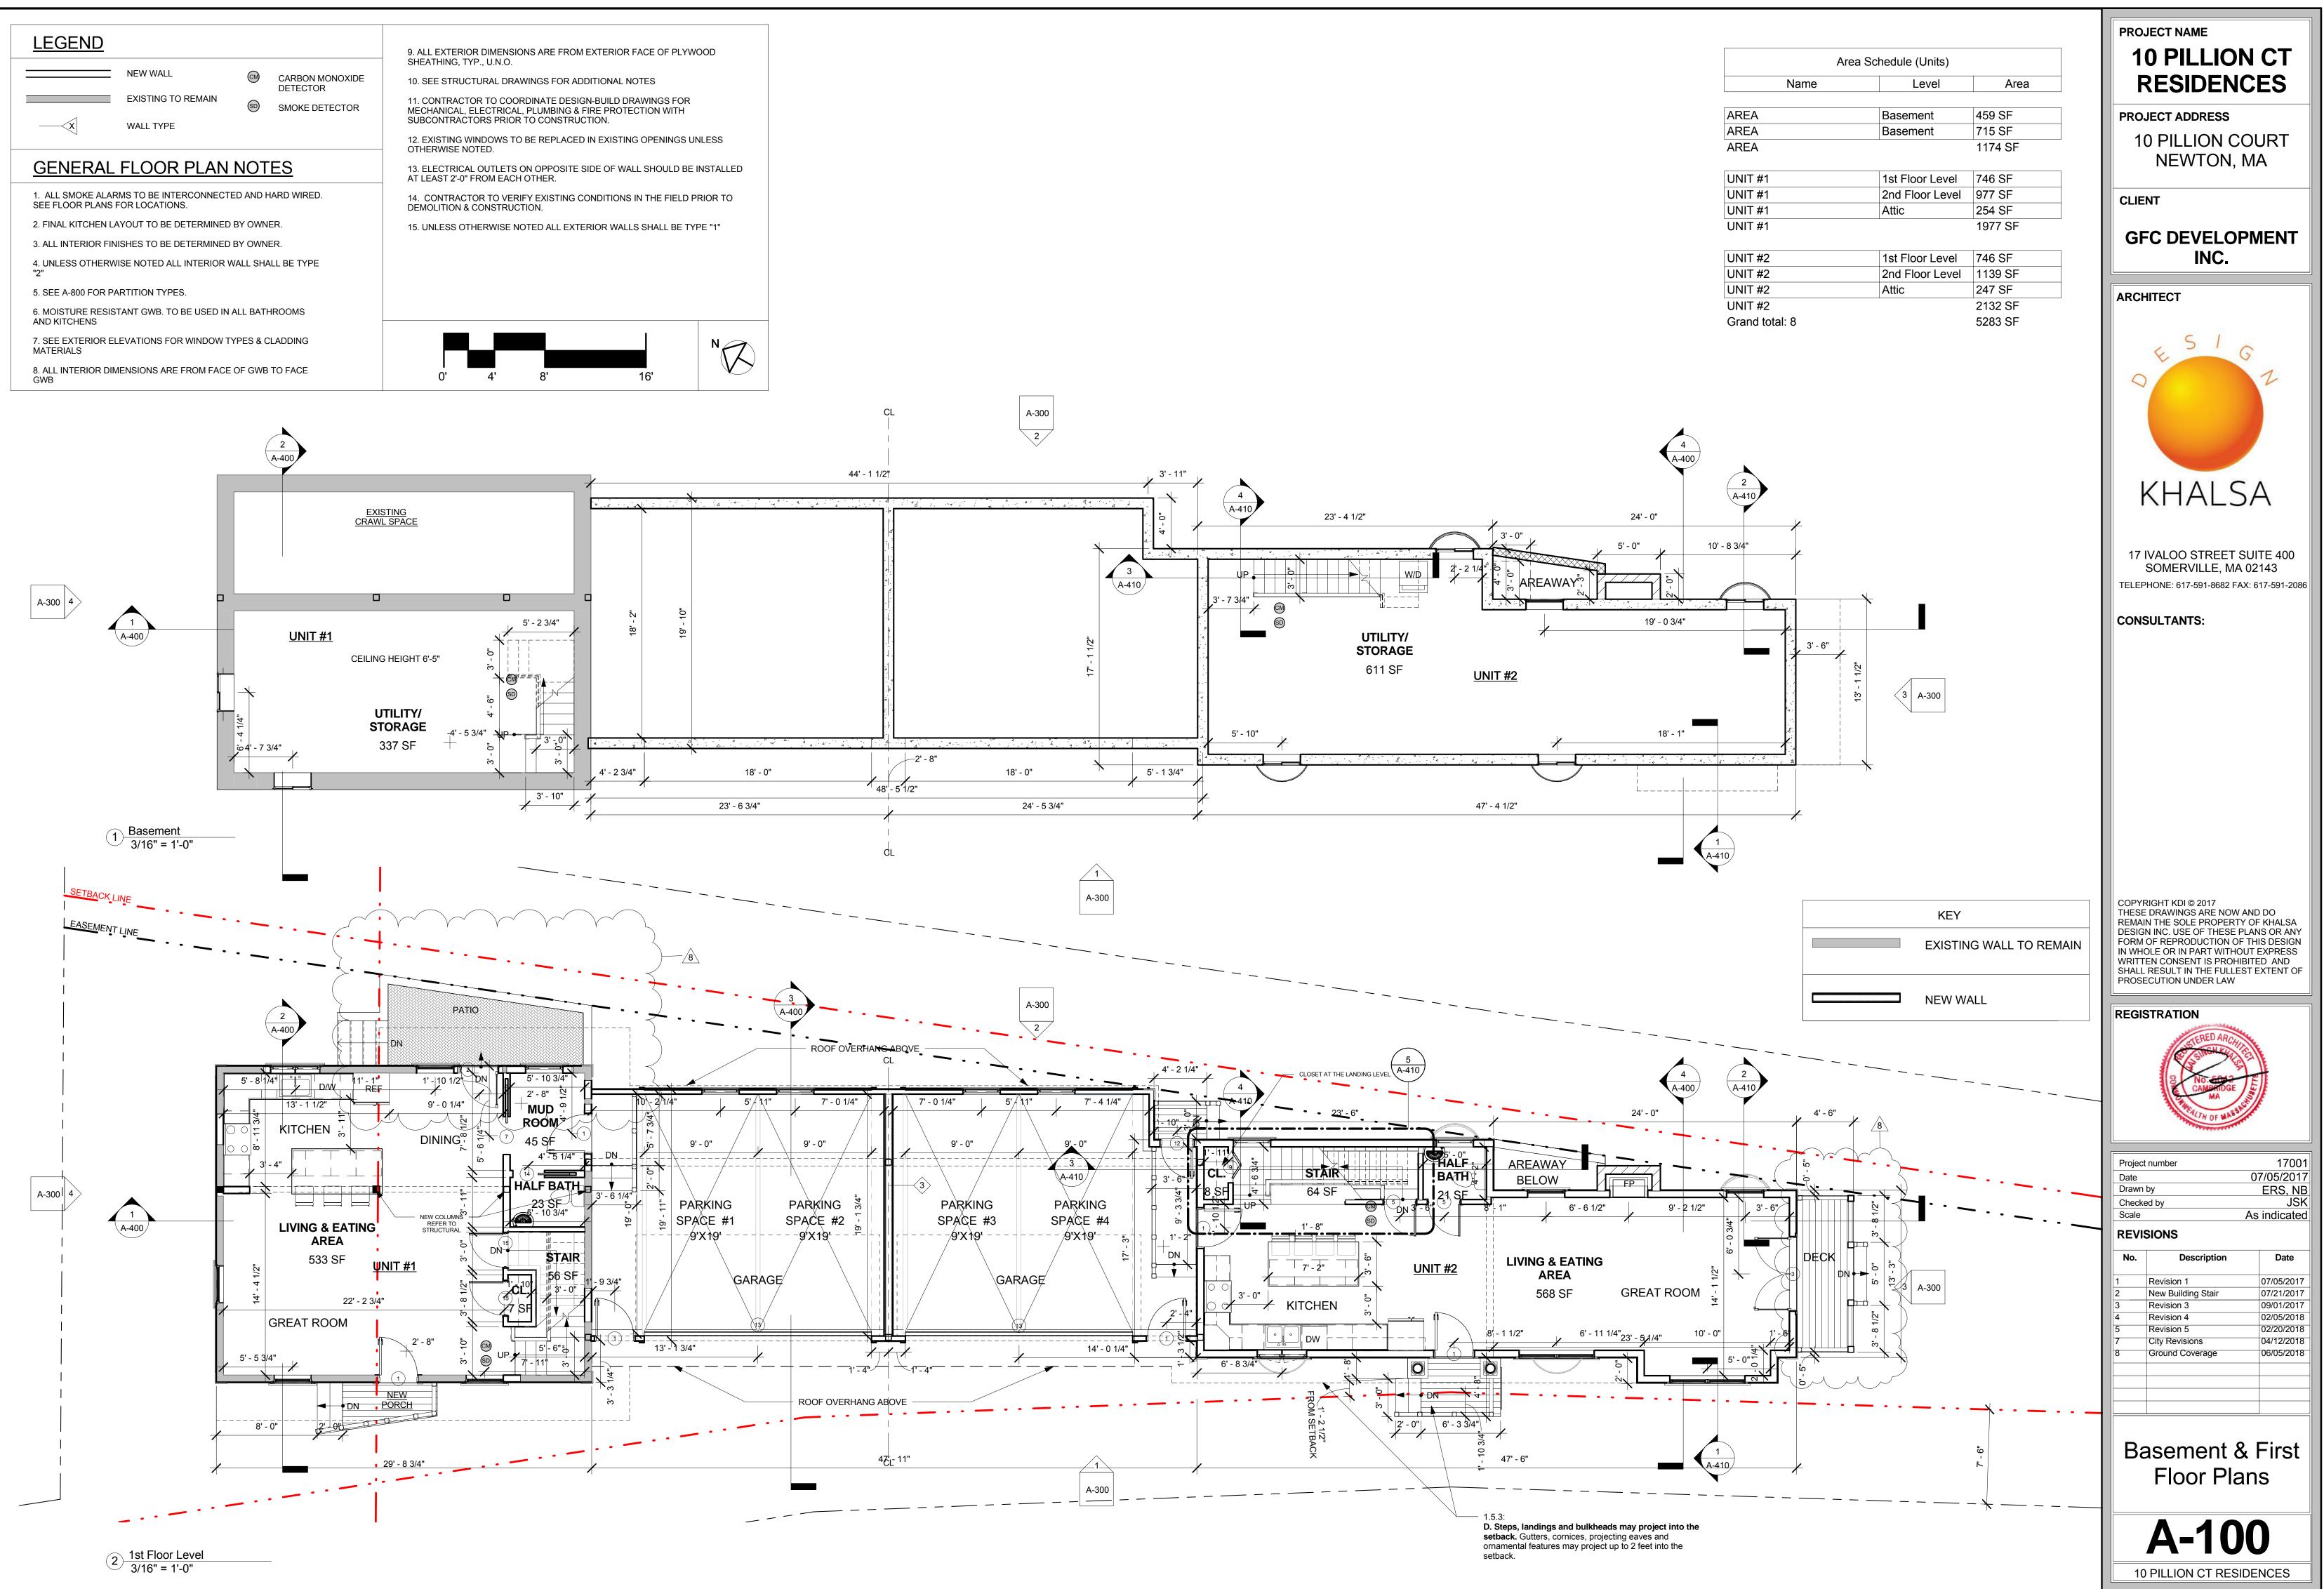

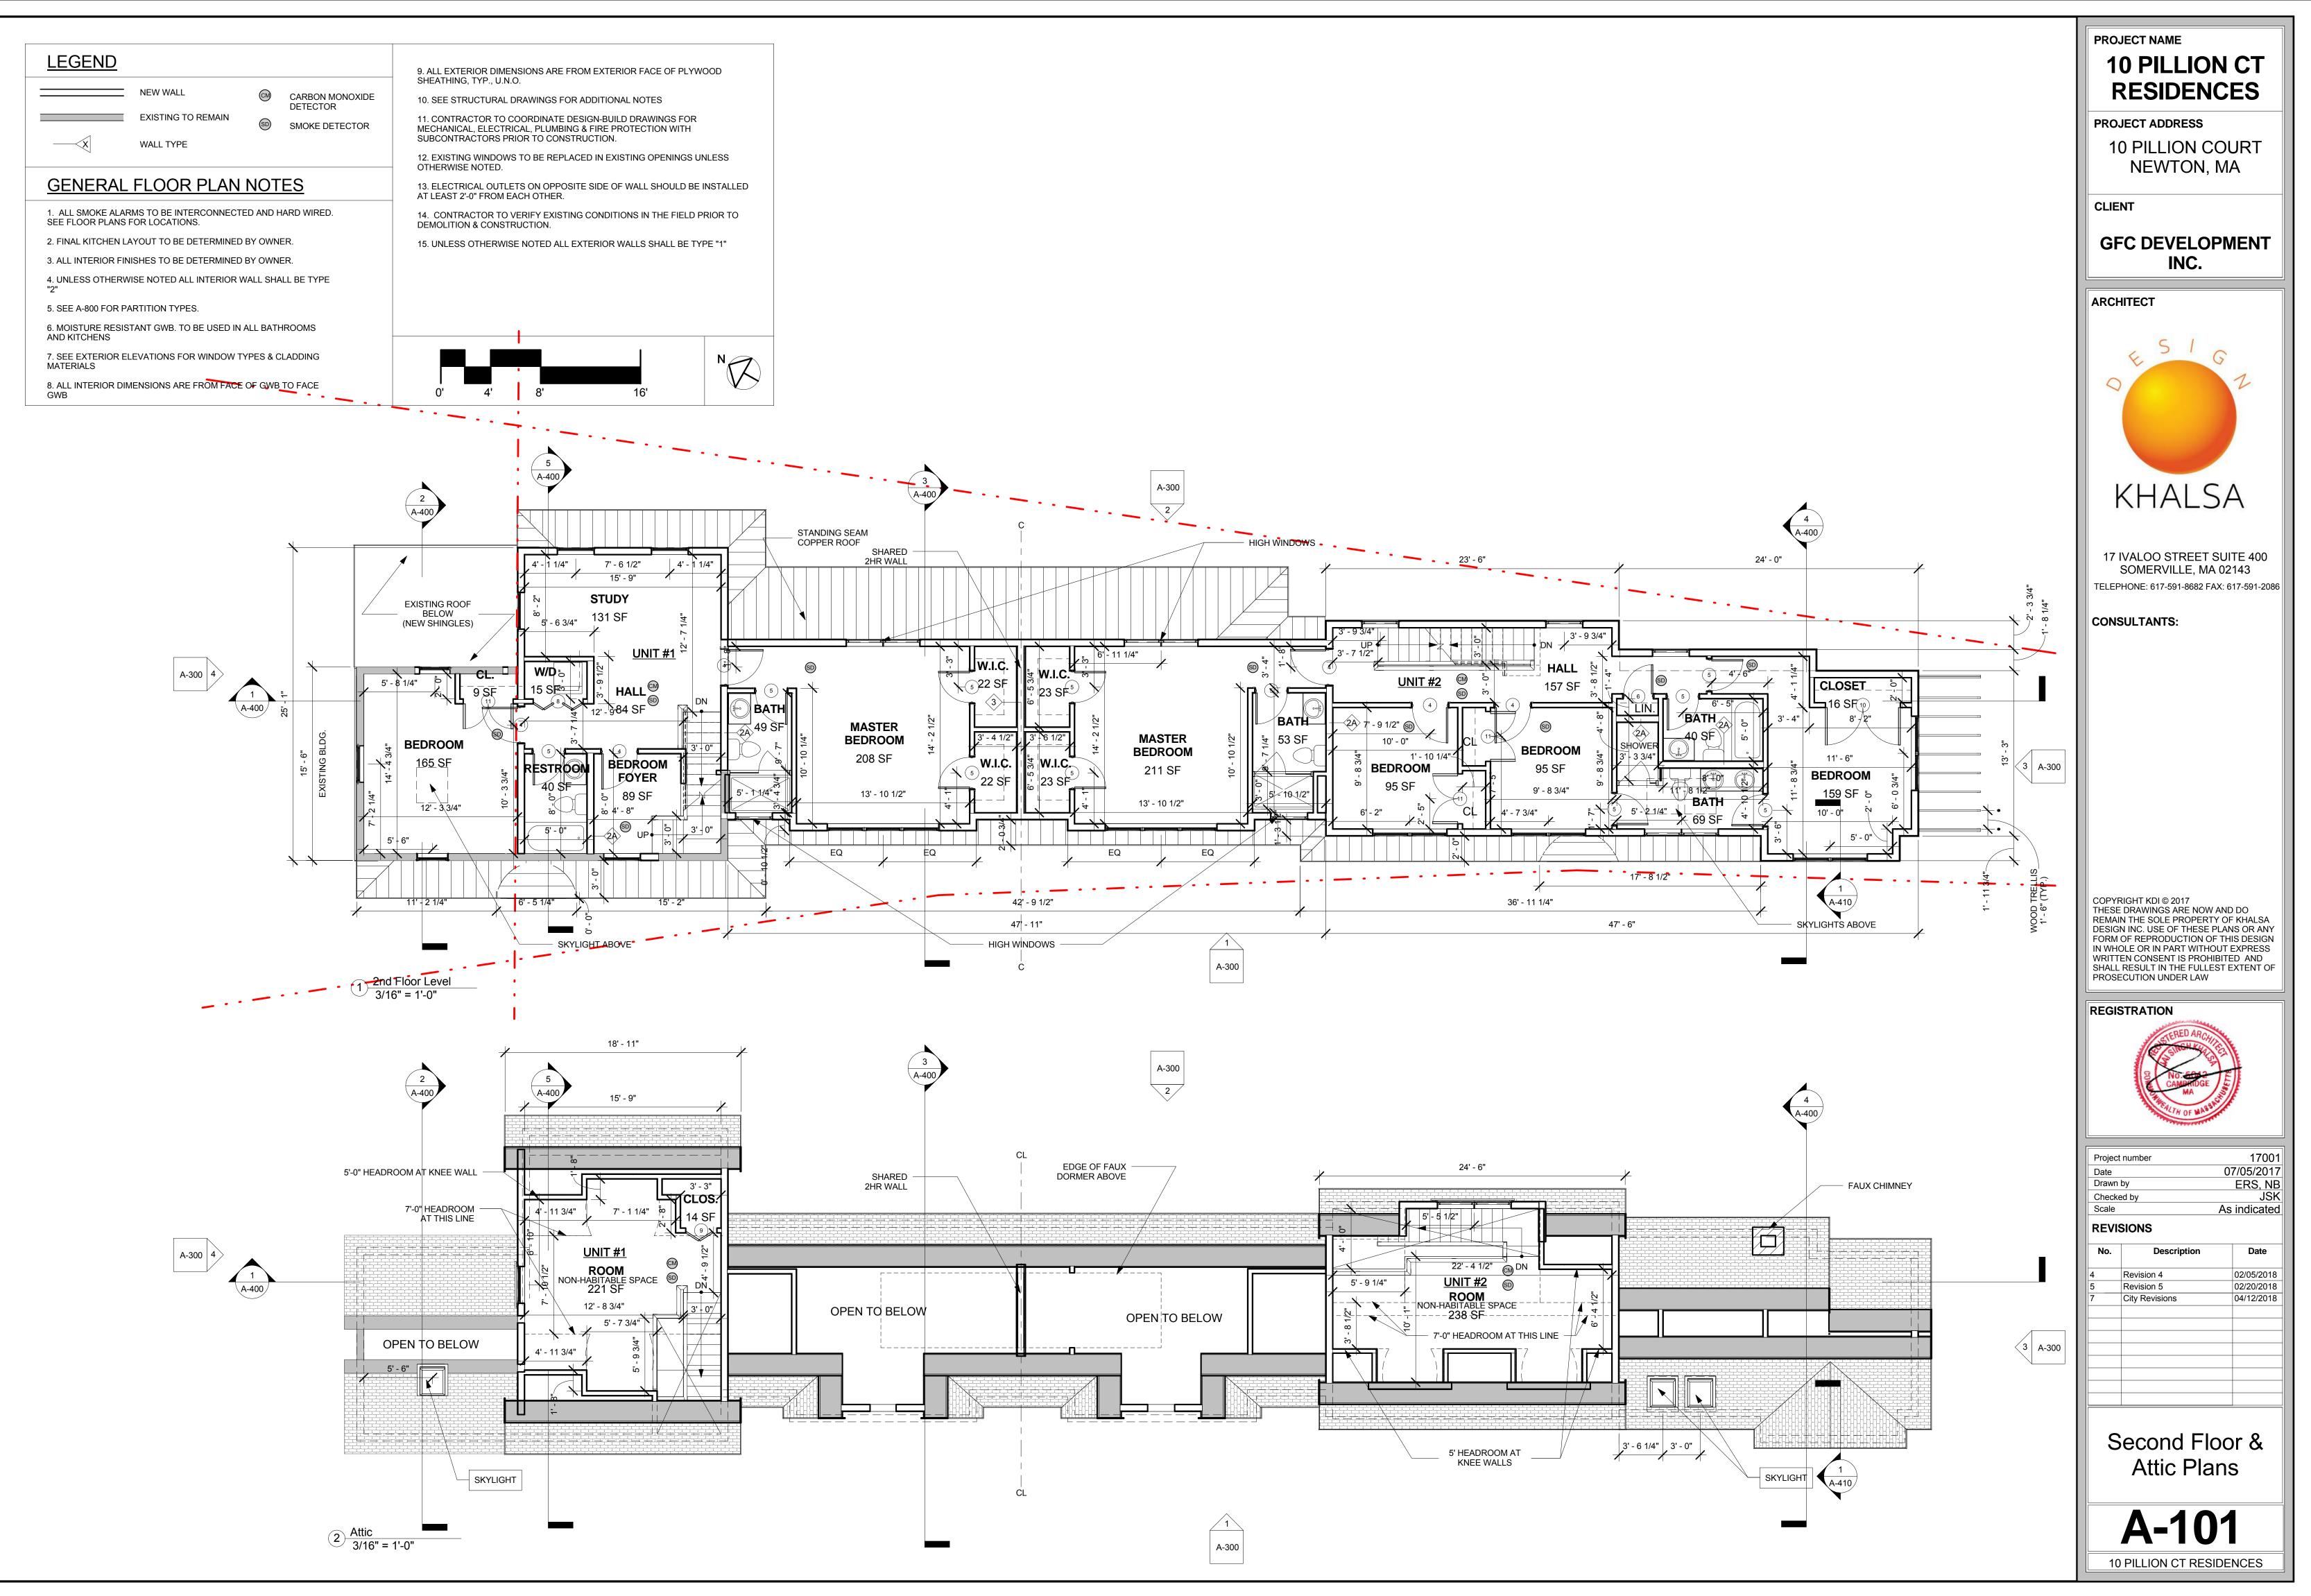



\\TKG-Server\Data\17\17001\_gfc-10 Pillion Ct Newton\03 Drawings\01\_ARCH\_CD\17001\_10 Pillion Ct\_Permit Set\_REV.4.

/6/2018 10:20:25 AM






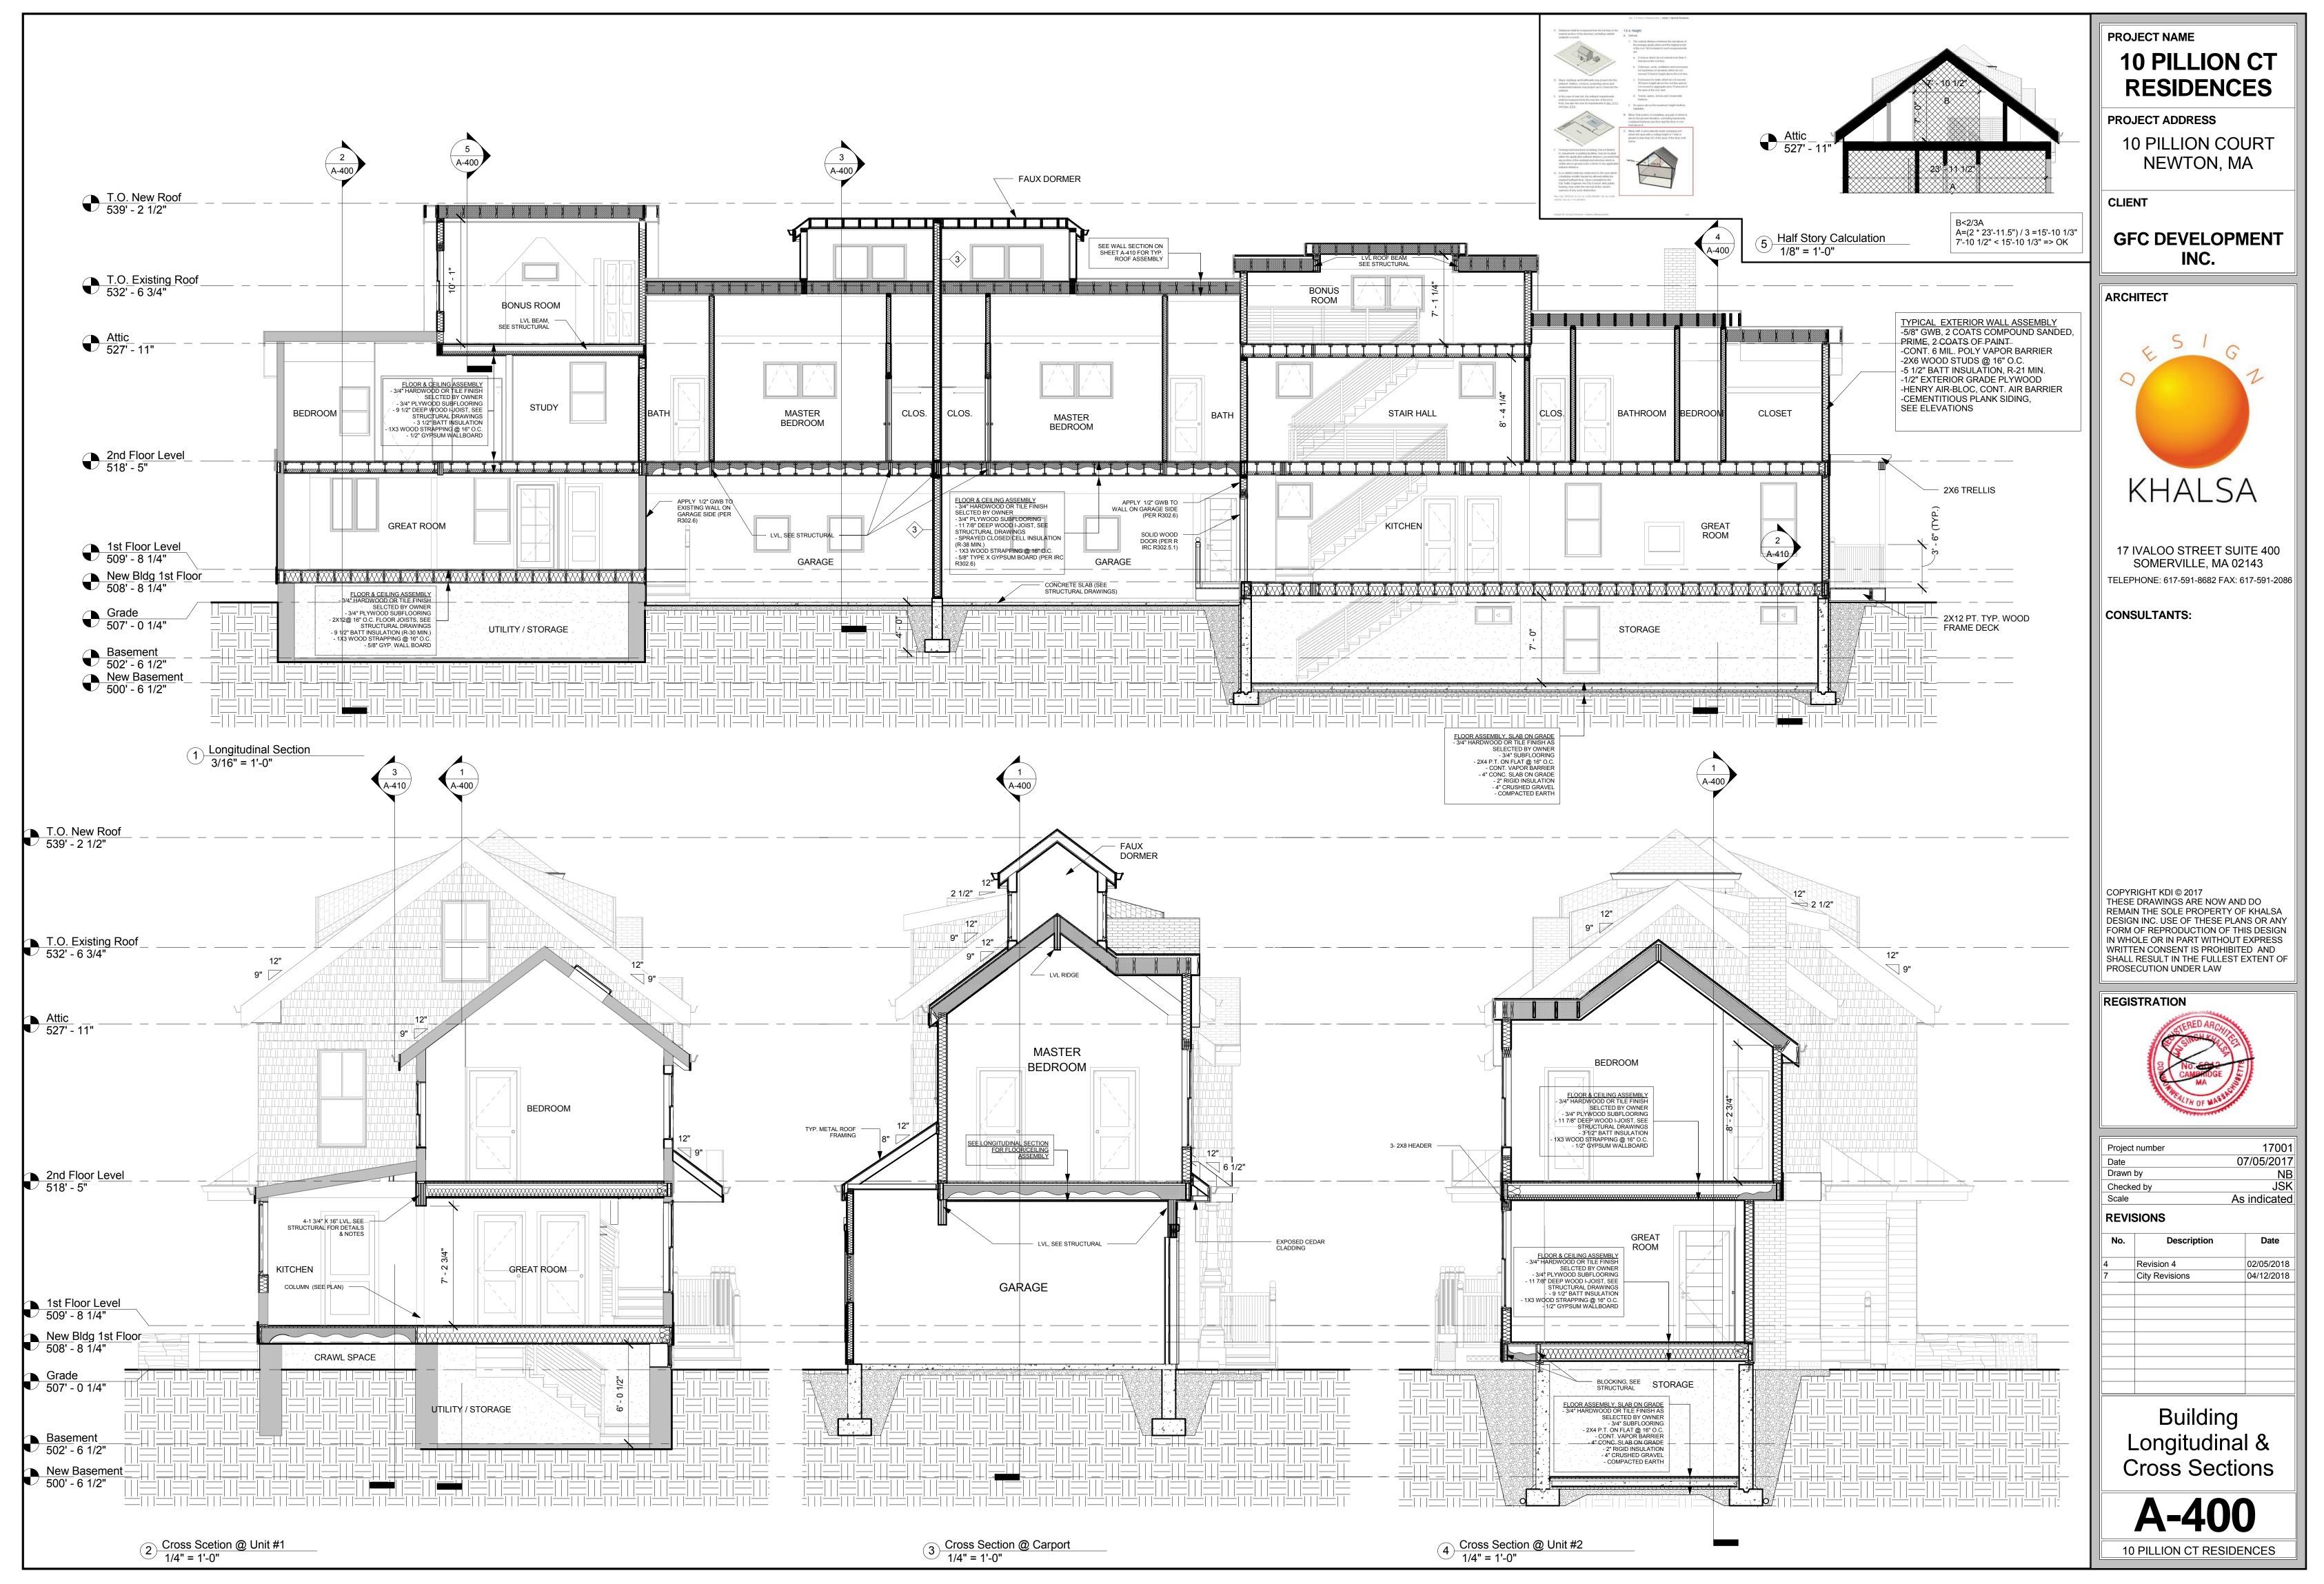


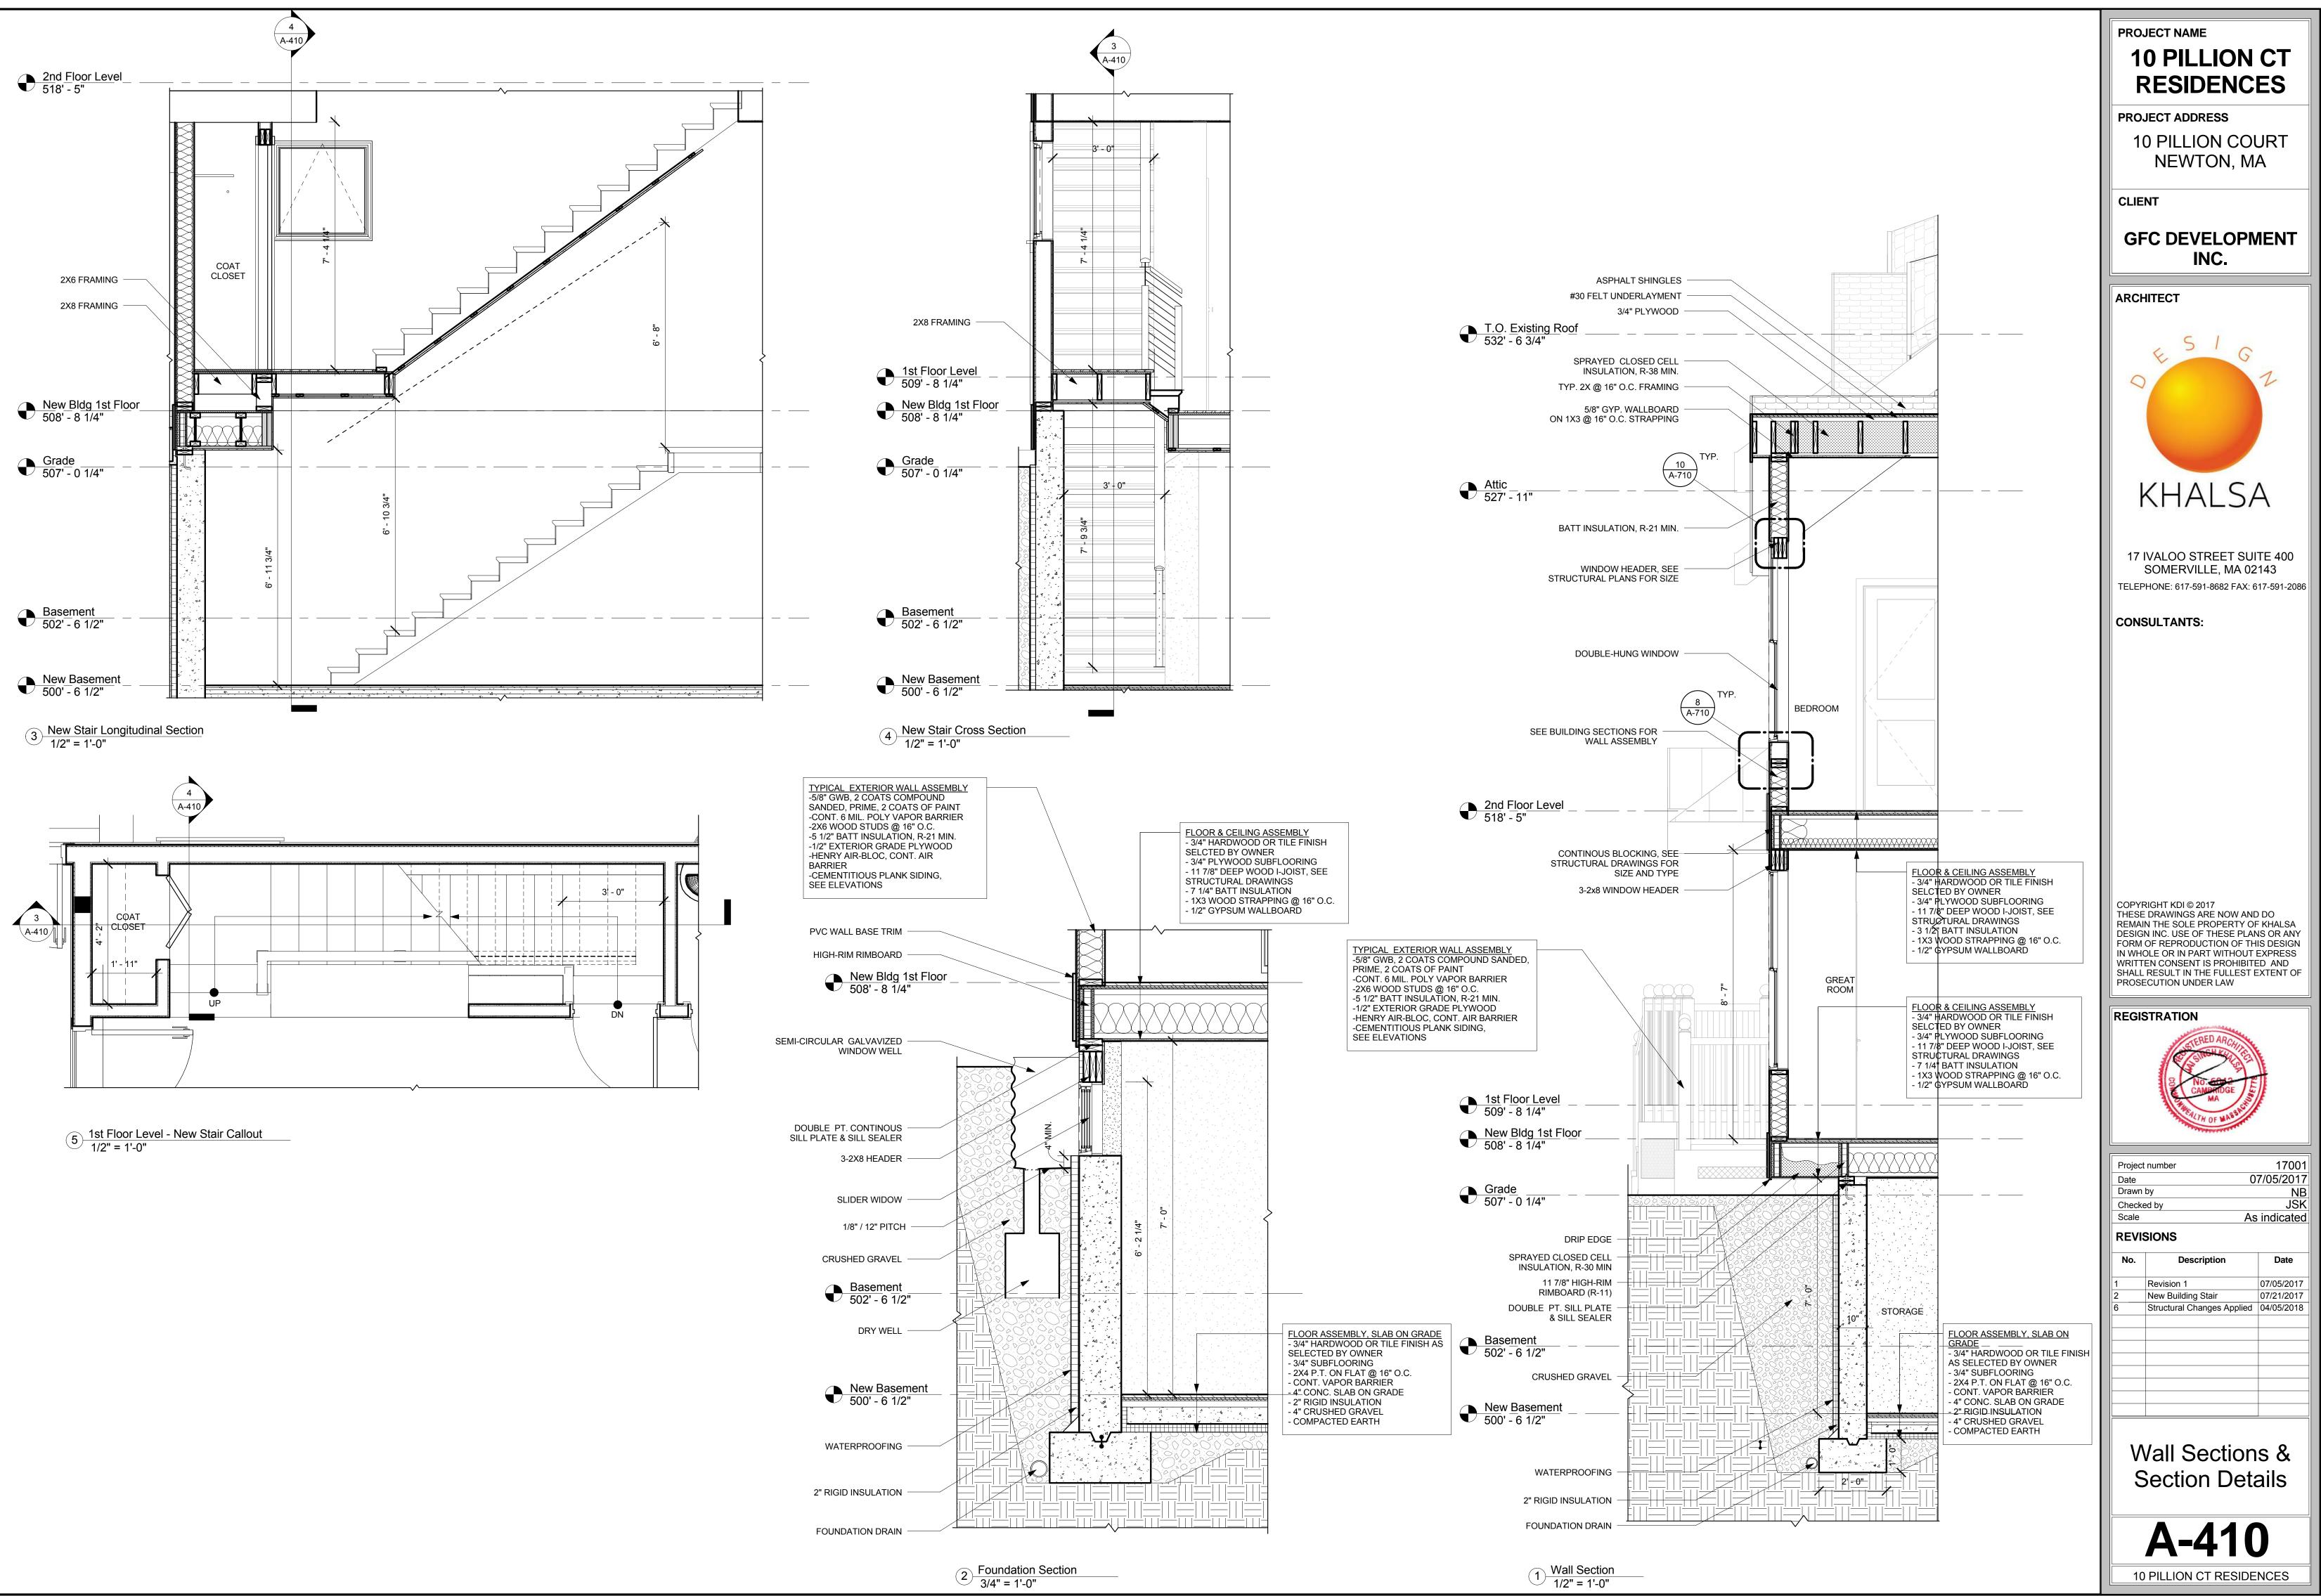



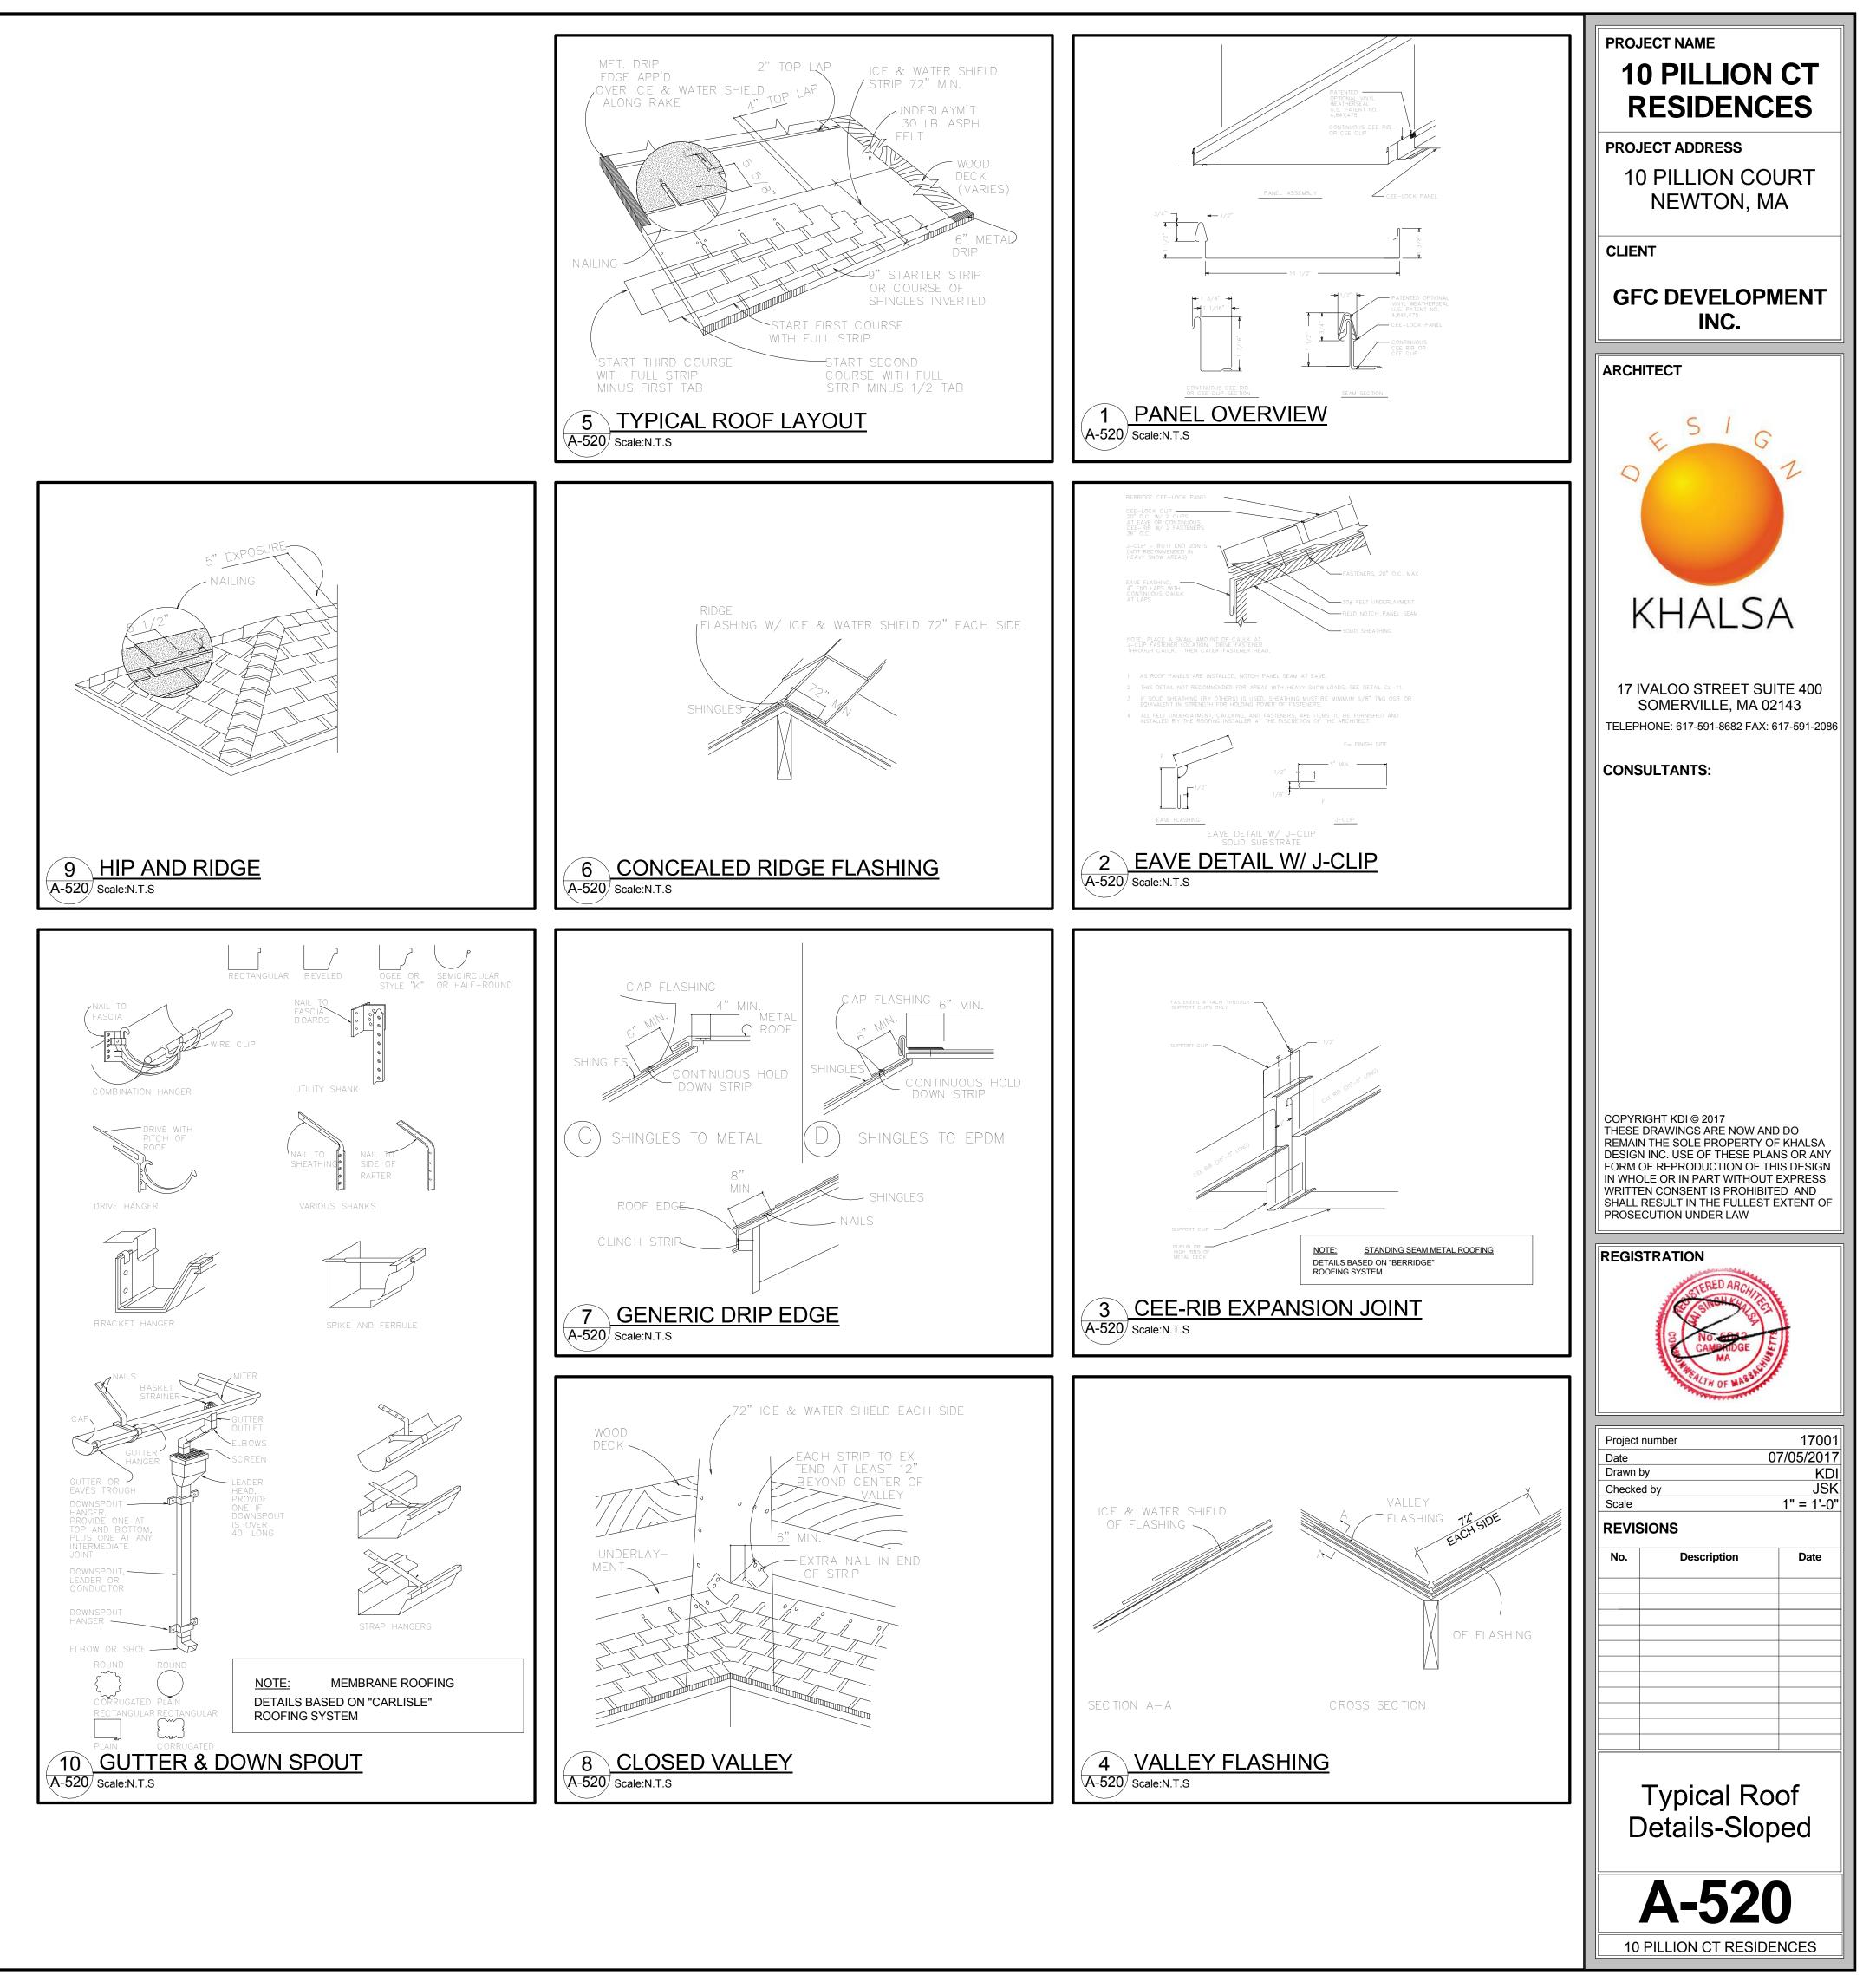

12 NOT USED	9 NOT USED
A-610 SCALE: 1" = 1'-0"	A-610 SCALE: 1" = 1'-0"
11 NOT USED	8 NOT USED
A-610 SCALE: 1" = 1'-0"	A-610 SCALE: 1" = 1'-0"
10 NOT USED	7 NOT USED
A-610 SCALE: 1" = 1'-0"	A-610 SCALE: 1" = 1'-0"

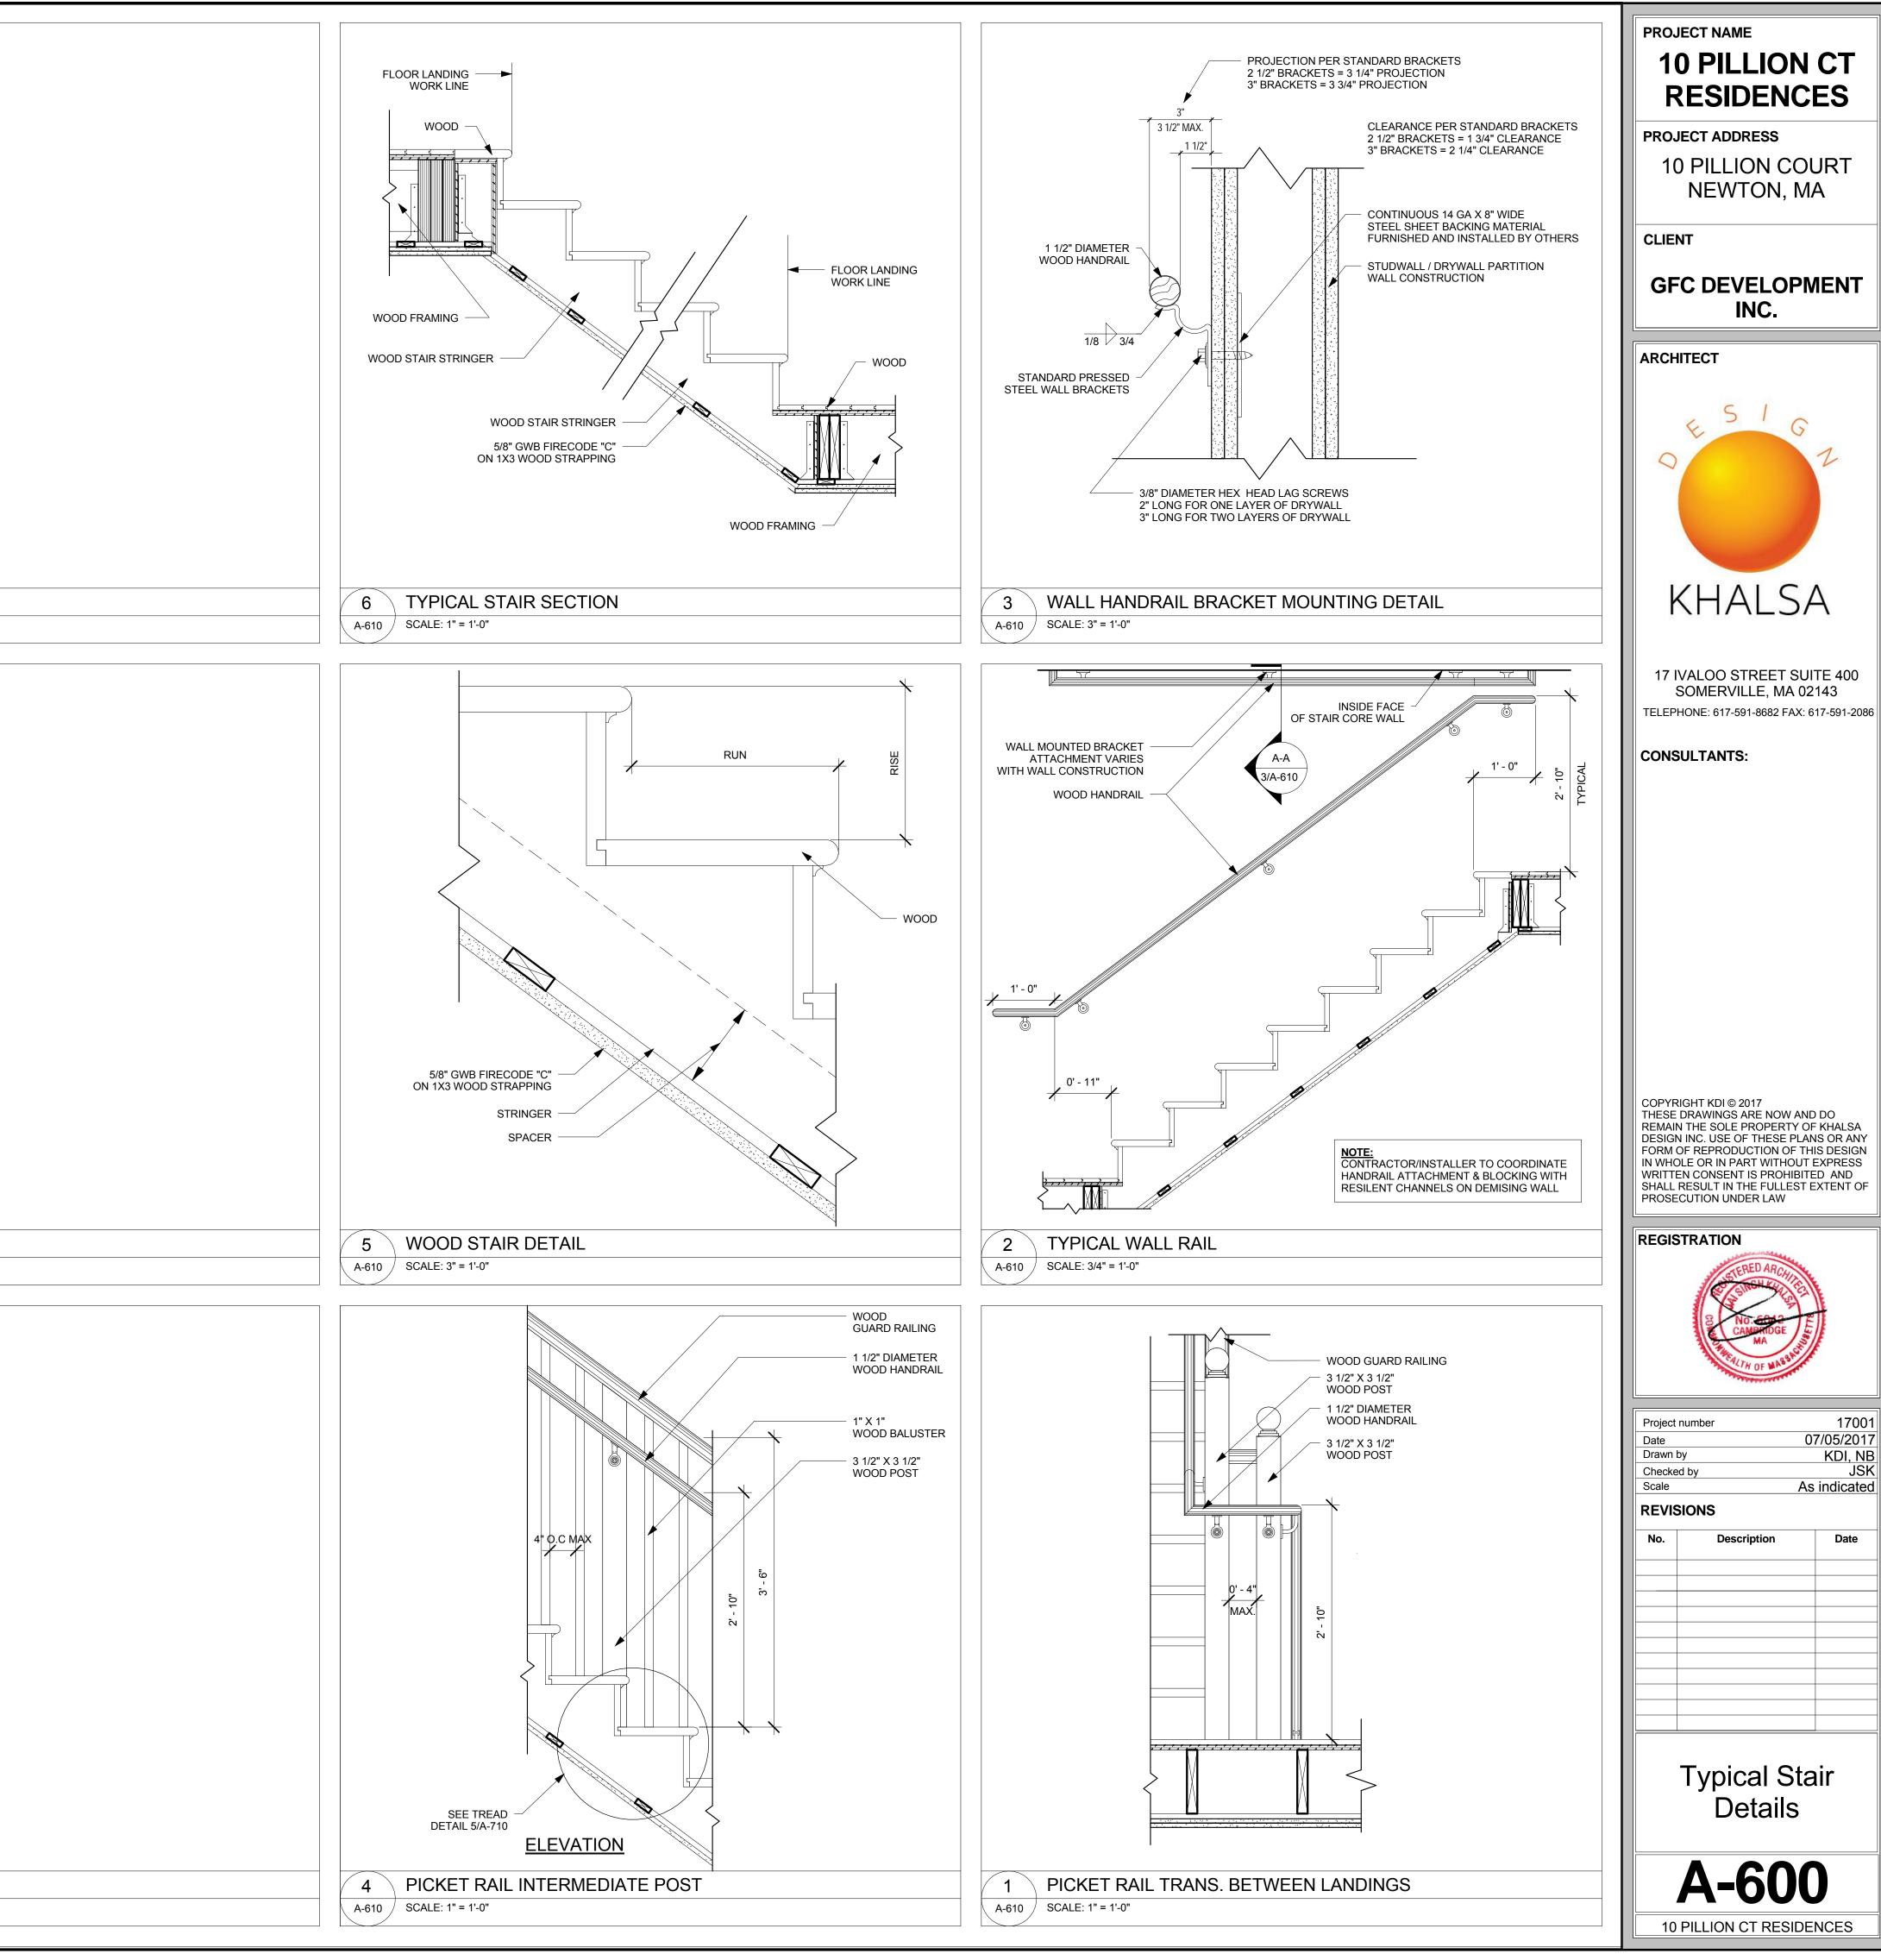



17001

Date




							Window
Туре							Rough C
Mark	Manufac	turer	M	odel	Туре	N	Width
A	Integrity Windows		IFDH264		Double-Hung	2' - 5	
B C	Integrity Windows Integrity Windows		IFDH305		Double-Hung Double-Hung		
D	Integrity Windows	s and Doors	IFDH306		Double-Hung	2' - 11	
E F	Integrity Windows Integrity Windows		IFDH306		Double-Hung Double-Hung		
G	Integrity Windows	s and Doors	IFAWN30	30	Awning	2' - 11	1/2"
H J	Integrity Windows Integrity Windows		IFGL3016		Glider Awning	2' - 11 2' - 11	
К	Integrity Windows	s and Doors	IFSWP20	46	Casement	1' - 11	1/2"
M	Integrity Windows	and Doors	IFCA2046 36" Diam		Casement Round	1' - 11 3' - 0"	
Ν	VELUX		2230		Skylight	2' - 0 \$	3/16"
2'-5		2'-11 10 11 10 10 10 10 10 10 10	1 1/2" 3 1 1/2"	1'-51/2" L L 51/2" L	2' - 11 1/2"	4'-51/2"	1' - 11 1/.
G	Doo	or Type	4	Frame Material	J Doo Door Material	r Schedule Width	к Э
Mark		птуре					
Mark				Wood	s anno an la a d	3' - 0"	6' - 8" 6' - 10'
1 S 2 H	ingle - Entry linged Single- Patio			Wood	Solid Wood Solid Wood	3' - 0 5/16"	
1 S 2 H 3 H	linged Single- Patio linged Double Patio			Wood Wood	Solid Wood Solid Wood	5' - 11"	6' - 10
1 S 2 H 3 H 4 H 5 H	linged Single- Patio linged Double Patio linged Single linged Single			Wood Wood Wood Wood	Solid Wood Solid Wood Hollow-Core Hollow-Core	5' - 11" 2' - 10" 2' - 6"	6' - 10 6' - 8" 6' - 8"
1 S 2 H 3 H 4 H 5 H 6 H	linged Single- Patio linged Double Patic linged Single			Wood Wood Wood Wood	Solid Wood Solid Wood Hollow-Core	5' - 11" 2' - 10"	
1 S 2 H 3 H 4 H 5 H 6 H 7 S 8 B	linged Single- Patio linged Double Patio linged Single linged Single linged Single iingle Pocket ifold Four Panel			Wood Wood Wood Wood Wood Wood	Solid Wood Solid Wood Hollow-Core Hollow-Core Hollow-Core Hollow-Core Hollow-Core	5' - 11" 2' - 10" 2' - 6" 2' - 4" 3' - 0" 4' - 0"	6' - 10 6' - 8" 6' - 8" 6' - 8" 6' - 8" 6' - 8"
1 S 2 H 3 H 4 H 5 H 6 H 7 S 8 B 9 B	linged Single- Patio linged Double Patio linged Single linged Single linged Single ingle Pocket			Wood Wood Wood Wood Wood Wood Wood	Solid Wood Solid Wood Hollow-Core Hollow-Core Hollow-Core Hollow-Core	5' - 11" 2' - 10" 2' - 6" 2' - 4" 3' - 0"	6' - 10 6' - 8" 6' - 8" 6' - 8" 6' - 8" 6' - 8" 6' - 8"
1 S 2 H 3 H 4 H 5 H 6 H 7 S 8 B 9 B 10 H 11 H	linged Single- Patio linged Double Patio linged Single linged Single linged Single ingle Pocket ifold Four Panel lifold Two Panel linged Double linged Double			Wood Wood Wood Wood Wood Wood Wood Wood	Solid Wood Solid Wood Hollow-Core Hollow-Core Hollow-Core Hollow-Core Hollow-Core Hollow-Core Hollow-Core	5' - 11" 2' - 10" 2' - 6" 2' - 4" 3' - 0" 4' - 0" 2' - 6" 6' - 0" 4' - 0"	6' - 10 6' - 8" 6' - 8"
1         S           2         H           3         H           4         H           5         H           6         H           7         S           8         B           9         B           10         H           11         H           12         S           13         G	linged Single- Patio linged Double Patio linged Single linged Single linged Single lingle Pocket lifold Four Panel linged Double linged Double linged Double single - Entry Garage			Wood Wood Wood Wood Wood Wood Wood Wood	Solid Wood Solid Wood Hollow-Core Hollow-Core Hollow-Core Hollow-Core Hollow-Core Hollow-Core Hollow-Core Solid Wood	5' - 11" 2' - 10" 2' - 6" 2' - 4" 3' - 0" 4' - 0" 2' - 6" 6' - 0" 4' - 0" 2' - 6" 18' - 0"	6' - 10 6' - 8" 6' - 8" 8' - 0"
1         S           2         H           3         H           4         H           5         H           6         H           7         S           8         B           9         B           10         H           11         H           12         S           13         G	linged Single- Patio linged Double Patio linged Single linged Single linged Single lingle Pocket ifold Four Panel linged Double linged Double ingle - Entry			Wood Wood Wood Wood Wood Wood Wood Wood	Solid Wood Solid Wood Hollow-Core Hollow-Core Hollow-Core Hollow-Core Hollow-Core Hollow-Core Hollow-Core	5' - 11" 2' - 10" 2' - 6" 2' - 4" 3' - 0" 4' - 0" 2' - 6" 6' - 0" 4' - 0" 2' - 6"	6' - 10 6' - 8" 6' - 8"
1         S           2         H           3         H           4         H           5         H           6         H           7         S           8         B           9         B           10         H           11         H           12         S           13         G           14         H	linged Single- Patio linged Double Patio linged Single linged Single linged Single linged Pocket lifold Four Panel linged Double linged Double linged Double linged Single			Wood Wood Wood Wood Wood Wood Wood Wood	Solid Wood Solid Wood Hollow-Core Hollow-Core Hollow-Core Hollow-Core Hollow-Core Hollow-Core Hollow-Core Solid Wood	5' - 11" 2' - 10" 2' - 6" 2' - 4" 3' - 0" 4' - 0" 2' - 6" 6' - 0" 4' - 0" 2' - 6" 18' - 0" 2' - 6" 2' - 6" 2' - 8"	6' - 10 6' - 8" 6' - 8" 7 6' - 8"

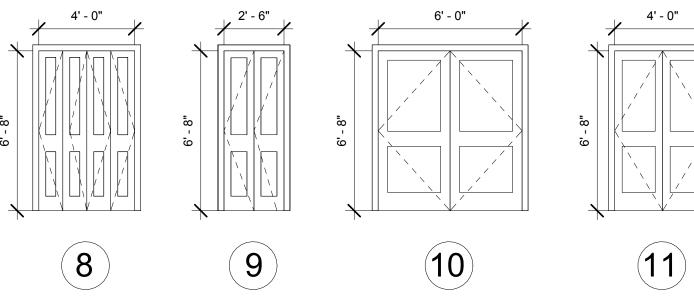


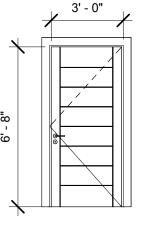







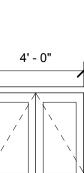

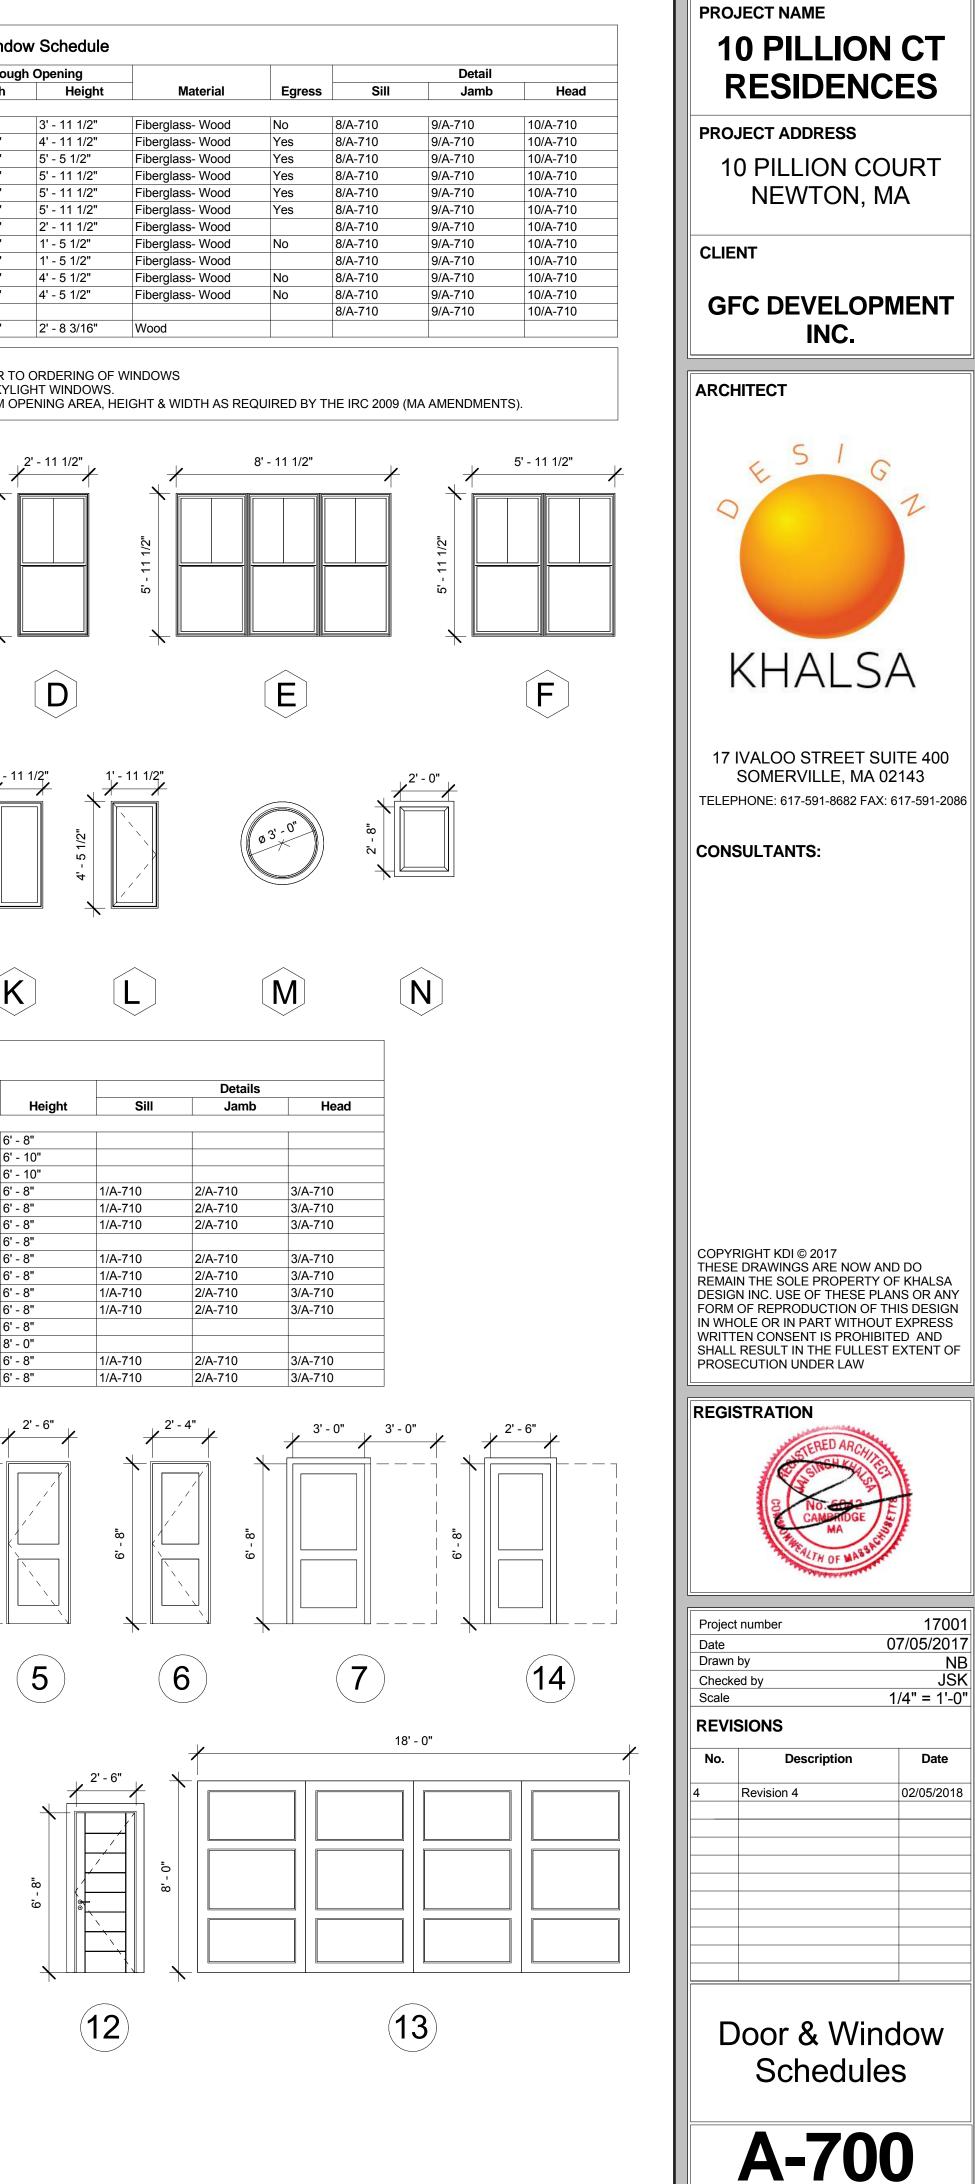



10 PILLION CT RESIDENCES

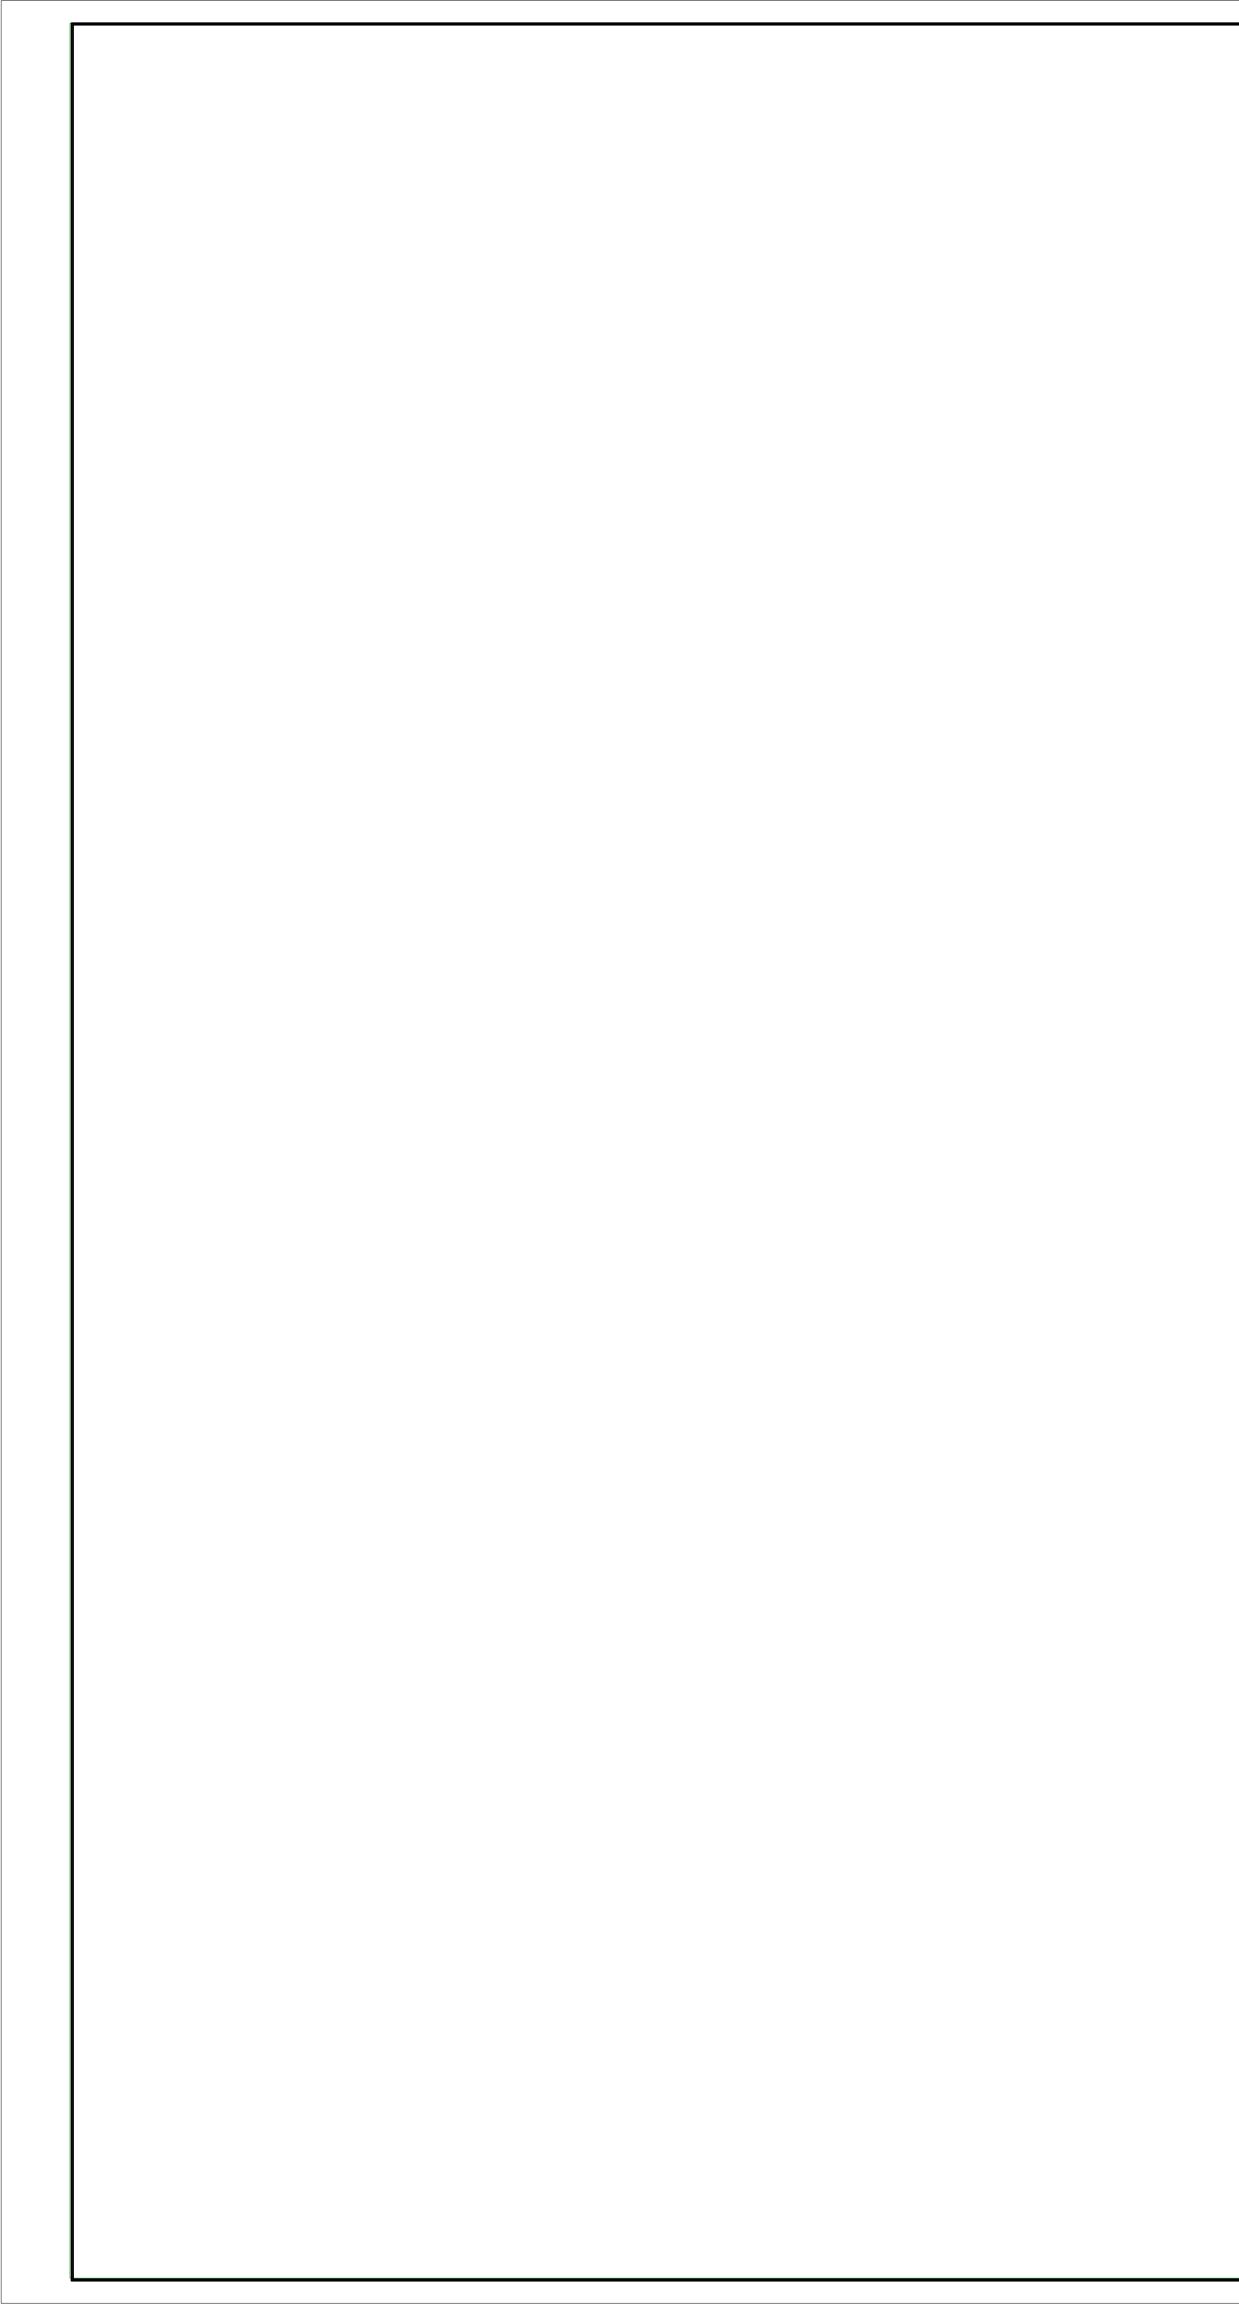


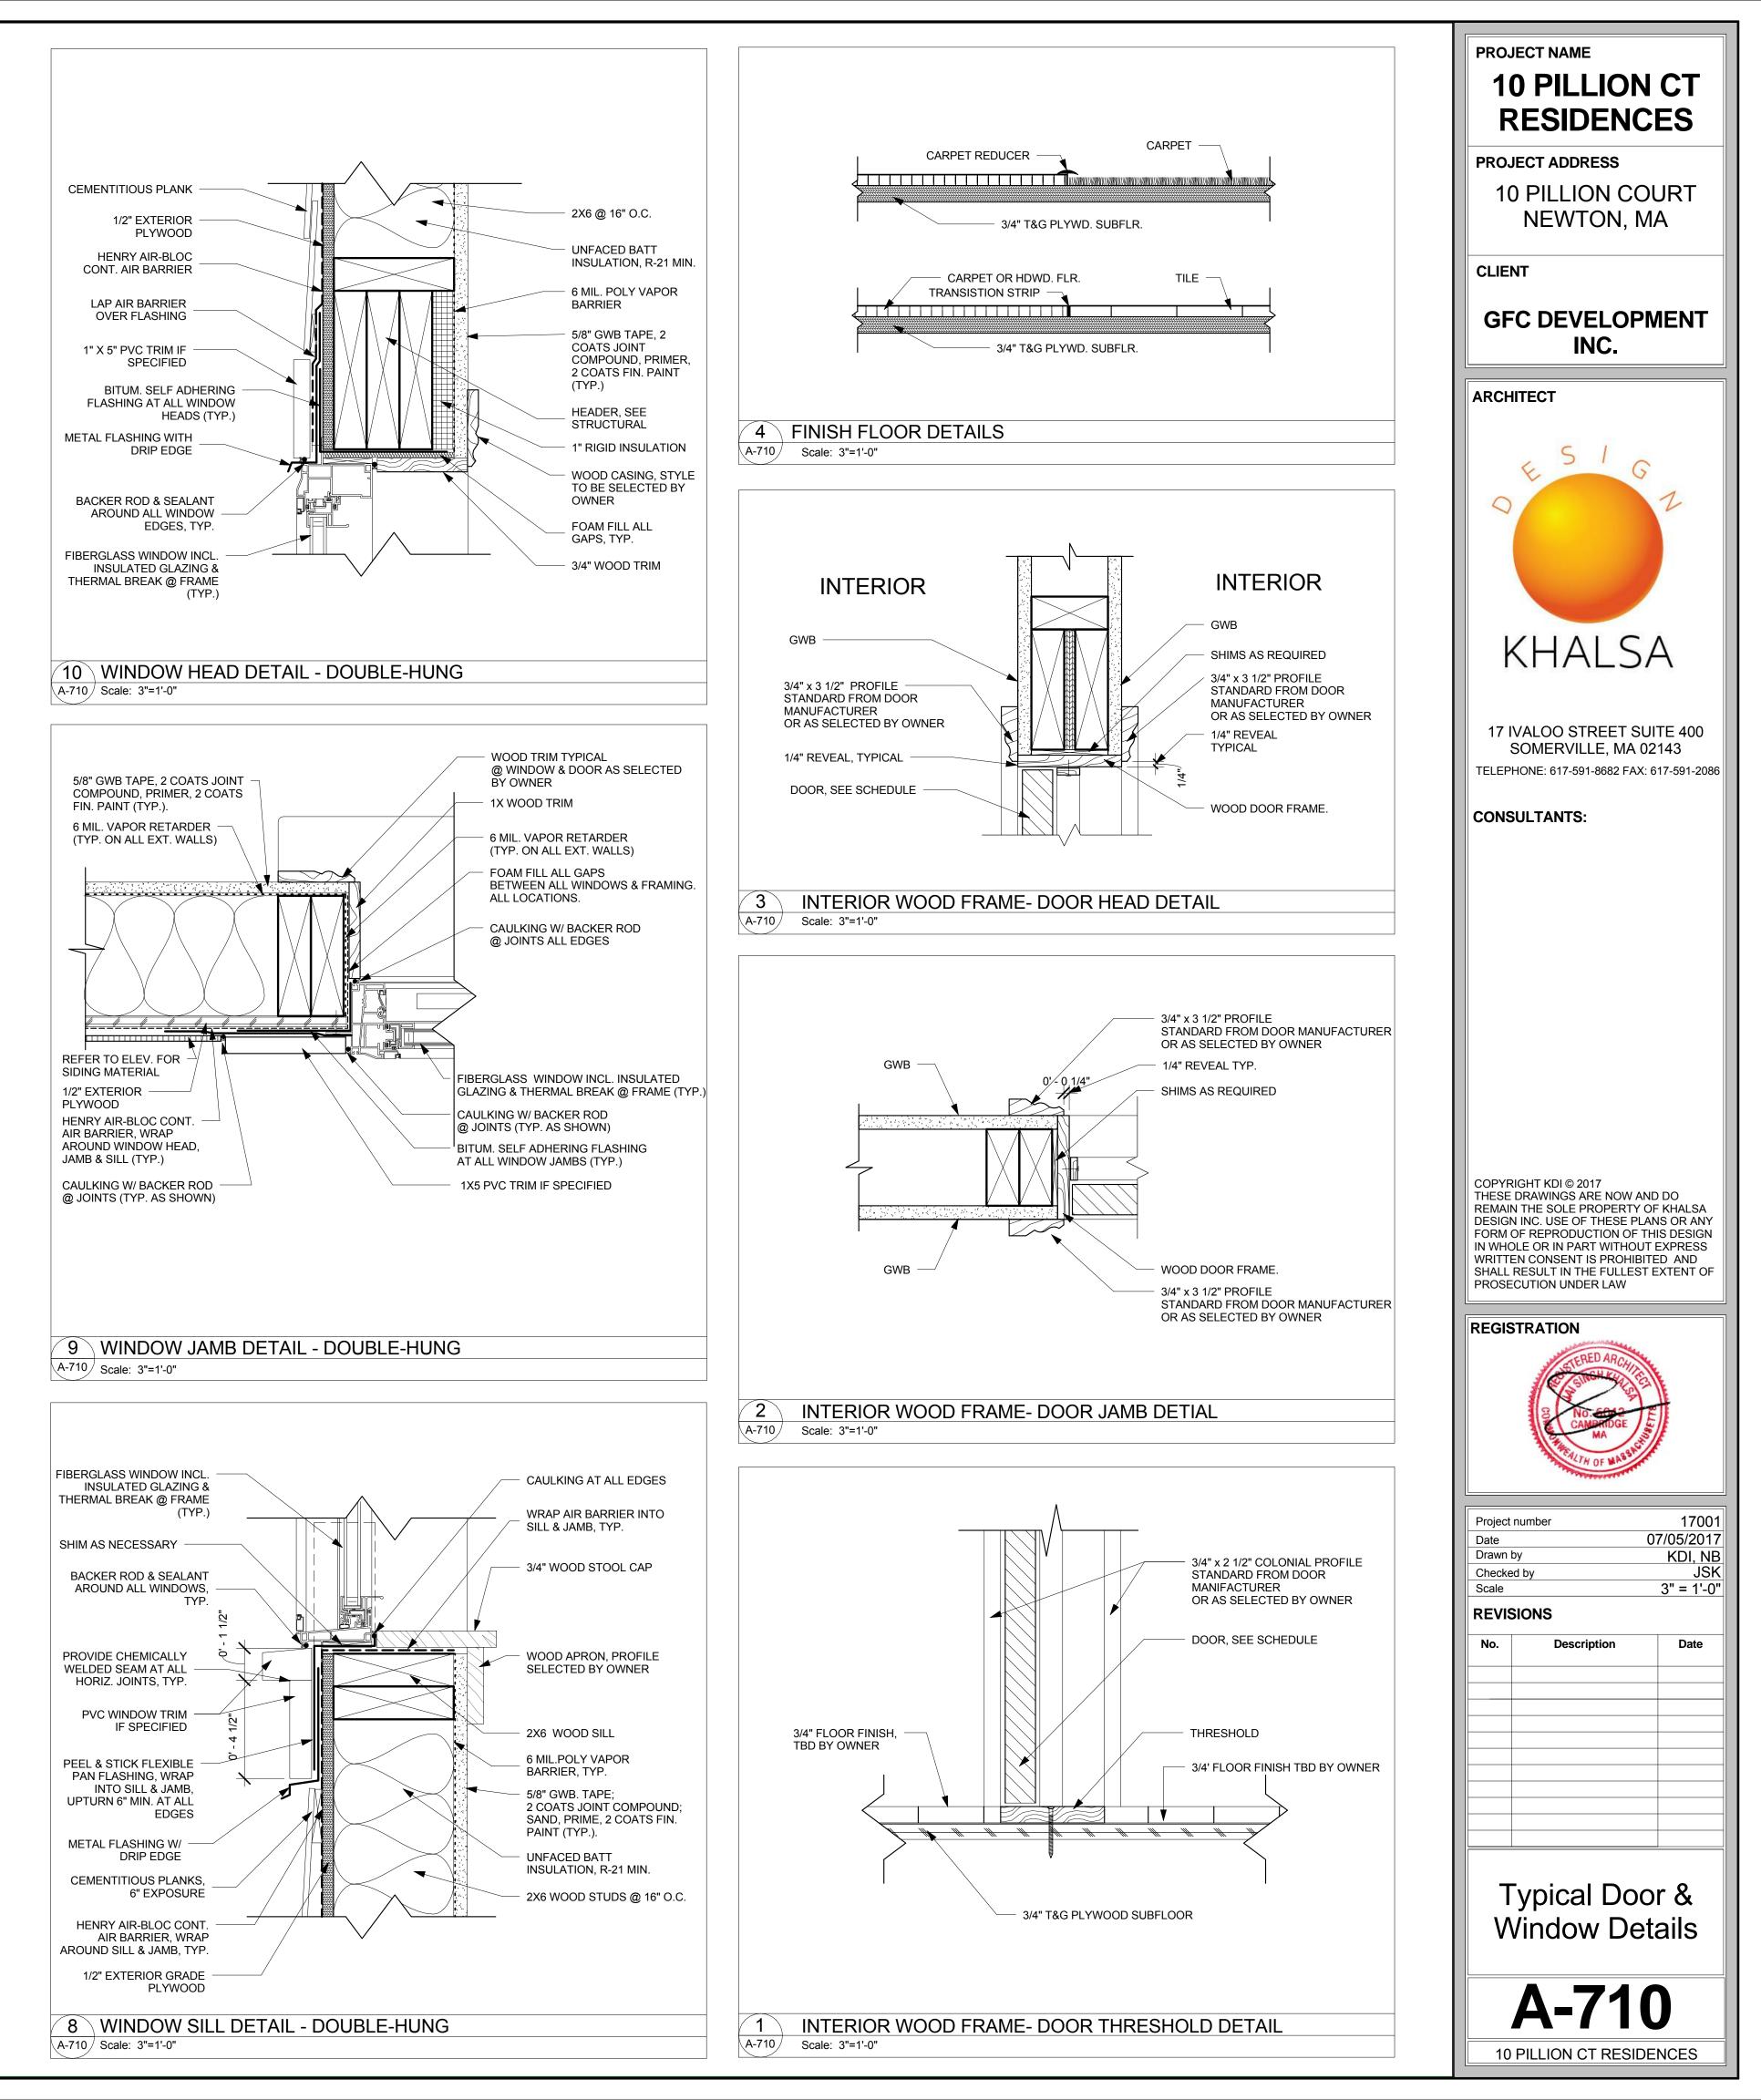





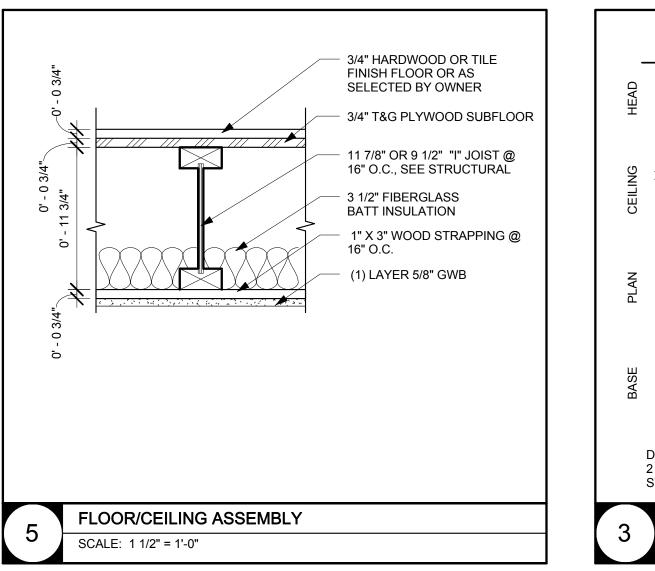

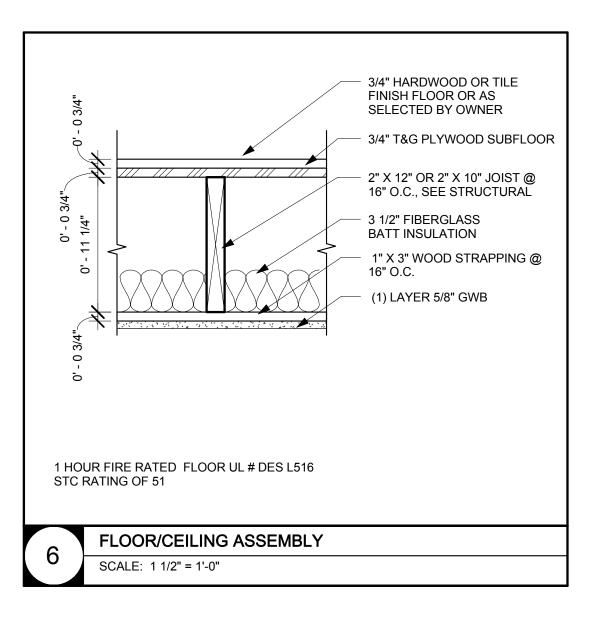

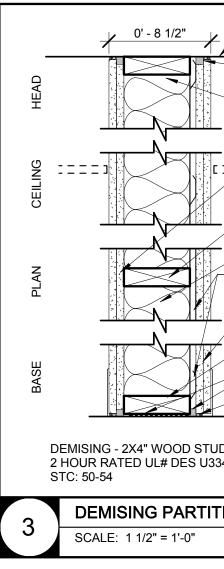


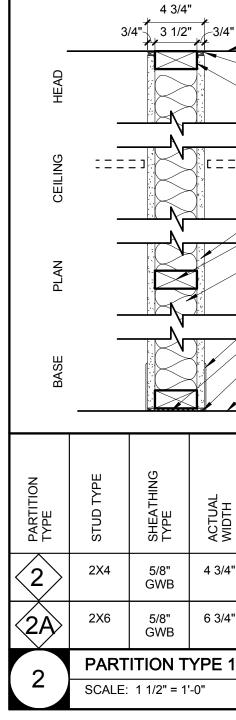

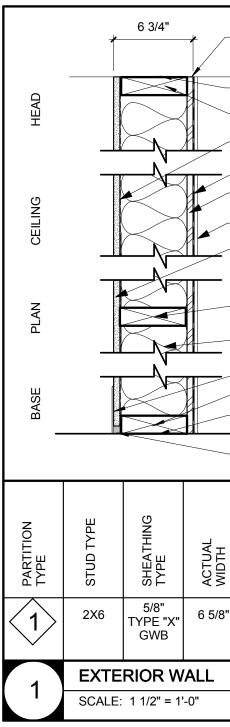



	- EF FF CA CA CA CA CA CA CA CA CA CA CA CA CA	UNDERSIDE ACCOUSTIC ACH SIDE IRESTOPP BACKER AT CEILING RU SSEMBLY CEILING AS 2) LAYERS PAPERLESS APERLESS APERLESS APERLESS APERLESS APERLESS APERLESS APERLESS APERLESS APERLESS ACCOUSTIC ACH SIDE BILL SEALEI ACE OF ST	SEALER / & BETWEE ING AND M RATED P/ NNER/DEF REQUIRE 5/8" TYPE 6 @ BATHF 6 DUDS @ INSULATIO INSULATIO INSULATIO S/8" TYPE 6 @ BATHF INER SEALER / & BETWEE R, TYP.	AND BACK EN RUNNE ARTITIONS FLECTION D X GWB ROOMS & I 16" O.C DN NELS @ 24 X GWB ROOMS & I ROOMS & I	R, VOOL KITCHENS I" O.C. KITCHENS			<section-header><section-header><section-header><section-header><text><text><text><text></text></text></text></text></section-header></section-header></section-header></section-header>	
3/4"	4" UNDERSIDE OF STRUCTURE JOINT SEALER AND BACKING EACH SIDE, FRUESTOPPING ADD MINERAL WOOL BACKER AT RATED PARTITIONS CEILING RUNNER/DEFLECTION ASSEMBLY CEILING AS REQUIRED 5/8" TYPE X GWB BOTH SIDES PAPERLESS AT BATHROOMS SIDE GYPE 1A 2X4" WOOD STUD FRAMING AT 16" O.C 3 12" BATT INSULATION AT BATHROOMS, MITCHENS & BEDROOMS. SCHEDULED BASE FLOOR RUNNER JOINT SEALER AND BACKING EACH SIDE TOP OF STRUCTURE								
THE T - I		(# 17) LS31 JUL# U305 UL# U305 OR WAL	FIRE RESISTANTNCE	RATING	- IIC RATING	9NILIMI 16'-4" 16'-4"	SINAWARANA WANDOAR HOOAR MR GWB @ BATH AND KITCHEN SIDE MR GWB @ BATH AND KITCHEN SIDE	COPYRIGHT KDI © 2017 THESE DRAWINGS ARE NOW AND DO REMAIN THE SOLE PROPERTY OF KHALSA DESIGN INC. USE OF THESE PLANS OR ANY FORM OF REPRODUCTION OF THIS DESIGN IN WHOLE OR IN PART WITHOUT EXPRESS WRITTEN CONSENT IS PROHIBITED AND SHALL RESULT IN THE FULLEST EXTENT OF	
	SIDE, WOOI DEFLI ASSE 6 MIL (TYP. CONT 1/2" P REFE SEE E 5/8"G' TYPE FRIMI 2 X 6 @ 16" R-21 F BATT R-21 F BATT SCHE FLOO SILL S	VAPOR BA ON ALL EX AIR BARR LYWOOD S R TO STRU ELEVATION YPSUM WA "X". PROVI AND COMF ER AND TW WOOD STU O.C. FIBERGLAS INSULATIC DULED BA R RUNNER SEALER, TY	PING AND AT RATED LOWANCE R/DEFLEC RRIER (TERIOR W IER (TYP) SHEATHING ICTURAL I FOR EXTINITION FOR EXTINITION (TURAL I FOR EXTINITION (TYP.) SE (P.	MINERAL PARTITIO TION VALLS) G DWG'S ERIOR SID TS TH ONE C	NS			Prosecution under Law         REGISTRATION         Image: constraint of the policies restricted of the policies of the poli	
ACTOAL ACTOAL S/8"		OF STRUCT SEALER A (# 10) LS I I I I I I I I I I I I I I I I I I I		ING EACH STC RATING	SIDE IIC RATING	DINITING HEIGHT 164.	HORIZONTAL LAP SIDING, SEE ELEVATION DWG'S FOR SIDING MATERIALS.	Partition Types	
								A-800 10 PILLION CT RESIDENCES	

ž

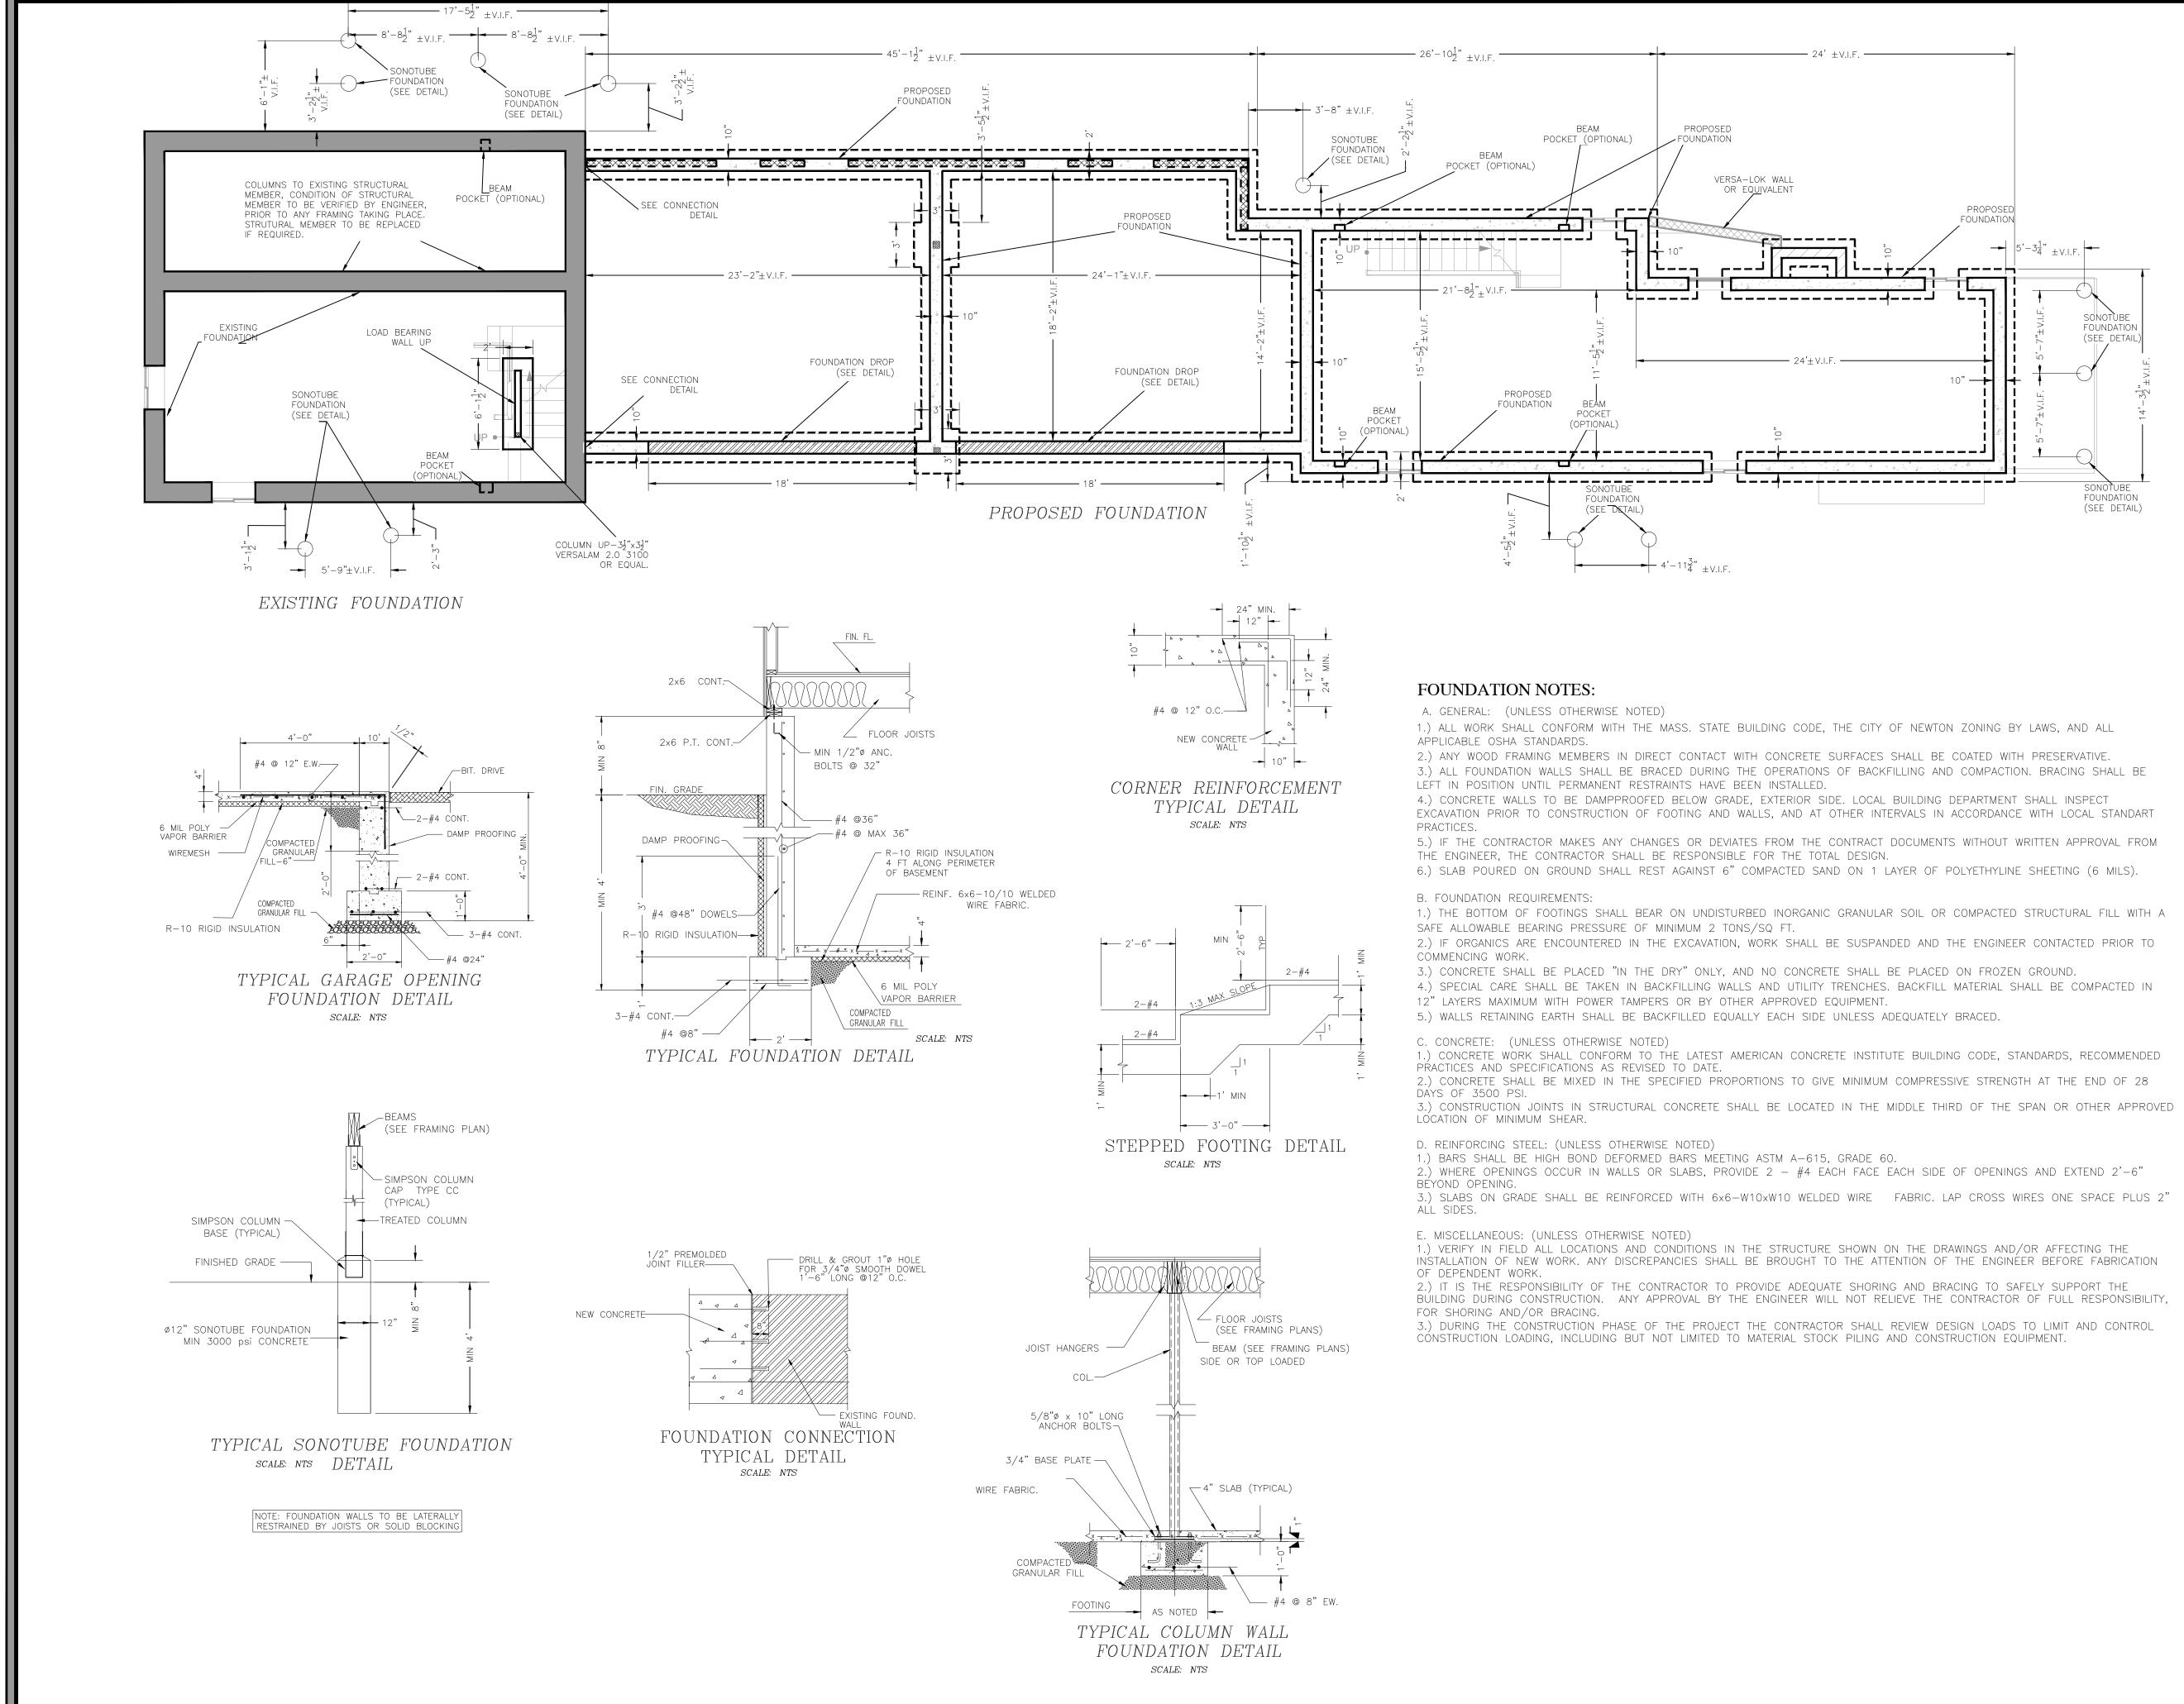



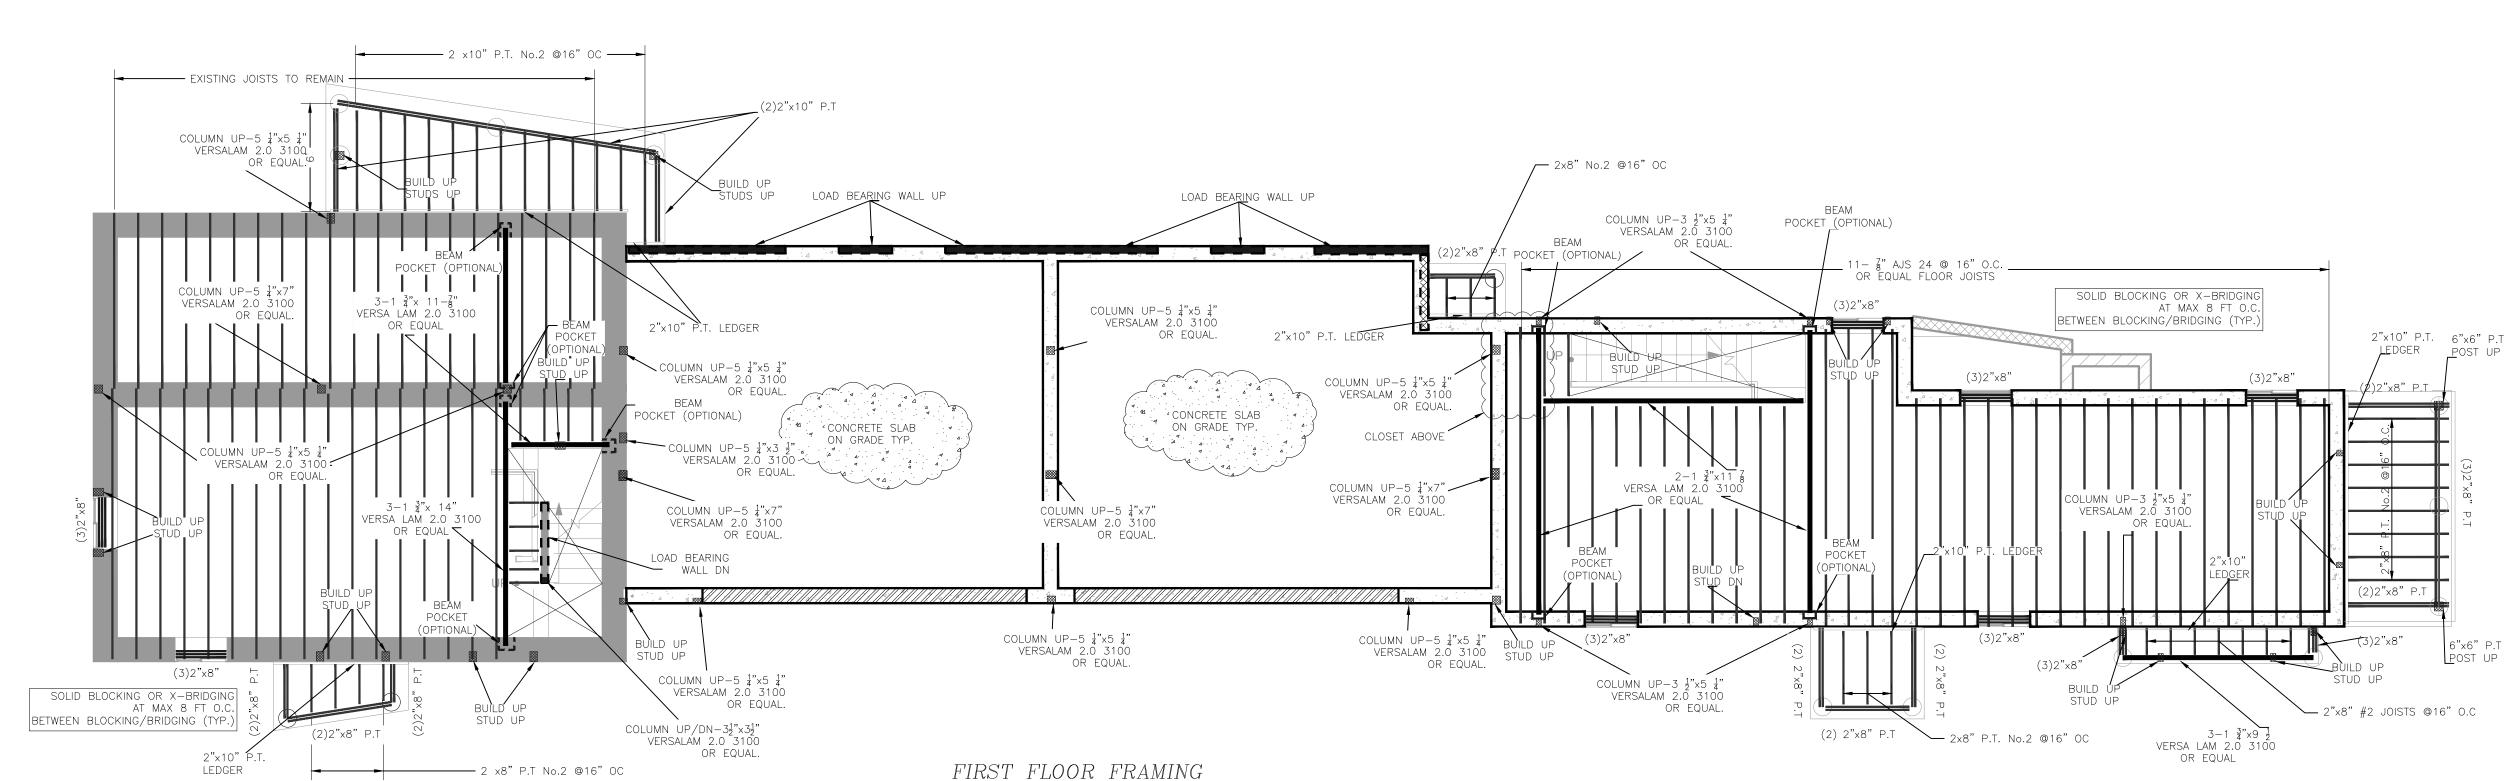

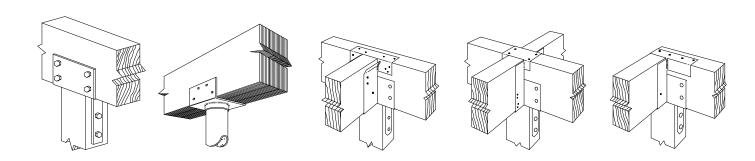

TYPE CC TYPE LCC TYPE CC/GLT TYPE CC/WD TYPE CC/HW TYPICAL BEAM/COLUMN CONNECTION DETAILS SCALE: NTS

## NOTES:

### CARPENTRY:

ALL ROUGH CARPENTRY SHALL PRODUCE JOINTS TRUE, TIGHT, WITH ALL MEMBERS ASSEMBLED IN ACCORDANCE WITH THE DRAWINGS AND WITH ALL PERTINENT CODES AND REGULATIONS. CAREFULLY SELECT ALL MEMBERS. SELECT INDIVIDUAL PIECES SO THAT KNOTS AND DEFECTS

WILL NOT INTERFERE WITH PLACING BOLTS OR PROPER NAILING OR MAKING CONNECTIONS. LUMBER MAY BE REJECTED BY THE ENGINEER, WHETHER OR NOT IT HAS BEEN INSTALLED, FOR EXCESSIVE WARP, TWIST, BOW, CROOK, MILDEW, FUNGUS, OR MOLD, AS WELL AS FOR IMPROPER CUTTING AND FITTING.

DO NOT SHIM SILLS, JOISTS, SHORT STUDS, TRIMMERS, HEADERS, LINTELS, OR OTHER FRAMING COMPONENTS. USE ONLY TREATED LUMBER FOR ALL WOOD BUCKS AND NAILING GROUNDS IN, OR IN CONTACT

WITH CONCRETE. TREAT ALL WOOD LESS THAN TWO FEET ABOVE FINISHED GRADE BY SPRAYING WITH THE PRESERVATIVE TO A MINIMUM DISTANCE OF SIX INCHES FROM THE ENDS. PERFORM ALL TREATMENT

IN STRICT ACCORDANCE WITH MANUFACTURER'S SPECIFICATIONS. IN ADDITION TO ALL FRAMING OPERATIONS NORMAL TO FABRICATION AND ERECTION INDICATED ON

THE DRAWINGS, INSTALL ALL BACKING REQUIRED FOR WORK OF OTHER TRADES. MAKE ALL BEARINGS FULL. FINISH ALL BEARING SURFACES ON WHICH STRUCTURAL MEMBERS ARE TO REST SO AS TO GIVE SURE AND EVEN SUPPORT. WHERE FRAMING MEMBERS SLOPE, CUT OR NOTCH THE ENDS AS REQUIRED TO GIVE UNIFORM BEARING SURFACE. INSTALL ALL BLOCKING REQUIRED TO SUPPORT ALL ITEMS OF FINISH AND TO CUT OFF ALL

CONCEALED DRAFT OPENINGS, BOTH VERTICAL AND HORIZONTAL, BETWEEN CEILING AND FLOOR AREAS.

FIRE BLOCKS SHALL BE TWO INCHES IN THICKNESS (NOMINAL) BY THE FULL WIDTH OF THE OPENING BEING BLOCKED.

FIRE-BLOCK IN THE FOLLOWING SPECIFIC LOCATIONS: (1) IN ALL STUD WALLS AT CEILING AND FLOOR LEVELS;

(2) IN ALL STUD WALLS, INCLUDING FURRED SPACES, SO THAT THE MAXIMUM DIMENSION OF EACH CONCEALED SPACE IS NOT MORE THAN EIGHT FEET;

(3) ALL OTHER LOCATIONS WHERE OPENINGS COULD AFFORD PASSAGE FOR RODENTS OR FLAMES. INSTALL WOOD CROSS BRIDGING OF NOT LESS THAN TWO INCHES BY THREE INCHES NOMINAL, METAL CROSS BRIDGING OF EQUAL STRENGTH, OR SOLID BLOCKING BETWEEN JOISTS WHERE THE SPAN EXCEEDS EIGHT FEET.

INSTALL SOLID BLOCKING BETWEEN JOISTS AT ALL POINTS OF SUPPORT AND WHEREVER SHEATHING OR FLOORING IS DISCONTINUOUS.

MAKE ALL STUDS SINGLE LENGTH, UNSPLICED, AND PLATFORM FRAMED. FRAME ALL CORNERS AND INTERSECTIONS WITH THREE OR MORE STUDS AND ALL REQUIRED BEARING FOR WALL FINISH. ON ALL FRAMING MEMBERS TO RECEIVE A FINISHED WALL OR CEILING, ALIGN THE FINISH

SUBSURFACE TO VARY NOT MORE THAN 1/8" FROM THE PLANE OF SURFACES OF ADJACENT FRAMING AND FURRING MEMBERS. PLACE ALL PLYWOOD WITH FACE GRAIN PERPENDICULAR TO SUPPORTS AND CONTINUOUSLY OVER

AT LEAST TWO SUPPORTS. ALL DOORS AND WINDOWS MUST BE INSTALLED WITH ALL NECESSARY APPURTENANCES AND TRIMS.

## NOTES:

### BE PRESSURE TREATED.

NOTE:

ALL EXPOSED WOOD AND WOOD IN DIRECT CONTACT WITH CONCRETE MUST

THE PROPERTIES OF WOOD MUST BE AS DESIGNED OR BETTER. SIMPSON CONNECTORS MUST BE USED AND INSTALLED IN ACCORDANCE WITH THE MANUFACTURER'S SPECIFICATIONS.

CONTRACTOR MUST VERIFY ALL DIMENSIONS IN FIELD. IF ADJUSTMENTS ARE NECESSARY, CONTACT THE ENGINEER.

COLUMNS OR BUILD-UP STUDS MUST BE INSTALLED UNDER EACH BEAM AND HEADER SUPPORT (TYP.) WHETHER IT IS SHOWN OR NOT ON THE PLANS. THESE COLUMNS MUST CARRY THE LOAD DOWN TO THE FOUNDATION OR BEAM BELOW.

