BEAL BANK - NEWTON, MA 71 NEEDHAM STREET, SUITE 1D NEWTON, MA 02461

INTERIOR CONSTRUCTION - ISSUED FOR PERMIT

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SUITE 5300

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CONTACT:


TOM GODFREY 781.258.1199

PHONE:



LOCATION PLAN

NOT TO SCALE

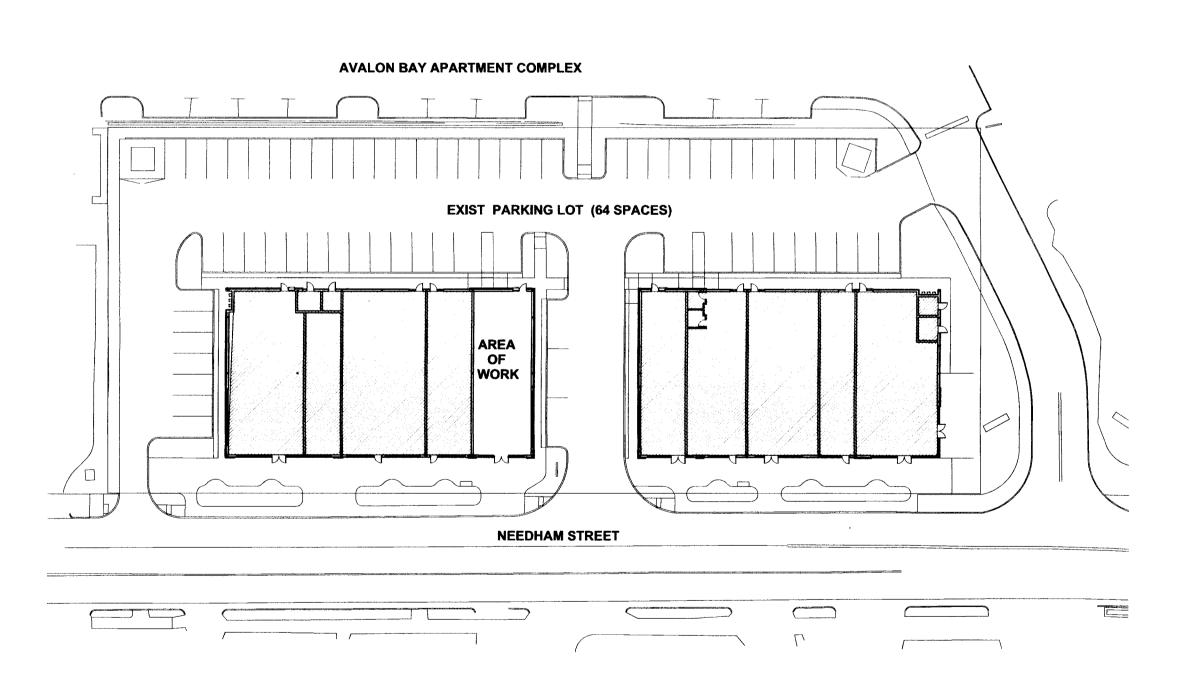

SITE PLAN NOT TO SCALE

LIST OF DRAWINGS

ARCHITECTURAL DRAWINGS

COVER SHEET A0 A0.1A ADDITIONAL CODE INFORMATION 1A.1 1ST FLOOR ARCHITECTURE PLAN 1A.2 1ST FLOOR REFLECTED CEILING PLAN 1A.3 1ST FLOOR POWER AND COMMUNICATION PLAN **1ST FLOOR FINISH PLAN** 1A.4 A6.1 **ELEVATIONS ELEVATIONS** A6.2 A6.3 MILLWORK SECTION DETAILS A6.4 MILLWORK DETAILS A6.5 MILLWORK DETAILS DOOR SCHEDULE/DETAILS A7.1 A11.1 **GENERAL NOTES**

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No. 6978 SCITUATE, MA

COMMISSIONING SPECIFICATIONS

M0.02 MECHANICAL SPECIFICATIONS

M0.03 MECHANICAL SPECIFICATIONS AND SYMBOL LIST

M0.04 MECHANICAL SCHEDULES M0.05 MECHANICAL DETAILS M0.06 MECHANICAL DETAILS

SPECIFICATIONS

SPECIFICATIONS

SPECIFICATIONS

ENGINEERING DRAWINGS

A11.2

A11.3

A11.4

M0.01

M4.01 **1ST FLOOR MECHANICAL PLAN**

E0.01 **ELECTRICAL SPECIFICATIONS** ELECTRICAL SPECIFICATIONS E0.03 **ELECTRICAL SYMBOLS LIST**

E0.04 **ELECTRICAL LIGHTING SCHEDULES** E0.05 **ELECTRICAL RISER DIAGRAM & SCHEDULES**

E3.01 **ELECTRICAL POWER PLAN** E4.01 **ELECTRICAL LIGHTING PLAN** E5.01 1ST FLOOR DAYLIGHTING PLAN


E6.01 **1ST FLOOR HVAC PLAN**


FA0.01 FIRE ALARM SPECIFICATIONS FA0.02 FIRE ALARM SPECIFICATIONS FA1.01 1ST FLOOR FIRE ALARM PLAN

P0.01 PLUMBING SPECIFICATIONS P0.02 PLUMBING SPECIFICATIONS & SYMBOLS P0.03 PLUMBING SCHEDULES & DETAILS P3.00 UNDERGROUND PLUMBING PLAN P3.01 1ST FLOOR PLUMBING PLAN

FP0.01 FIRE PROTECTION SPECIFICATIONS FP0.02 FIRE PROTECTION DETAILS, SCHEDULE, AND SPECIFICATIONS

FP3.01 **1ST FLOOR FIRE PROTECTIONS PLAN**

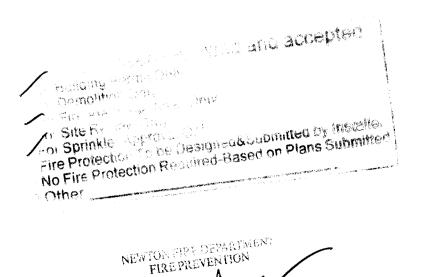

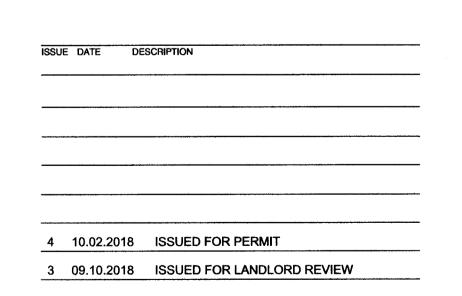


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COVER SHEET

DRAWING SCALE: AS NOTED

A0






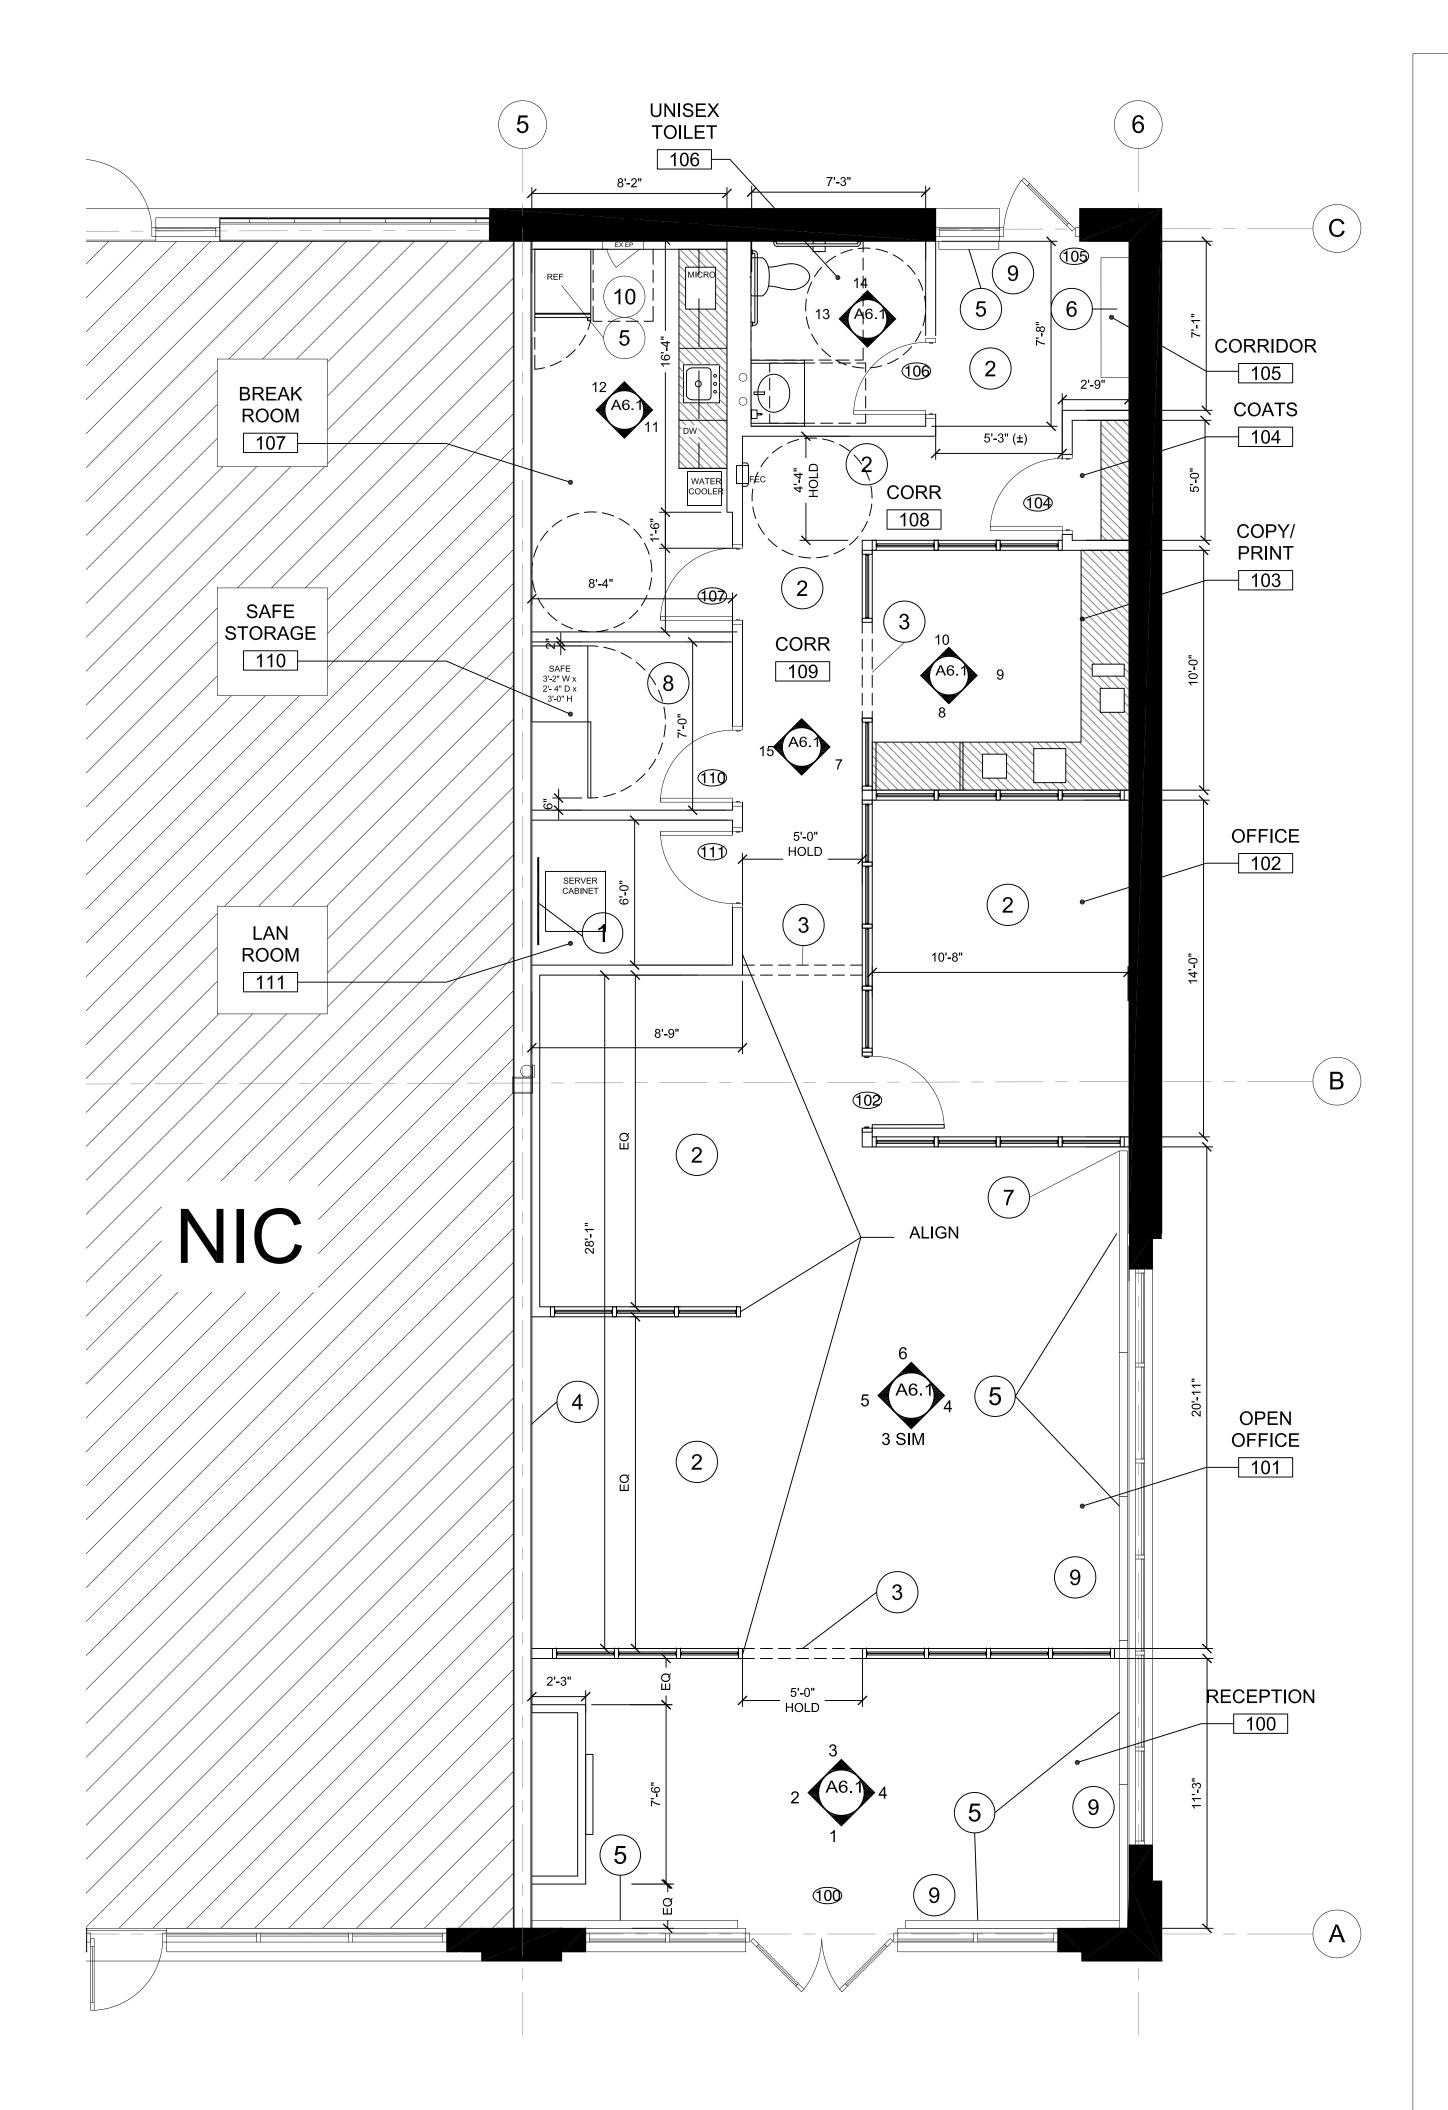

GENERAL NOTES


- A. SEE SHEET 1A.3 FOR ALL EQUIPMENT SPECIFICATIONS.
- B. SEE SHEET A7.1 FOR DOOR SCHEDULE.
- C. ALL PARTITIONS TO BE TYPE B UNLESS NOTED OTHERWISE; SEE WALL TYPES, SHEET A7.1.
- D. ALL DIMENSIONS ARE FACE OF GYP. BD. TO FACE OF GYP.BD. G.C. AND MILLWORKER SHALL COORDINATE ALL DIMENSIONS WITH INSTALLATION OF WOOD WALL PANELS.
- E. FIRE SAFE ALL PENETRATIONS IN ANY FIRE RATED PARTITIONS/DEMISING WALLS; AS REQUIRED TO MAINTAIN CODE COMPLIANCE.
- F. PROVIDE FIRE RETARDENT TREATED BLOCKING IN ALL LOCATIONS FOR WALL HUNG MILLWORK, EQUIPMENT, TOILET ROOM ACCESSORIES ETC. -
- G. G.C. SHALL REVIEW PARTITION TYPES WITH MECHANICAL DRAWINGS TO COORDINATE AREAS OF PLENUM AND NON-PLENUM CEILINGS.
- H. G.C. IS TO NOTIFY ARCHITECT OF LAYOUT DISCREPANCIES BEFORE PLACEMENT OF METAL RUNNERS AND STUDS.
- I. "ALIGN", AS USED IN THESE DOCUMENTS, SHALL MEAN TO ACCURATELY LOCATE FINISH FACES IN THE SAME PLANE.
- J. "TYPICAL" (OR "TYP."), AS USED IN THESE DOCUMENTS, SHALL MEAN THAT THE CONDITION IS THE SAME OR REPRESENTATIVE FOR ALL SIMILAR CONDITIONS UNLESS OTHERWISE NOTED.
- K. DIMENSIONS LOCATING DOORS IN GYPSUM BOARD PARTITIONS ARE TO BE FROM FINISHED FACE OF PARTITION TO THE INSIDE FACE OF FRAME.
- .. WHERE NEW WORK ADJOINS EXISTING, SUCH NEW WORK SHALL BE PROPERLY INTEGRATED WITH THE EXISTING TO INSURE A UNIFORM APPEARANCE AND LEAVE NO EVIDENCE OF REMODELING.
- M. PROVIDE 1/4" DIAMETER COLD WATER LINES FOR REFRIGERATOR. SEE POWER PLAN FOR REFRIGERATOR SPECIFICATION..

CONSTRUCTION PLAN LEGEND

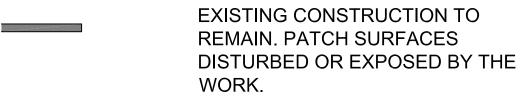




NEW PARTITION (SEE <u>WALL</u> TYPES, SHEET A7.1)

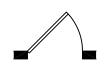

EXISTING SWING DOOR

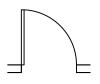


NEW SWING DOOR




DOOR TYPE (SEE <u>DOOR</u> SCHEDULE, SHEET A7.1)



NEW MILLWORK

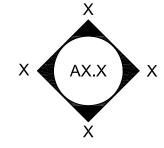

ELEVATION TAG

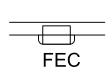

NEW FIRE EXTINGUISHER CABINET SEE POWER PLAN FOR SPECIFICATION

KEY NOTES

- PROVIDE AND INSTALL ¾" x 4' x 8' FIRE RETARDANT PLYWOOD WALL PANEL FOR MOUNTING OF EQUIPMENT IN LAN ROOM 111. COORDINATE EXACT PLACEMENT OF PANEL WITH BEAL REPRESENTATIVE. PAINT TO MATCH ADJACENT WALL.
- WD-1 CROWN MOLDING, CHAIR RAIL, AND WD-1 BASE WITH WALL COVERING WC-1 THIS AREA. REFER TO ELEVATIONS/FINISH PLAN FOR ADDITIONAL INFORMATION.
- PROVIDE WD-1 TRIM ON UNDERSIDE OF GYP BOARD FASCIA. BOTTOM OF TRIM TO BE FLUSH WITH BOTTOM OF THE CROWN MOLDING-TYP
- PROVIDE A SEPARATE COST FOR NEW DEMISING PARTITION. TAPE AND MUD NIC SIDE ONLY.
- PROVIDE NEW BASEBOARD HEATERS. SEE ENGINEERING DRAWINGS FOR SPECS.
- (6) WALL MOUNTED HEATER SEE ENGINEERING DWGS
- 7 HOLD NEW BASEBOARD HEATER 2" FROM NEW PARTITION FOR INSTALLATION OF NEW WALL BASE.
- 8 COORDINATE WITH TENANT'S VENDOR RELOCATION OF EXISTING SAFE AFTER FIT OUT OF ROOM IS COMPLETE.
- 9 PROVIDE NEW HORIZONTAL MINI BLINDS SPEC TBD
- PROVIDE FURR OUT SO FACE OF GYP BOARD IS FLUSH WITH FACE OF EXISTING ELECTRICAL PANEL

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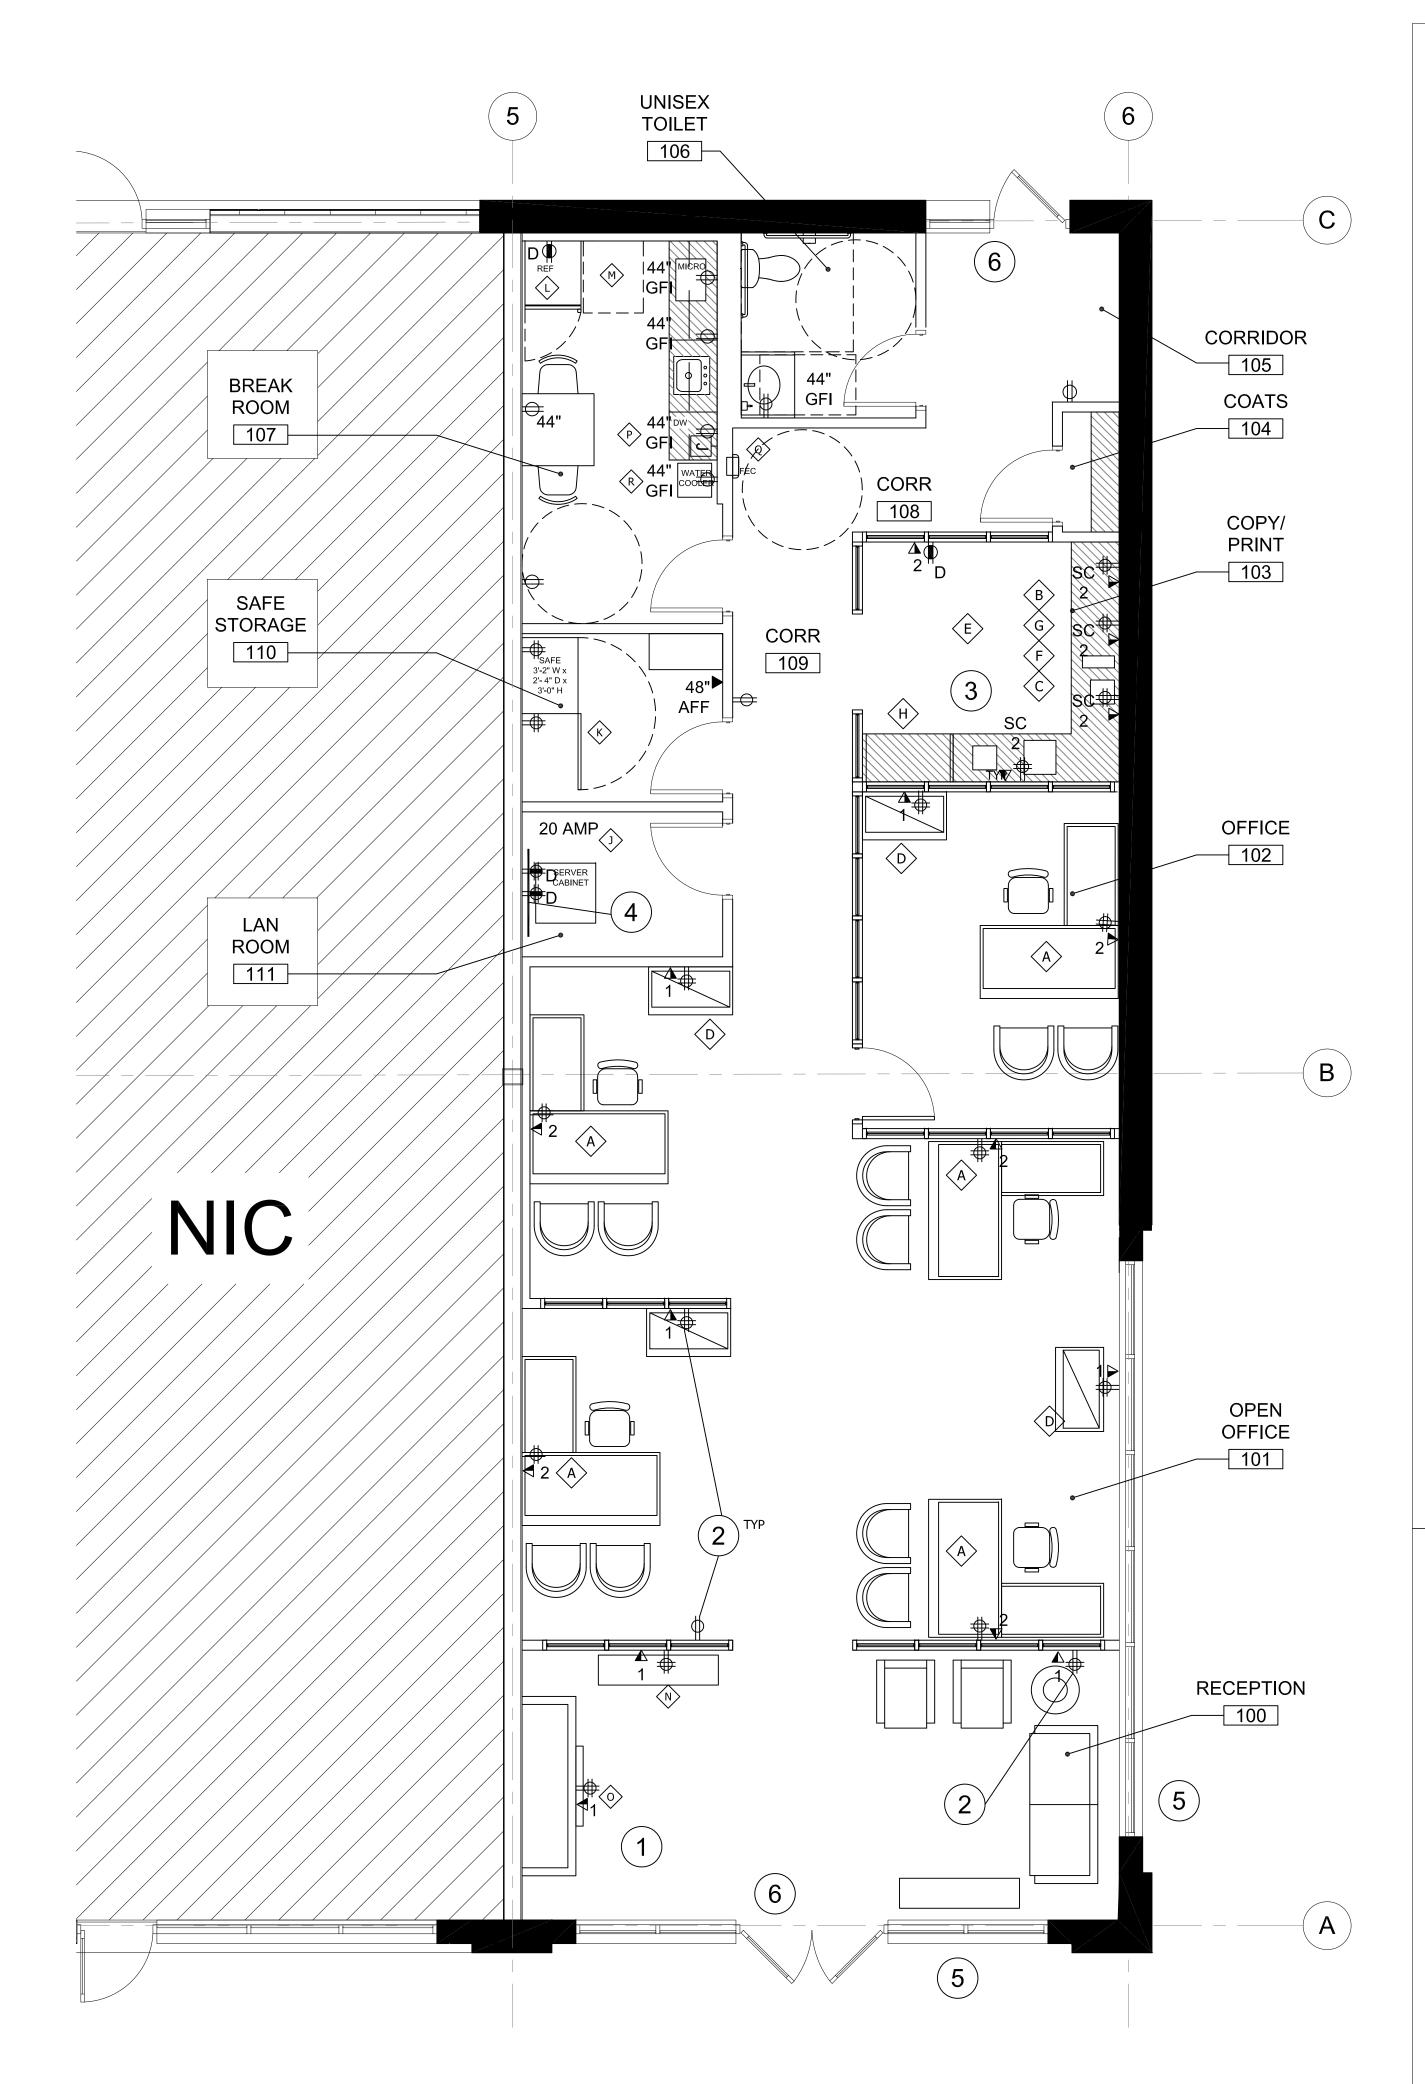
1ST FLR CONSTRUCTION PLAN

PROJECT NUMBER: DRAWN BY: DRAWING NUMBER:

RAWING NAME: DRAWING SCALE

CONSTRUCTION PLAN.DWG 1/4" = 1'-0"

1A.







EQUIPMENT LEGEND

NOTE: ALL EQUIPMENT/APPLIANCES SHALL BE PROVIDED BY TENANT UNLESS NOTED OTHERWISE.

- A PC WITH FLAT SCREEN 20" DIA MONITOR.
- (2) PC'S WITH (2) 20" DIA. FLAT SCREEN MONITORS. NOTE: PC'S TO BE LOCATED INSIDE BASE CABINET.
- C CHECK PRINTER CANON DR-3080C11, 13"W X 13"D X 8"H.
- (D) HP PRINTER 17"W X 26"D X 19"H
- E COPY/SCANNER/FAX CANON IMAGE RUNNER ADVANCE SERIES MAIN UNIT 43"W X 46"D
- POSTAGE METER -EXISTING 30"W X 17"D X 13"H
- ⟨G⟩ UNISYS CHECK SORTER, 6"W X 16"D X 8"H
- (h) 2 DRW LAT. FILE (36" WIDE) BY OTHERS
- (1) SERVER RACK: 24"W X 32"D X 49"H 200 LBS. EMPTY - 400 LBS FULL (RELOCATED TENANT PROVIDED/ INSTALLED)
- SAFE: SIZE: 3'-2" W X 2'-4" D X 3'-0" H (TENANT RELOCATED AND INSTALLED)
- GC PROVIDED REFRIGERATOR WITH ICEMAKER: ADD WATER LINE FOR FEED TO ICEMAKER. GE 17.5 CU. FT. BLACK TOP FREEZER REFRIGERATOR

STYLE NO: GTE18GTHBB 32.5" D X 66.88" H X 28" W COLOR: BLACK

- M TENANT PROVIDED MICROWAVE
- COFFEE DISPENSER BY TENANT
- OWNER PROVIDED PLASMA TV AND MOUNTING BRACKET GC TO COORDINATE DEVICE LOCATIONS WITH EXISTING BRACKET
- GENERAL CONTRACTOR PROVIDED NEW DISHWASHER GE 24" BUILT-IN DISHWASHER ADA COMPLIANT STYLE NO: GLDT225-SGLBB MANF: BLACK

24" W X H 32.25" H X 22 7/8"

EXTINGUISHER CABINET W/ EXTINGUISHER

MANF LARSEN STYLE: 2409-R1

INSIDE BOX DIMENSIONS: 91/2" W X 5" D X 24" H OUTSIDE TRIM DIMENSIONS: 13" W X 10½" D X 25" h ROUGH OPENING: $10\frac{1}{2}$ " W X $5\frac{1}{4}$ " D X 25" H

R TENANT PROVIDED WATER COOLER

KEYNOTES

- LOCATION OF POWER AND DATA OUTLETS TO BE COORDINATED WITH TENANT PROVIDED BRACKET AND MONITOR. POWER/DATA TO BE LOCATED IN LOWER LEFT CORNER OF PLASMA SCREEN POCKET.
- LOCATE OUTLETS 18" AFF. PROVIDE EXTENDERS WITH J-BOXES TO ACCOMMODATE WD-1 RAISED PANELS.- SEE
- COORDINATE CUT OUT ACCESS IN CABINET WITH POWER AND DATA LOCATIONS. SEE MILLWORK BASE CABINET DETAILS. TYPICAL ALL OUTLETS IN COPY/FAX AREA.
- INSTALL 3/4" X 4' X 8' FIRE RETARDANT PLYWOOD PANEL MOUNTED ON WALL. PAINT TO MATCH ADJACENT WALL
- PROVIDE NEW CONNECTIONS AS REQUIRED TO ILLUMINATE NEW SIGNAGE ON (2) SIDES OF BUILDING. SEE ENGINEERING DRAWINGS.
- PROVIDE NEW DOOR ANNUNCIATORS @ EACH ENTRY

POWER/DATA SYMBOLS

WALL MOUNTED SEPARATE CIRCUIT DUPLEX

WALL MOUNTED DUPLEX RECEPTACLE

WALL MOUNTED QUADRADUPLEX RECEPTACLE

WALL MOUNTED DATA RECEPTACLE WITH (2) DATA

WALL MOUNTED DUPLEX RECEPTACLE

WALL MOUNTED TELEPHONE @ 48" AFF

WALL MOUNTED DEDICATED QUADRADUPLEX RECEPTACLE

GENERAL NOTES

- A. THIS DRAWING INDICATES THE GENERAL LOCATION OF FIXTURES, DEVICES, EQUIPMENT AND COMPONENTS, ARCHITECTURAL DETAILS AND FINISHES. REFER TO ENGINEERING DRAWINGS FOR ADDITIONAL INFORMATION, SPECIFICATIONS AND SCHEDULES
- B. ALL DIMENSIONS ARE TO THE CENTERLINE OF ELECTRICAL OUTLET OR OUTLET GROUP. SEE COVER SHEET/ELEVATIONS FOR OUTLET & DEVICE MOUNTING HEIGHTS, UNO.
- C. G.C. IS TO NOTIFY THE ARCHITECT/PM WHEN LAYOUT OF ELECTRICAL AND COMMUNICATION DEVICES MAY BE REVIEWED PRIOR TO FINAL INSTALLATION.
- D. PROVIDE G.F.I. OUTLETS WITHIN 6'-0" OF ALL WET LOCATIONS.
- E. ELECTRICAL AND COMMUNICATION OUTLETS ARE NOT TO BE PLACED BACK TO BACK IN A SINGLE PARTITION, BUT PLACED OFFSET TO AVOID SOUND TRANSMISSION.
- F. ALL DIMENSIONS ARE FROM FACE OF GYP. BD.-UNO.
- G. ALL RECEPTACLES SHALL BE MOUNTED HORIZONTALLY AT 18" A.F.F. TO CENTER LINE OF OUTLET U.N.O.
- H. REFER TO ELECTRICAL ENGINEERING DRAWINGS FOR ALL POWER, DATA AND VOICE REQUIREMENTS.
- I. CONTRACTOR SHALL COORDINATE W/ TENANT'S SECURITY VENDOR FOR SECURITY SYSTEM DEVICES AND HOOKUP.
- J. GC TO COORDINATE W/ TENANT'S CABLING AND SECURITY CONTRACTORS TO INSTALL ALL PHONE/DATA CABLE. CABLE TO BE CAT 5E.
- K. COORDINATE OUTLET PLACEMENT WITH RAISED PORTION OF WOOD WALL PANELS. PROVIDE EXTENDERS AS REQUIRED. SEE ELEVATIONS.
- L. FIRE SAFE ALL NEW PENETRATIONS LOCATED IN DEMISING WALLS.
- M. DEVICE COLORS AS FOLLOWS:
- DEVICES & COVER PLATES AT ALL WOOD PANELING TO BE: BROWN

DEVICES AND COVER PLATES AT ALL WALL COVERING AND PAINTED PARTITIONS TO BE: IVORY

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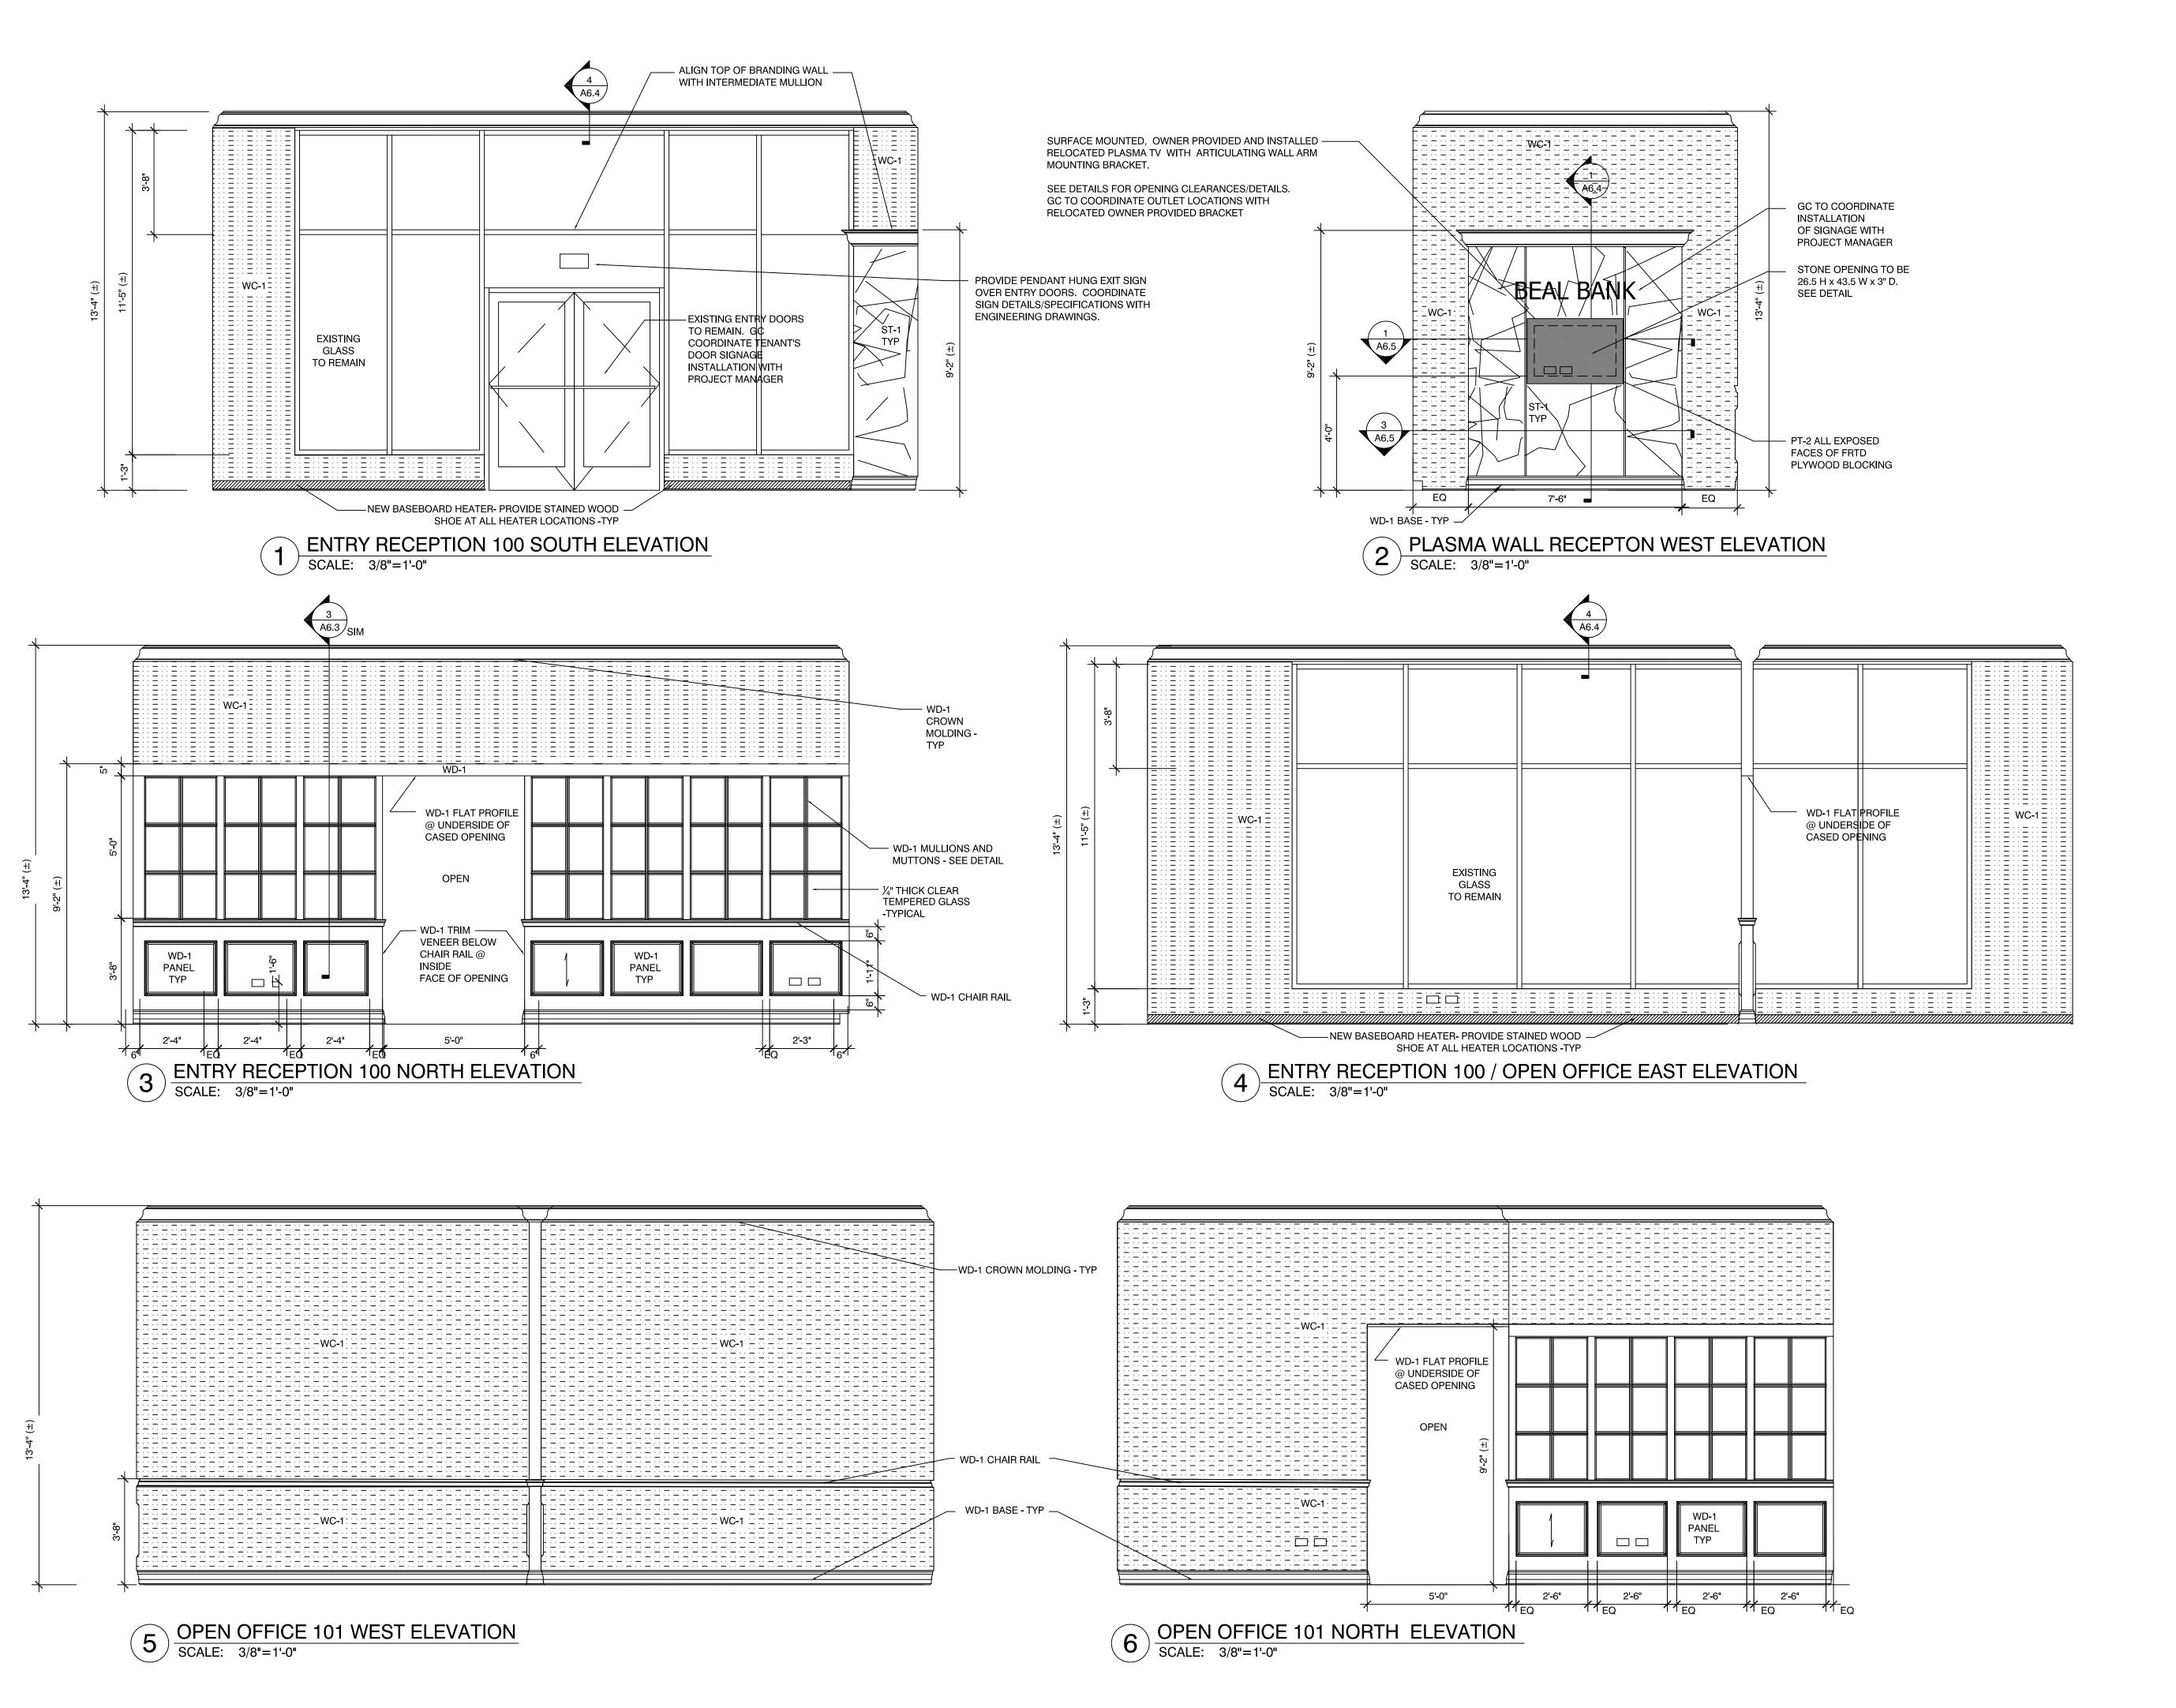
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1ST FLR POWER/DATA PLAN

POWER DATA PLAN.DWG 1/4" = 1'-0"



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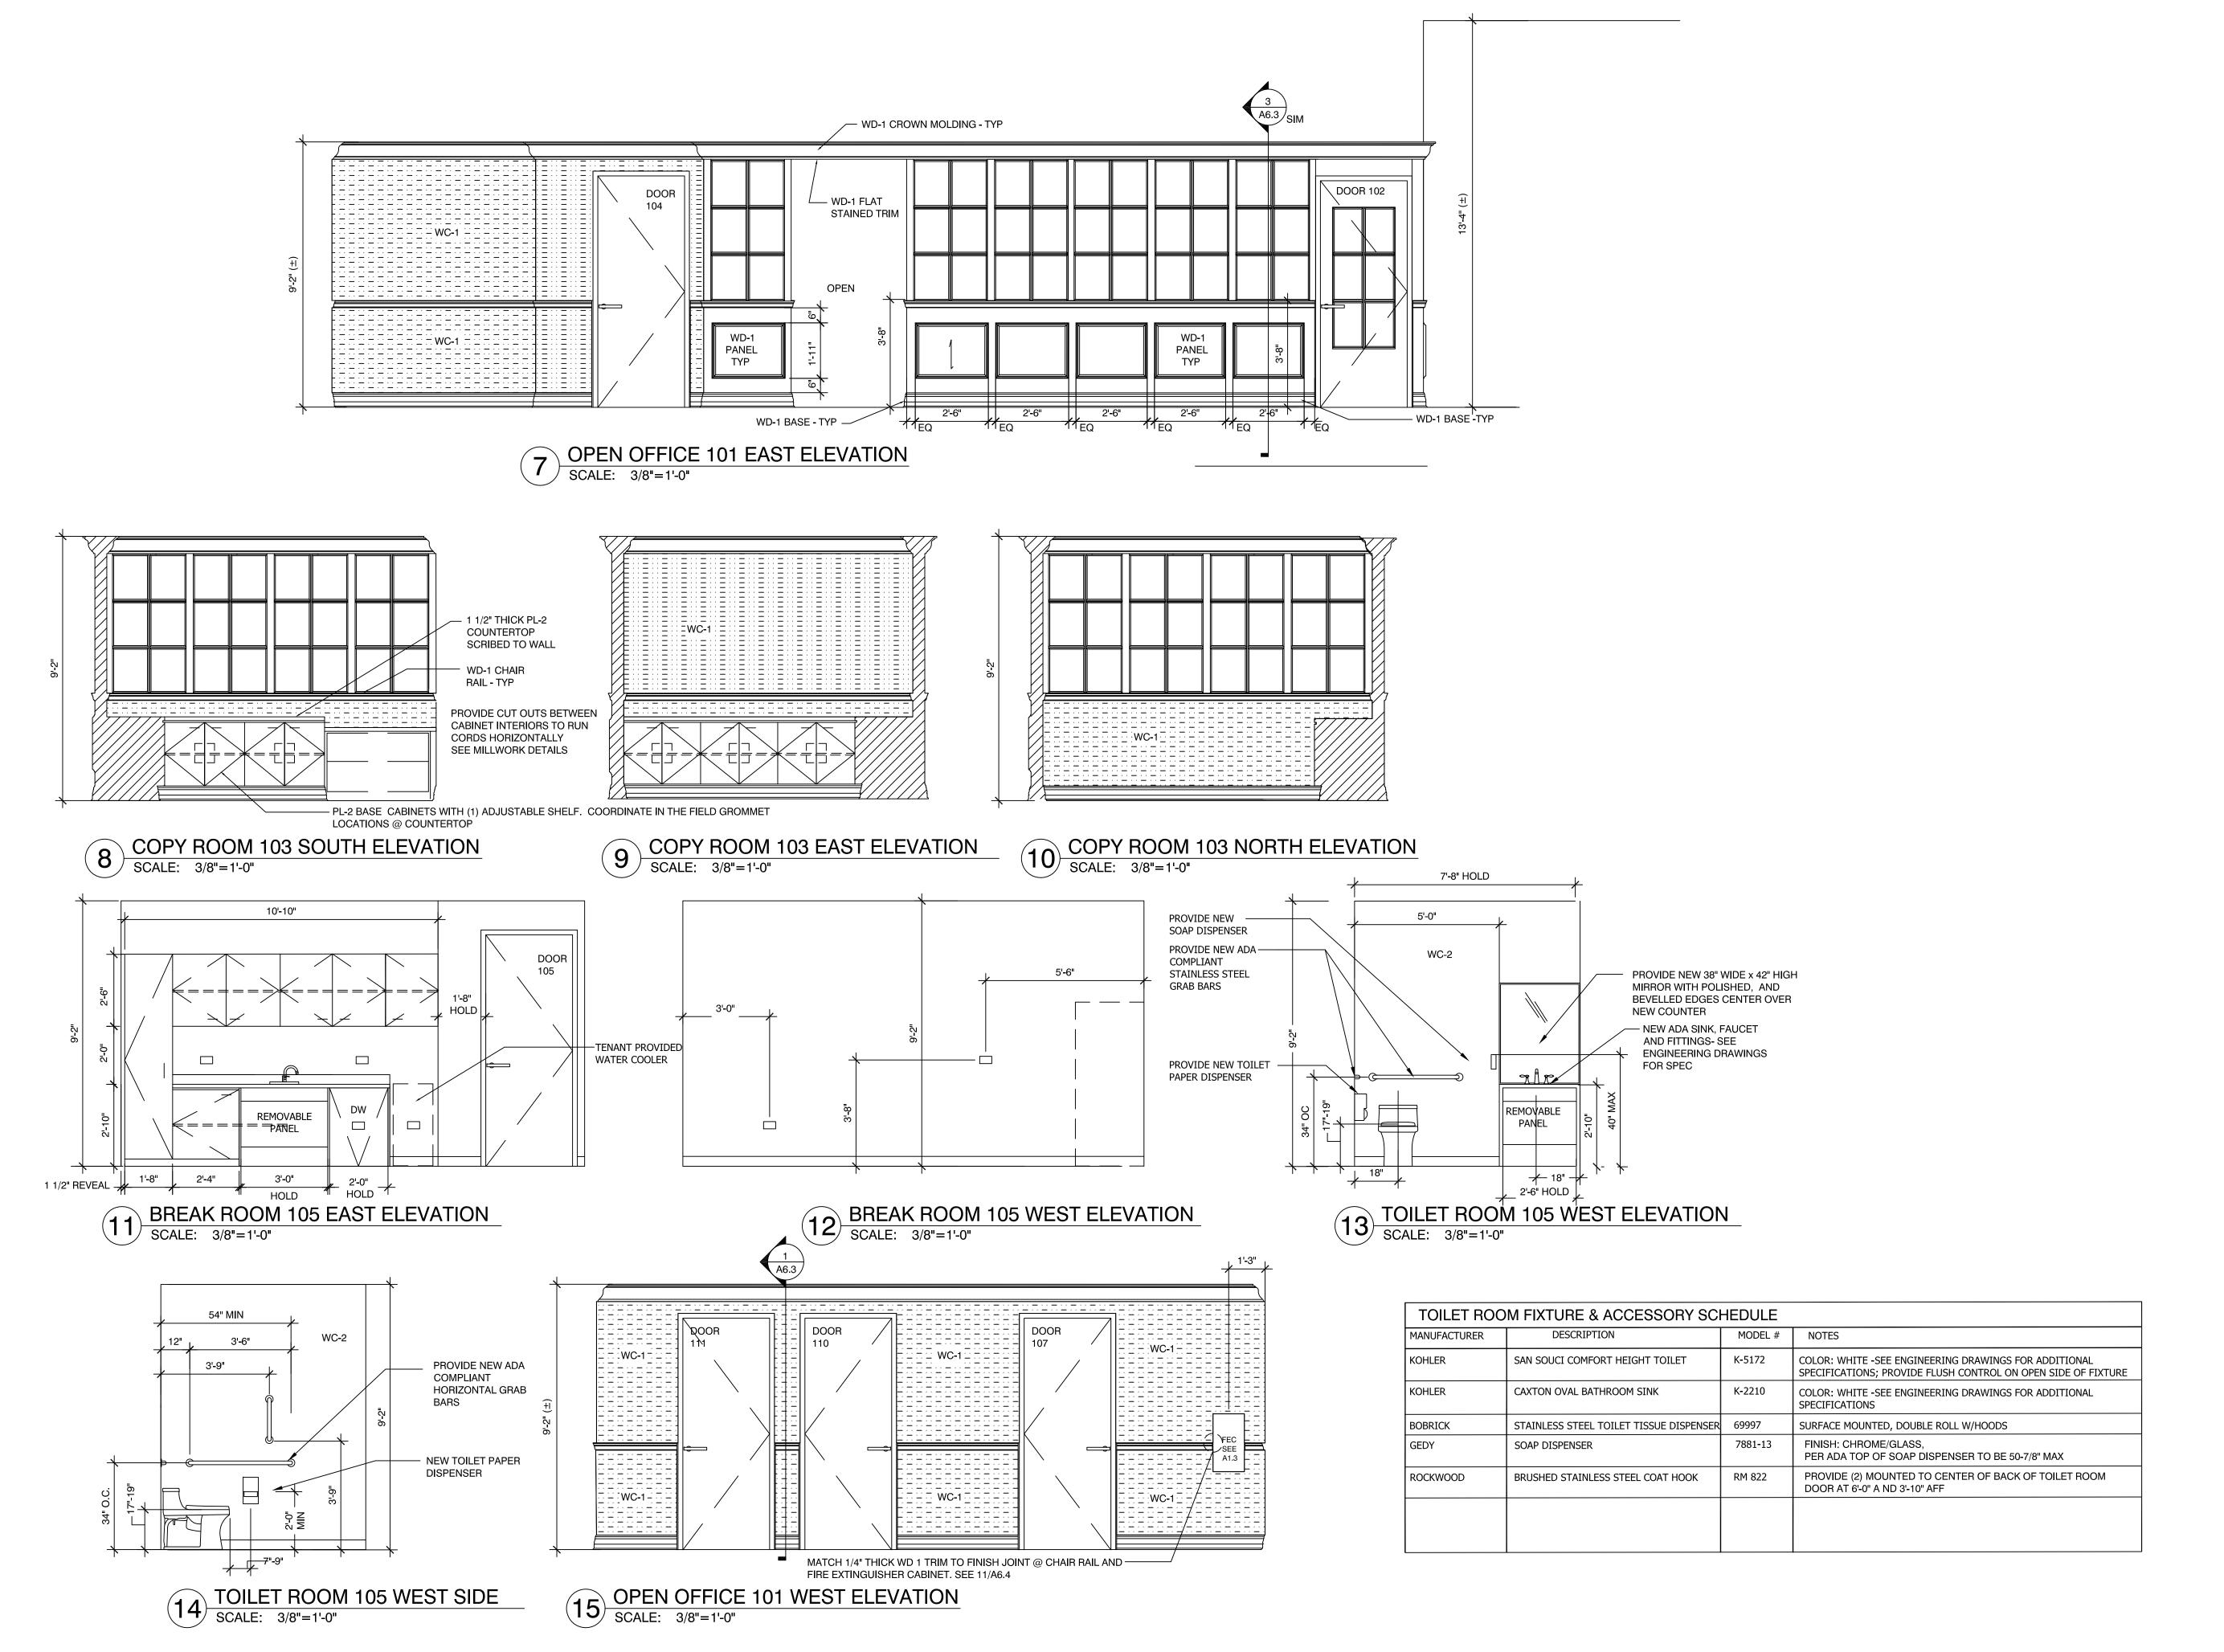
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ELEVATIONS

ELEVATIONS.DWG

PROJECT NUMBER;	DRAWN BY:	DRAWING NUMBER:	
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