

170 NEEDHAM STREET NEWTON, MA



RETAIL BUILDING FLOOR PLAN

06/26/2013 ---

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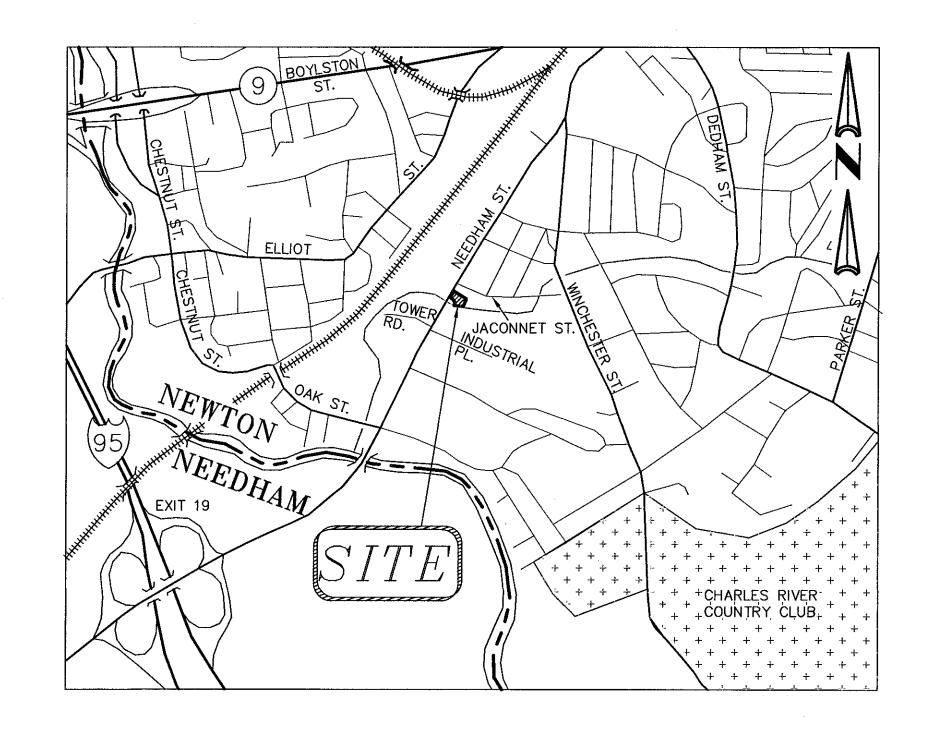
SITE DEVELOPMENT PLANS

FOR

170 NEEDHAM STREET NEWTON, MA

JUNE 26, 2013

	SHEET INDEX									
SHEET No.	DESCRIPTION	LATEST REV	ISED DATE	CONST	RUCTION	REV	ISIONS			
1	COVER SHEET									
2	LOCUS PLAN									
3	EXISTING CONDITIONS PLAN									
4	LAYOUT PLAN									
5	SITE PLAN									
6	DETAIL SHEET			- "						



LOCATION MAP

OWNER:

NEEDHAM CHESTNUT REALTY, LLC 310 WASHINGTON STREET, SUITE 202 WELLESLEY, MA 02481

CIVIL ENGINEERS:

KELLY ENGINEERING GROUP, INC. O CAMPANELLI DRIVE BRAINTREE, MA 02184

ARCHITECT:


HDS ARCHITECTURE, INC. 625 MT. AUBURN STREET CAMBRIDGE, MA 02138

LANDSCAPE ARCHITECT:

HAWK DESIGN, INC. 39 PLEASANT STREET SAGAMORE, MA 02561

ATTORNEY:


SCHLESINGER AND BUCHBINDER, LLP 1200 WALNUT STREET NEWTON, MA 02461

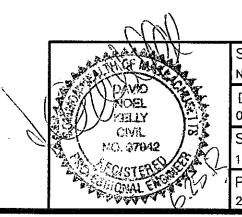


DISK REF NO. F: \P\2013-028 DRAWN BY 06/26/13 CHKD BY PLAN NO. APPD BY

170 NEEDHAM ST. NEWTON, MA KELLY ENGINEERING GROUP, INC.
CIVIL ENGINEERING CONSULTANTS O CAMPANELLI DRIVE · BRAINTREE MA · 02184

PHONE: 781 843 4333 FAX: 781 843 0028

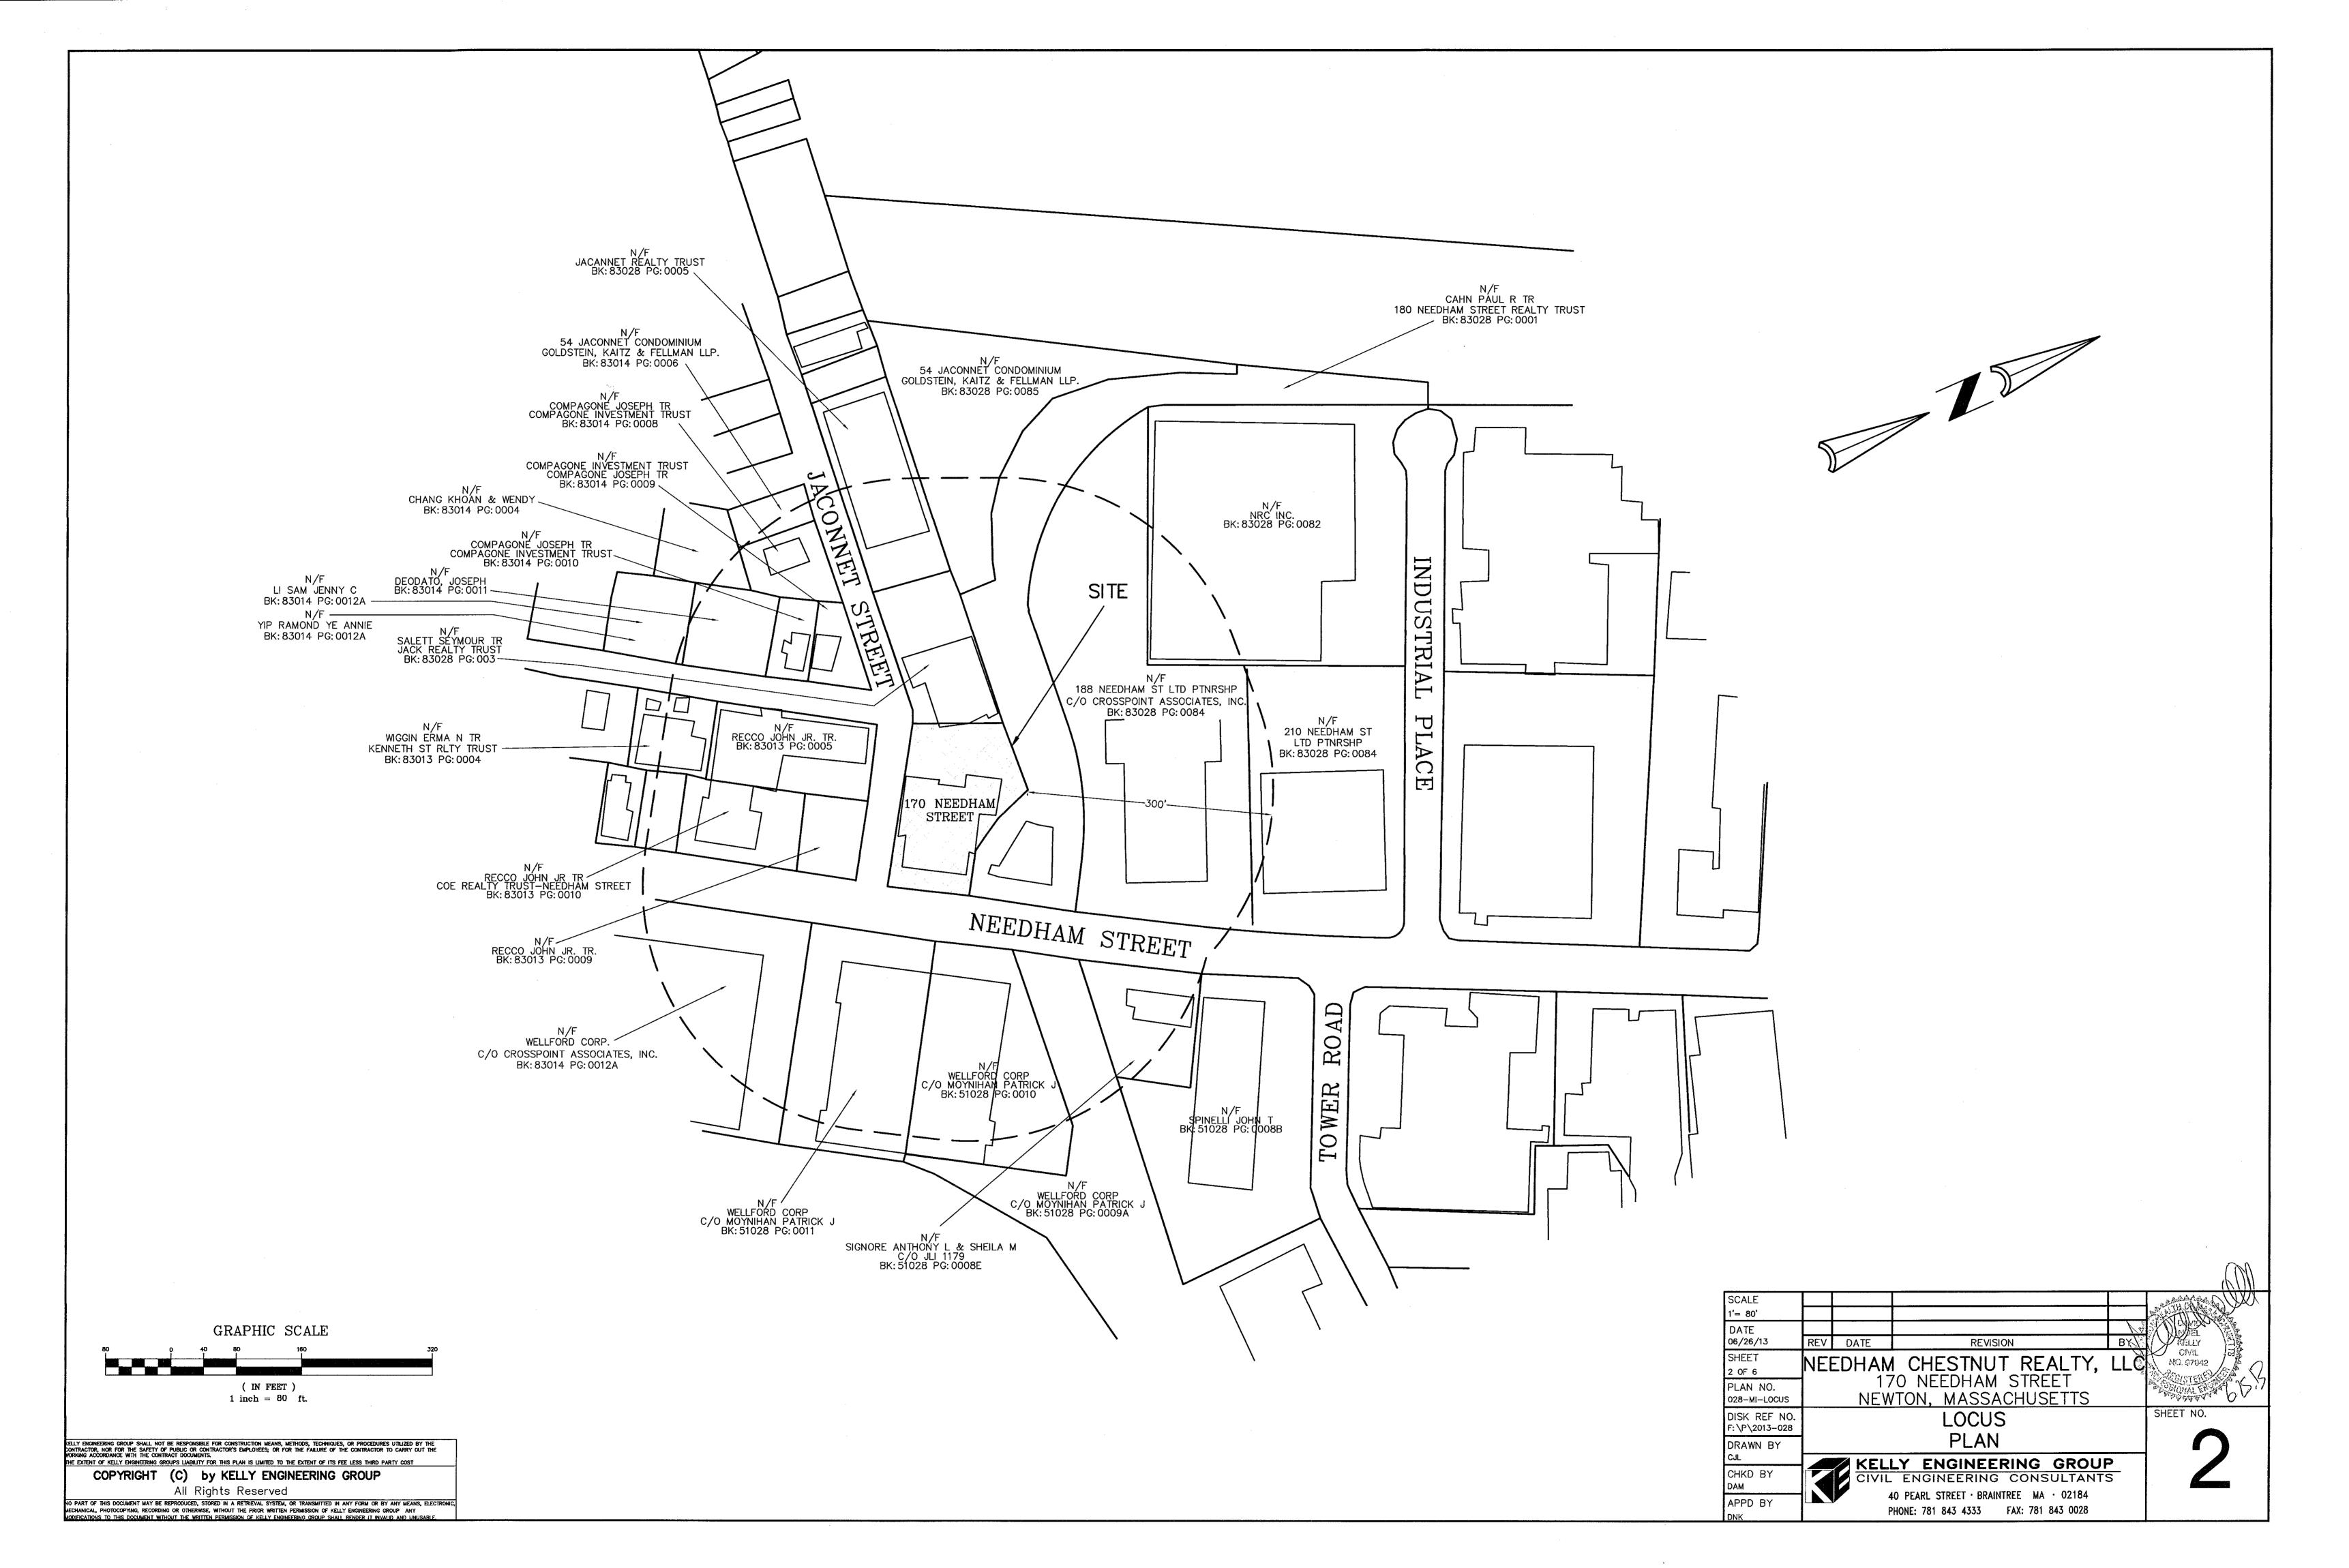

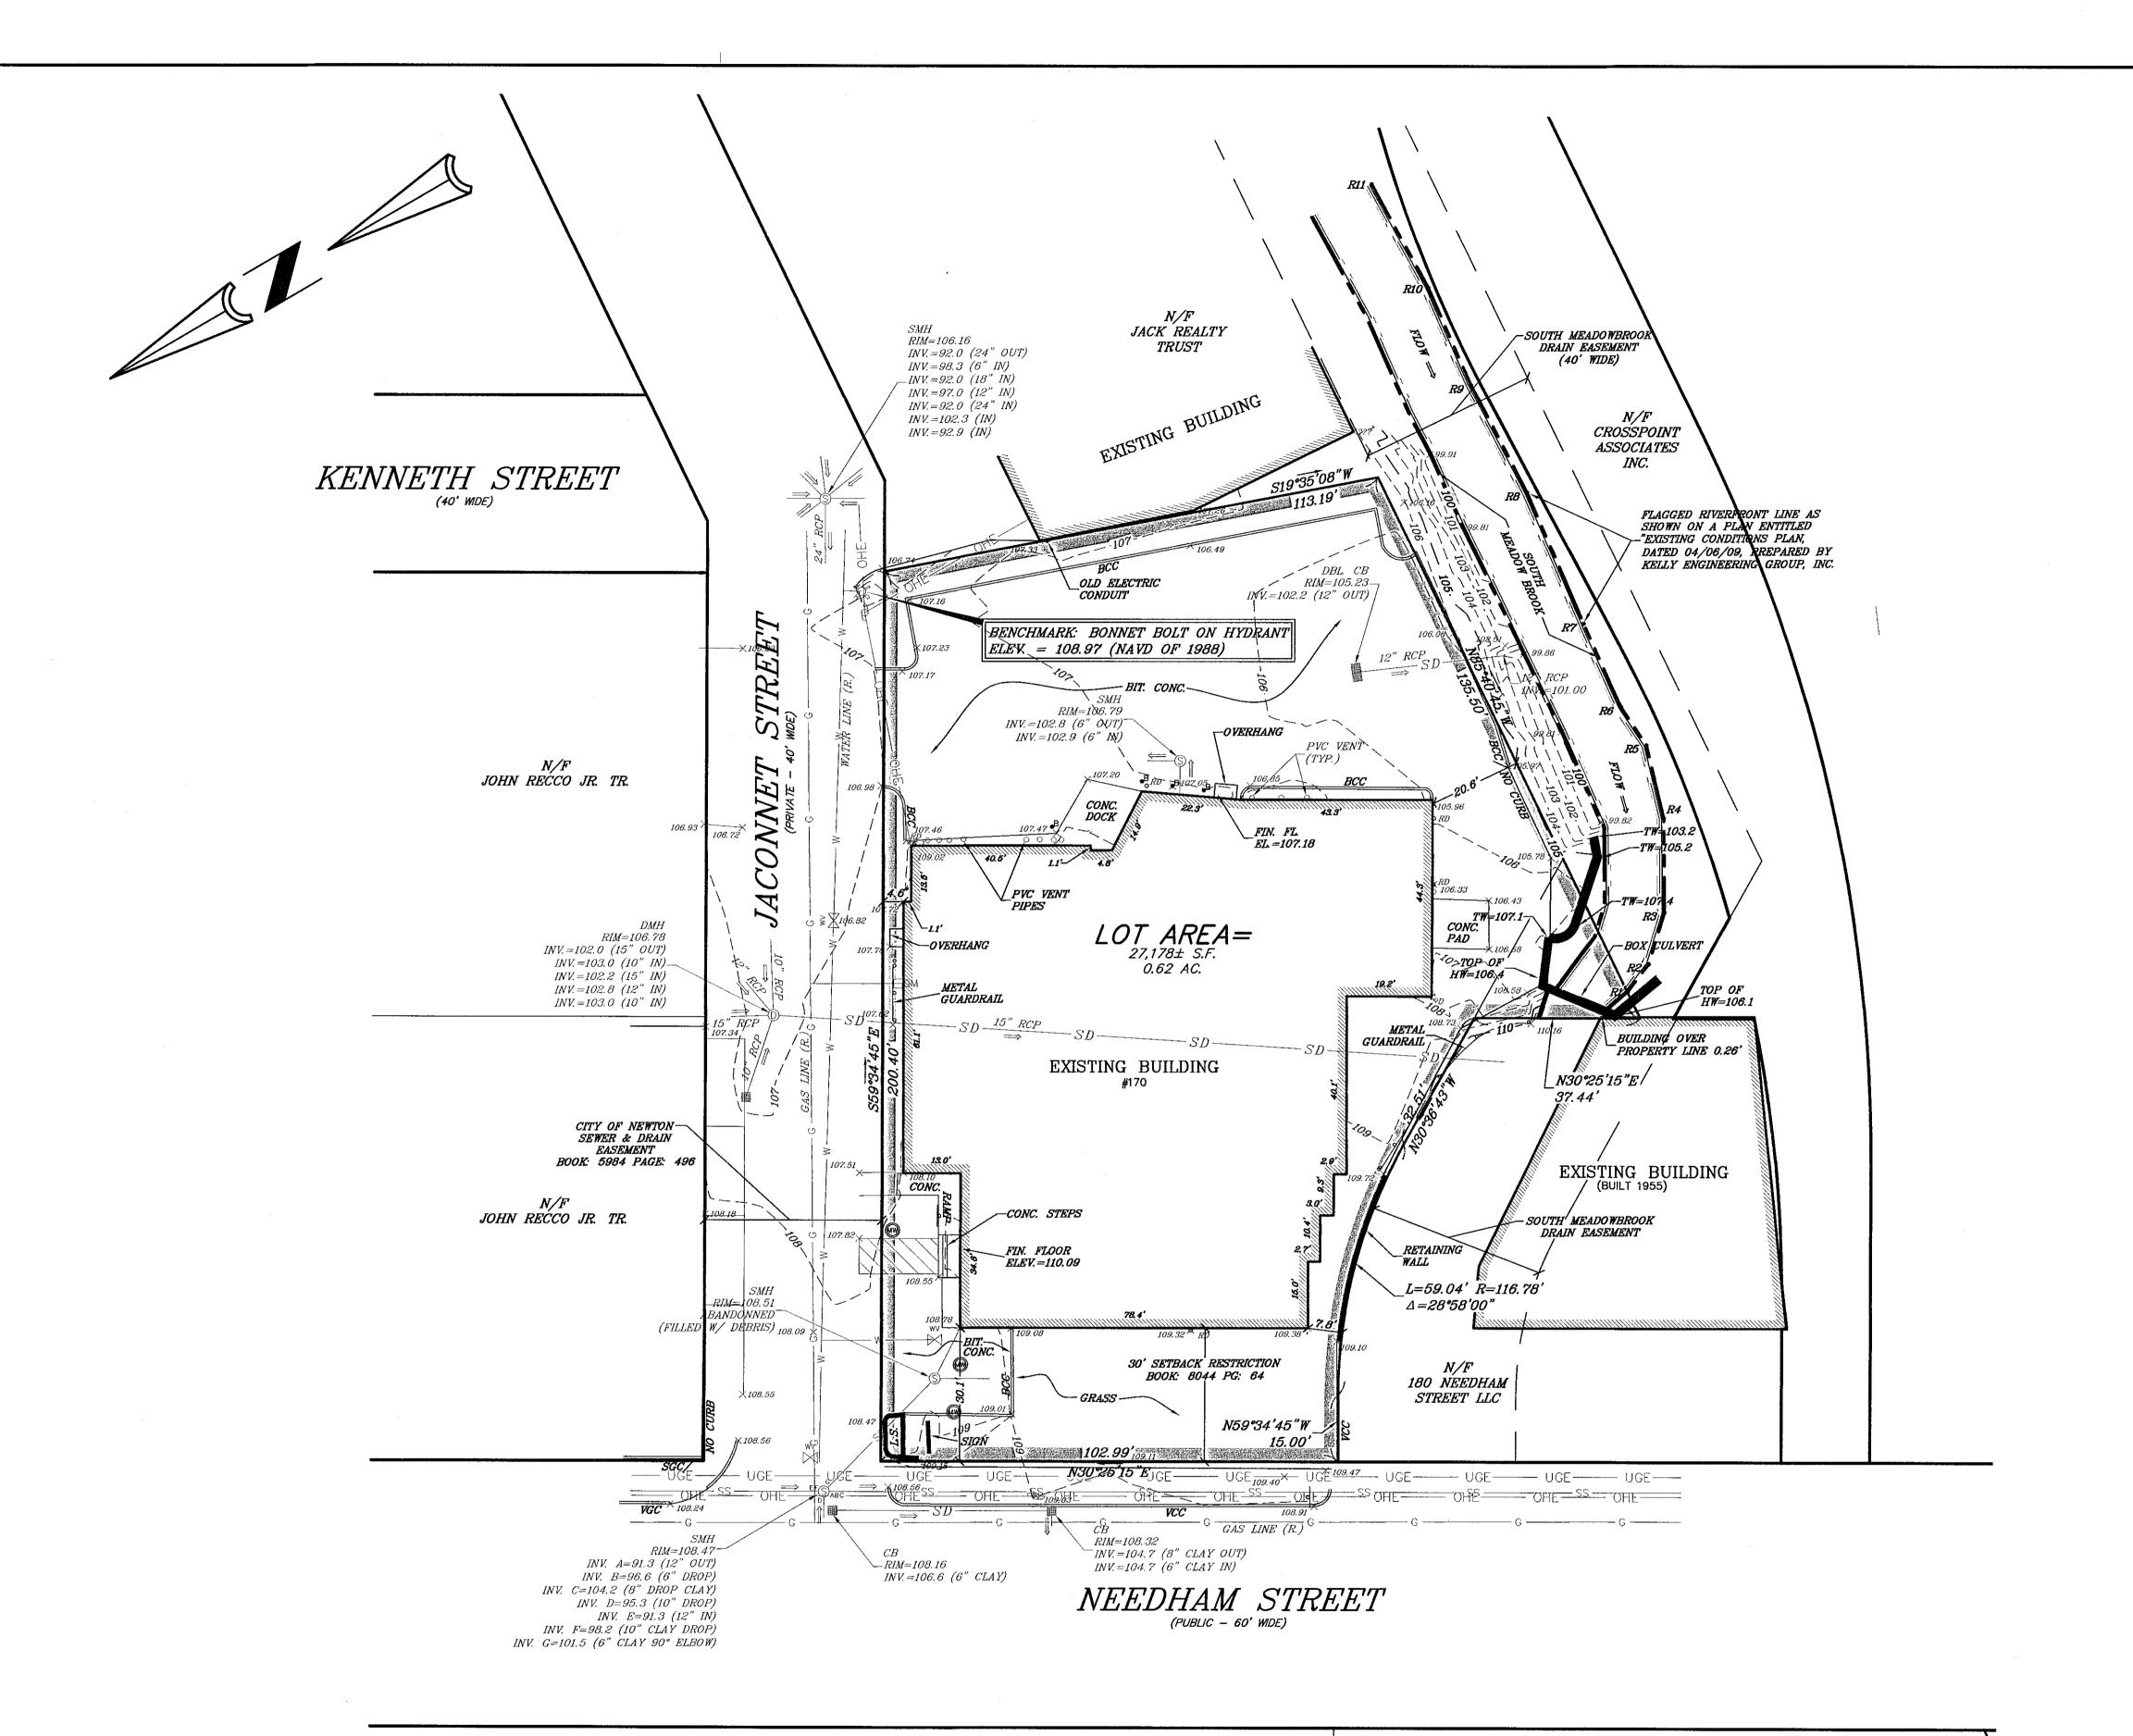

	LEGEND
	CATCH BASIN
0	DRAIN MANHOLE
SD	DRAINLINE
• RD	ROOF DRAIN
\Rightarrow	FLOW DIRECTION
<u>(S)</u>	SEWER MANHOLE
SS	SEWER LINE
₩V 	WATER VALVE
於	HYDRANT
	WATER LINE
— OHE—	OVERHEAD ELECTRIC
— UGE—	UNDERGROUND ELECTRIC
□ЕМ	ELECTRIC METER
D	UTILITY POLE
	GAS LINE
cv ⊠	GAS VALVE
□GM	GAS METER
@	TRANSFORMER
₽	BOLLARD
\$	LIGHT POLE
vcc	VERTICAL CONCRETE CURB
BCC	BITUMINOUS CONC. CURB
- 0 ''	SIGN
	- METAL GUARDRAIL
	RETAINING WALL
L.S.	LANDSCAPED
	- RIVERFRONT LINE
• <i>R3</i>	RIVERFRONT FLAG
× 105.78	SPOT ELEVATION
	- MAJOR CONTOUR
102	MINOR CONTOUR
(R.)	RECORD LOCATION

PLAN REFERENCES:

1.) SITE PLAN (SPRINKLER - WATER CONNECTION), 170 NEEDHAM STREET, NEWTON, MA, REVISED THROUGH 11/14/2001, PREPARED BY CUBELLIS SAIVETZ ASSOCIATES, BRAINTREE, MA.

2.) PLAN NO. 1415 OF 1986 RECORDED IN BOOK: 17482 PAGE: END.

3.) PLAN NO. 1144 OF 1987 RECORDED IN BOOK: 18470 PAGE: 347.

NOTES:


1.) TOPOGRAPHICAL INFORMATION SHOWN HEREON IS BASED ON A FIELD SURVEY PERFORMED BY KELLY ENGINEERING GROUP, INC. IN FEBRUARY 2013.

2.) AT THE TIME OF SURVEY, SNOW WAS PRESENT ON THE GROUND.

3.) UTILITIES SHOWN HEREON ARE APPROXIMATE ONLY AND ARE BASED UPON FIELD LOCATIONS OF VISIBLE STRUCTURES COMBINED WITH AVAILABLE RECORD INFORMATION.

4.) ELEVATIONS SHOWN HEREON ARE BASED ON NGVD DATUM OF 1929.

THE ELEVATION WAS DETERMINED USING ELEVATION REFERENCE MARK "RM 15"...
("NORTH NUT OF HYDRANT NEAR POLE 85 ON SOUTH SIDE JACONNETT STREET,
OPPOSITE INTERSECTION OF KENNETH STREET"), AS SHOWN OF FLOOD INSURANCE
RATE MAP, FOR THE CITY OF NEWTON, MA, DATED JUNE 4, 1990,
COMMUNITY—PANEL NUMBER 250208 0004 D.

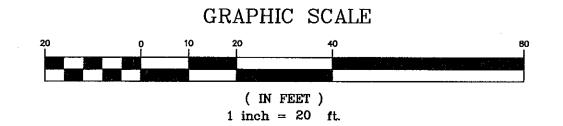

CELLY ENGINEERING GROUP SHALL NOT BE RESPONSIBLE FOR CONSTRUCTION MEANS, METHODS, TECHNIQUES, OR PROCEDURES UTILIZED BY THE CONTRACTOR NOR FOR THE SAFETY OF PUBLIC OR CONTRACTOR'S EMPLOYEES, OR FOR THE FAILURE OF THE CONTRACTOR TO CARRY OUT THE WORKING ACCORDANCE WITH THE CONTRACT DOCUMENTS.

THE EXTENT OF KELLY ENGINEERING GROUPS LIABILITY FOR THIS PLAN IS LIMITED TO THE EXTENT OF ITS FEE LESS THIRD PARTY COST

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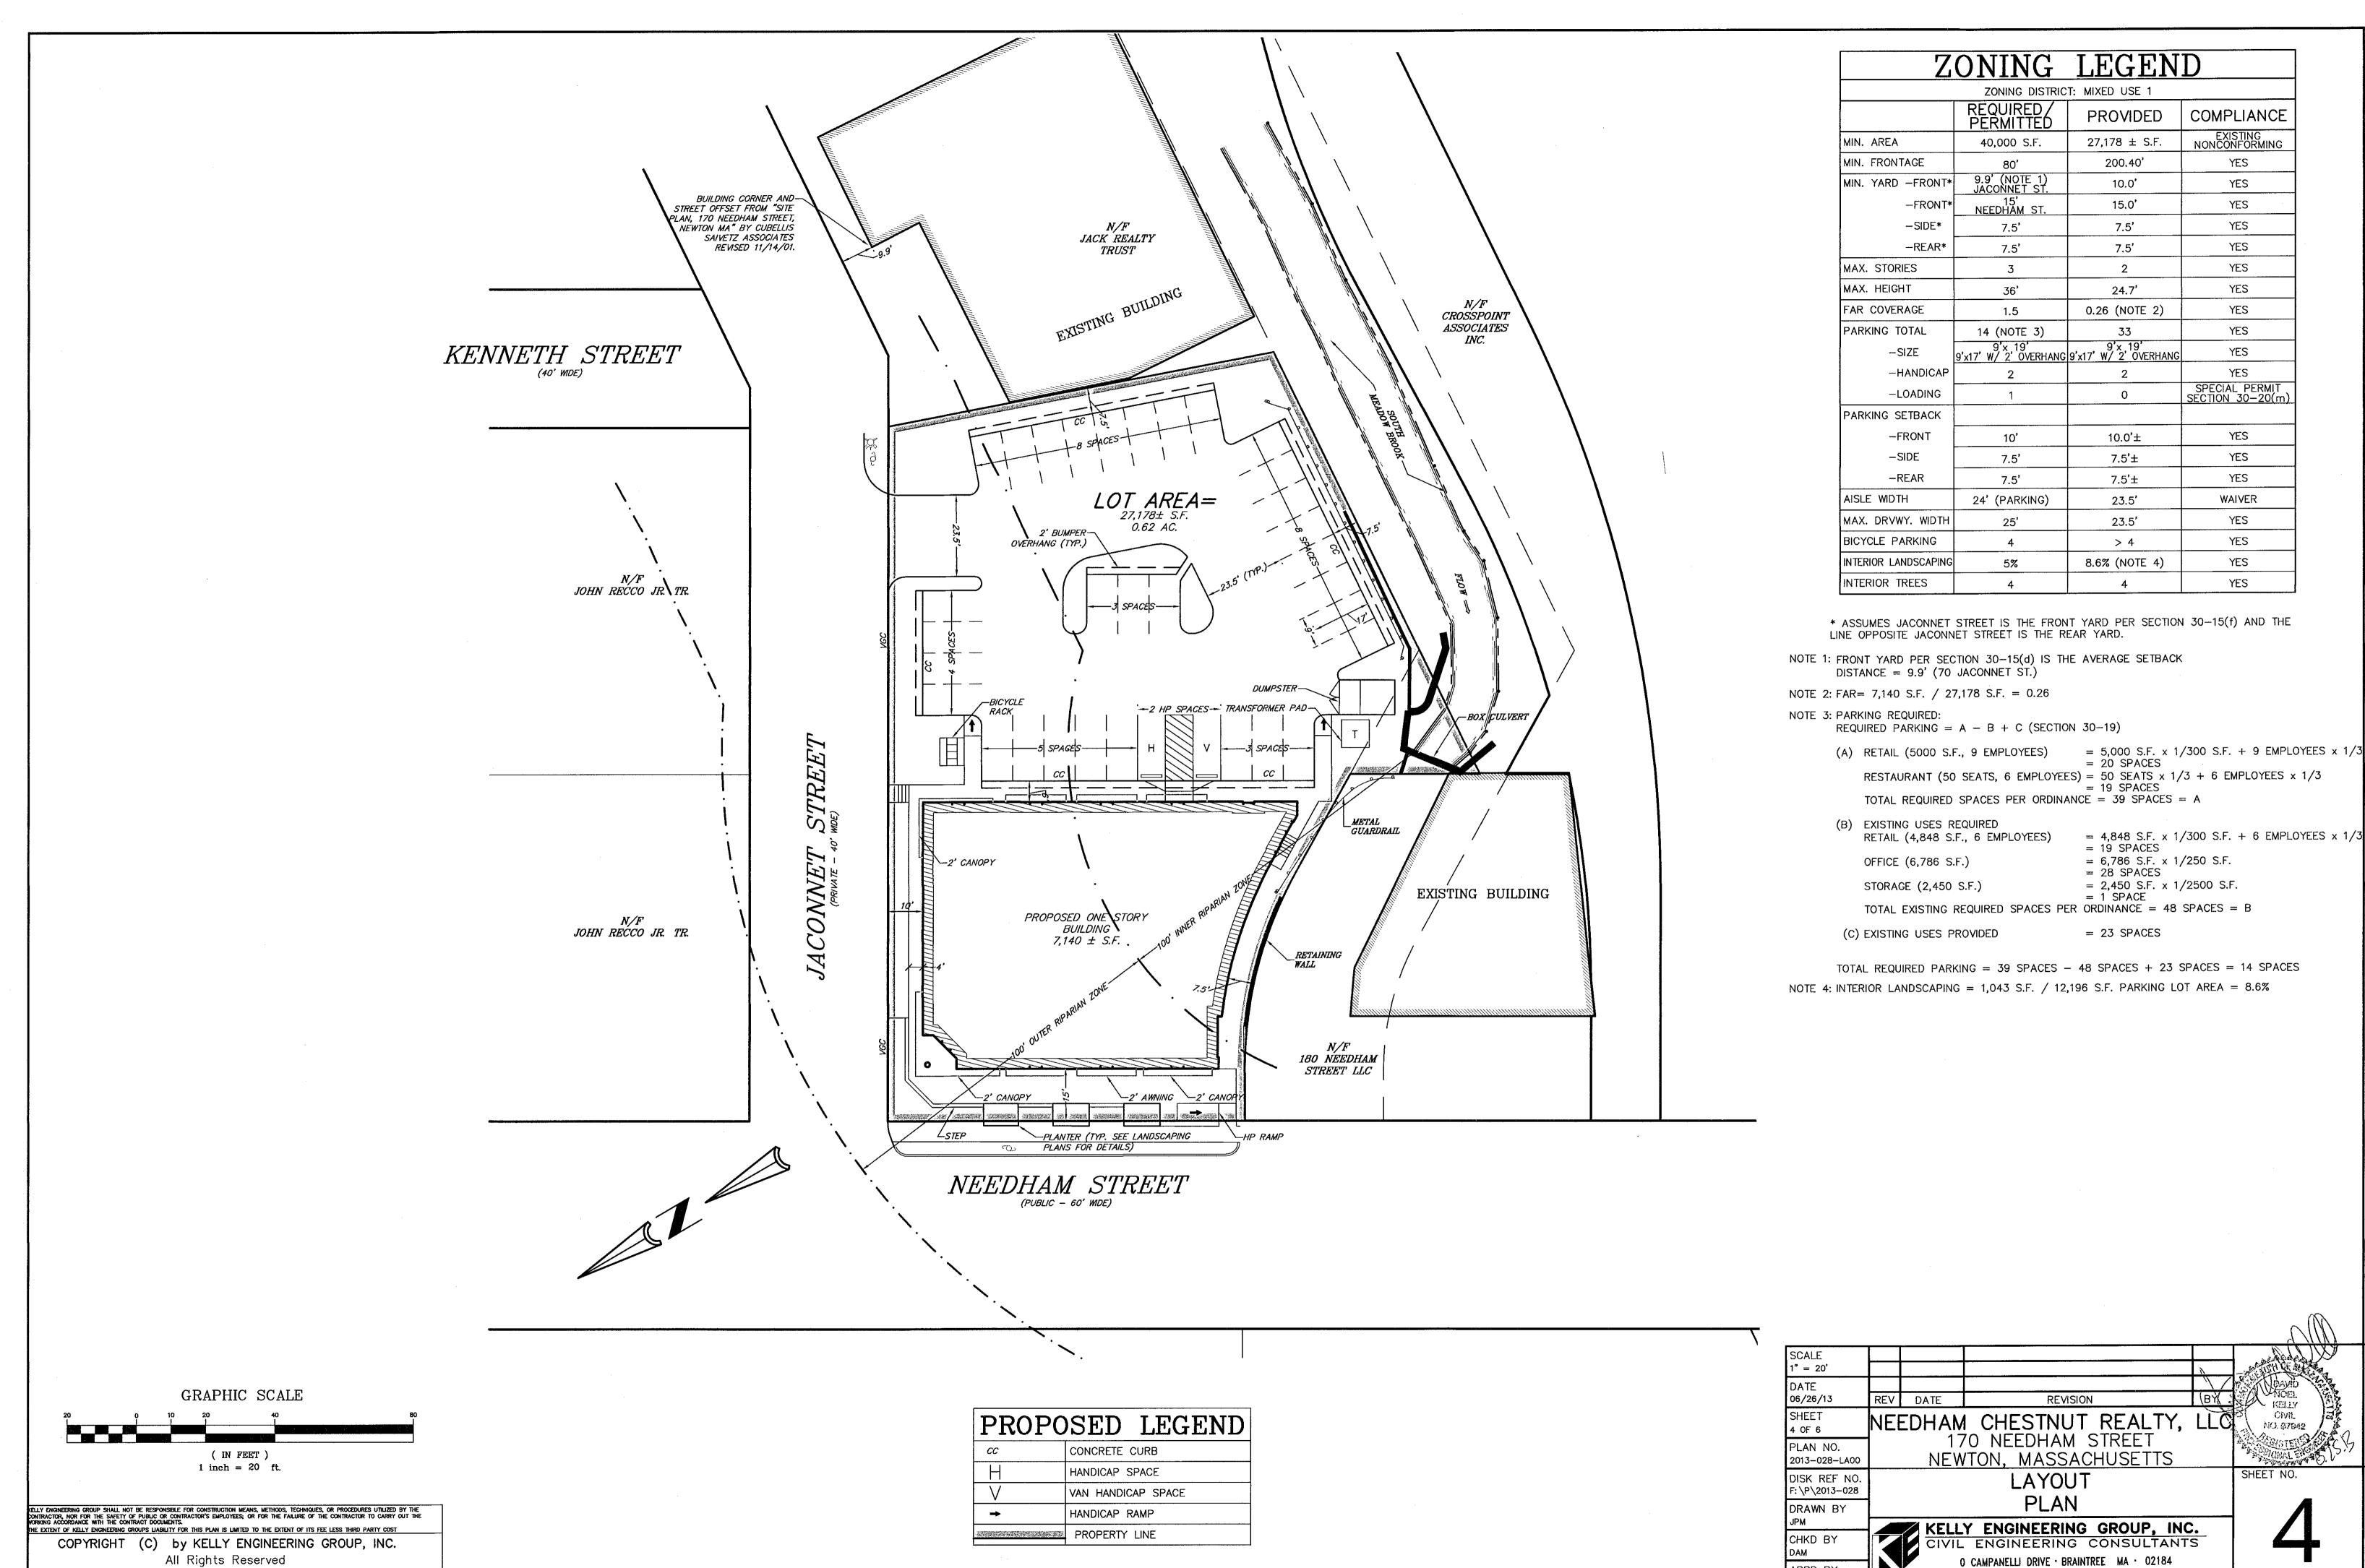
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SCALE STH OF MASS 1'' = 20'STEVEN DATE 06/26/13 HORSFALL REV DATE BY REVISION NEEDHAM CHESTNUT REALTY, LLC 170 NEEDHAM STREET 3 OF 6 PLAN NO. NEWTON, MASSACHUSETTS 2013-028-SU00 EXISTING CONDITIONS SHEET NO. DISK REF NO. F: \P\2013-028 PLAN DRAWN BY KELLY ENGINEERING GROUP, INC. CIVIL ENGINEERING CONSULTANTS O CAMPANELLI DRIVE · BRAINTREE MA · 02184 APPD BY

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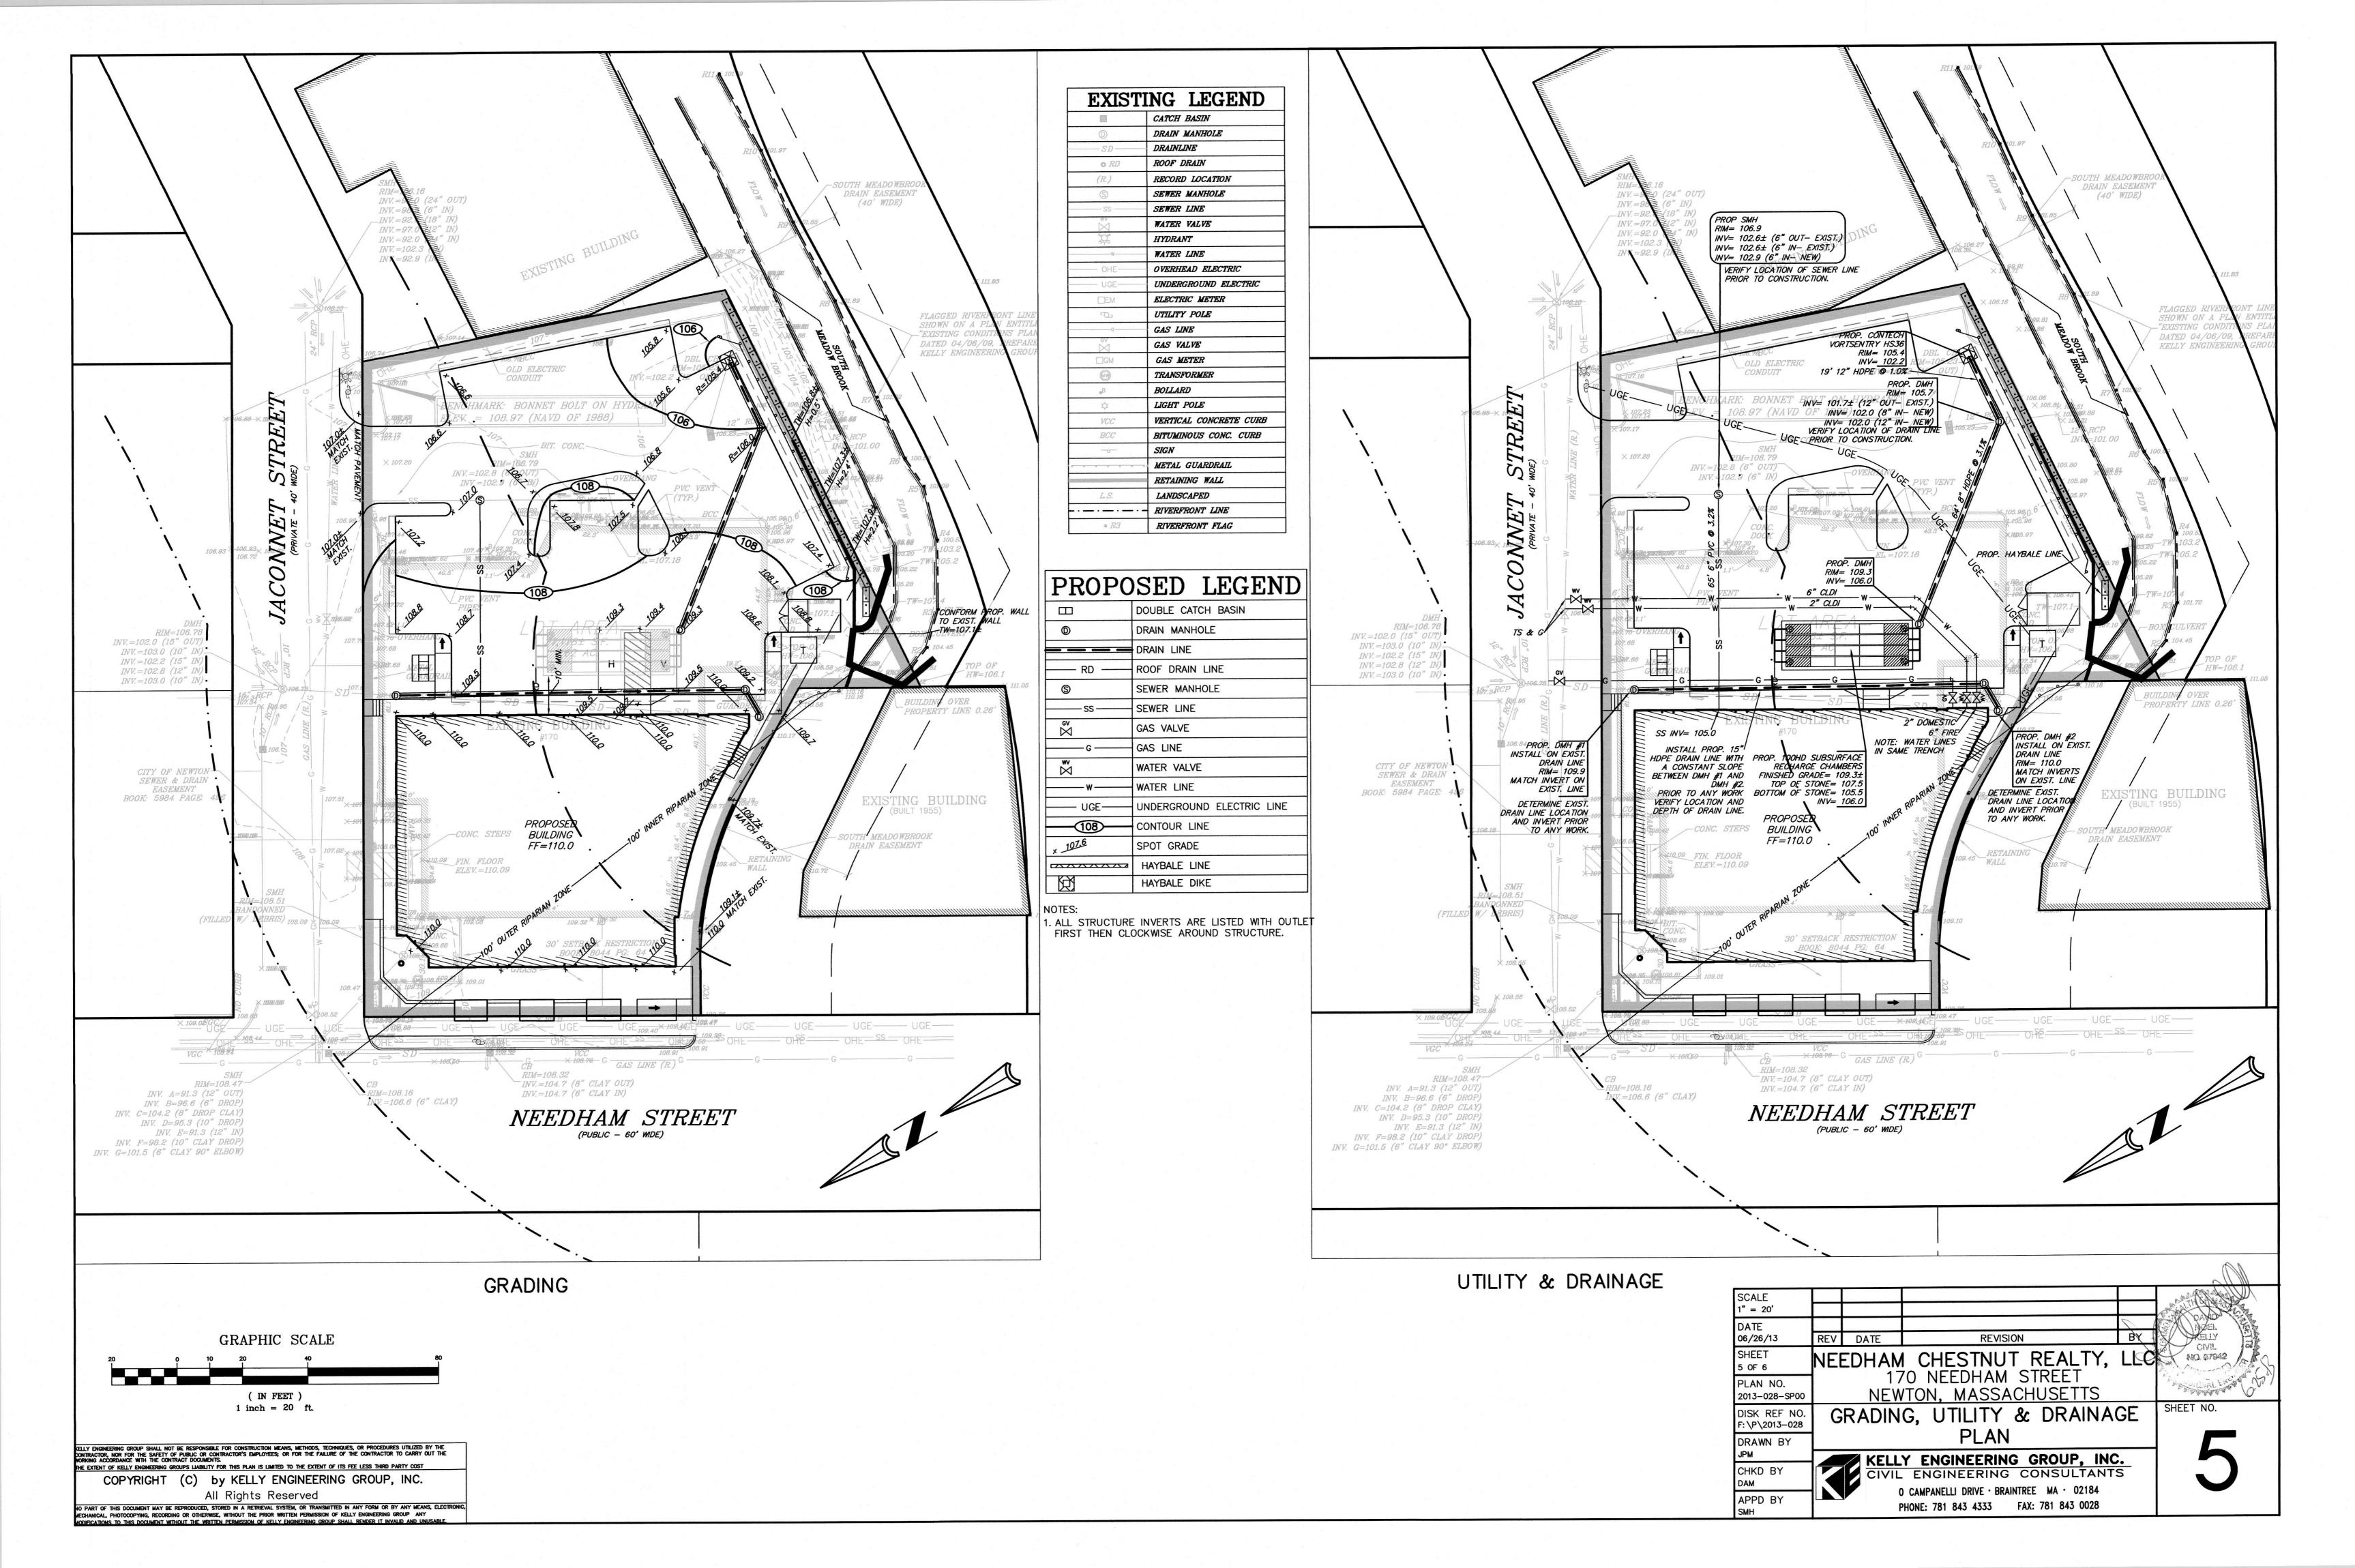



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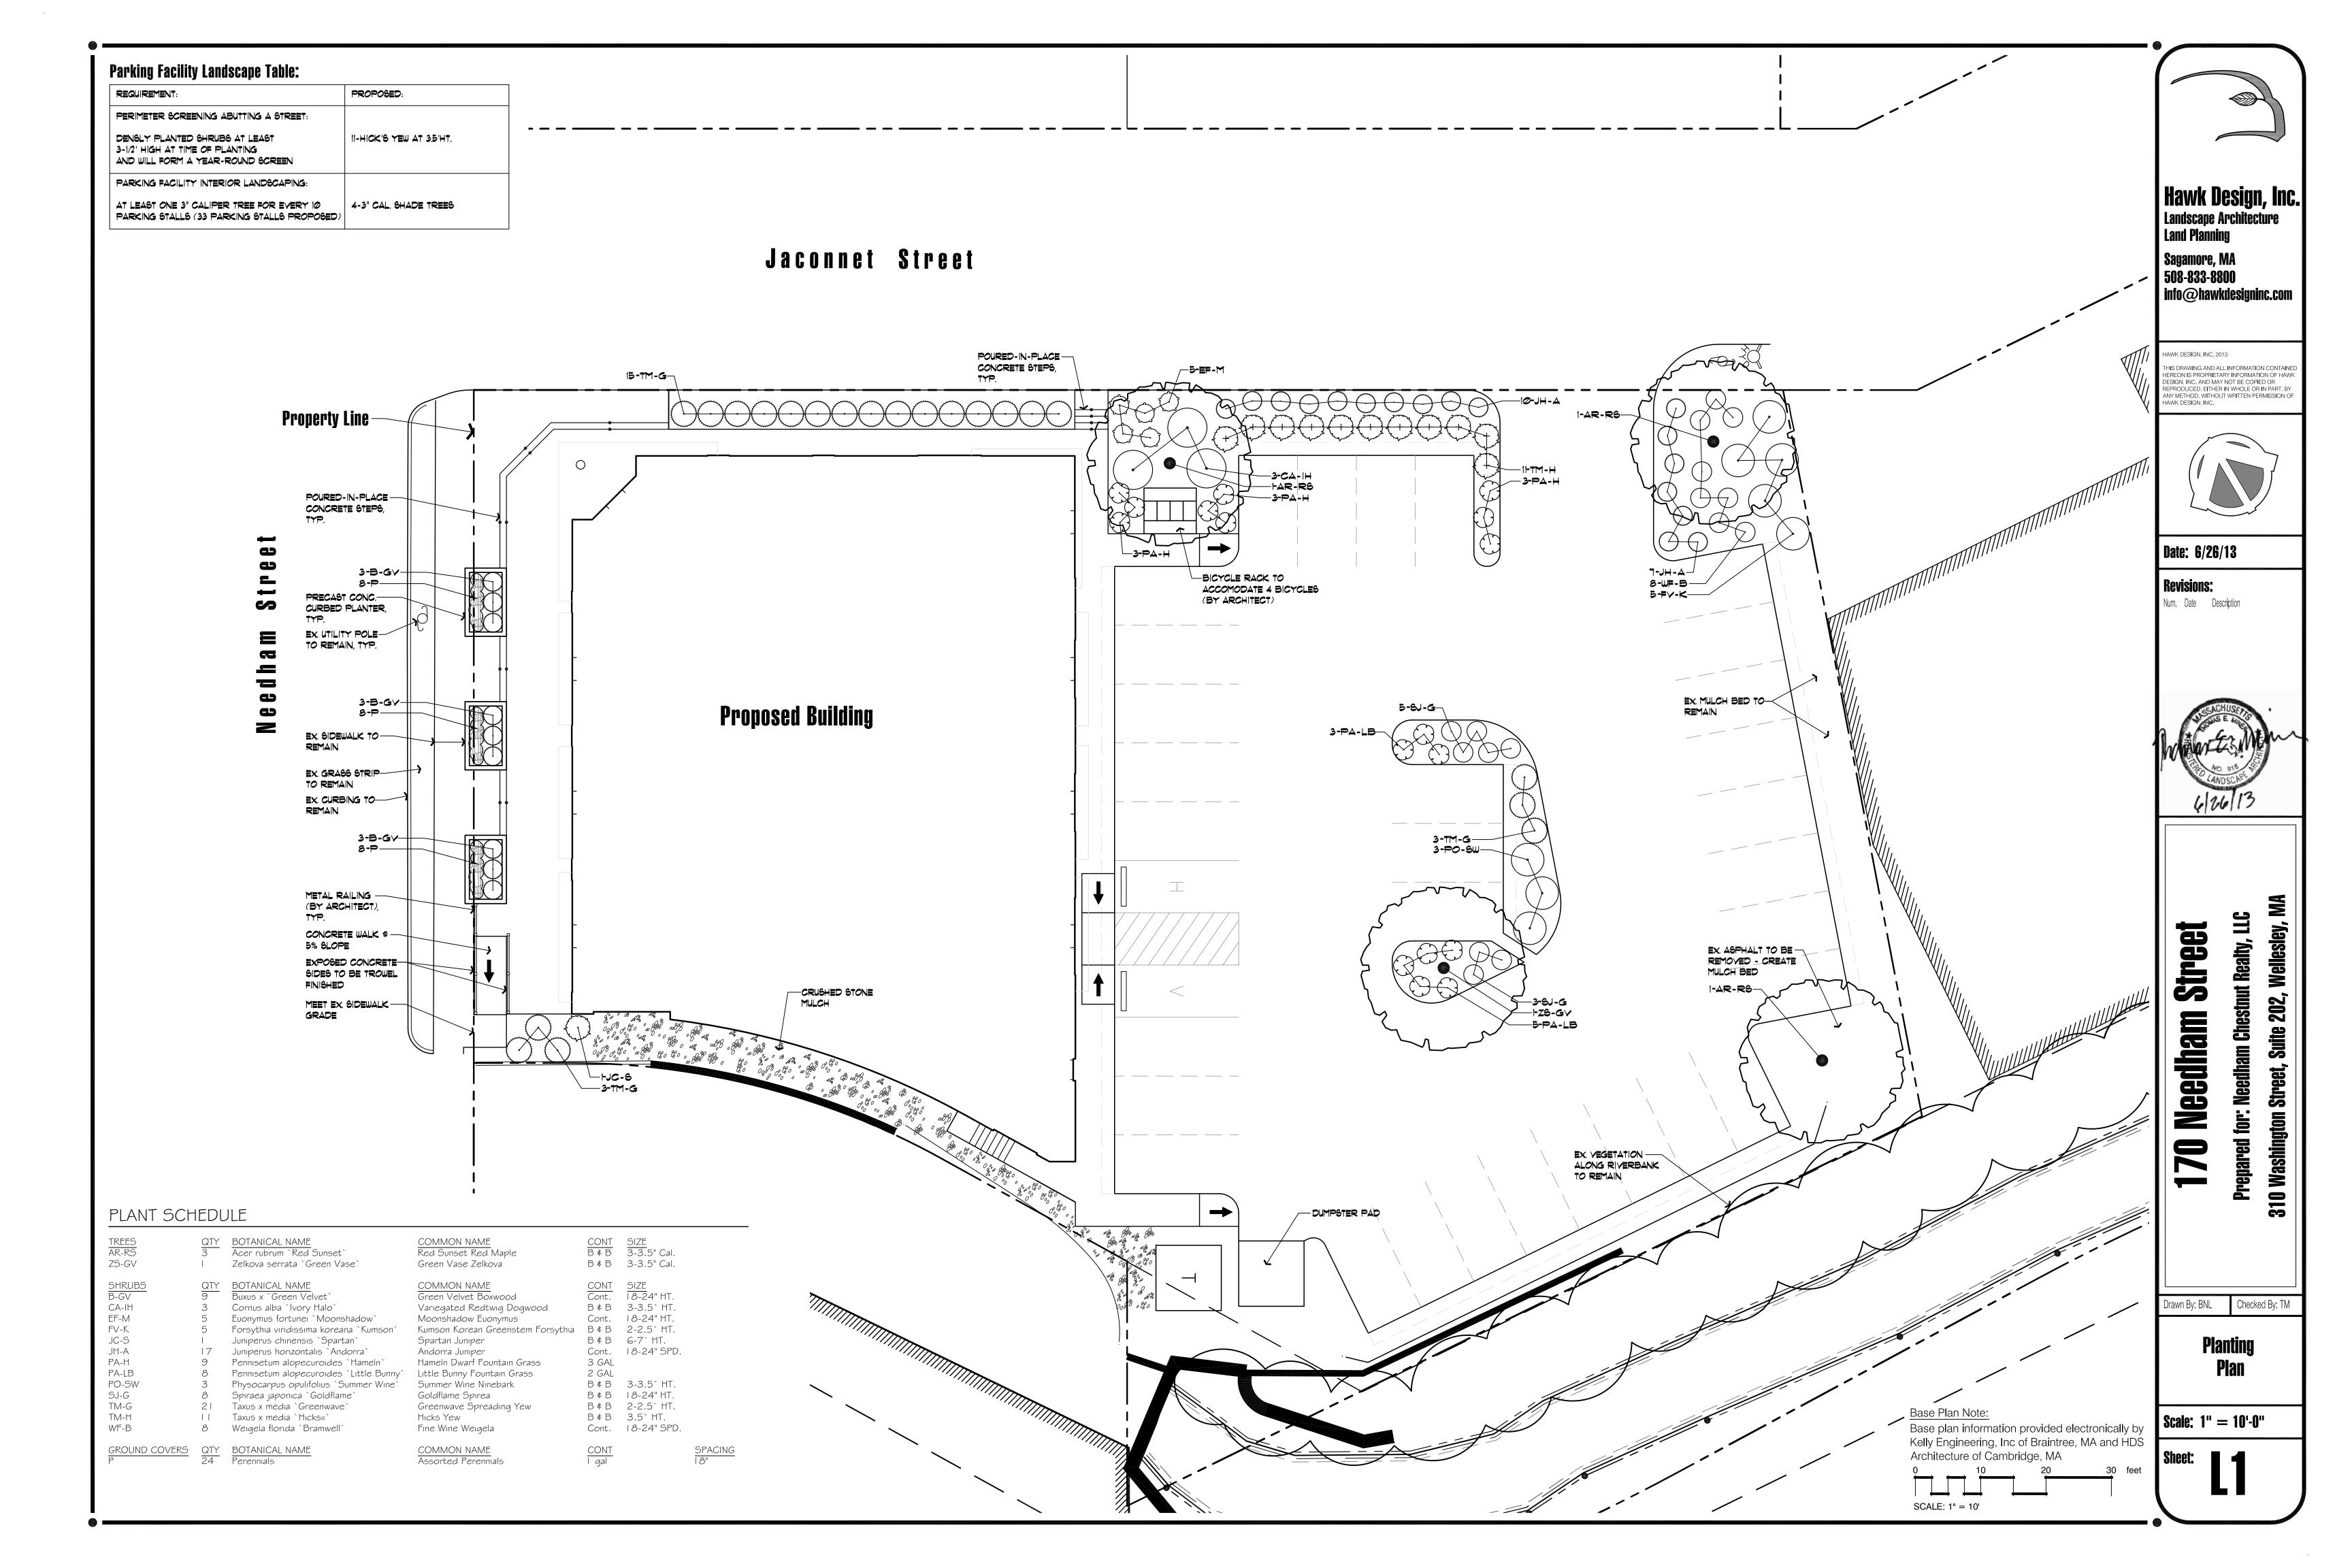
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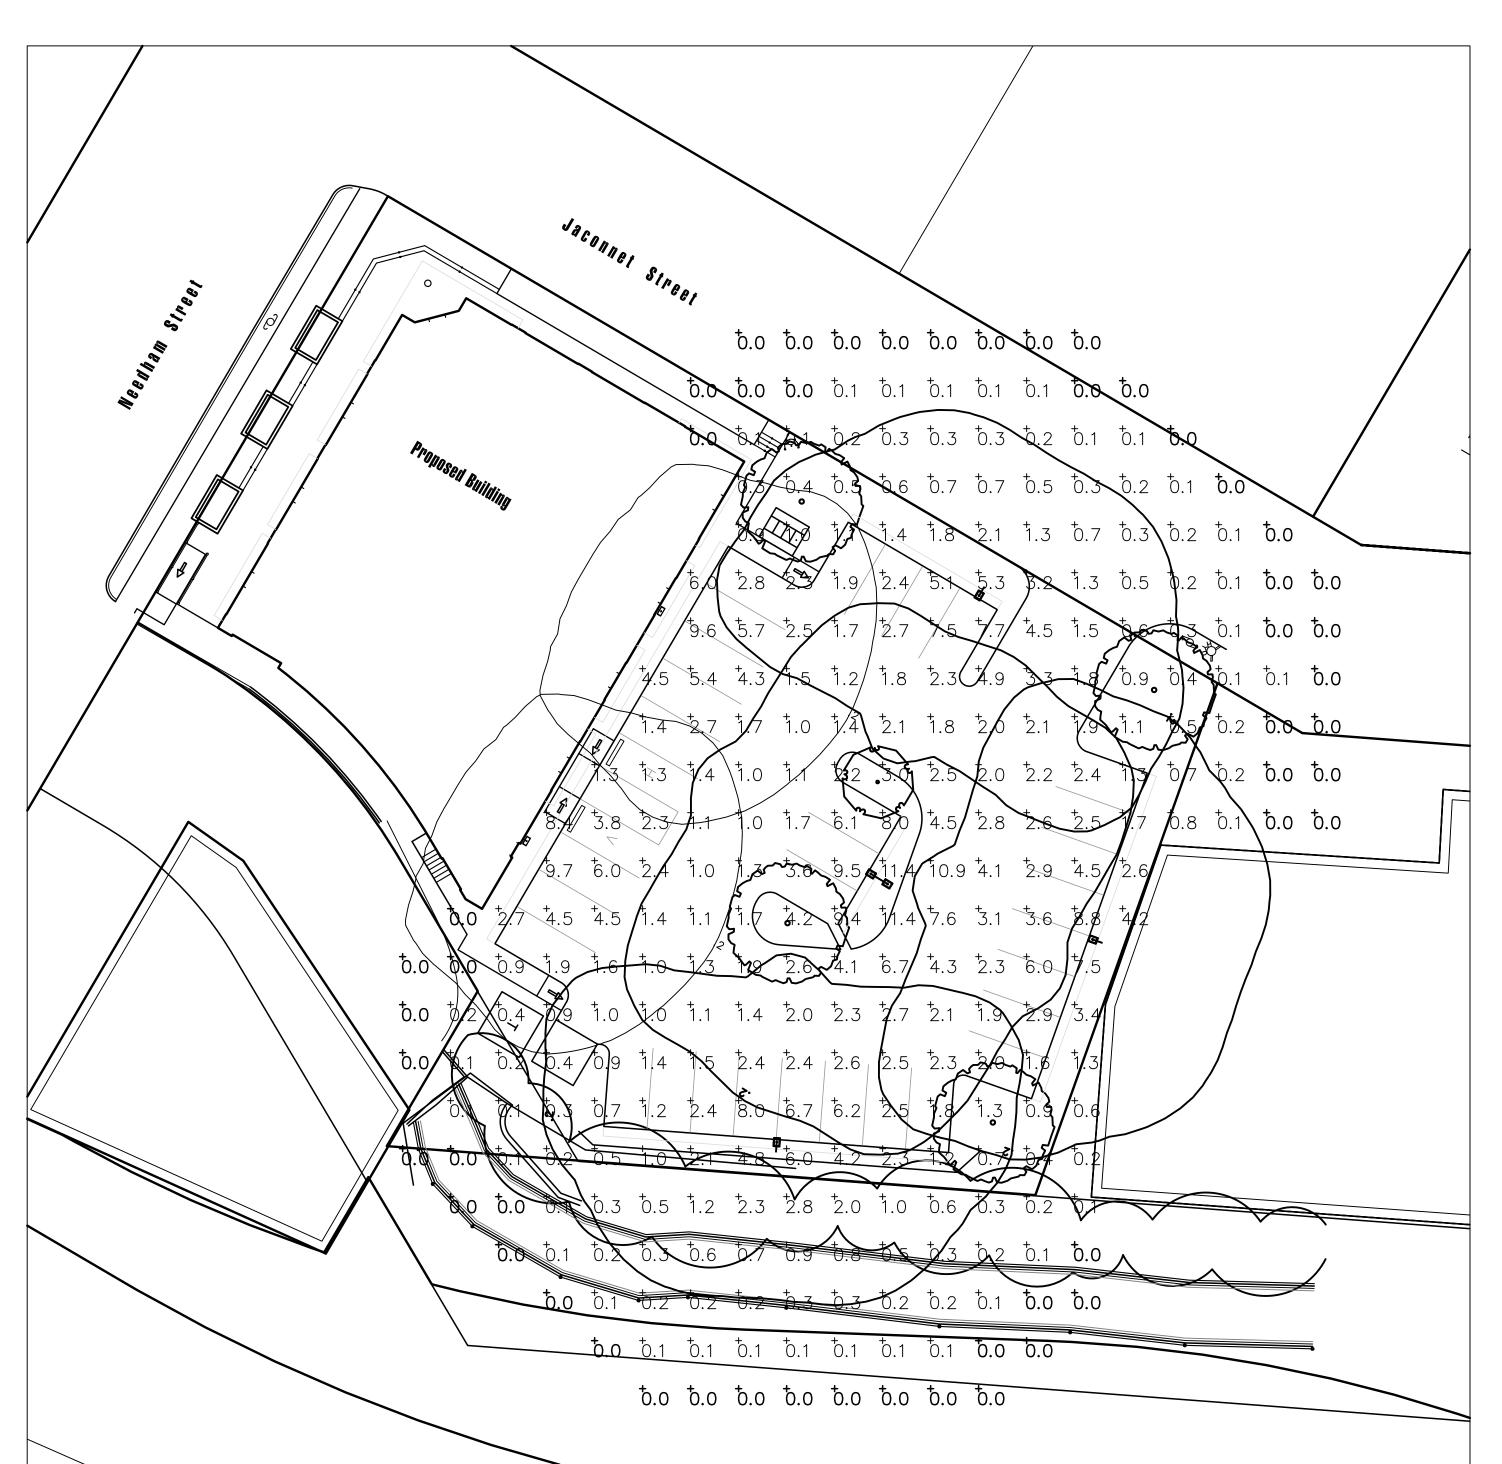
APPD BY

PAND NOEL KELLY CIVIL NO. 87842







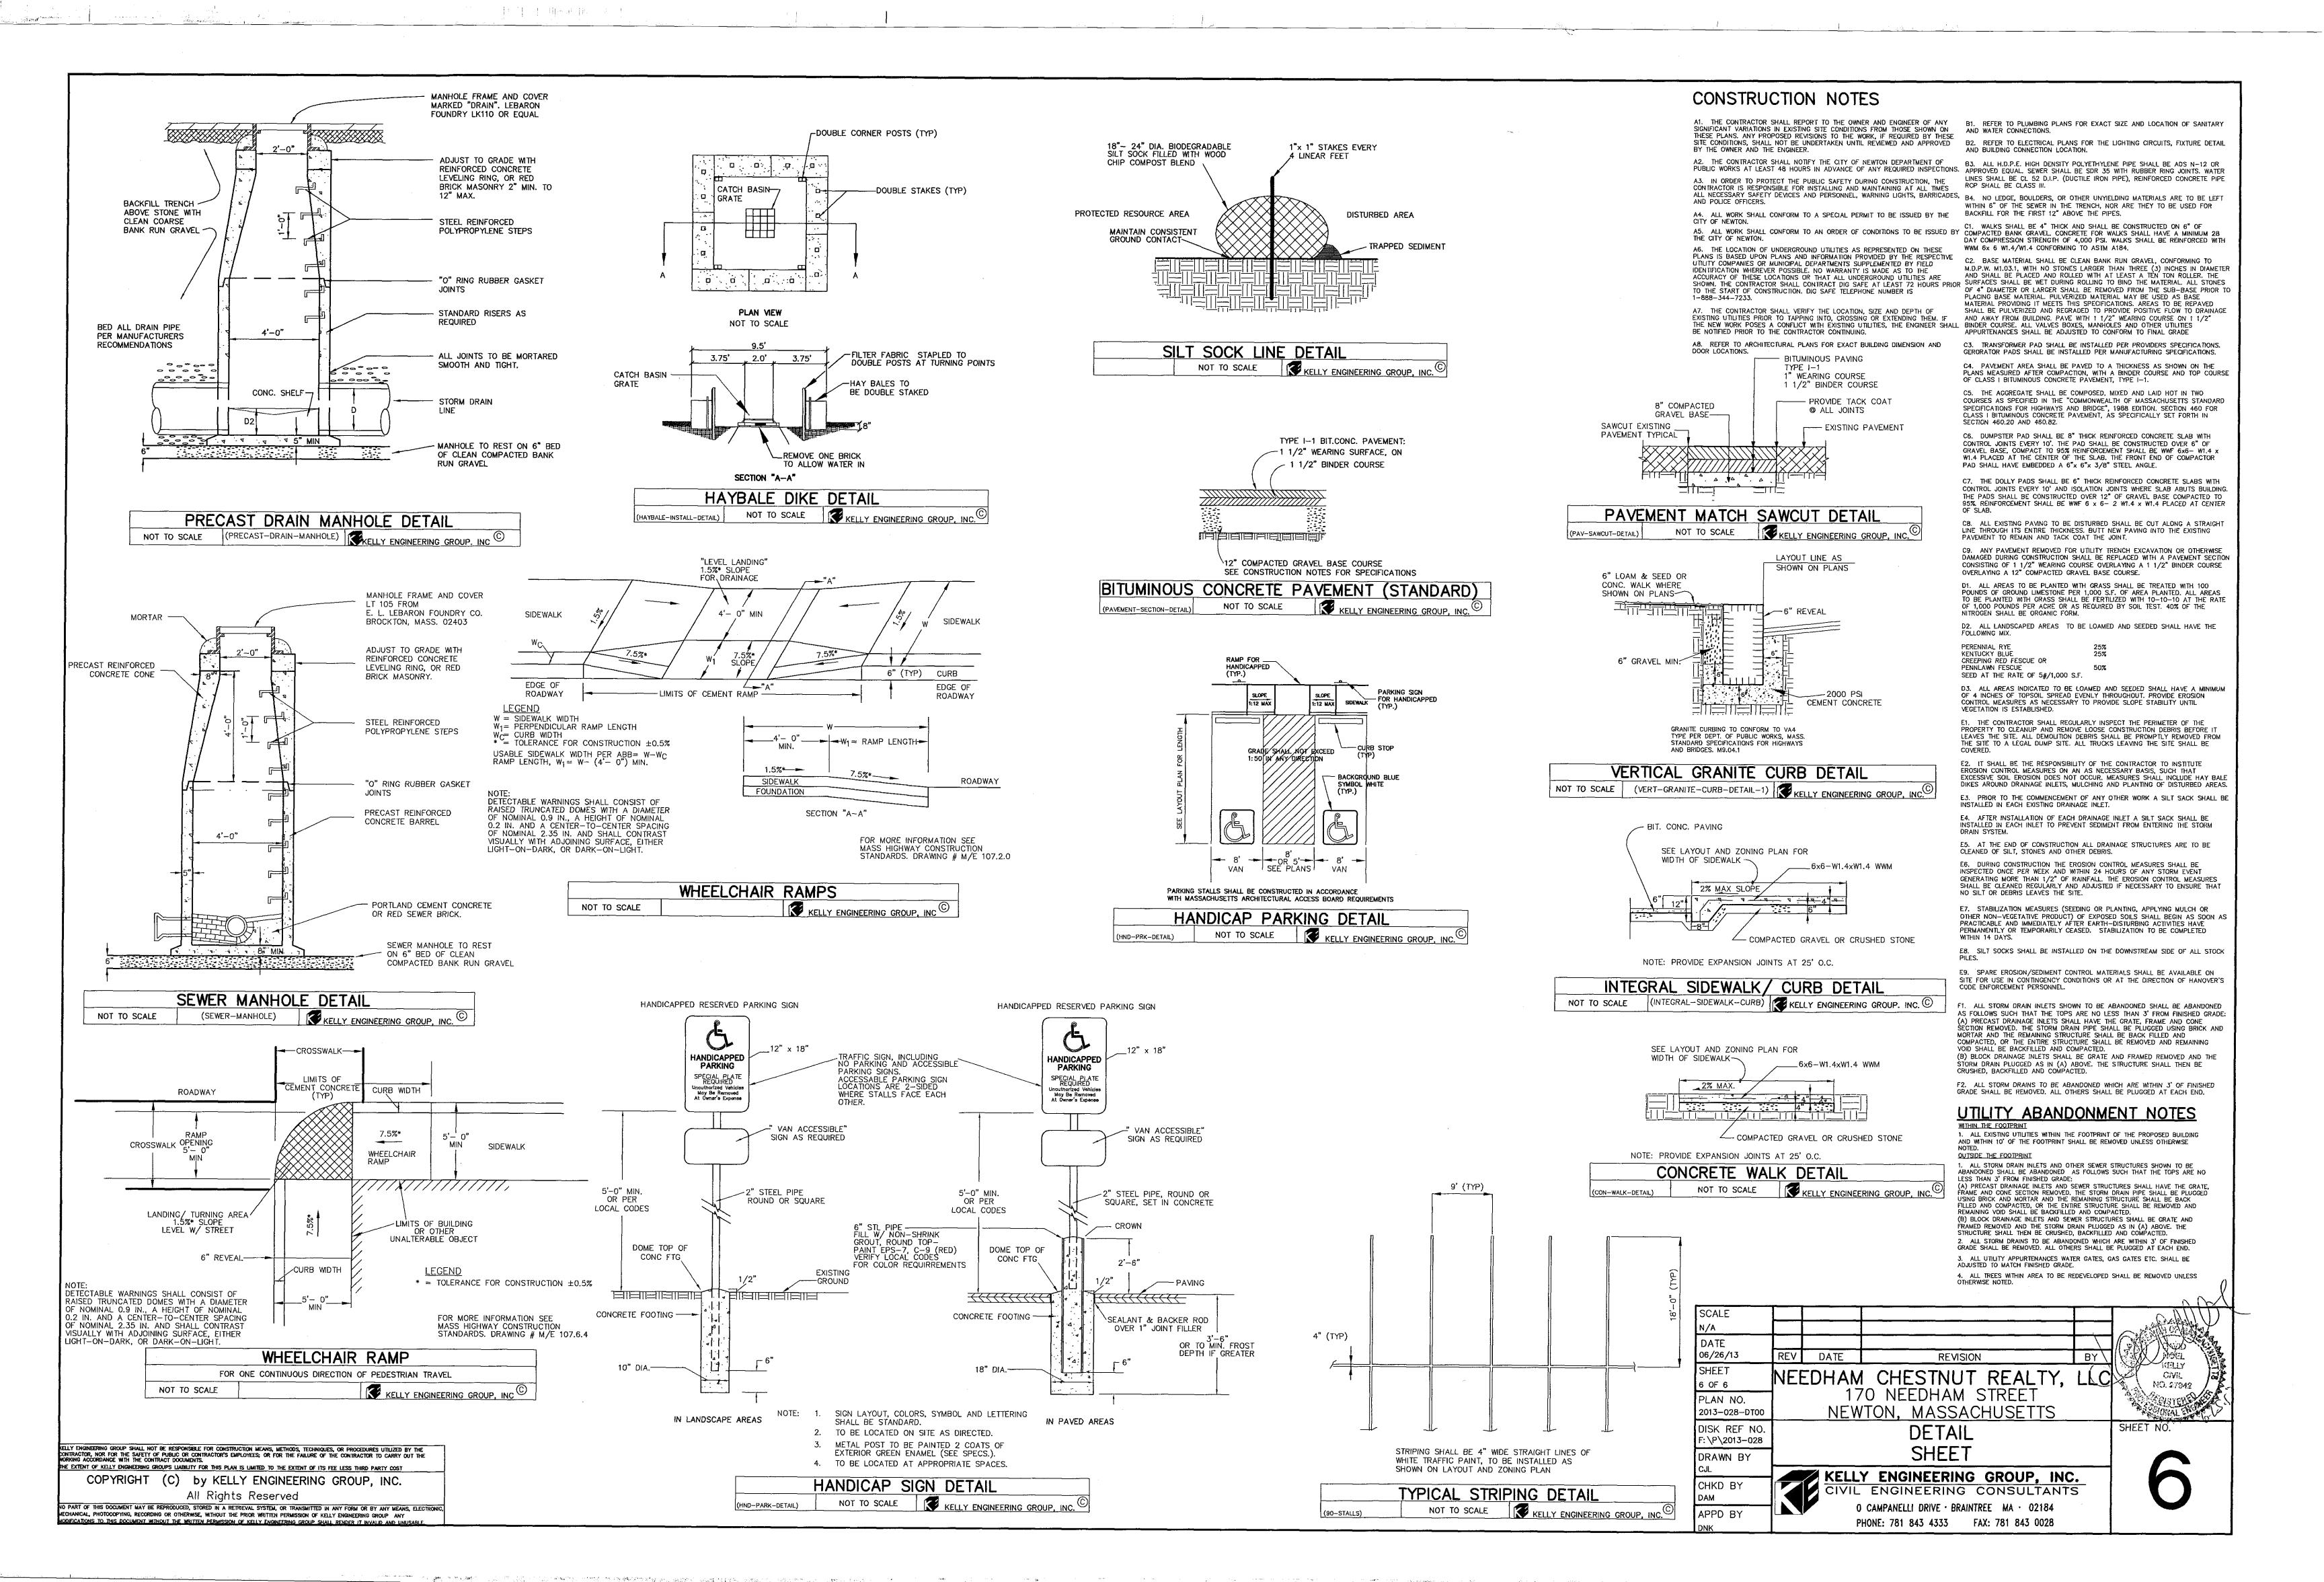

Luminaire Schedule								
Symbol	Qty	Label	Arrangement	Lumens	Watts	LLF	BUG Rating	Description
+	2	А	SINGLE	13000	150	0.830	B3-U0-G1	Hadco PW2, 150w MH, Forward Throw, 15ft Mtg Ht
-	3	В	SINGLE	13000	150	0.830	B3-U1-G3	Hadco PA2, 150w MH, Type III, 15ft Pole
	1	С	BACK-BACK	26000	300	0.830	B3-U1-G3	Hadco PA2, 150w MH, Type III, 15ft Pole

Calculation Sum	ımary							
Label	CalcType	Units	Avg	Max	Min	Avg/Min	Max/Min	Description
Parking Lot	Illuminance	Fc	3.34	11.40	1.00	3.34	11.40	10ft Grid



Profiler (small) (PA2) Specification Sheet

Fixture Type:	Catalog No.:		Qt	y:	
		Ordering G	uide		
1		Example: PA	2 AT	3 A 2 70S E N	
		Product Code	PA2	Profiler (small)	
		Arm	AT C HT S	Adjustable Arm Curved Arm Horizontal Slip Fitter Straight Arm	** ** **
		Mounting	3 4 5 6 8 W	3" O.D. Round Pale 4" O.D. Round Pale 5" O.D. Round Pale 6" O.D. Round Pale Square Pale Wall Mount	-2
Height: 6"(15cm)		Finish	A B H	Black White Bronze Gray	
Width: 30 7/8" (78cm)		Optics	2 3 5	Type III Type III Type V	
Max. IEPA: PA2S: 0.94 sq. ft.		Wattage	F 706	Forward Throw 70W HPS	
Max. IEPA: PA2C: 1.10 sq. ft. Max. Weight: 38 lbs		wanage	1008 1508 50H 70H 100H 150H	100W HPS 150W HPS 50W MH 70W MH 100W MH 150W PMH	-3
		Voltage	EFGIKJ	120°V 208°V 240°V 277°V 347°V 480°V	
		Options	ZABLGIGE>	None Air Fitter Button Bye Photo Control Fusing Polycarbonate Shield House-Side Shield Quartz Restrike Twist-lock Photo Control Receptacle Vandal Resistant Latch	*3 *4 *5

MFG: Philips Hadco

*1 Do not specify "Mounting" option with these arms.

*5 Quartz Restrike option is not available in 480V. *6 Order pole machined for this fixture.

*2 Available with Straight Arm (S) only.
*3 Not available in 480V (J).
*4 Not available with Type V (5) or Forward Throw (F) optics

Base Plan Note:

SCALE: 1" = 20'

Base plan information provided electronically by Kelly Engineering, Inc of Braintree, MA and HDS

Architecture of Cambridge, MA


Specifications

360 low-copper die-cast alluminum alloy. Tool-less lamp access. Hinged lens frame is cast alluminum with stainless steel spring latch for tool-less lamp access. A weatherproof ballast assembly isolates the ballast from water and heat for longer life. The optional photo control eye or twist-lock receptable is located in the ballast enclosure for easy access via a removable cloor. All non-ferrous fasteners prevent corrosion and ensure longer life.

Thermoset polyester powdercoat is electrostatically applied after a five-stage conversion cleaning process and bonded by heat fusion thermosetting. Laboratory tested for superior weatherability and fade resistance in accordance with ASTM B117 specifications. For larger projects where a custom color is required, contact the factory for more information.

Note: Philips reserves the right to modify the above details to reflect changes in the cost of materials and/or production and/or design without prior notice. 100 Craftway Drive, Littlestown, PA 17340 | P: +1-717-359-7131 F: +1-717-359-9289 | http://www.lhadco.com/ | Copyright 2013 Philips

Wall Mount Flood Light (PW2) Specification Sheet

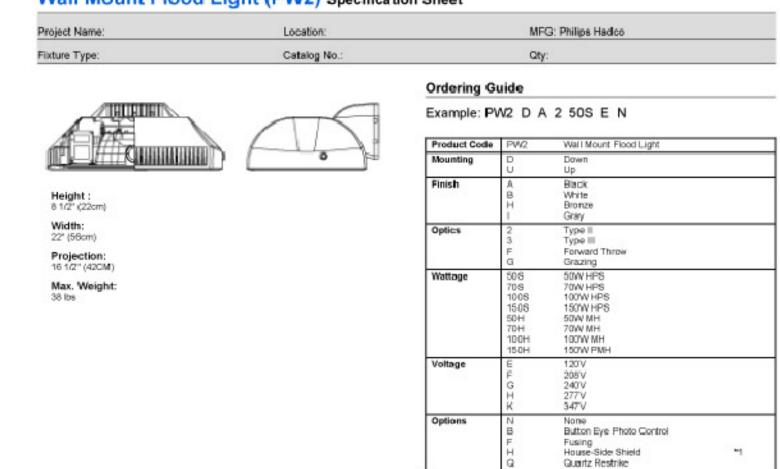

Specifications

360 low-copper die-cast aluminum alloy. Easy access to lamp. The lens frame assembly incurts to the housing via four (4) captive W*-20 stainless steel screws and two (2) galvanized steel thinges. The optional photo control eye is located in the ballast enclosure for easy access. A weatherproof ballast assembly isolates the ballast from water and heat for longer life. All non-ferrous fasteners prevent corrosion and ensure longer life.

*1 Not available with Forward Throw (F) or Grazing (G) optics

Thermoset polyester powdercoat is electrostatically applied after a five-stage conversion cleaning process and bonded by heat fusion thermosetting. Laboratory tested for superior weatherability and fade resistance in accordance with ASTM B117 specifications. For larger projects where a custom color is required, contact the factory for more

OPTICAL ASSEMBLY:
Type II Gutoff. Type III Gutoff. Forward Throw. Grazing. Precision formed, segmented specular aluminum internal outoff reflector with horizontal lamp mounting. Reflector is rotatable in 90° increments. Sealed optical chamber. Interchangeable reflectors. Glear tempered flat glassiens.

MH and HPS Medium base: E17.

ELECTRICAL ASSEMBLY: Ballast assembles are mounted to an aluminum plate or spinning, which is mounted inside the ballast housing. 4kv rated porcelain mini-can base. Nickel-plated screw shell with

All HID ballasts are core and coil and regulated with power factors better than 90% (HPF). Ballast provides +/- 5% lamp power regulation with +/- 10% input voltage regulation. Ballasts are factory pre-wired and tested. Metal halide ballasts are capable of starting at -20° F or -30° C and HPS at -40°F or -40°C. NOTE: All ballasts are EISA // Title 20 / Title 24 compliant where applicable.

MOUNTING:

Note: Philips reserves the right to modify the above details to reflect changes in the cost of materials and/or production and/or design without prior notice.

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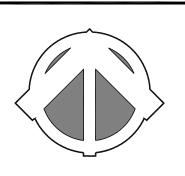
	Date:	Project ID#	REV:	Issued By:	Program:	JOB NAME:
100 Craftway P.O. Bo Littlestown, PA 17340	06/25/2013	130624-21-80	В	PMD	AGI32 -V2.04 REV01	170 Needham St
Phone: 717-359-7131 Fax: 717-359-9515	Contact:		770 000	^		Application Report
www.hadco.com	Robert S	Stacey — Hurry Associates -	- 339.200	J. 83 / /		



Hawk Design, Inc. **Landscape Architecture Land Planning** Sagamore, MA 508-833-8800

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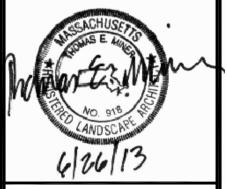


Date: 6/26/13

HAWK DESIGN, INC.

Revisions: Num. Date Description






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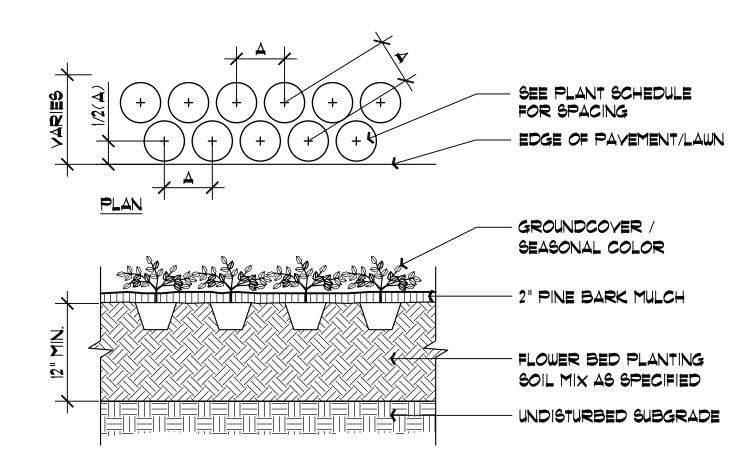
Needham 310 Washington

Drawn By: BNL Checked By: TM

Scale: 1" = 20'-0"

PHILIPS HADCO




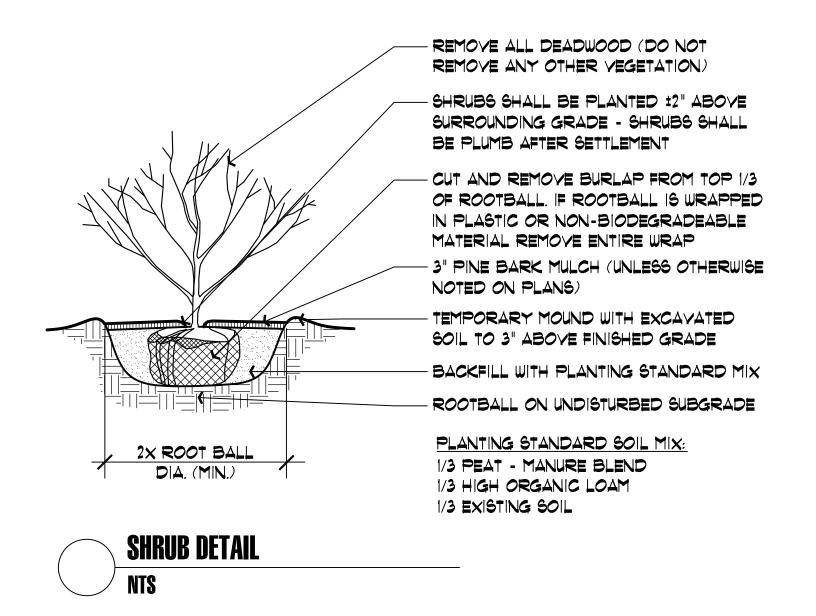


SEASONAL COLOR / PERENNIAL / GROUNDCOVER PLANTING

SCHEDULE OF TOPSOILS & ADDITIVES

LOCATION	DEPTH	DESCRIPTION
GENERAL PLANTING BEDS	12"	1/3 PEAT - MANURE BLEND 1/3 HIGH ORGANIC LOAM 1/3 EXISTING SOIL
FLOWER BEDS	12"	SCREENED LOAM 1/3 PEAT - MANURE BLEND LIME - PELATIZED OR GROUND (50 LB. PER 100 SF.) GROUND BONE MEAL (50 LB. PER 100 SF.) 10-10-10 INORGANIC FERTILIZER (50 LB. PER 5000 SF.)
LAWNS - SOD & SEED	6"	6" SCREENED LOAM

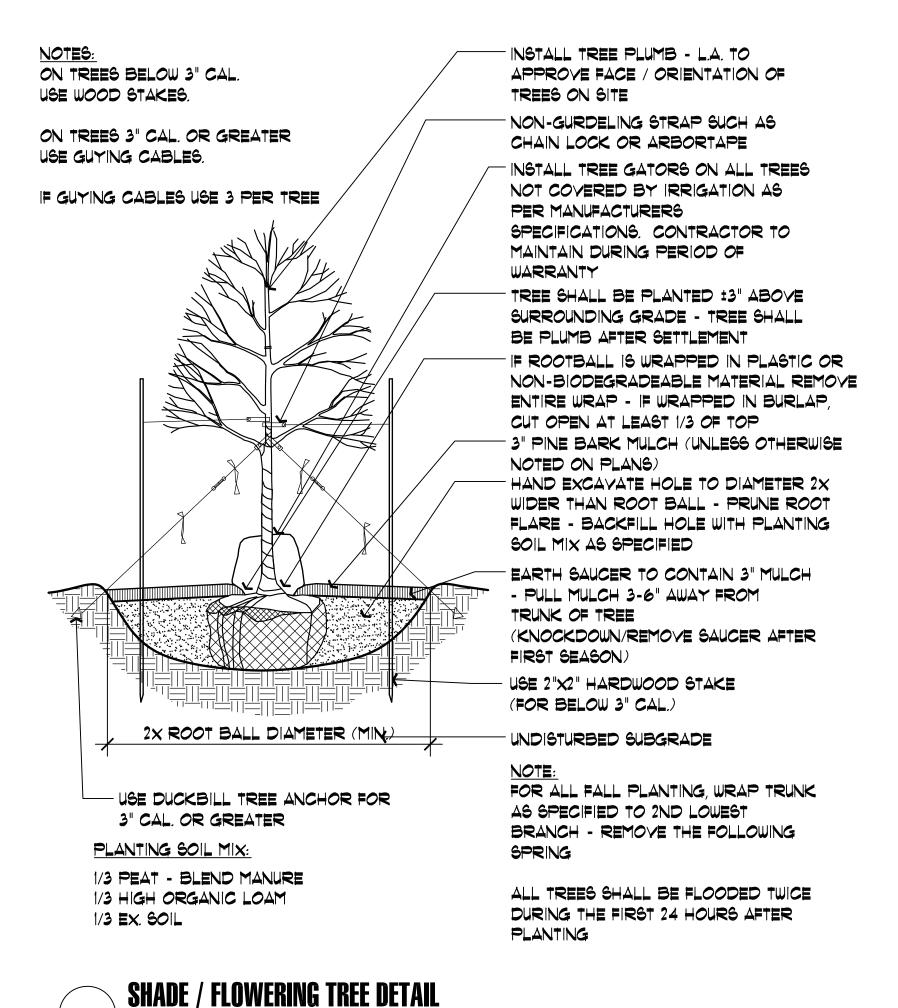



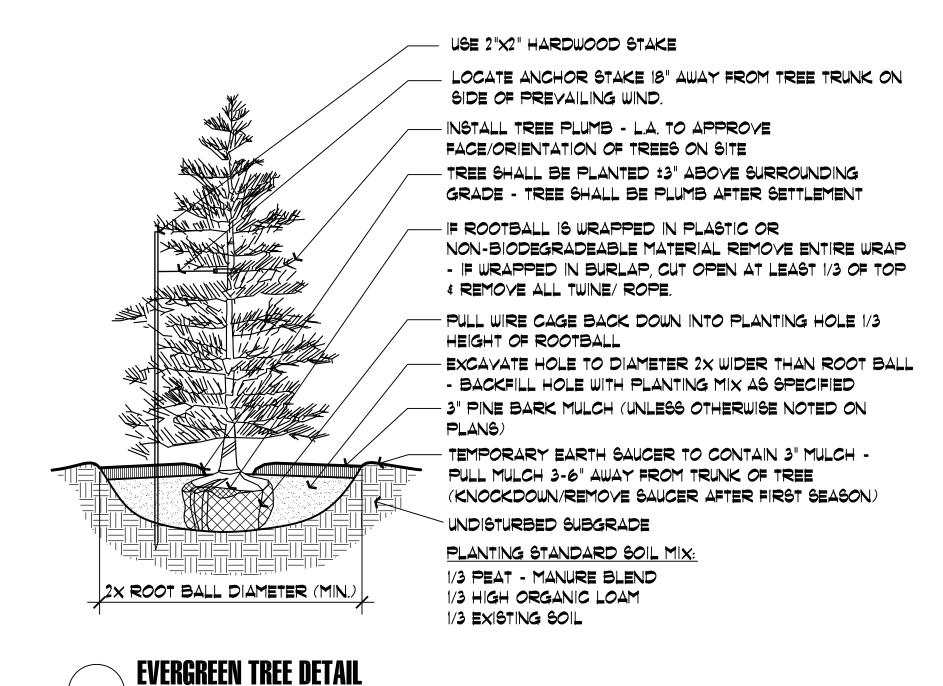



Hawk Design, Inc.
Landscape Architecture
Land Planning
Sagamore MA

Sagamore, MA 508-833-8800 info@hawkdesigninc.com

HAWK DESIGN, INC. 2013

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Date: 6/26/13

Revisions:Num. Date Description

uni. Buto Bosorphon



4/26/13

170 Needham Street
Prepared for: Needham Chestnut Realty, LLC
310 Washington Street, Suite 202, Wellesley, MA

Drawn By: BNL Checked By: TM

Planting Details

Scale: As Noted

• D1

1.1) CONTRACTOR REQUIREMENTS:

A) ALL WORK SHALL COMPLY WITH APPLICABLE CODES AND REGULATIONS, FROM ALL FEDERAL, STATE AND LOCAL AUTHORITIES.

B) THE CONTRACTOR SHALL ARRANGE FOR AND OBTAIN ALL PERMITS AND LICENSES REQUIRED FOR THE COMPLETE WORK SPECIFIED HEREIN AND SHOWN ON ALL THE DRAWINGS. THE CONTRACTOR SHALL PAY FOR ANY FEES NOT WAIVED.

1.2) <u>utilities:</u>

A) LANDSCAPE CONTRACTOR IS REQUIRED TO CONTACT THE RELEVANT UTILITY COMPANIES PRIOR TO DOING ANY EXCAVATION ON THE SITE. IF ANY WORK IS TO BE DONE AROUND UNDERGROUND UTILITIES, THE APPROPRIATE AUTHORITY OF THAT UTILITY MUST BE NOTIFIED OF THE IMPENDING WORK.

B) UTILITIES SHALL BE LOCATED AND MARKED PRIOR TO ANY INSTALLATION. ADJUSTMENTS MAY BE NECESSARY IN THE FIELD TO ACCOMMODATE UTILITY LOCATIONS. REPORT ANY CONFLICTS TO THE LANDSCAPE ARCHITECT PRIOR TO INSTALLATION.

C) THE LANDSCAPE CONTRACTOR SHALL BE RESPONSIBLE FOR ANY DAMAGES DONE TO EXISTING UTILITIES. THE CONTRACTOR SHALL BE RESPONSIBLE FOR THE COST OF SATISFACTORY REPAIR OF ALL DAMAGE IN KIND RESULTING FROM THEIR FAILURE TO

1.3) <u>Protection of existing work:</u> It shall be the contractor's responsibility to PERFORM ALL WORK IN A MANNER THAT PROTECTS WORK COMPLETED BY OTHERS, SUCH AS CURBS, UTILITIES, STORM DRAINAGE, FENCES, DRIVEWAY APRONS, DRIVES, VEGETATION, ETC. THE CONTRACTOR SHALL BE RESPONSIBLE FOR THE COST OF SATISFACTORY REPAIR OF ALL DAMAGE IN KIND RESULTING FROM THEIR FAILURE TO COMPLY.

1.4) <u>quantities:</u> a complete list of plants including a schedule of quantities, SIZES, TYPES, AND NAMES IS INCLUDED IN THIS SET OF DRAWINGS. IN THE EVENT OF DISCREPANCIES BETWEEN QUANTITIES OF PLANT IN THE PLANT LIST AND THE QUANTITIES SHOWN ON THE DRAWINGS, THE PLAN SHALL GOVERN. THE LANDSCAPE CONTRACTOR SHALL NOTIFY THE LANDSCAPE ARCHITECT OF UNLABELED PLANTS IN PLAN FOR . THE LANDSCAPE ARCHITECT SHALL BE ALERTED BY THE CONTRACTOR OF ANY DISCREPANCIES PRIOR TO FINAL BID NEGOTIATION.

1.5) <u>applicable plant materials standards:</u> all plant materials are to comply WITH THE LATEST EDITION OF THE AMERICAN STANDARD FOR NURSERY STOCK AS PUBLISHED BY THE AMERICAN ASSOCIATION OF NURSERYMEN. PLANTING METHODS WILL BE IN ACCORDANCE WITH SITE-SPECIFIC REQUIREMENTS.

1.6) <u>Plant Hardiness:</u> all trees and shrubs shall be nursery grown within a USDA PLANT HARDINESS ZONE, WHICH IS THE SAME AS, OR COLDER THAN, THE ZONE IN WHICH THE PROJECT IS LOCATED.

1.7) <u>Planting Seasons:</u> Planting Shall only occur during specified seasons. SPRING SEASON SHALL BE FROM MARCH I TO JUNE 15, FALL PLANTING SEASON SHALL BE FROM SEPTEMBER 15 THROUGH NOVEMBER 15, NO PLANTING SHALL OCCUR WHEN THE GROUND IS FROZEN.

1.8) <u>Plant substitutions</u>: no substitutions of products, plant types or sizes SHALL BE MADE WITHOUT THE WRITTEN APPROVAL OF THE LANDSCAPE ARCHITECT. REQUESTS FOR SUBSTITUTION SHALL BE IN WRITING, AND SHALL STATE THE REASON FOR THE SUBSTITUTION REQUEST, THE SUGGESTED ALTERNATIVE AND THE CHANGES IN COST. REQUESTS FOR SUBSTITUTION IN PLANT MATERIALS SHALL STATE THE NAMES OF NURSERIES THAT HAVE BEEN UNABLE TO SUPPLY THE ORIGINALLY SPECIFIED MATERIAL

1.9) THE LANDSCAPE ARCHITECT SHALL RESERVE THE RIGHT TO INSPECT ALL PLANT MATERIALS AT THE NURSERY, UPON SITE DELIVERY AND DURING INSTALLATION TO INSURE SPECIFICATIONS AND PROCEDURES ARE ADHERED TO.

1.10) MINIMUM SIZES: ALL PLANTS 3' OR GREATER IN HEIGHT OR SPREAD SHALL BE BALLED AND BURLAPPED. SIZES SPECIFIED IN THE PLANT LIST ARE MINIMUMS ON WHICH THE PLANTS ARE TO BE JUDGED.

(11) DEAD PLANTS: DEAD PLANTS ARE TO BE REMOVED FROM THE SITE IMMEDIATELY, AND REPLACED WITH THE SAME PLANT & SIZE REGARDLESS OF SEASON, WEEKLY FROM THE JOB BY THE CONTRACTOR, THE CONTRACTOR SHALL MAINTAIN AN UPDATED COMPREHENSIVE LIST OF ALL DEAD MATERIALS REMOVED AND PRESENT A COPY OF THE LIST TO THE OWNER AND LANDSCAPE ARCHITECT AT THE END OF EVERY MONTH DURING THE CONTRACT PERIOD.

1.12) <u>Plant Material Removal:</u> no existing trees shall be removed without the WRITTEN AUTHORIZATION FROM THE LANDSCAPE ARCHITECT EXCEPT WHERE NOTED ON THE PLANS. CONTRACTORS WHO REMOVE EXISTING TREES WITHOUT WRITTEN APPROVAL WILL BE REQUIRED TO MAKE REMEDIES DETERMINED BY THE GOVERNING URBAN FORESTER OR EQUIVALENT AUTHORITY, NO GRUBBING SHALL OCCUR WITHIN EXISTING TREE AREAS UNLESS SPECIFICALLY NOTED ON THE PLANS.

1.13) ALL DISTURBED AREAS NOT TO RECEIVE PLANT MATERIALS ARE TO BE LOAMED AND SEEDED AND BLENDED INTO EXISTING GRADE AND CONDITIONS. SEE SECTION 4.0.

1.14) LEDGE BOULDERS: IF DURING SITE EXCAYATION, LEDGE BOULDERS ARE AYAILABLE, THESE ARE TO BE STOCKPILED FOR USE IN EARTH BERMS IF APPLICABLE, WITH HAWK DESIGN, INC. PRIOR TO INSTALLATION. THIS ITEM WILL ONLY APPLY IF SO SPECIFIED ON DRAWINGS. BOULDERS SIZES TO BE STOCKPILED WILL RANGE FROM TWO TO FIVE FEET IN DIAMETER. SEE APPROPRIATE DETAIL FOR INSTALLATION COORDINATION.

1.15) SLEEVES: LANDSCAPE OR SITE CONTRACTOR SHALL PLACE INDIVIDUAL SLEEVES FOR LIGHTING AND IRRIGATION UNDER ANY PROPOSED WALKWAY OR VEHICULAR ROADWAY PRIOR TO INSTALLATION. COORDINATE SLEEVE LOCATIONS WITH IRRIGATION AND LIGHTING CONTRACTORS PRIOR TO INSTALLATION.

1.16) DO NOT CLOSE OR OBSTRUCT ANY STREET, SIDEWALK, ALLEY OR PASSAGEWAY WITHOUT PRIOR NOTIFICATION AND PERMISSION. CONDUCT OPERATIONS AS TO INTERFERE AS LITTLE AS POSSIBLE WITH THE USE ORDINARILY MADE OF ROADS, DRIVEWAYS, ALLEYS, SIDEWALKS OR OTHER FACILITIES NEAR ENOUGH TO THE WORK TO BE EFFECTED THEREBY.

20 PLANTING MATERIALS

2.1 PLANTING MATERIAL ITEMS IN SECTION 2.0 ARE TO BE INCORPORATED DURING PLANT INSTALLATION UNLESS OTHERWISE DEEMED UNNECESSARY IN ACCORDANCE WITH SOIL TEST RECOMMENDATIONS. SEE SECTION 3.1.

MULCH - MULCH WILL BE DOUBLE-SHREDDED PINE BARK MULCH.

- TREES AND SHRUBS SHALL RECEIVE AN EVEN 3" MULCH LAYER. - GROUNDCOYERS, PERENNIALS AND ANNUALS SHALL RECEIVE AN EVEN 2" MULCH LAYER.

MANURE- TO BE WELL ROTTED, ODORLESS, UNLEACHED COW MANURE, CONTAINING NOT MORE THAN 15% BEDDED MATERIALS SUCH AS STRAW, WOOD CHIPS OR SHAVINGS, AGED NOT LESS THAN TWO YEARS OLD

HERBICIDE - A PRE-EMERGENCE WEED KILLER IS TO BE USED ON ALL LAWN AND PLANTING AREAS PRIOR TO INSTALLATION AS PER MANUFACTURER'S SPECFICATIONS. *HERBICIDES ARE NOT TO BE APPLIED IN RESTRICTED CONSERVATION AREAS.

FERTILIZER - ALL TREES AND SHRUBS TO HAVE SLOW RELEASE PACKET OR PELLET PLACED INTO THE PLANT PIT WITH A MINIMUM ANALYSIS OF 10-10-10. ALL GROUNDCOVERS, PERENNIALS AND ANNUALS ARE TO RECIEVE A BROADCAST APPLICATION OF A 14-14-14 FERTILZER AT 3 LB PR 100 SQ. FT. APPLY AS PER MANUFACTURER'S INSTRUCTIONS. *FERTILIZERS ARE NOT TO BE APPLIED IN RESTRICTED CONSERVATION AREAS.

TOPSOIL- ACCEPTABLE TOPSOIL SHALL BE FERTILE, FRIABLE NATURAL LOAM, UNIFORM IN COMPOSITION, FREE OF STONES, LIMBS, PLANTS AND THIER ROOTS, DEBRIS AND OTHER EXTRANEOUS MATTER OVER ONE INCH IN DIAMETER, THE SOIL SHALL BE CAPABLE OF SUSTAINED PLANT GROWTH AND HAVE A 5% MINIMUM ORGANIC CONTENT. IN SITUATIONS WHICH REQUIRE A CUSTOM TOPSOIL OR STRUCTURAL SOIL, THE SOIL MIXTURE SPECIFICATION WILL BE PROVIDED BY THE LANDSCAPE ARCHITECT.

SOIL AMENDMENTS: APPLY AS NECESSARY ACCORDING TO SOIL TEST RESULTS, AS PER MANUFACTURES SPECIFICATIONS.

<u>anti-desiccant</u>- "wilt pruf" ncf or equal apply as per manufacturers' SPECIFICATIONS.

3.1) Soil testing: Landscape contractor shall provide a certified soil analysis PRIOR TO ANY PLANT INSTALLATION TO DETERMINE ANY NECESSARY AMENDMENTS TO THE EXISTING SOIL CONDITIONS FOR SEEDING AND PLANTING, THE ANALYSIS WILL ALSO BE REQUIRED FOR ESTABLISHING THE FERTILIZER PROGRAM REQUIRED, COORDINATE RESULTS AND PROVIDE WRITTEN RECOMMENDATIONS TO HAWK DESIGN, INC. 15 DAYS PRIOR TO INSTALLATION.

3.2) ALL PLANTS SHALL BE TRANSPORTED TO THE SITE IN COVERED TRUCKS, TARPAULIN COYERS SHALL BE UTILIZED TO PREVENT WIND DAMAGE OF LOAD.

3.3) DELIVER PLANT MATERIALS IMMEDIATELY PRIOR TO PLACEMENT, KEEP PLANT MATERIALS MOIST, DO NOT STORE PLANT MATERIAL ON PAYED AREAS, ROOTS OR BALLS SHALL BE PROTECTED FROM THE SUN OR DRYING WINDS, AS REQUIRED BY TEMPERATURE OR WIND CONDITIONS, APPLY ANTI-DESICCANT EMULSION TO PREVENT DRYING OUT OF PLANT MATERIALS.

3.4) CONDITIONS FOR PLANT REJECTION:

A) REJECT PLANTS WHEN BALL OF EARTH SURROUNDING ROOTS HAS BEEN CRACKED OR BROKEN PREPARATORY TO OR DURING THE PROCESS OF PLANTING.

B) WHEN BURLAP, STAYES AND ROPES REQUIRED IN CONNECTION WITH TRANSPLANTING HAVE BEEN DISPLACED PRIOR TO ACCEPTANCE.

C) WIND DAMAGED PLANT MATERIAL FROM POOR TARPAULIN COVER PROCEDURES ARE SUBJECT TO REJECTION.

3.5) ALL PLANT MATERIAL, WHICH CANNOT BE PLANTED IMMEDIATELY ON DELIVERY, SHALL BE SET ON THE GROUND IN A SHADED LOCATION AND SHALL BE TEMPORARILY PROTECTED WITH SOIL OR OTHER ACCEPTABLE MATERIAL. TEMPORARY WATERING OR IRRIGATION SHALL BE INCORPORATED AND REGULARLY CONDUCTED ON PLANTINGS IN HOLD AREAS.

3.6) IN CASE OF CONFLICTS DURING CONSTRUCTION WITH UTILITIES, ROCK MATERIALS, TREE ROOTS OR OTHER OBSTRUCTIONS FOR THE EXCAVATION OF SHRUB BEDS AND TREE PITS. CONTACT LANDSCAPE ARCHITECT FOR APPROVED ALTERNATE LOCATIONS.

3.7) <u>Soil Permability</u>: test drainage of planting beds and pits by filling with water TWICE IN SUCCESSION, CONDITIONS PERMITTING THE RETENTION OF WATER FOR MORE THAN 24 HOURS SHALL BE BROUGHT TO THE ATTENTION OF THE LANDSCAPE ARCHITECT.

3.8) SOIL EXCAYATIONS:

A) EXCAYATE TREE PITS AND SHRUB BEDS TO DEPTHS REQUIRED BY PLANTING DETAILS. ALL PITS SHALL BE CIRCULAR IN OUTLINE, EXCEPT FOR WHOLE BEDS. SEE APPROPRIATE PLANTNIG DETAILS.

B) SOIL EXCAVATIONS FOR BALLED & BURLAP AND CONTAINER PLANTINGS MUST BE NO LESS THAN 2X ROOT BALL DIAMETER, SEE PLANTING DETAILS. IF QUESTIONABLE SUBSURFACE SOIL CONDITIONS EXIST SUCH AS POOR DRAINAGE CONDITIONS, RUBBLE OR OBSTRUCTIONS, REPORT TO THE LANDSCAPE ARCHITECT AND CONSTRUCTION MANAGER BEFORE PLANTING.

3.9) GRADING:

A) VERIFY GRADES PRIOR TO PLANTING, THE CONTRACTOR SHALL VERIFY THAT CONSTRUCTED GRADES ARE AS INDICATED ON PLANS. THE CONTRACTOR SHALL NOTIFY THE LANDSCAPE ARCHITECT IF ADJUSTMENTS TO PLANT PLACEMENT MAY BE REQUIRED DUE TO FIELD CONDITIONS AND FINAL GRADING.

B) POSITIVE DRAINAGE SHALL BE MAINTAINED AWAY FROM AND AROUND BUILDINGS (REFER TO ENGINEERS GRADING PLANS). REPORT ANY CONFLICTS TO HAWK DESIGN, INC. PRIOR TO INSTALLATION.

C) FINISH GRADE OF PLANTINGS SHALL BE EQUIVALENT TO FORMER EXISTING GRADE OF PLANT IN THE NURSERY.

3.10) BALLED AND BURLAPED (B&B) MATERIALS: A) CUT WIRE BASKETS ONCE IN THE PLANT PIT AND PEEL WIRE BACK.

B) TAGS AND TWINE ARE TO BE REMOVED AND BURLAP IS TO BE ROLLED BACK ONE-THIRD ON ALL B&B PLANT MATERIAL. ANY SYNTHETIC BURLAP SHALL BE COMPLETELY REMOVED FROM ANY PLANT MATERIAL

3.0 INSTALLATION CON'T

3.11) <u>Container Grown Stock:</u> Shall be removed from container by cutting CONTAINER AWAY TO AVOID ROOT DAMAGE TO PLANT ROOT SYSTEM. IF PLANT ROOT IS BOUND, SLICE ROOT BALLS APPROXIMATELY 2" DEEP WITH KNIFE OR SHARP SPADE.3.12) DO NOT USE MUDDY OR FROZEN SOIL TO BACKFILL PLANTINGS.

3.13) <u>WATERING:</u> THOROUGHLY WATER UNTIL SOIL IS SATURATED AROUND ALL TREES AND SHRUBS AFTER PLANTING AND THROUGHOUT THE TIME PERIOD UNTIL FINAL ACCEPTANCE FROM CLIENT. DURING DRY CONDITIONS, WATER AS REQUIRED TO MAINTAIN PLANTS IN A WILT-FREE CONDITION.

3.14) PRUNING: TREES SHALL BE PRUNED TO BALANCE TOP GROWTH WITH ROOTS AND TO PRESERVE THEIR NATURAL CHARACTER AND TYPICAL GROWTH HABIT, PRUNING SHALL BE RESTRICTED IN GENERAL TO THE SECONDARY BRANCHES AND SUCKER GROWTH. ALL CUTS TO BE FLUSH WITH TRUNK, DO NOT CUT A LEADER, THE LANDSCAPE ARCHITECT WILL REJECT ALL PLANTS DISFIGURED BY POOR PRUNING PRACTICES, ALL PRUNING CUTS SHALL REMAIN UNPAINTED.

3.15) STAKING AND GUYING: ALL TREES TO BE STAKED AND GUYED WITHIN 48 HOURS OF PLANTING. METHODS AND MATERIALS FOR STAKING AND GUYING ARE ILLUSTRATED IN INDIVIDUAL PLANTING DETAILS. NEATLY FLAG ALL GUY WIRES WITH ROT RESISTANCE YELLOW TREE MARKING RIBBON.

3.16) STAKE OUT PLANT LOCATIONS: PRIOR TO PLANTING THE CONTRACTOR SHALL LAYOUT THE EXTENT OF THE PLANT BEDS AND PROPOSED LOCATIONS FOR B&B PLANTS FOR REVIEW BY THE OWNER AND LANDSCAPE ARCHITECT.

3.17) <u>Planting field adjustments:</u>

A) THE CONTACTOR IS TO SLIGHTLY ADJUST PLANT LOCATIONS IN THE FIELD AS NECESSARY TO BE CLEAR OF DRAINAGE SWALES AND UTILITES.

B) LARGE GROWING PLANTS ARE NOT TO BE PLANTED IN FRONT OF WINDOWS OR UNDER BUILDING OVERHANGS. NOTIFY THE LANDSCAPE ARCHITECT OF DISCREPANCIES IN PLANTING PLAN VS. FIELD CONDITIONS.

C) SHRUBS PLANTED NEAR HVAC UNITS ARE TO BE LOCATED SO THAT SHRUBS AT MATURITY WILL MAINTAIN ONE FOOT (I') AIRSPACE BETWEEN THE UNIT AND THE PLANT, ANY PLANTING SHOWN ADJACENT TO CONDENSER UNITS SHALL BE PLANTED TO SCREEN THE UNITS. SHOULD THE CONDENSER UNITS BE INSTALLED IN LOCATIONS DIFFERENT FROM THOSE SHOWN ON THE PLAN, IT WILL BE THE CONTRACTOR'S RESPONSIBILITY TO NOTIFY THE LANDSCAPE ARCHITECT AND INSTALL THE MATERIAL AROUND THE CONDENSERS AND ADJUST THE OTHER PLANTING ACCORDINGLY.

3.18) <u>Plant Bed Edges/Lines:</u> groups of shrubs, perennials and groundcovers SHALL BE PLACED IN A CONTINUOUS MULCH BED WITH SMOOTH CONTINUOUS LINES. ALL MULCHED BED EDGES SHALL BE CURVILINEAR IN SHAPE, FOLLOWING THE CONTOUR OF THE PLANT MASS. TREES LOCATED WITHIN 4 FEET OF PLANT BEDS SHALL SHARE THE SAME MULCH BEDS.

3.19) A.D.A. - THE AMERICAN WITH DISABILITIES ACT STANDARDS REQUIRE THAT A 7 FOOT VERTICAL CLEARANCE BE MAINTAINED FROM TREE BRANCHES TO FINISHED GRADE WHERE PEDESTRIANS SIDEWALKS AND/OR TRAILS ARE LOCATED. THE CONTRACTOR IS TO ADJUST TREE PLANTINGS IN FIELD TO SLIGHTLY MINIMIZE BRANCH OVERHANG AMD COMPLY WITH THE

320) TREE SPACING MINUMUMS: TREES SHALL BE LOCATED A MINIMUM OF 4 FEET FROM WALLS AND WALKS WITHIN THE PROJECT, IF A CONFLICT ARISE BETWEEN ACTUAL SIZE OF AREA AND PLANS, THE CONTRACTOR SHALL CONTACT THE LANDSCAPE ARCHITECT FOR RESOLUTION. FAILURE TO MAKE SUCH CONFLICTS KNOWN TO LANDSCAPE ARCHITECT WILL RESULT IN CONTRACTOR'S LIABILITY TO RELOCATE MATERIALS.

4.0 SEEDING AND SODDING

4.1) SEEDING OF LAWN AREAS: GRASS SEED APPLICATION SHALL BE SPREAD AT THE RATE OF 5 LBS. PER 1,000 SQUARE FEET, SEEDING SHALL BE ACCOMPLISHED BY MEANS OF A HYDRO-SEEDING PROCESS.

4.2) WATERING OF SEEDED AREAS: 24 HOURS AFTER HYDRO SEEDING, THE CONTRACTOR SHALL WATER THE SEEDED AREA LIGHTLY AND SUFFICIENTLY TO A DEPTH OF TWO INCHES (2") A MINIMUM OF 2 TIMES A DAY (MID-MORNING AND LATE AFTERNOON), UNTIL THE SEEDS ARE ESTABLISHED.

4.3) SEEDED AREA PROTECTION: THE CONTRACTOR SHALL ERECT SUITABLE SIGNS AND BARRICADES NOTIFYING THE PUBLIC TO KEEP OFF THE SEEDED AREAS UNTIL WELL ESTABLISHED. ANY TRAFFIC DAMAGE AND VANDALISM THAT MAY OCCUR PRIOR TO FINAL ACCEPTANCE OF THE WORK SHALL BE REPAIRED AND RESEEDED AT THE OWNER'S EXPENSE. ANY DISTURBED OR DAMAGED BY THE CONTRACTOR SHALL BE REPAIRED IN ACCORDANCE WITH THE SPECIFICATIONS AT THE CONTRACTOR'S EXPENSE.

4.4) LAYING OF SOD: A KENTUCKY BLUEGRASS SOD MIX - BY LOCAL SOURCE AS SELECTED BY CONTRACTOR, SHALL BE FRESHLY CUT FROM THE SAME FIELD WITH 1/2 -3/4 INCHES OF SOIL. SOD SHALL BE LAID IMMEDIATELY WITH ANY STORED SOD BEING UNROLLED GRASS SIDE UP AND KEPT WATERED. LAY COURSES TIGHTLY TOGETHER WITHOUT OVERLAPPING WITH THE JOINTS STAGGERED. AFTER SODDING IS COMPLETE, ROLL LIGHTLY. THE CONTRACTOR SHALL WATER THE SODDED AREAS TO A DEPTH OF AT LEAST SIX INCHES AFTER THE SODDING PROCESS. OWNER SHALL THEN BE RESPONSIBLE FOR WATERING. THE FREQUENCY SHALL BE DETERMINED BY RAIN FALL AND WINDS WITH THE UPPER TWO OR THREE INCHES OF SOIL NOT DRYING OUT MARKEDLY.

4.5) SODDED AREA: INSPECTION AND ACCEPTANCE: FOUR WEEKS AFTER CONTRACTOR COMPLETES INSTALLATION, LANDSCAPE ARCHITECT SHALL INSPECT THE LAWN TO DETERMINE THE ACCEPTABILITY OF THE INSTALLATION. SODDED AREAS FAILING TO SHOW ADEQUATE ROOTING INTO THE SUBSOIL, OVERLAPPING, COURSE SEPARATION, UNEVENNESS OF THE SURFACE, UNEVEN COURSE COLOR AND EXCESSIVE BROADLEAF WEED CONTENT SHALL BE REPLACED. THE COST SHALL BE BORNE BY THE CONTRACTOR EXCEPT WHERE VANDALISM OR NEGLECT ON THE PART OF OTHERS NOT UNDER THE CONTRACTORS CONTROL HAS RESULTED IN DAMAGE.

4.6) FINAL APPROVAL: SEEDED AND SODDED AREAS WILL RECEIVE FINAL APPROVAL IF COVERAGE IS FULL AND CONSISTENT, FREE OF BARE SPOTS AND WEED FREE. WHEN GRASS IS CUT AT 2" HEIGHT NO SOIL SHOULD BE VISIBLE. SOD AREAS MUST HAVE RECEIVED A MINIMUM OF TWO MOWINGS, AREAS SODDED AFTER NOVEMBER IST WILL BE ACCEPTED THE FOLLOWING SPRING - ONE MONTH AFTER THE START OF THE GROWING SEASON, IF THE ABOVE CRITERIA HAS BEEN MET.

5.0 MAINTENANCE

5.1) MAINTENANCE DURING INSTALLATION: MAINTENANCE OPERATIONS SHALL BEGIN IMMEDIATELY AFTER EACH PLANT IS PLANTED AND SHALL CONTINUE AS REQUIRED UNTIL FINAL ACCEPTANCE AND THEN FOR THE GUARANTEE PERIOD. PLANTS SHALL BE KEPT IN A HEALTHY, GROWING CONDITION BY WATERING, PRUNING, SPRAYING, WEEDING AND ANY OTHER NECESSARY OPERATIONS OF MAINTENANCE, PLANT SAUCERS AND BEDS SHALL BE KEPT FREE OF WEEDS, GRASS AND OTHER UNDESIRED VEGETATION. PLANTS SHALL BE INSPECTED AT LEAST ONCE PER WEEK BY THE CONTRACTOR DURING THE INSTALLATION PERIOD AND ANY NEEDED MAINTENANCE IS TO BE PERFORMED PROMPTLY.

52) <u>Grass and weed control:</u> the contractor shall be responsible for MOWING ALL GRASS AROUND LANDSCAPE BEDS AND INDIVIDUAL TREES AND SHRUBS UNTIL FINAL ACCEPTANCE, WEED CONTROL AREAS SHALL INCLUDE ALL LANDSCAPE BEDS AND THE AREA WITHIN 2 FEET OF THE OUTER EDGE OF THE MULCH AREA OR INDIVIDUAL TREE/SHRUBS.

5.3) THE CONTRACTOR SHALL WATER, FERTILIZE, WEED, CULTIVATE, REMULCH, SPRAY TO CONTROL INSECT INFESTATION AND DISEASE AND PERFORM ANY OTHER GOOD HORTICULTURAL PRACTICE NECESSARY TO MAINTAIN THE PLANTS IN A LIVING HEALTHY CONDITION UPON THE TIME FOR TERMINATION OF HIS RESPONSIBILITY FOR CARE AS SET OUT HEREIN. THE CONTRACTOR SHALL BE RESPONSIBLE FOR THE PLANTS THROUGHOUT LIFE OF THE CONTRACT.

5.4) ALL PLANTS STOLEN, DAMAGED OR DESTROYED BY FIRE, AUTOMOBILES, VANDALISM OR ANY OTHER CAUSE, WITH THE EXCEPTION OF PLANTS DAMAGED OR DESTROYED BY THE OWNERS MAINTENANCE OPERATIONS, SHALL BE REPLACED BY THE OWNER PRIOR TO THE DATE OF FINAL ACCEPTANCE.

5.5) LANDSCAPE CONTRACTOR SHALL PREPARE MAINTENANCE SPECIFICATIONS AND SCHEDULE ANNUAL CARE OF ALL PLANTED AND LAWN AREAS INCLUDING FERTILIZING WEEDING, MULCHING, BED EDGING, PRUNING AND PEST PREVENTION AND TREATMENT.

6.0 PLANT MATERIAL GUARANTEE

*CONTRACTOR SHALL GUARANTEE IN WRITING ALL PLANT MATERIAL AND LANDSCAPE IMPROVEMENTS FOR A PERIOD OF ONE YEAR. THE GUARANTEE IS TO INCLUDE THE FOLLOWING:

6.1) INSPECTIONS: PERFORM PERIODIC INSPECTIONS DURING GUARANTEE PERIOD WITH RESULTING WRITTEN REPORTS TO OWNER, PROJECT ADMINISTRATOR AND LANDSCAPE ARCHITECT STATING CONDITIONS AND RECOMMEND MAINTENANCE MODIFICATIONS. THE CONTRACTOR MUST CONTACT THE OWNER AND LANDSCAPE ARCHITECT AT LEAST 10 DAYS IN ADVANCE TO SCHEDULE ACCEPTANCE INSPECTION(S).

62) REMOVAL AND REPLACEMENT OF PLANTS PROVIDED BY CONTRACTOR TO BE DONE WITHIN THIRTY DAYS OF NOTIFICATION BY OWNER OF THEIR UNSATISFACTORY CONDITION DURING GROWING SEASONS. REPLACEMENT MATERIALS MUST BE EQUAL IN TYPE AND SIZE PER THE PROJECT'S PLANT LIST.

6.3) WHEN REPLACEMENT PLANT SPECIES IS EITHER NOT READILY AVAILABLE OR NO LONGER SUITABLE TO EXISTING SITE CONDITIONS WRITTEN NOTICE RECOMMENDATION OF SUBSTITUTION TO BE PROVIDED TO THE OWNER AND LANDSCAPE ARCHITECT WITHIN FIFTEEN DAYS FOR APPROVAL.

6.4) REMOVAL OF TREE'S SUPPORTS AND DEAD LIMBS PRIOR TO END OF GUARANTEE INSPECTION PERIOD.

6.5) CONTINUE WITH MAINTENANCE, SEE SECTION 5.0

6.6) GUARANTEE SHALL BEGIN UPON DATE OF FINAL ACCEPTANCE FROM OWNER AND WILL CONTINUE FOR ONE YEAR.

1.0 SITE CLEAN UP

7.1) SITE WORK CONDITIONS: EXCESS WASTE MATERIAL SHALL BE REMOVED DAILY WHEN PLANTING IN AN AREA HAS BEEN COMPLETED, THE AREA SHALL BE CLEARED OF ALL DEBRIS, SOIL PILES AND CONTAINERS DAILY. WHERE EXISTING GRASS AREAS HAVE BEEN DAMAGED OR SCARRED DURING PLANTING OPERATIONS, THE CONTRACTOR SHALL RESTORE DISTURBED AREAS TO THEIR ORIGINAL CONDITIONS AT HIS EXPENSE.

7.2) CLEAN PAYED AREAS UTILIZED FOR HAULING OR EQUIPMENT STORAGE AT END OF EACH WORKDAY.

7.3) MAINTAIN VEHICLES AND EQUIPMENT IN CLEAN CONDITION TO PREVENT SOILING OF ROADS, WALKS OR OTHER PAYED OR SURFACED AREAS.

7.4) REMOVE PROTECTIVE BARRIERS AND WARNING SIGNS AT TERMINATION OF LAWN ESTABLISHMENT.

Landscape Architecture **Land Planning** Sagamore, MA

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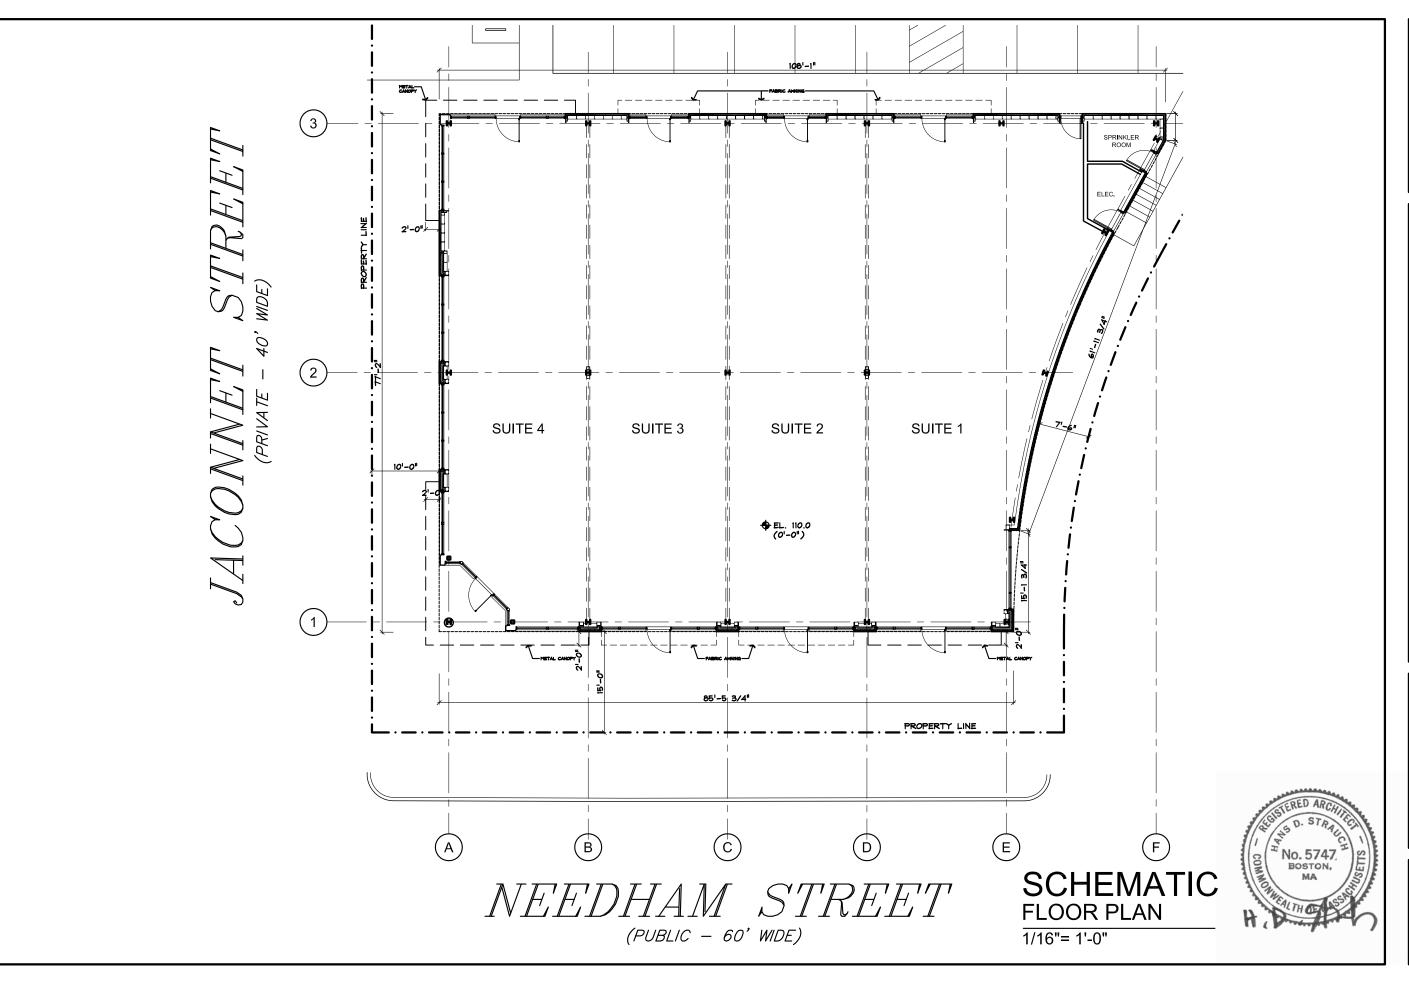
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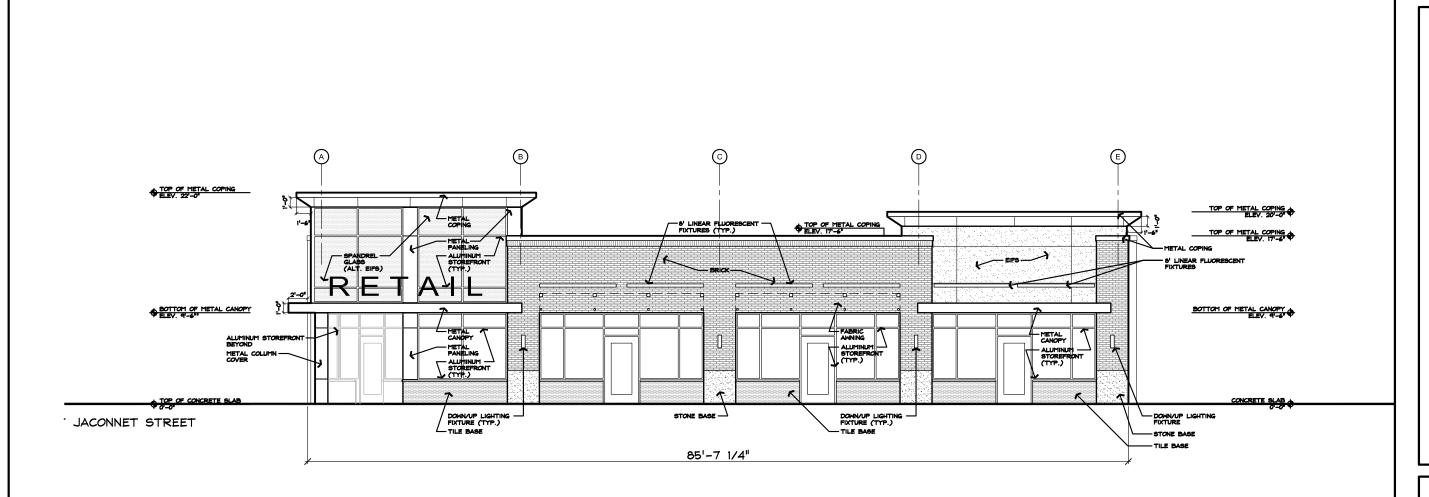


RETAIL BUILDING FLOOR PLAN

170 NEEDHAM STREET NEWTON, MA

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SCHEMATIC NEEDHAM STREET ELEVATION

SCALE: 1" = 10'-0"





RETAIL BUILDING ELEVATIONS
170 NEEDHAM STREET
NEWTON, MA

 Date:
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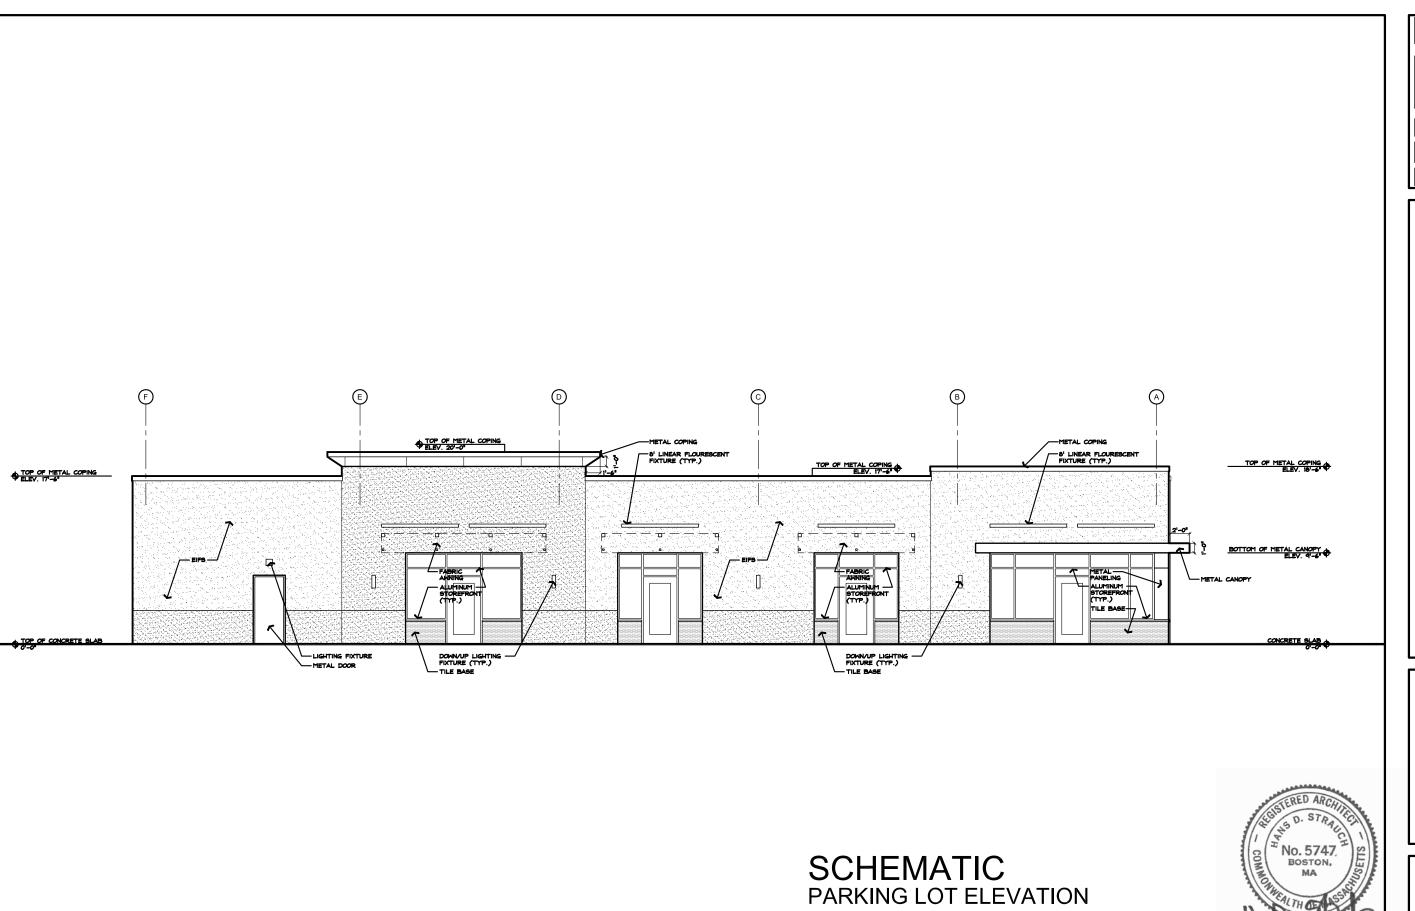
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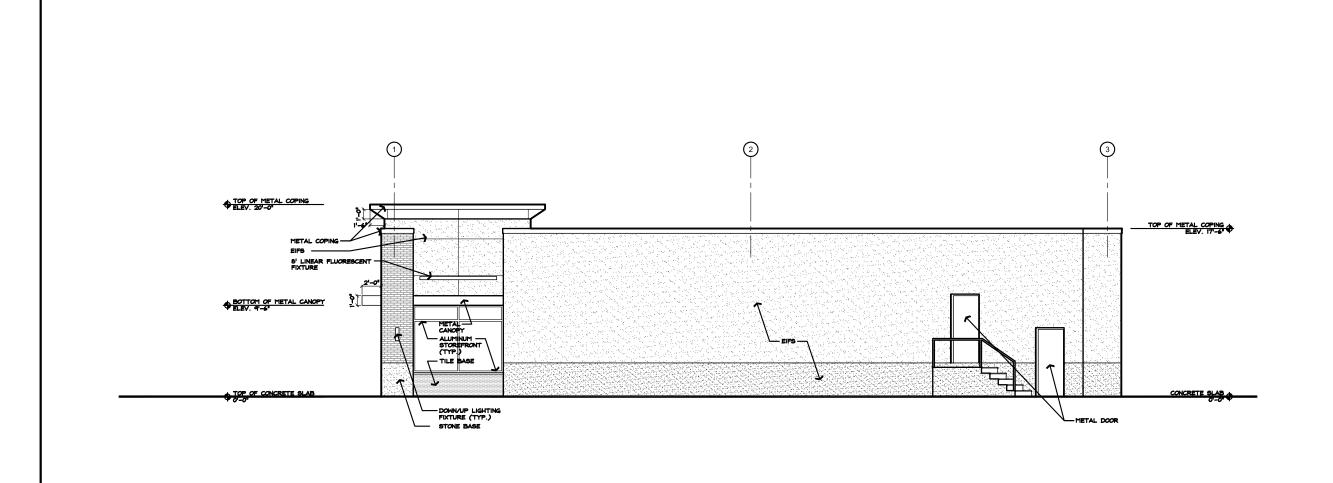
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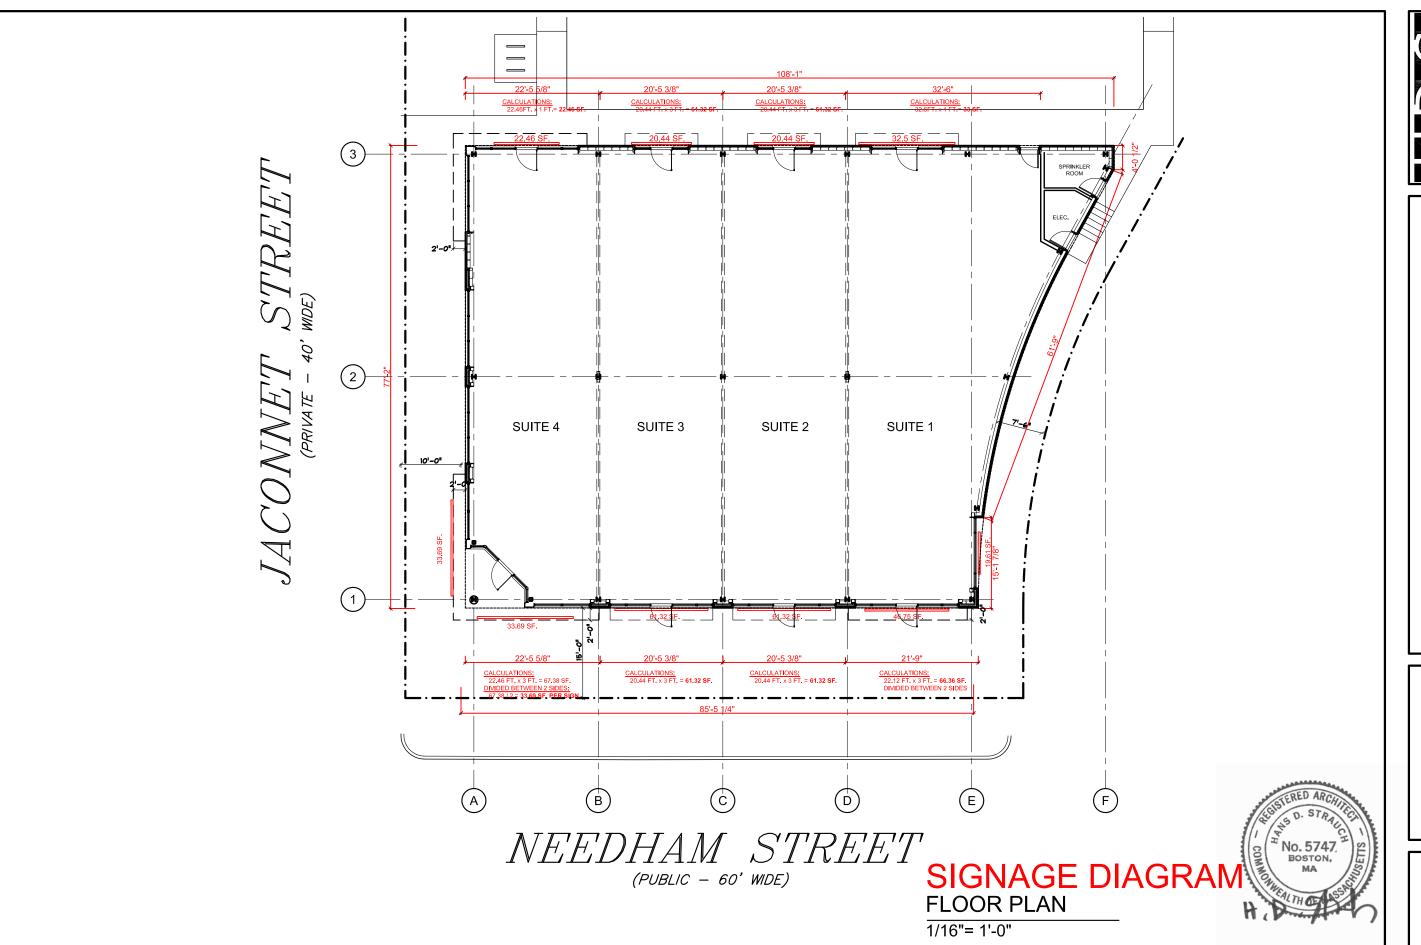


ELEVATIONS BUILDING RETAIL

170 NEEDHAM STREET NEWTON, MA

SCHEMATIC SIDE ELEVATION







RETAIL BUILDING FLOOR PLAN

170 NEEDHAM STREET NEWTON, MA

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SIGNAGE DIAGRAM NEEDHAM STREET ELEVATION

SCALE: 1" = 10'-0"



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RETAIL BUILDING ELEVATIONS

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SIGNAGE DIAGRAM JACONNET STREET ELEVATION

ELEVATIONS BUILDING

170 NEEDHAM STREET NEWTON, MA

RETAIL

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SIGNAGE DIAGRAM PARKING LOT ELEVATION



ELEVATIONS BUILDING

170 NEEDHAM STREET NEWTON, MA RETAIL

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SIGNAGE DIAGRAM SIDE ELEVATION