

) Stantec

SPECIAL PERMIT DRAWING SET FOR:

THE RESIDENCES AT KESSELER WOODS Newton, Massachusetts


ISSUED: AUGUST 4, 2014 REVISED: AUGUST 29, 2014 OCTOBER 24, 2014

	ZONING DATA - MR-3				
	REQUIRED / ALLOWED	CURRENT SPECIAL PERMIT			
MINIMUM LOT SIZE	10,000 S.F.	640,847 S.F. (14.7 ACRES)			
CONTINUOUS FRONTAGE	80'	625' +/- (LAGRANGE STREET)			
	15'	203' +/-			
MINIMUM SIDE YARD	16'	110' +/- (NEWTON/BROOKLINE TOWN LINE 202' +/- (SOUTHWEST PROPERTY LINE)			
MINIMUM REAR YARD	24'	77' +/-			
MINIMUM DISTANCE FROM STRUCTURE TO STREET	150' (FOOTNOTE 5)	202' +/-			
MINIMUM DISTANCE FROM STRUCTURE TO LOT LINE	75' (FOOTNOTE 5)	112' +/-			
MINIMUM SETBACKS TO LOT LINES	50' (FOOTNOTE 5)	203' FRONT; 77' REAR; 110' SIDE			
MAXIMUM NUMBER OF STORIES	4 STORIES (FOOTNOTE 5)	3.5 Stories			
MAXIMUM BLDG HEIGHT	48' (FOOTNOTE 5)	46.75'			
MAXIMUM BLDG LOT COVERAGE BY STRUCTURES	45%	8% +/-			
	30%	80% +/-			
PARKING		·			
	2 SPACES FOR EACH DWELLING UNIT	146 SPACES FOR 62 UNITS			
CAR PARKING SPACES	9x17' WITH OVERHANG AND 24' AISLE PARALLEL 9'X21'	9x19' WITH OVERHANG AND 20' AISLE PARALLEL 10'X20'			
ACCESSIBLE PARKING SPACES	2 VAN ACCESSIBLE	1 VAN ACCESSIBLE			
PARKING SETBACK	15' AT STREET R.O.W.	93' +/-			

_	
	PROPOSED
	640,847 S.F. (14.7 ACRES)
ľ	625' +/- (LAGRANGE STREET)
Ī	150' +/-
	182' +/- (NEWTON/BROOKLINE TOWN LINE) 516' +/- (SOUTHWEST PROPERTY LINE)
t	60' +/-
T	150'+/-
T	182'+/-
Ţ	150' FRONT; 60' REAR; 182' SIDE
Ī	4 STORIES MAX.
	48' MAX.
	8% +/-
	85% +/-
	160 SPACES FOR 80 UNITS
	9x17' WITH OVERHANG AND 24' AISLE
	PARALLEL 9'X21'
	2 VAN ACCESSIBLE
	96' +/-

DRAWING INDEX

	EXISTING CONDITIONS PLAN OF LAND	v. *	
001 100 200 201 202 300 301 301 400 401 400 401 500 600 700 700 702 703 704	OVERALL SITE PLAN LAYOUT AND MATERIALS PLAN GRADING PLAN BLASTING COMPARISON PLAN BUILDING HEIGHT CALCULATION PLAN UTILITY PLAN UTILITY PROFILES PLANTING PLAN TREE REMOVAL PLAN SITE PHOTOMETRIC PLAN LIFE SAFETY PLAN SITE DETAILS 1 SITE DETAILS 2 SITE DETAILS 3 SITE DETAILS 4 SITE DETAILS 5	A1.00 A1.01 A2.00A A2.00B A2.01A A2.01B A2.02A A2.02B A2.03A A2.03B A4.01 A4.02 A5.01	FLOOR PLAN: PARKING FLOOR PLAN & FIRST FLOOR PLAN FLOOR PLAN: SECOND FLOOR PLAN & THIRD FLOOR PLAN FLOOR PLAN: PARTIAL PARKING FLOOR PLAN FLOOR PLAN: PARTIAL PARKING FLOOR PLAN FLOOR PLAN: PARTIAL FIRST FLOOR FLOOR PLAN FLOOR PLAN: PARTIAL FLOOR FLOOR PLAN FLOOR PLAN: PARTIAL SECOND FLOOR PLAN FLOOR PLAN: PARTIAL SECOND FLOOR PLAN FLOOR PLAN: PARTIAL SECOND FLOOR PLAN FLOOR PLAN: PARTIAL THIRD FLOOR PLAN BUILDING ELEVATIONS BUILDING SECTIONS
L-800 L-801	SITE SECTIONS 1 SITE SECTIONS 2		
L-802	SITE SECTIONS 3		

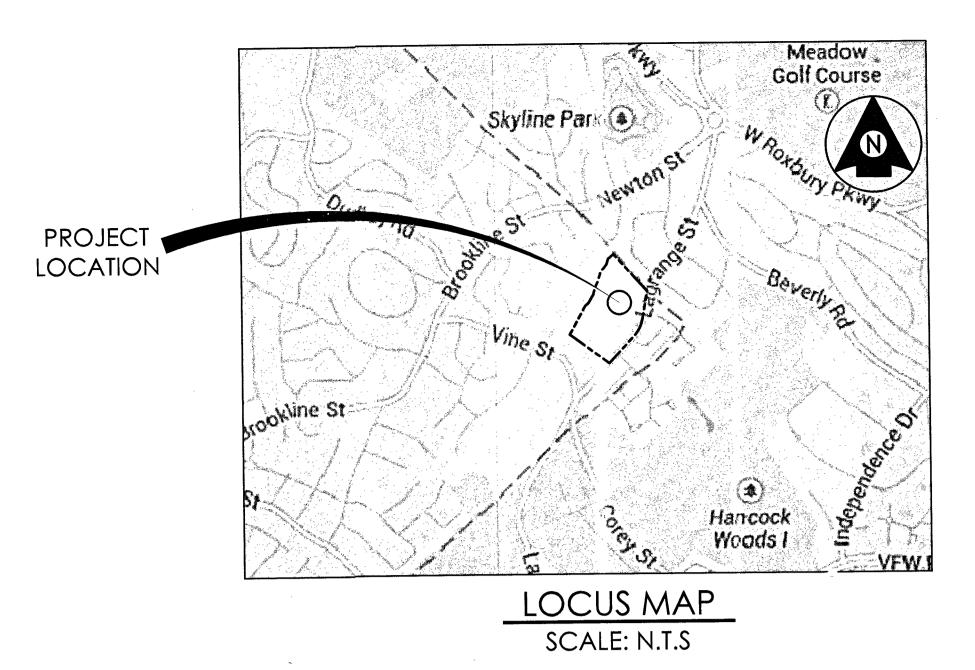

APPLICANT

CHESTNUT HILL REALTY DEVELOPMENT, LLC 300 INDEPENDENCE DRIVE CHESTNUT HILL, MA 02467 617.323.2100

OWNER

KESSELER DEVELOPMENT, LLC 400 BLUE HILL DRIVE WESTWOOD, MA 02090


LANDSCAPE ARCHITECT AND CIVIL ENGINEER

STANTEC PLANNING AND LANDSCAPE ARCHITECTURE P.C. 226 CAUSEWAY STREET BOSTON, MA 02114 617.523.8103

ARCHITECT

THE ARCHITECTURAL TEAM, INC 50 COMMANDMENTS WAY CHELSEA, MA 02150 617.889.4402



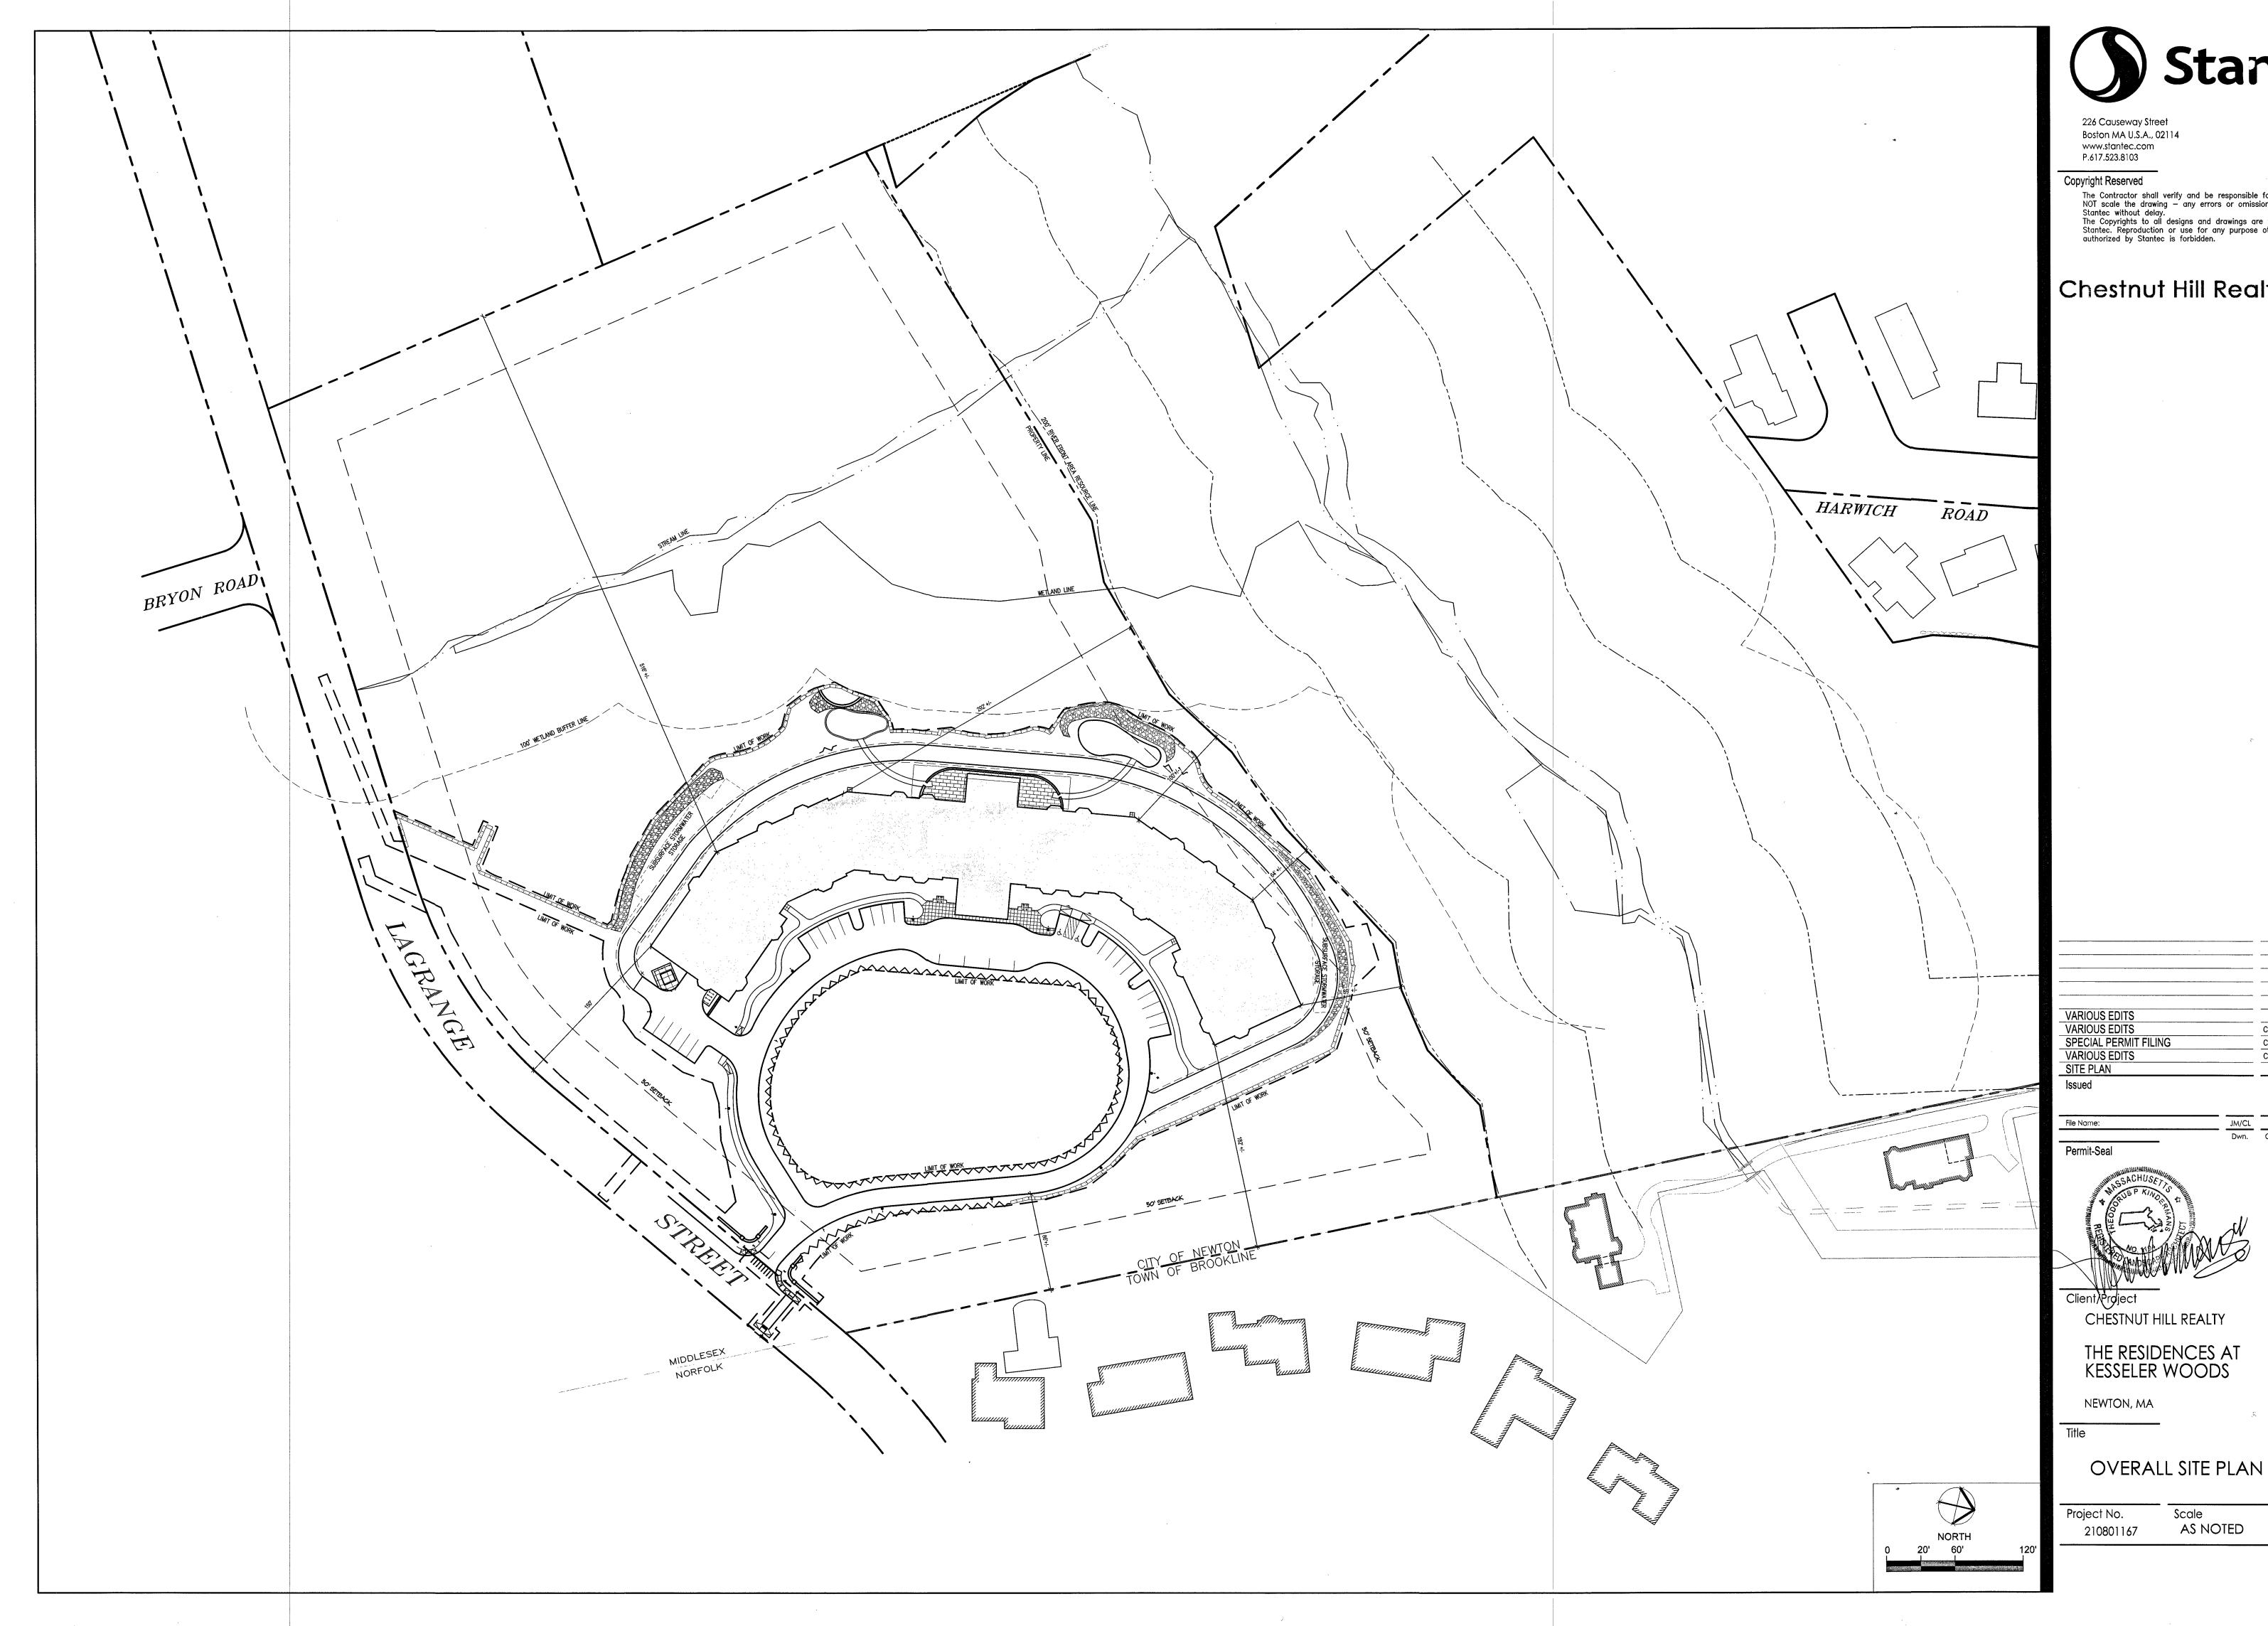



Copyright Reserved

The Contractor shall verify and be responsible for all dimensions. DO NOT scale the drawing — any errors or omissions shall be reported to Stantec without delay. The Copyrights to all designs and drawings are the property of Stantec. Reproduction or use for any purpose other than that authorized by Stantec is forbidden.

Chestnut Hill Realty



JM TPK 10.24.14 CL/JM TPK 08.29.14

 CL/JM
 TPK
 08.04.14

 CL/JM
 TPK
 07.14.14

 JM
 TPK
 11.26.13

 By
 Appd.
 MM.DD.YY

Drawing No.


L-001

Dwn. Chkd. Dsgn. MM.DD.YY

JM/C

Scale AS NOTED

SEND				
	ROPERTY LINE			
LI	IMIT OF WORK LINE			
50	D' SETBACK			
	OCK FACE			
S	ITE LIGHTING			AM
	ONCRETE PAVEMENT		STREAM	LINE
v Z⊂ v	ERTICAL GRANITE CURB		STREAT	18
ζ IN	NTEGRAL CONCRETE CURB			610
	APE COD BERM		90	
			ETH. 00 80	
		BIR		8200
	-1-			
Catcy-Basin	ere /	69		TREE WE EXISTING
		EXATS		PLAY A
				RIP RAF
1 84			Â	
	\ \			
			AND BUFFER LINE	/
	\	100' WETL	411-	, MIT OF WO
			RIP RAP SLOPE	A STOLET
			JLOPE	
	2,1 1			
				Star I and I
ÌT	1. 1.			
			NORK IS IN	
		Ling	IT OF WORK	
		` ```	MORK ~ ~	
		$\mathbf{\dot{\lambda}}$	DUMPSTER	
		· · · · · · · · · · · · · · · · · · ·	ENCLOSURE	
			LANE SIGN, TYP	
			BICYCLE RACKS	
			RETAINING WALL	
			$\mathbf{\dot{\lambda}}$	
			in its start	
				513
ARKING: DIMEN	NSIONS AND TABULAT	TIONS	~~~~~~~~~~~~~~~~~~~~~~~~~~~~~~~~~~~~~~	
	DIMENSIO		A A A A A A A A A A A A A A A A A A A	VAY TYP.
YPE	1			
YPE GARAGE PARKING	,	75 (4 110)		
GARAGE PARKING SPACES - REGULAR		35 (4 HC)		• · · ·
GARAGE PARKING				
GARAGE PARKING SPACES - REGULAR SPACES - W COLUM	INS 8'-6" X 19' 9' X 19'	, 65 10		
GARAGE PARKING SPACES - REGULAR SPACES - W/ COLUM SPACES - TANDEM SPACES - TANDEM W	INS 8'-6" X 19' 9' X 19'	, 65 10		
GARAGE PARKING SPACES - REGULAR SPACES - W/ COLUM SPACES - TANDEM SPACES - TANDEM W SPACES - TANDEM W SPACES - W/ 2' OVE	INS 8'-6" X 19' 9' X 19' N/COLUMNS 8'-6" X 19' ERHANG * 9' X 17'	, 65 10		
BARAGE PARKING SPACES - REGULAR SPACES - W/ COLUM SPACES - TANDEM SPACES - TANDEM W UTSIDE PARKING SPACES - W/ 2' OVE SPACES - HANDICAR	INS 8'-6" X 19' 9' X 19' N/COLUMNS 8'-6" X 19 ERHANG * 9' X 17' P ACCESSIBLE 8' X 18'	, 65 10 , 20 		
GARAGE PARKING SPACES - REGULAR SPACES - W/ COLUM SPACES - TANDEM SPACES - TANDEM W SPACES - TANDEM W SPACES - W/ 2' OVE	INS 8'-6" X 19' 9' X 19' N/COLUMNS 8'-6" X 19' ERHANG * 9' X 17' P ACCESSIBLE 8' X 18'	' 65 10 ' 20		
BARAGE PARKING SPACES - REGULAR SPACES - W/ COLUM SPACES - TANDEM SPACES - TANDEM W UTSIDE PARKING SPACES - W/ 2' OVE SPACES - HANDICAR	INS 8'-6" X 19' 9' X 19' N/COLUMNS 8'-6" X 19 ERHANG * 9' X 17' P ACCESSIBLE 8' X 18'	, 65 10 , 20 	SIGN WALL WITH UPLIGHTS	
GARAGE PARKING SPACES - REGULAR SPACES - W/ COLUM SPACES - TANDEM SPACES - TANDEM W SPACES - TANDEM W SPACES - W/ 2' OVE SPACES - W/ 2' OVE SPACES - HANDICAR SPACES - PARALLE	INS 8'-6" X 19' 9' X 19' N/COLUMNS 8'-6" X 19 ERHANG * 9' X 17' P ACCESSIBLE 8' X 18'	25 2 HC 3	STOP SIGN WITH	
BARAGE PARKING SPACES - REGULAR SPACES - W/ COLUM SPACES - TANDEM SPACES - TANDEM SPACES - TANDEM M SPACES - TANDEM M SPACES - W/ 2' OVE SPACES - HANDICAR SPACES - PARALLE TOTAL # OF SPACES	INS 8'-6" X 19' 9' X 19' N/COLUMNS 8'-6" X 19 ERHANG * 9' X 17' P ACCESSIBLE 8' X 18' L 9' X 22'	й 65 10 20 25 2 HC 3 160 (6 HC)		
BARAGE PARKING SPACES - REGULAR SPACES - W/ COLUM SPACES - TANDEM SPACES - TANDEM W SPACES - TANDEM W SPACES - TANDEM W SPACES - W/ 2' OVE SPACES - HANDICAR SPACES - PARALLE	INS 8'-6" X 19' 9' X 19' N/COLUMNS 8'-6" X 19 ERHANG * 9' X 17' P ACCESSIBLE 8' X 18' L 9' X 22'	25 2 HC 3	STOP SIGN WITH PAINTED STOP SIGN TYP. PAINTED CROSSWALK	
BARAGE PARKING SPACES - REGULAR SPACES - W/ COLUM SPACES - TANDEM SPACES - TANDEM UTSIDE PARKING SPACES - W/ 2' OVE SPACES - HANDICAR SPACES - PARALLE TOTAL # OF SPACES ICYCLE PARKING U - TYPE RACKS (2	INS 8'-6" X 19' 9' X 19' N/COLUMNS 8'-6" X 19 ERHANG * 9' X 17' P ACCESSIBLE 8' X 18' L 9' X 22'	й 65 10 20 25 25 2 HC 3 160 (6 HC) 16 (8 RACKS)	STOP SIGN WITH PAINTED STOP SIGN TYP. PAINTED CROSSWALK TYP.	MALK
BARAGE PARKING SPACES - REGULAR SPACES - W/ COLUM SPACES - TANDEM SPACES - TANDEM UTSIDE PARKING SPACES - W/ 2' OVE SPACES - HANDICAR SPACES - PARALLE TOTAL # OF SPACES ICYCLE PARKING U - TYPE RACKS (2	INS 8'-6" X 19' 9' X 19' N/COLUMNS 8'-6" X 19' PACCESSIBLE 8' X 18' 9' X 22' BIKES PER RACK) DN ZONING CODE, SECTION 30-19, S	й 65 10 20 25 25 2 HC 3 160 (6 HC) 16 (8 RACKS)	STOP SIGN WITH PAINTED STOP SIGN TYP. PAINTED CROSSWALK TYP.	MALK AND DLESEX
BARAGE PARKING SPACES - REGULAR SPACES - W/ COLUM SPACES - TANDEM SPACES - TANDEM UTSIDE PARKING SPACES - W/ 2' OVE SPACES - W/ 2' OVE SPACES - HANDICAR SPACES - PARALLE TOTAL # OF SPACES ICYCLE PARKING U - TYPE RACKS (2 S PER TOWN OF NEWTO	INS 8'-6" X 19' 9' X 19' A/COLUMNS 8'-6" X 19' ERHANG * 9' X 17' P ACCESSIBLE 8' X 18' L 9' X 22' BIKES PER RACK) 9' X 20' DN ZONING CODE, SECTION 30-19, S DULE	й 65 10 20 25 25 2 HC 3 160 (6 HC) 16 (8 RACKS)	STOP SIGN WITH PAINTED STOP SIGN TYP. PAINTED CROSSWALK TYP.	MALK MORFOLK
BARAGE PARKING SPACES - REGULAR SPACES - W/ COLUM SPACES - TANDEM SPACES - TANDEM DUTSIDE PARKING SPACES - W/ 2' OVE SPACES - HANDICAR SPACES - PARALLE TOTAL # OF SPACES ICYCLE PARKING U - TYPE RACKS (2 S PER TOWN OF NEWTO TE SIGN SCHE	INS 8'-6" X 19' 9' X 19' A/COLUMNS 8'-6" X 19' ERHANG * 9' X 17' P ACCESSIBLE 8' X 18' L 9' X 22' BIKES PER RACK) 9' X 20' DN ZONING CODE, SECTION 30-19, S DULE	' 65 10 ' 20 25 2 HC 3 3 160 (6 HC) 160 (6 HC) 16 (8 RACKS) 50BPARAGRAPH (H)(2)(d).	STOP SIGN WITH PAINTED STOP SIGN TYP. PAINTED CROSSWALK TYP.	MALK MIDDLESEX NORFOLK
BARAGE PARKING SPACES - REGULAR SPACES - W/ COLUM SPACES - TANDEM SPACES - TANDEM DUTSIDE PARKING SPACES - W/ 2' OVE SPACES - HANDICAF SPACES - PARALLE TOTAL # OF SPACES ICYCLE PARKING U - TYPE RACKS (2 S PER TOWN OF NEWTO TE SIGN SCHE DIGN# COPY 1 HANDICAP P	INS 8'-6" X 19' 9' X 19' A/COLUMNS 8'-6" X 19' ERHANG * 9' X 17' P ACCESSIBLE 8' X 18' L 9' X 22' BIKES PER RACK) 9' X 22' PN ZONING CODE, SECTION 30-19, S DULE PARKING-VAN	' 65 10 ' ' 20 25 2 HC 3 160 (6 HC) 16 (8 RACKS) SUBPARAGRAPH (H)/(2)/(d). # REQ'D. 1	STOP SIGN WITH PAINTED STOP SIGN TYP. PAINTED CROSSWALK TYP.	MALK MIDDLESEX NORFOLK
BARAGE PARKING SPACES - REGULAR SPACES - W/ COLUM SPACES - TANDEM SPACES - TANDEM UTSIDE PARKING SPACES - W/ 2' OVE SPACES - HANDICAF SPACES - HANDICAF SPACES - PARALLE TOTAL # OF SPACES ICYCLE PARKING U - TYPE RACKS (2 S PER TOWN OF NEWTO TE SIGN SCHE OIGN# COPY 1 HANDICAP P 2 HANDICAP P	INS 8'-6" X 19' 9' X 19' A/COLUMNS 8'-6" X 19' ERHANG * 9' X 17' P ACCESSIBLE 8' X 18' L 9' X 22' BIKES PER RACK) 9' X 22' PN ZONING CODE, SECTION 30-19, S DULE PARKING-VAN	' 65 10 ' 20 25 2 HC 3 3 160 (6 HC) 160 (6 HC) 16 (8 RACKS) 50BPARAGRAPH (H)(2)(d).	STOP SIGN WITH PAINTED STOP SIGN TYP. PAINTED CROSSWALK TYP.	MALK MIDDLESEX NORFOLK
BARAGE PARKING SPACES - REGULAR SPACES - W/ COLUM SPACES - TANDEM SPACES - TANDEM UTSIDE PARKING SPACES - W/ 2' OVE SPACES - W/ 2' OVE SPACES - HANDICAF SPACES - PARALLE TOTAL # OF SPACES ICYCLE PARKING U - TYPE RACKS (2 S PER TOWN OF NEWTO TE SIGN SCHE DIGN# COPY 1 HANDICAP P 2 HANDICAP P 3 DO NOT ENTI 4 STOP SIGN	NS 8'-6" X 19' 9' X 19' AVCOLUMNS 8'-6" X 19' P' X 17' P ACCESSIBLE 8' X 18' 1 9' X 22' BIKES PER RACK) DN ZONING CODE, SECTION 30-19, S DULE 'ARKING-VAN 'ARKING	' 65 10 . 20 . 25 2 HC 3 . 160 (6 HC) . 16 (8 RACKS) . BUBPARAGRAPH (H)(2)(d). . 1 2	STOP SIGN WITH PAINTED STOP SIGN TYP. PAINTED CROSSWALK TYP.	MALK MIDDLESEX NORFOLK
BARAGE PARKING SPACES - REGULAR SPACES - W/ COLUM SPACES - TANDEM SPACES - TANDEM DUTSIDE PARKING SPACES - W/ 2' OVE SPACES - HANDICAF SPACES - HANDICAF SPACES - PARALLE TOTAL # OF SPACES ICYCLE PARKING U - TYPE RACKS (2 S PER TOWN OF NEWTO TE SIGN SCHE DIGN# COPY 1 HANDICAP P 2 HANDICAP P 3 DO NOT ENTI 4 STOP SIGN 5 ONE WAY	NS 8'-6" X 19' 9' X 19' AVCOLUMNS 8'-6" X 19' P' X 17' P ACCESSIBLE 8' X 18' 1 9' X 22' BIKES PER RACK) DN ZONING CODE, SECTION 30-19, S DULE 'ARKING-VAN 'ARKING	' 65 10 . 20 . 25 2 HC 3 . 160 (6 HC) . 16 (8 RACKS) . BUBPARAGRAPH (H)(2)(d). . 1 2	STOP SIGN WITH PAINTED STOP SIGN TYP. PAINTED CROSSWALK TYP.	MALK MDDLESEX NORFOLK

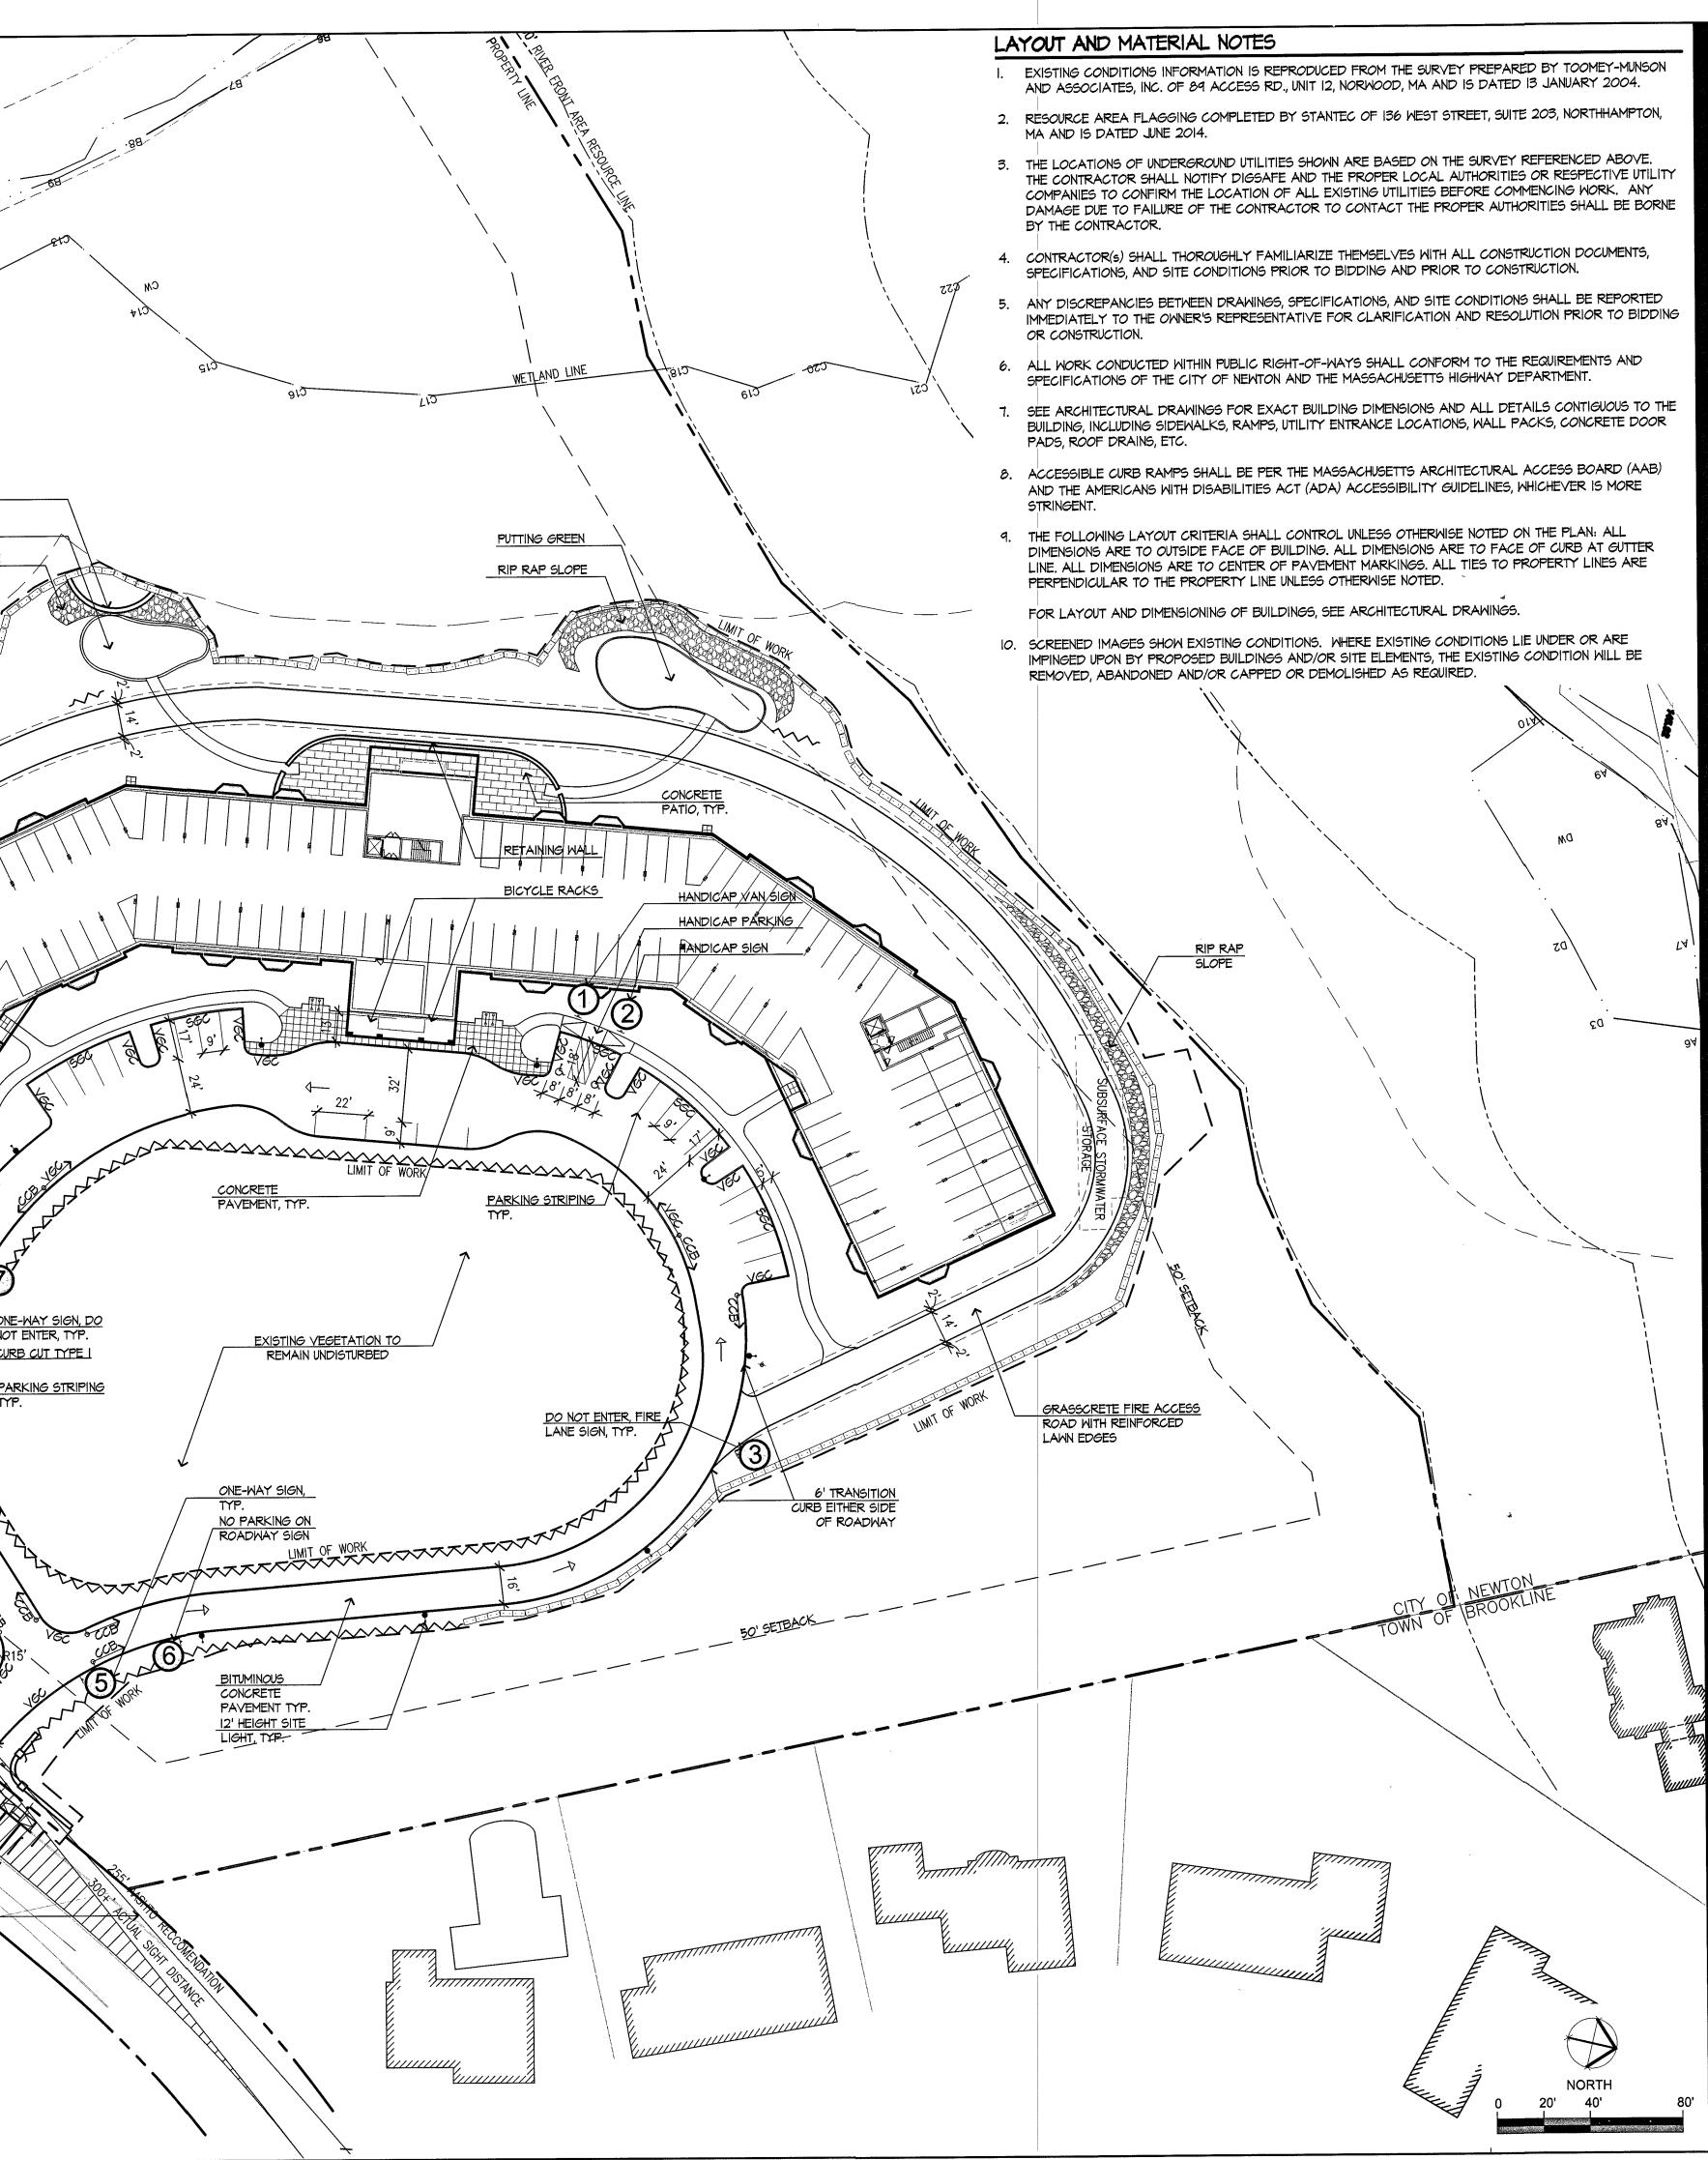



Copyright Reserved

The Contractor shall verify and be responsible for all dimensions. DO NOT scale the drawing — any errors or omissions shall be reported to Stantec without delay. The Copyrights to all designs and drawings are the property of Stantec. Reproduction or use for any purpose other than that authorized by Stantec is forbidden.


Chestnut Hill Realty (



	<u> </u>		
			<u> </u>
VARIOUS EDITS	JM	ТРК	10.24.14
VARIOUS EDITS	CL/JM	TPK	08.29.14
SPECIAL PERMIT FILING	CL/JM	TPK	08.04.14
VARIOUS EDITS	CL/JM	TPK	07.14.14
SITE PLAN	JM	TPK	11.26.13
Issued	By	Appd.	MM.DD.YY

File Name:

Permit-Seal

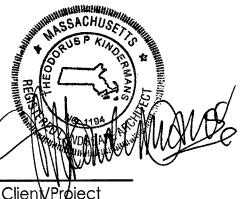

CHESTNUT HILL REALTY

THE RESIDENCES AT KESSELER WOODS

NEWTON, MA


Title

LAYOUT AND MATERIALS PLAN

Project No. 210801167 Scale AS NOTED


> Drawing No. L-100

JM/CL Dwn. Chkd. Dsgn. MM.DD.YY

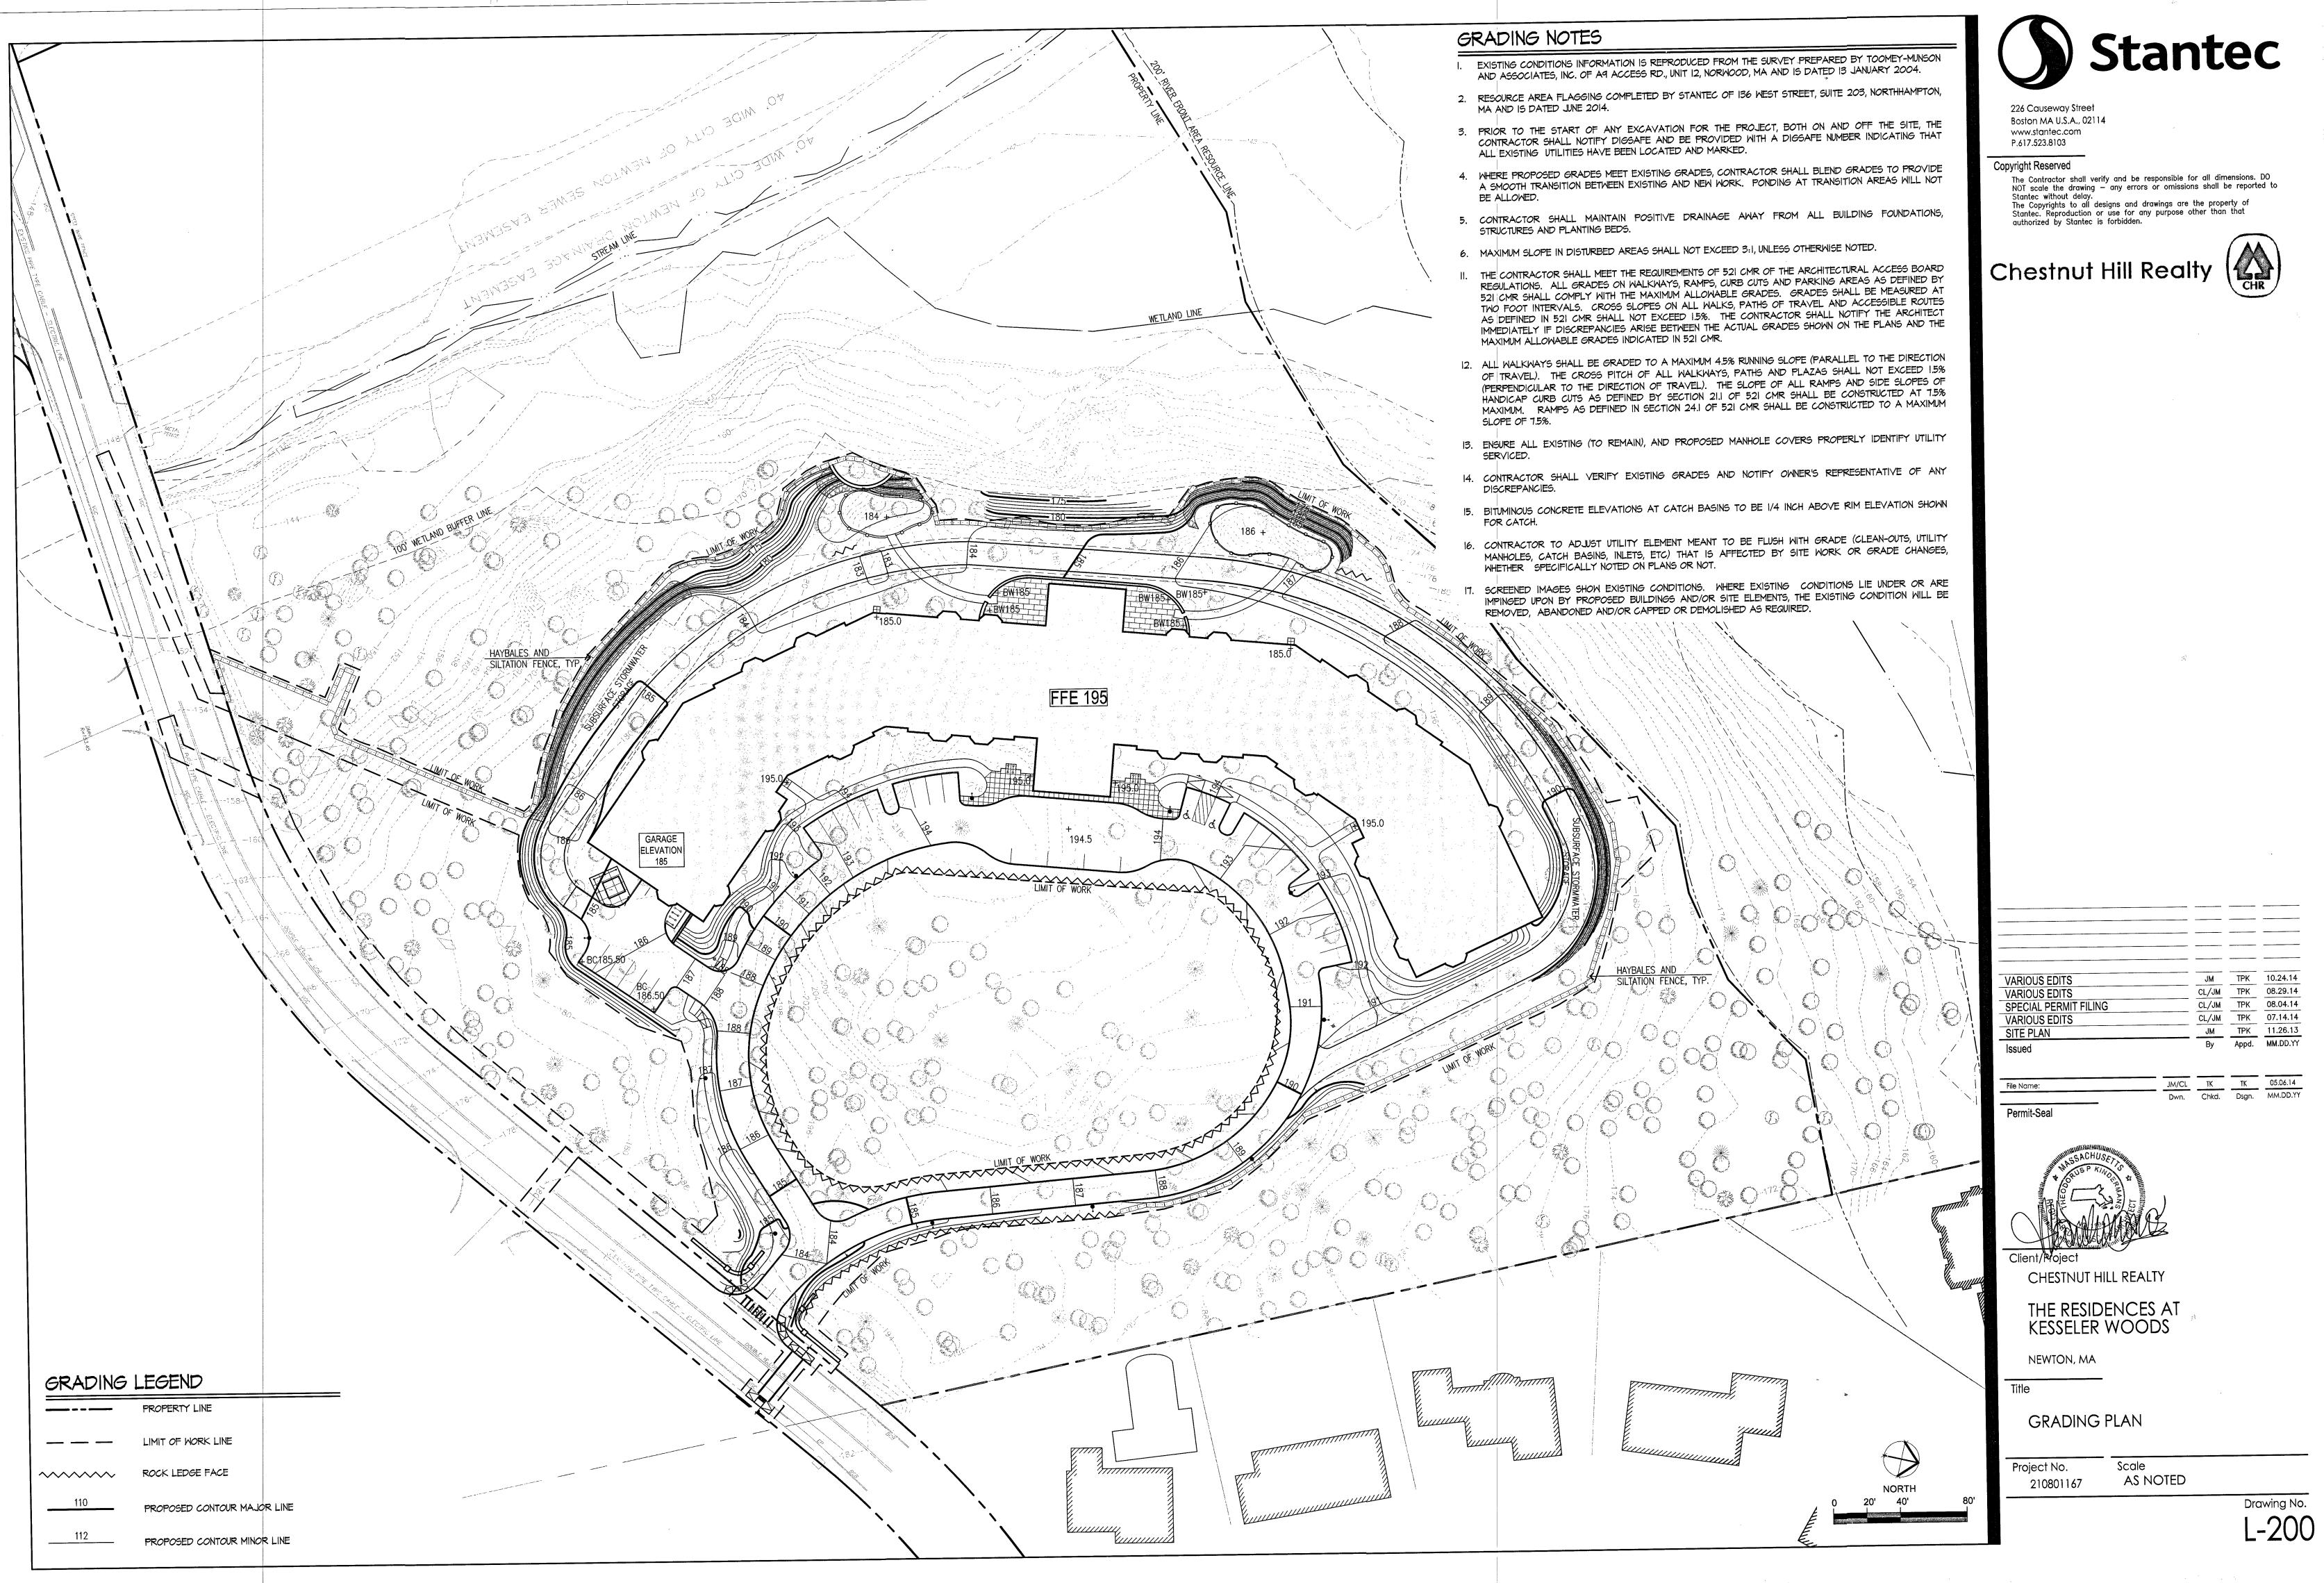

VARIOUS EDITS	JM	ТРК	10.24.14
VARIOUS EDITS	CL/JM	TPK	08.29.14
SPECIAL PERMIT FILING	CL/JM	TPK	08.04.14
VARIOUS EDITS	CL/JM	TPK	07.14.14
SITE PLAN	JM	TPK_	11.26.13
Issued	Ву	Appd.	MM.DD.YY
			05.06.14



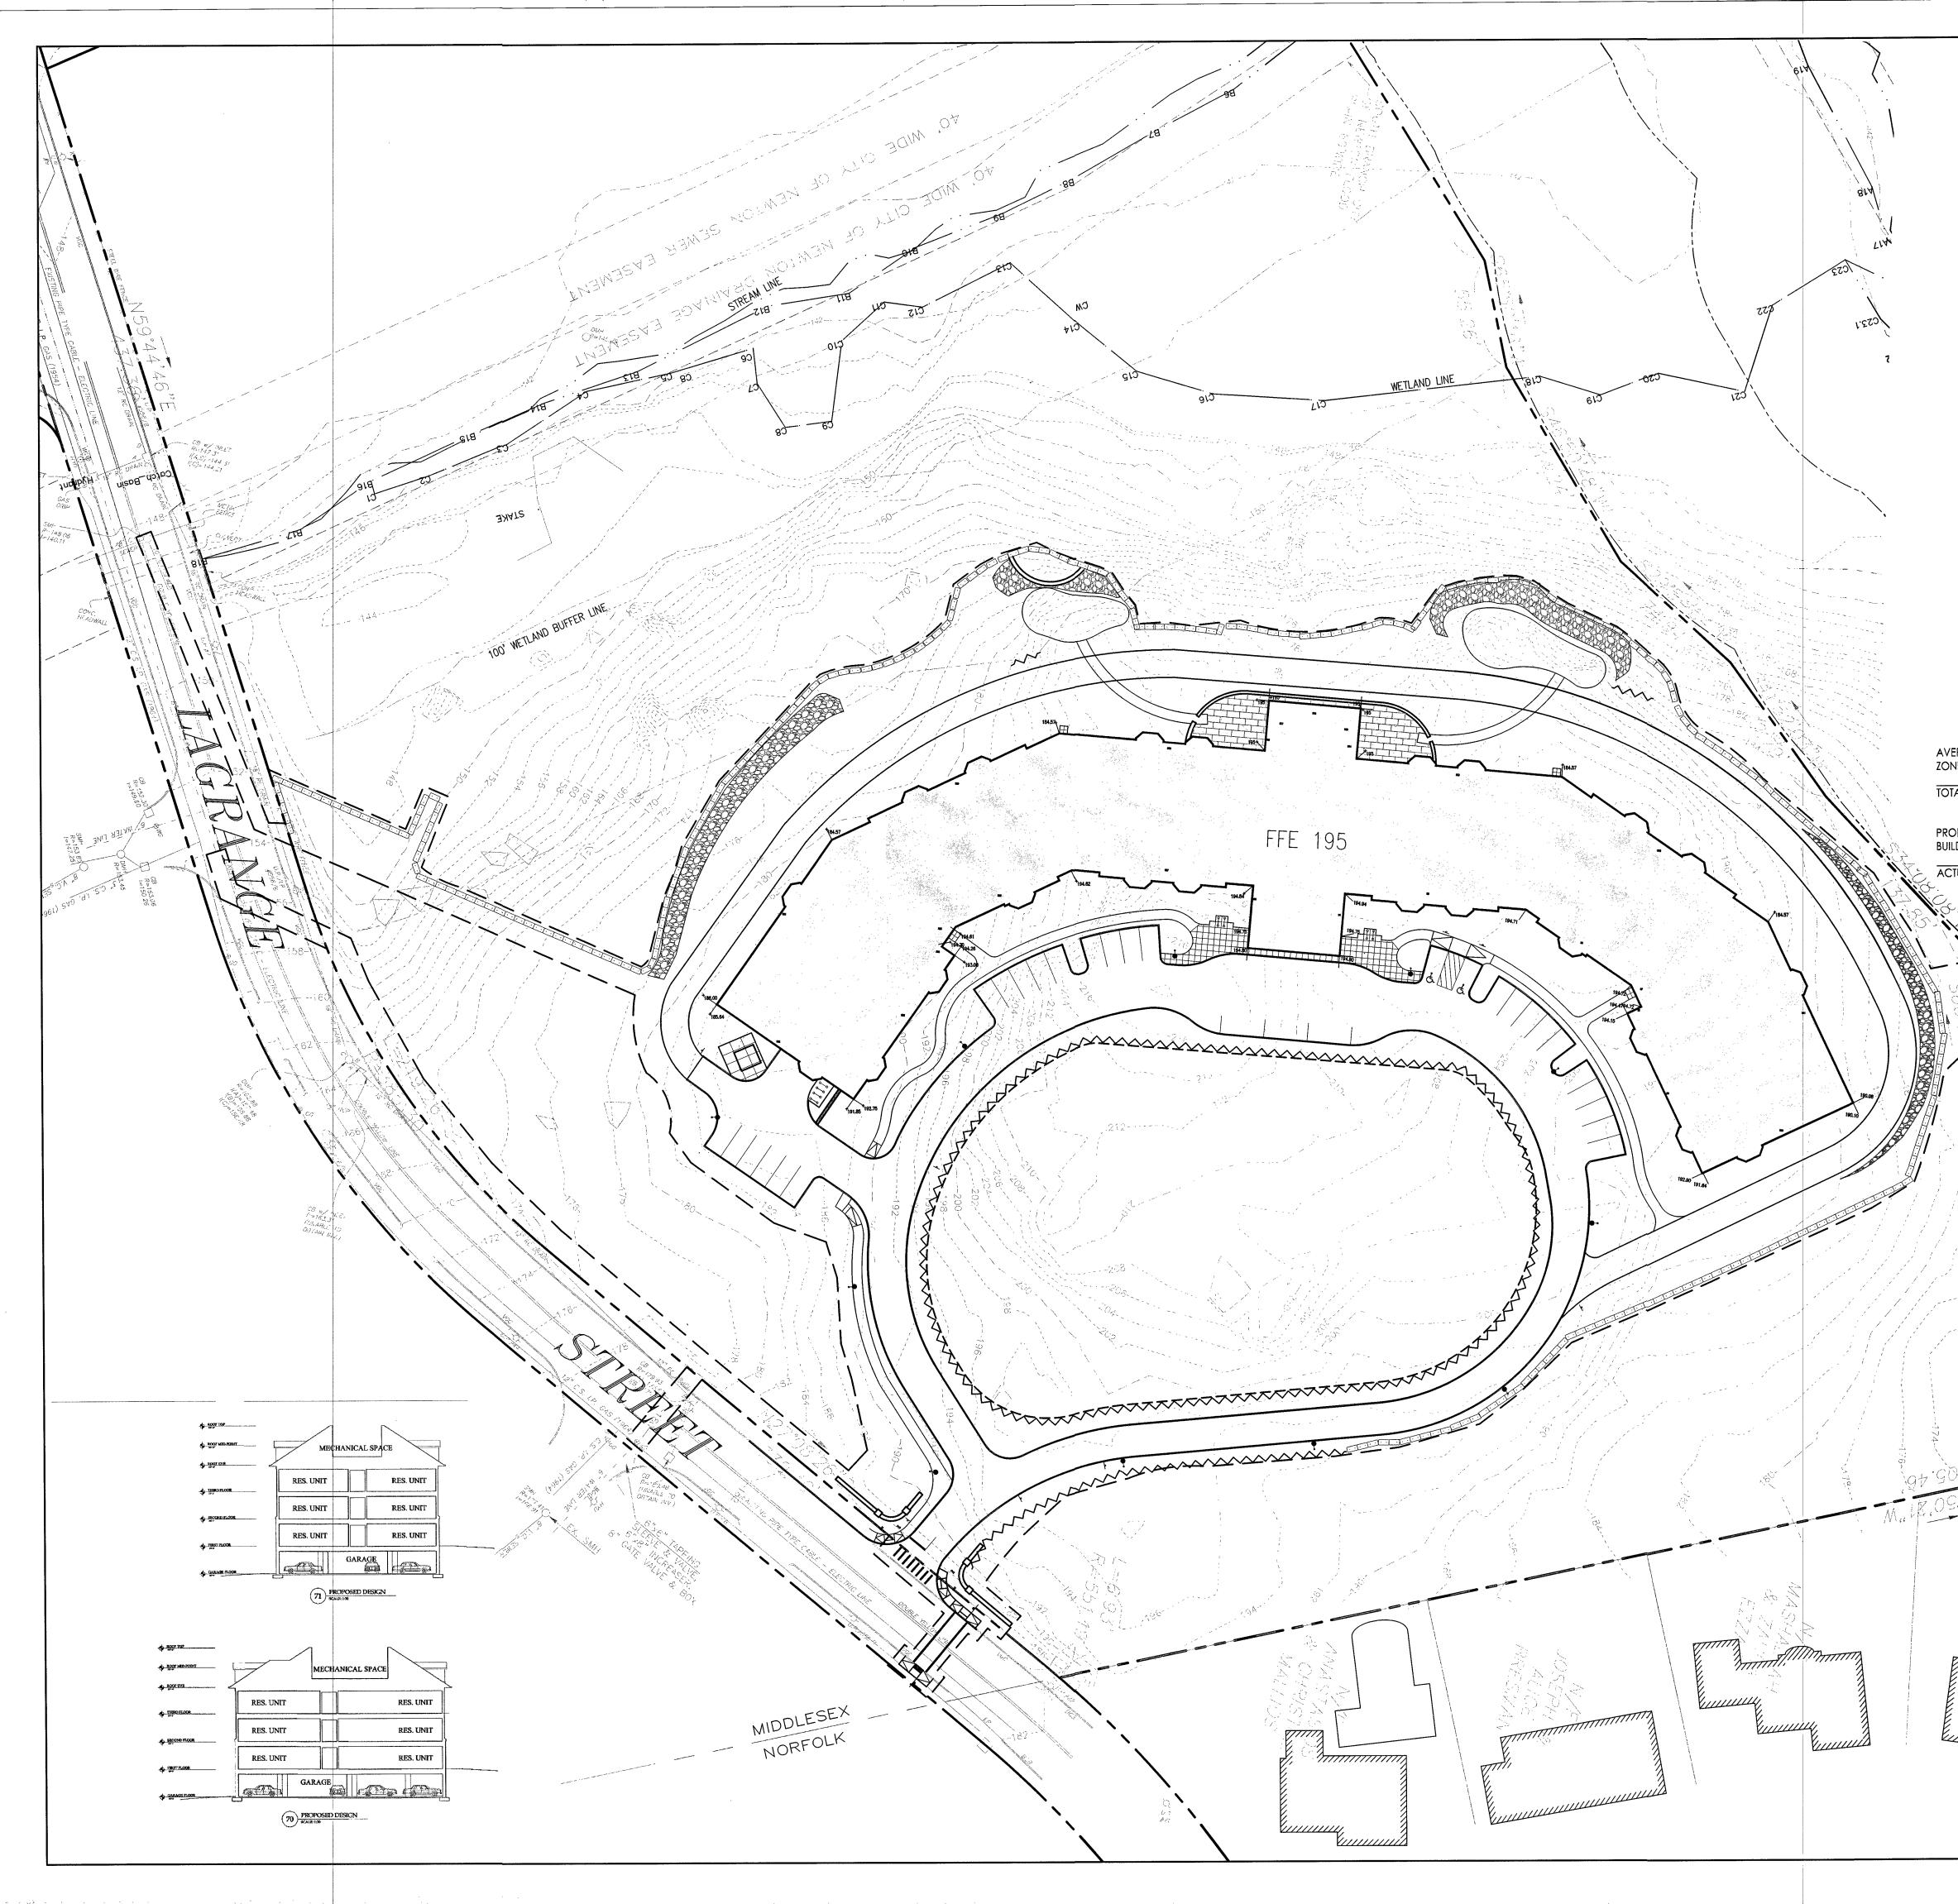




Copyright Reserved

The Contractor shall verify and be responsible for all dimensions. DO NOT scale the drawing — any errors or omissions shall be reported to Stantec without delay. The Copyrights to all designs and drawings are the property of Stantec. Reproduction or use for any purpose other than that authorized by Stantec is forbidden.

	E GRADE PLAN CODE TABLE 1	190.65' 48'	
TOTAL HE	IGHT ALLOWED	237.65	
	D BUILDING FINISH FLOOR ELEVATION HEIGHT TO MIDPOINT OF ROOF	195.00' 40.80'	
	BUILDING HEIGHT	235.8'	
	* (a) PER HEIGHT CALCULATION DEFINI THE NEW CODE ONLINE ZONING BY LA AND 9		E 8

VARIOUS EDITSJMTPK10.24.14VARIOUS EDITSCL/JMTPK08.29.14SPECIAL PERMIT FILINGCL/JMTPK08.04.14VARIOUS EDITSCL/JMTPK07.14.14SITE PLANJMTPK11.26.13IssuedByAppd.MM.DD.YY

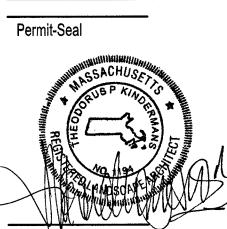

Clieht/Project CHESTNUT HILL REALTY

THE RESIDENCES AT KESSELER WOODS

NEWTON, MA

Title

NORTH


40'

20'

HEIGHT CALCULATION PLAN

Project No. 210801167

Scale AS NOTED

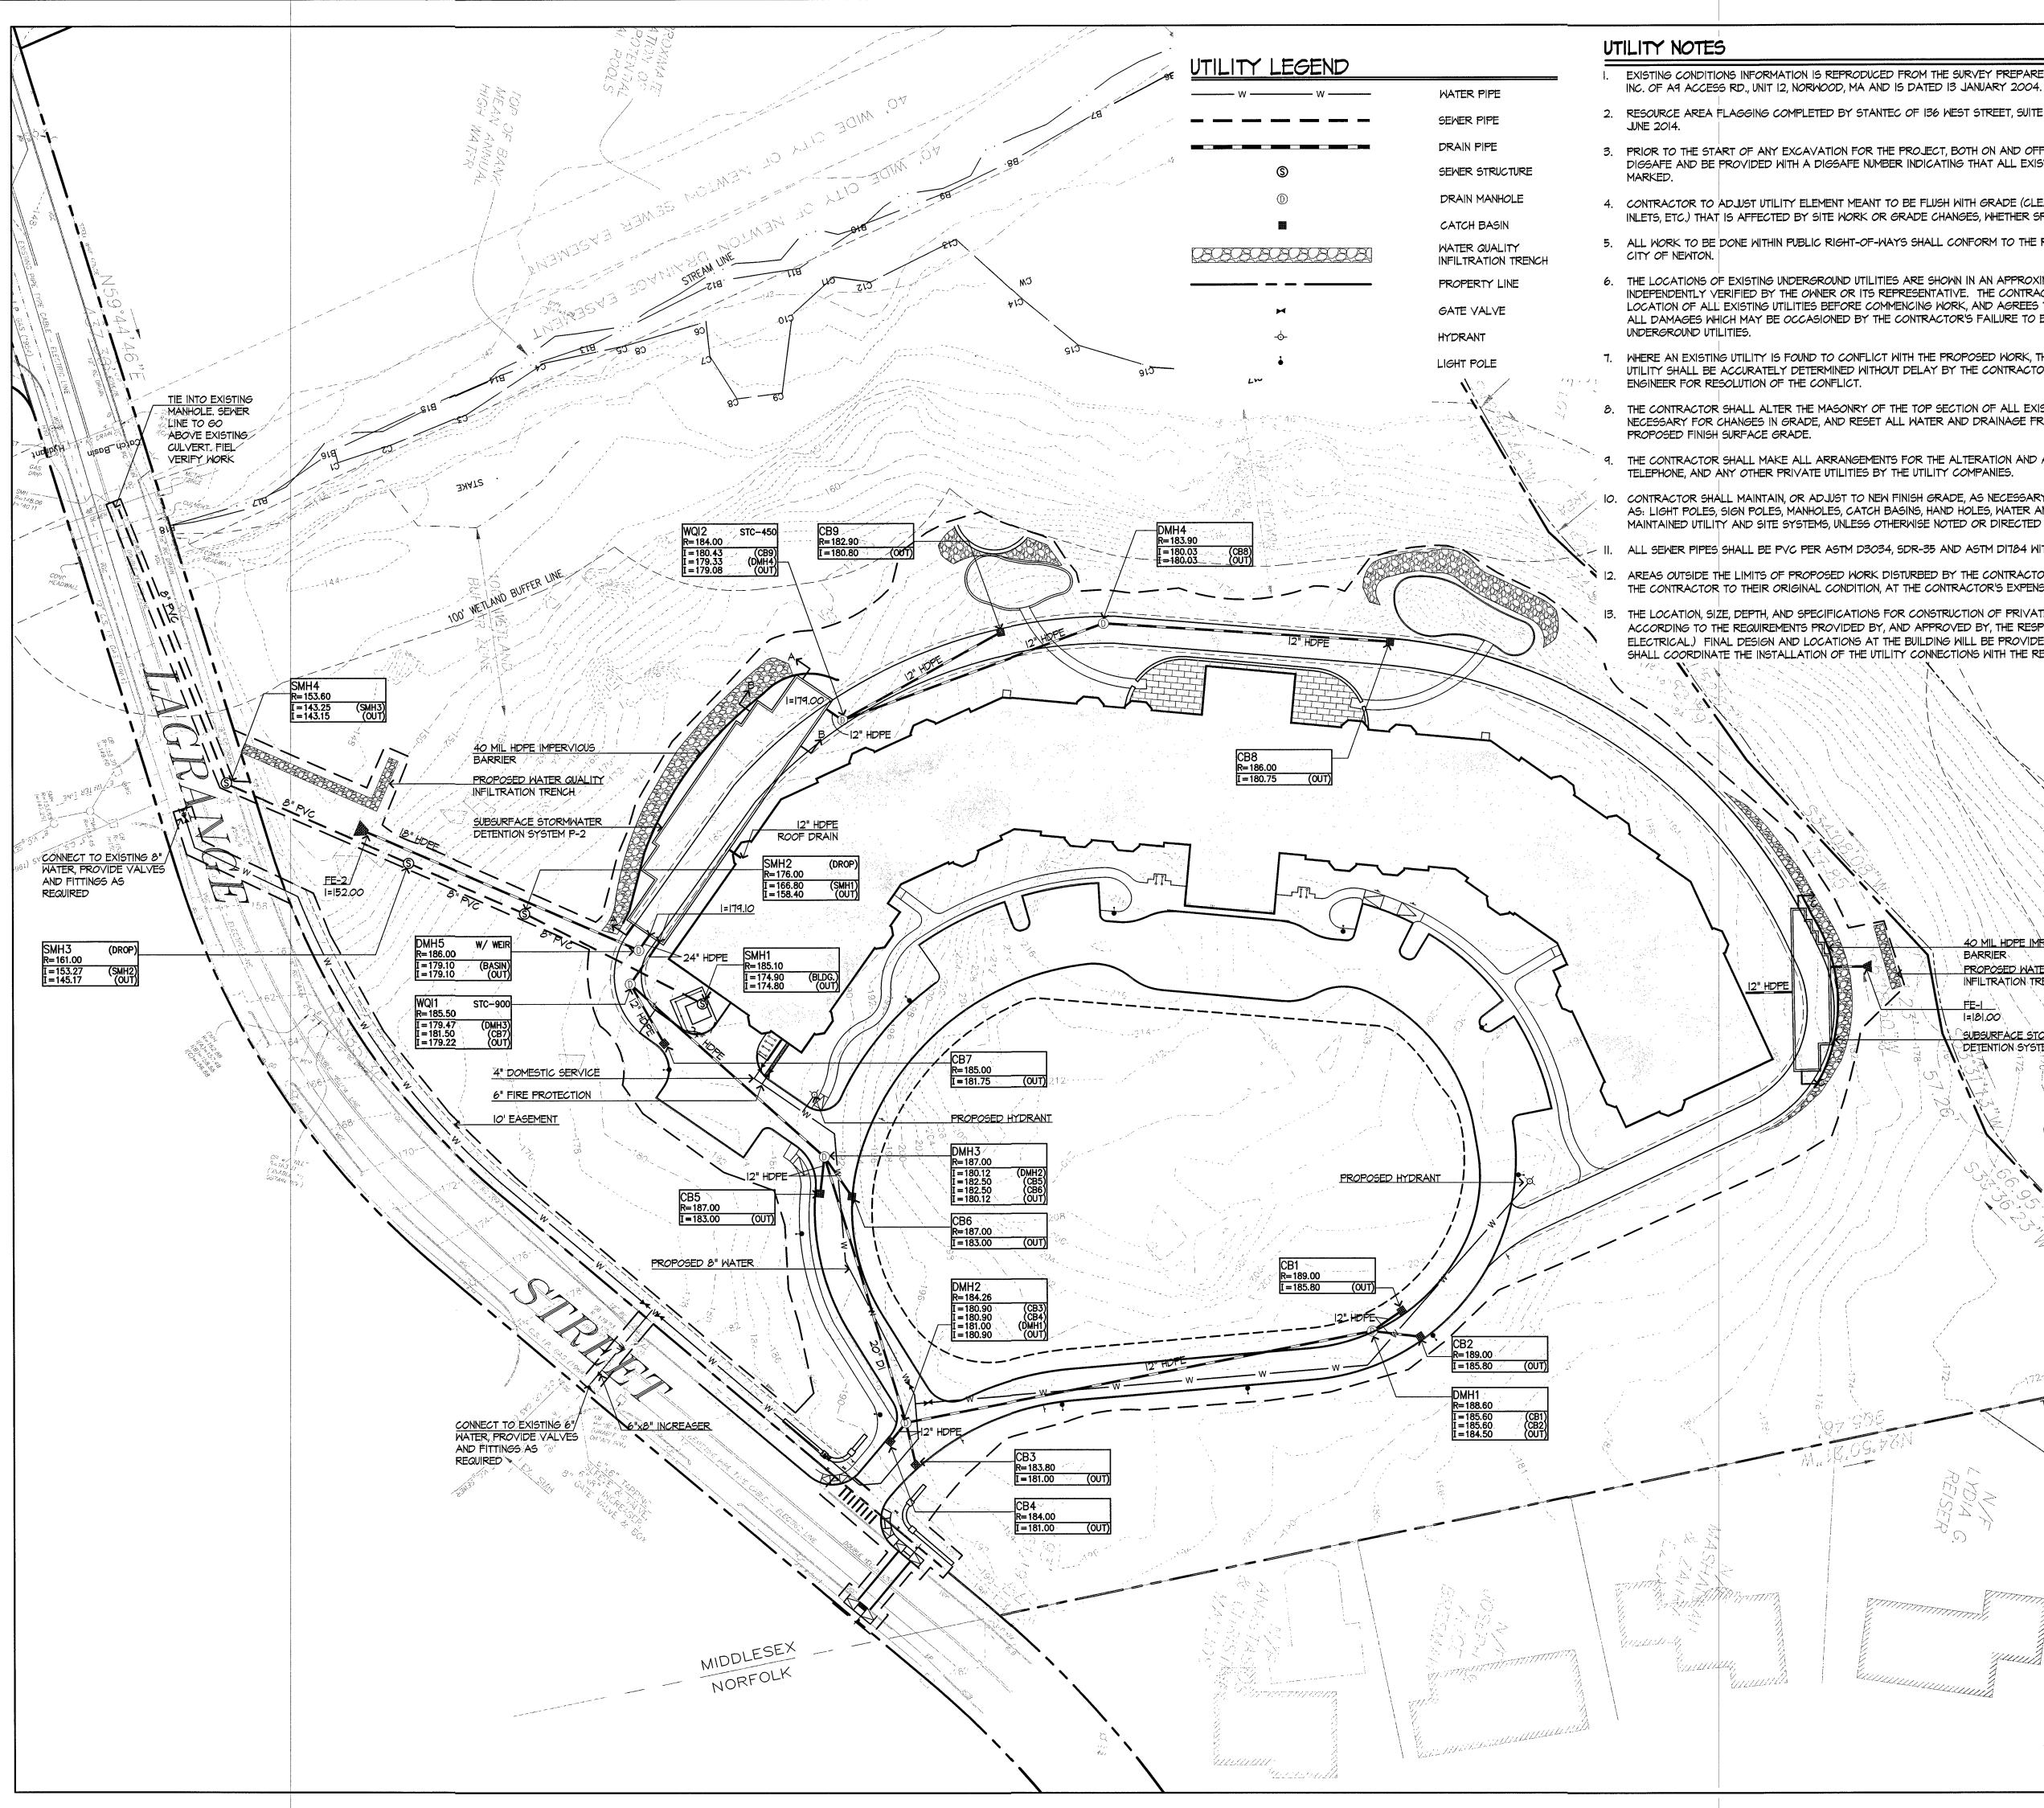

. EXISTING CONDITIONS INFORMATION IS REPRODUCED FROM THE SURVEY PREPARED BY TOOMEY-MUNSON AND ASSOCIATES

2. RESOURCE AREA FLAGGING COMPLETED BY STANTEC OF 136 WEST STREET, SUITE 203, NORTHHAMPTON, MA AND IS DATED

3. PRIOR TO THE START OF ANY EXCAVATION FOR THE PROJECT, BOTH ON AND OFF THE SITE, THE CONTRACTOR SHALL NOTIFY DIGSAFE AND BE PROVIDED WITH A DIGSAFE NUMBER INDICATING THAT ALL EXISTING UTILITIES HAVE BEEN LOCATED AND

4. CONTRACTOR TO ADJUST UTILITY ELEMENT MEANT TO BE FLUSH WITH GRADE (CLEAN-OUTS, UTILITY MANHOLES, CATCH BASINS, INLETS, ETC.) THAT IS AFFECTED BY SITE WORK OR GRADE CHANGES, WHETHER SPECIFICALLY NOTED ON PLANS OR NOT.

5. ALL WORK TO BE DONE WITHIN PUBLIC RIGHT-OF-WAYS SHALL CONFORM TO THE REQUIREMENTS AND SPECIFICATIONS OF THE

6. THE LOCATIONS OF EXISTING UNDERGROUND UTILITIES ARE SHOWN IN AN APPROXIMATE WAY ONLY AND HAVE NOT BEEN INDEPENDENTLY VERIFIED BY THE OWNER OR ITS REPRESENTATIVE. THE CONTRACTOR SHALL DETERMINE THE EXACT LOCATION OF ALL EXISTING UTILITIES BEFORE COMMENCING WORK, AND AGREES TO BE FULLY RESPONSIBLE FOR ANY AND ALL DAMAGES WHICH MAY BE OCCASIONED BY THE CONTRACTOR'S FAILURE TO EXACTLY LOCATE AND PRESERVE ALL

WHERE AN EXISTING UTILITY IS FOUND TO CONFLICT WITH THE PROPOSED WORK, THE LOCATION, ELEVATION, AND SIZE OF THE UTILITY SHALL BE ACCURATELY DETERMINED WITHOUT DELAY BY THE CONTRACTOR, AND THE INFORMATION FURNISHED TO THE

THE CONTRACTOR SHALL ALTER THE MASONRY OF THE TOP SECTION OF ALL EXISTING DRAINAGE STRUCTURES AS NECESSARY FOR CHANGES IN GRADE, AND RESET ALL WATER AND DRAINAGE FRAMES, GRATES, AND BOXES TO THE

THE CONTRACTOR SHALL MAKE ALL ARRANGEMENTS FOR THE ALTERATION AND ADJUSTMENT OF ALL GAS, ELECTRIC,

IO. CONTRACTOR SHALL MAINTAIN, OR ADJUST TO NEW FINISH GRADE, AS NECESSARY ALL UTILITY AND SITE STRUCTURES SUCH AS: LIGHT POLES, SIGN POLES, MANHOLES, CATCH BASINS, HAND HOLES, WATER AND GAS GATES, HYDRANTS, ETC., FROM MAINTAINED UTILITY AND SITE SYSTEMS, UNLESS OTHERWISE NOTED OR DIRECTED BY OWNER'S REPRESENTATIVE.


ALL SEWER PIPES SHALL BE PVC PER ASTM D3034, SDR-35 AND ASTM D1784 WITH RUBBER GASKET JOINTS.


AREAS OUTSIDE THE LIMITS OF PROPOSED WORK DISTURBED BY THE CONTRACTOR'S OPERATIONS SHALL BE RESTORED BY THE CONTRACTOR TO THEIR ORIGINAL CONDITION, AT THE CONTRACTOR'S EXPENSE.

THE LOCATION, SIZE, DEPTH, AND SPECIFICATIONS FOR CONSTRUCTION OF PRIVATE UTILITY SERVICES SHALL BE INSTALLED ACCORDING TO THE REQUIREMENTS PROVIDED BY, AND APPROVED BY, THE RESPECTIVE UTILITY COMPANY (GAS, TELEPHONE, ELECTRICAL.) FINAL DESIGN AND LOCATIONS AT THE BUILDING WILL BE PROVIDED BY THE ARCHITECT. THE CONTRACTOR SHALL COORDINATE THE INSTALLATION OF THE UTILITY CONNECTIONS WITH THE RESPECTIVE COMPANIES PRIOR TO ANY

> O MIL HOPE IMRERVIOUS BARRIER PROPOSED WATER QUALITY 1=181.00

SUBSURFACE STORMWATER

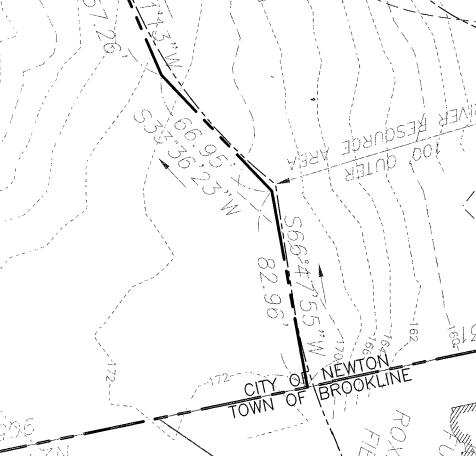

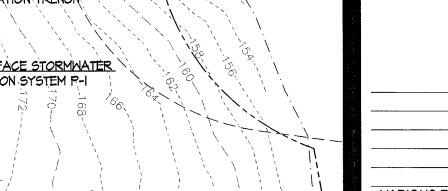

٤Q .



226 Causeway Street Boston MA U.S.A., 02114 www.stantec.com P.617.523.8103


Copyright Reserved

The Contractor shall verify and be responsible for all dimensions. DO NOT scale the drawing - any errors or omissions shall be reported to Stantec without delay. The Copyrights to all designs and drawings are the property of Stantec. Reproduction or use for any purpose other than that authorized by Stantec is forbidden.

Chestnut Hill Realty



VARIOUS EDITS ТРК 10.24.14 VARIOUS EDITS CL/JM TPK 08.29.14 SPECIAL PERMIT FILING TPK 08.04.14 CL/JM VARIOUS EDITS CL/JM TPK 07.14.14 JM TPK 11.26.13 SITE PLAN Appd. MM.DD.YY By Issued File Name: JM/CL Dwn. Chkd. Dsgn. MM.DD.YY

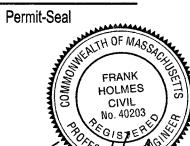

NAND

Client/Project CHESTNUT HILL REALTY

THE RESIDENCES AT **KESSELER WOODS**

NEWTON, MA

UTILITY PLAN

Title

Project No. 210801167


Scale AS NOTED



 \bigcirc

NORTH

40'

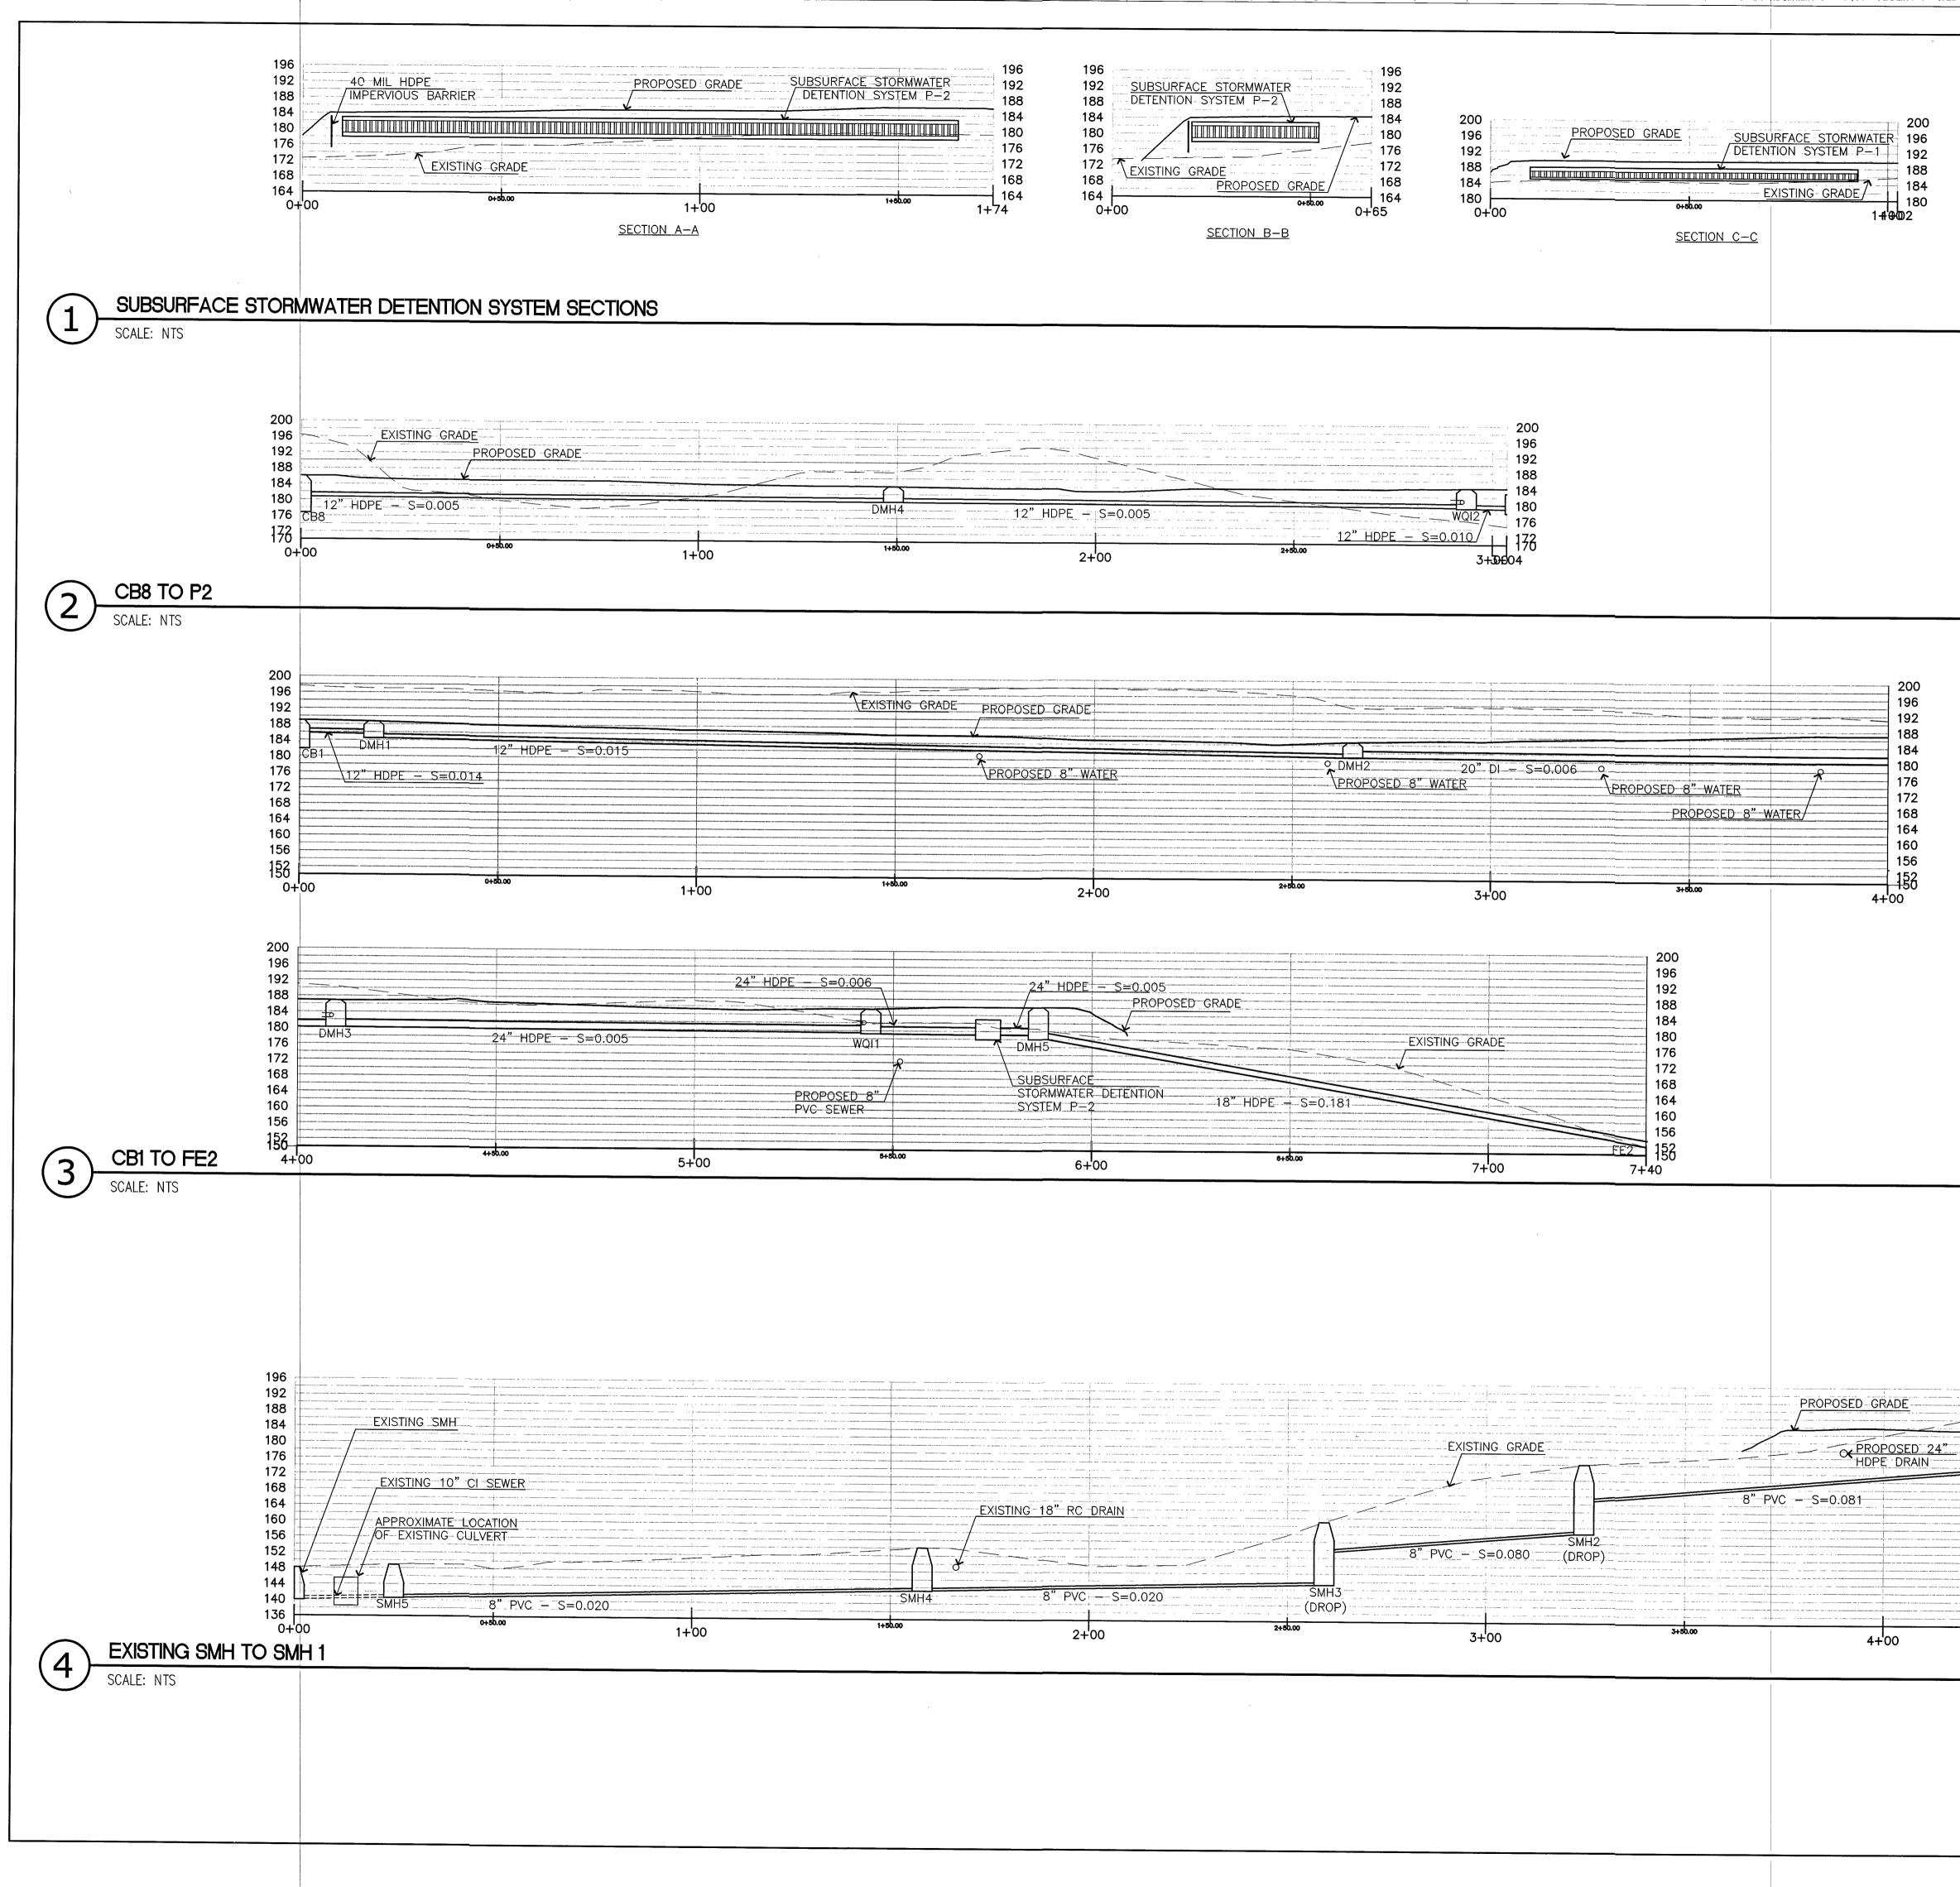



Copyright Reserved

The Contractor shall verify and be responsible for all dimensions. DO NOT scale the drawing - any errors or omissions shall be reported to Stantec without delay. The Copyrights to all designs and drawings are the property of Stantec. Reproduction or use for any purpose other than that authorized by Stantec is forbidden.

Chestnut Hill Realty



200

192

188

184

180

188

160

144


140

136

4+27

VARIOUS EDITS TPK 10.24.14 JM VARIOUS EDITS CL/JM TPK 08.29.14 SPECIAL PERMIT FILING CL/JM TPK 08.04.14 VARIOUS EDITS CL/JM TPK 07.14.14 SITE PLAN
 JM
 TPK
 11.26.13

 By
 Appd.
 MM.DD.YY
 Issued JM/CL File Name: Dwn. Chkd. Dsgn. MM.DD.YY Permit-Seal

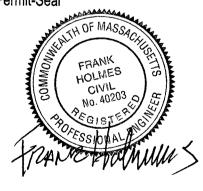

Client/Project CHESTNUT HILL REALTY

THE RESIDENCES AT KESSELER WOODS

NEWTON, MA


Title


UTILITY PROFILES

Project No. 210801167

Scale 1" = 20'

LANT SCH	EDULE					PERENNIALS/GRASSES AS ASTILBE 'SNOWDRIFT'	ASTILBE	#2 POT	
SYMBOL BOTA		COMMON NAME	QTY	SIZE	COMMENT	ASB ASTILBE 'BURGUNDY RED' HP HOSTA 'PATRIOT'	ASTILBE HOSTA	#2 POT #2 POT #2 POT	
AG ACER (GRISEUM	PAPERBARK MAPLE	1	3 -3 1/2" CAL.		HK HOSTA 'KROSS REGAL' IV IRIS VERSICOLOR	HOSTA IRIS	#2 POT #2 POT	
	SACCHARUM SIA TRIANCANTHOS	SUGAR MAPLE HONEY LOCUST	21 35	3 −3 1/2" CAL. 3 −3 1/2" CAL.		MA MATTECUCCUA STRUTHIOPTERIS OC OSMUNDA CINNAMONEA	OSTRICH FERN CINNAMON FERN	#2 POT #1 POT	
	NDRON TULIPIFERA	TULIP TREE	37	3 -3 1/2" CAL.		SS SCHIZACEHYMON SCOPARIUM	LITTLE BLUE STEM	#1 POT	
AA AMELAI	NCHIER ARBOREA	SERVICEBERRY PAPER BIRCH	45	3 -3 1/2" CAL. 3 -3 1/2" CAL.	MULTISTEM TRIPLE CLUMP	X		LEGEND	
CC CERCIS	CANADENSIS IUS CAROLINIANA	EASTERN REDBUD BRADFORD PEAR	31	3 -3 1/2" CAL. 3 -3 1/2" CAL.				\sim	
HV HAMAM	IALIS VIRGINIANA	WITCH-HAZEL	24	3 -3 1/2" CAL.				+ DECIDUOUS TREE	
	CONCOLOR	WHITE FIR	44	8-10' / 3" CAL					
	ECYPARIS 'FILIFERA AUREA' NIGRA 'AUSTRIACA'	CHAMAECYPARIS AUSTRIAN PINE	19 60	8-10' / 3" CAL 8-10' / 3" CAL				EVERGREEN TREE	
	STROBUS OCCIDENTALIS × 'GREEN GIANT'	WHITE PINE GREEN GIANT ARBORVITAE	146 67	8-10' / 3" CAL 8-10' / 3" CAL				OOO EVERGREEN SHRUBS ··· VINES	
DECIDUOUS SHRUBS								LIMIT OF WORK	
AZ AZALE.	A ABORESCENS	AZALEA SUMMERSWEET						PROPERTY LINE CONTRACT ROCK LEDGE FACE	
COA CORNU	RA ALNIFOLIA 'SIXTEEN CANDLES'	'ARCTIC FIRE' DOGWOOD							
	IS 'BUDS YELLOW' RGILLA GARDENII	'BUDS YELLOW' DOGWOOD FOTHERGILLA				gw		Cla /	460
	THIS X INTERMEDIA 'SPECTABILIS'	FORSYTHIA LIMELIGHT HYDRANGEA					LW		
	A LATIFOLIA	MOUNTAIN LAUREL							
ILS ILEX X	BLUE PRINCE	'BLUE PRINCE' HOLLY 'BLUE PRINCESS' HOLLY						Non Internet	• X
RD RHODO	BLUE PRINCESS DDENDRON 'MIDNIGHT RUBY'	MIDNIGHT RUBY' HYDRANGEA							х Х. Х.
VINES HA HYDRA	NGEA ANOMOLA 'PETIOLARIS'	CLIMBING HYDRANGEA	17	#5 POT	BASE OF LEDGE			<u>4 GT</u>	
a Conc				and the			A AS		
MEADWALL		THEFER LINE	The second			G CONO	d = d	THE WORK	
	r c	TO WETLAND BUILD		\bigcirc	OF WORK T			<u>eq e</u>	
				en si	the cont		IS The state of th	1 AS 6 AS	
		all the second s			ST	3 AA		3 BP 2 PN	∽ []
	_0-0 ¥					OP - C			3 AA
12	ps C C C					\sim			
		0		S BP					
					25				
	The Alexander								Jan J
		5 IO							- ZO
		PO MIT OF MOR						E P CON	
	6 10	Cor Contraction		Television de la companya de la comp					
LO IRIC L						$\frac{35}{17} \xrightarrow{2} \frac{35}{17} \xrightarrow{4} \frac{35}{100}$	$\begin{array}{c} 2 BP \\ \hline 2 BP \\ \hline 2 D \\ 55 OC \\ 1 OC \\ \hline 2 BP \\ \hline 2 D \\ 55 OC \\ \hline 2 BP \\ \hline 7 HP \\ \hline$		
						A A A A A A A A A A A A A A A A A A A	1 HA		
	1 Star		3 10				SE LIMIT OF WORK		
TANK C							Alt and a second se		
200 - 20 - 200 - 200 - 200 - 200 - 200 - 200 - 200 - 200 - 200 - 200 - 200 - 200 - 200 - 200 - 200 - 200 - 200 - 200 - 200			h 2 LT	3_10					
					3 CE				DA CA
			<u>3 TO</u>						2 0000
	CB W/ MLS/ Refice.st	3 PN							Jan All
				3 10		· · · · · · · · · · · · · · · · · · ·	en e		
						$0, 0, \phi$			UMIT OF
				5 PN	the total) ⁱⁿ tra		
		Mark I							
					(F) for elt	<u>3 HA</u> <u>3 CF 1 HA</u> <u>2 CP</u> 1 MAT			
				26" PS"	A B B B B B B B B B B B B B B B B B B B			6 PW	
					3 LOP CHART		Charles Com		
		651-3-0 41 12							
				10 HD		AA		5 AC	
		A CARA		1 1 1 1 1 1 1 1 1 1 1 1 1 1 1 1 1 1 1		CAR BARRA			3.0
						85 PS		ROOS	<u>3 AA 3 HV</u>
						3 PN 3 PS S S S S S S S S S S S S S S S S S	A O OF	3 AA	T Kn &
						XX O ARA	HOCO A HV		
							<u>3 HV</u> <u>3 CC</u>	1 225	
							8898 h		ununut,
					· · · · ·	X X X = -			V.

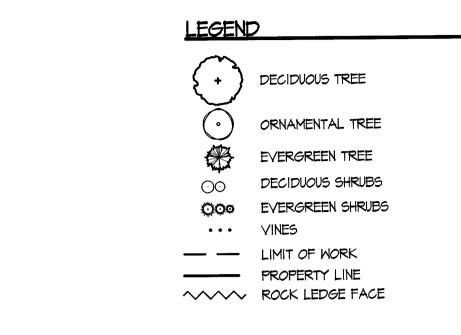

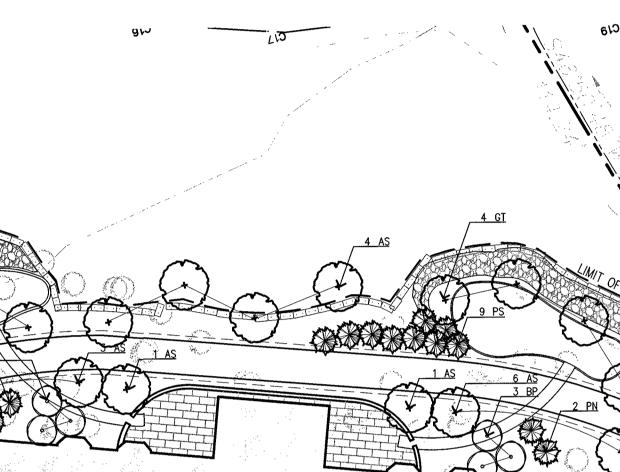

PLANTING NOTES

- ASSOCIATES, INC. OF A9 ACCESS RD., UNIT 12, NORWOOD, MA AND IS DATED JANUARY 2004.
- DATED JUNE 2014.
- ACCEPTANCE OF PLANT MATERIAL.
- PLANTING BEDS.
- PLANTINGS SHOWN ON THIS DRAWING.
- ASSOCIATION.
- II. ALL PLANTS TO BE BALLED IN BURLAP OR CONTAINERIZED.
- OF WOOD CHIPS THICKER THAN 1/4 INCH.
- EQUIVALENT. FERTILIZER ADDED PER RECOMMENDED RATES OF SOILS ANALYSIS.
- ACCEPTANCE.
- THE SITE.
- SEEDED WITH A MINIMUM DEPTH OF 6" DEPTH TOPSOIL.
- CHANGE WITHOUT APPROVAL OF OWNER'S REPRESENTATIVE.

EXISTING CONDITIONS INFORMATION IS REPRODUCED FROM THE SURVEY PREPARED BY TOOMEY-MUNSON AND

2. RESOURCE AREA FLAGGING COMPLETED BY STANTEC OF 136 WEST STREET, SUITE 203, NORTHHAMPTON, MA AND IS

3. THE LOCATIONS OF UNDERGROUND UTILITIES SHOWN ARE BASED ON THE SURVEY REFERENCED ABOVE. THE CONTRACTOR SHALL CONTACT DIGSAFE AND THE PROPER LOCAL AUTHORITIES OR RESPECTIVE UTILITY COMPANIES TO CONFIRM THE LOCATION OF ALL EXISTING UTILITIES BEFORE COMMENCING WORK. ANY DAMAGE DUE TO FAILURE OF THE CONTRACTOR TO CONTACT THE PROPER AUTHORITIES SHALL BE BORNE BY THE CONTRACTOR.

4. CONTRACTOR SHALL BEGIN MAINTENANCE IMMEDIATELY AFTER PLANTING AND WILL CONTINUE UNTIL FINAL WRITTEN

5. CONTRACTOR SHALL VERIFY ALL TREE REMOVALS OWNER'S REPRESENTATIVE PRIOR TO CONSTRUCTION START.

6. CONTRACTOR SHALL MAINTAIN POSITIVE DRAINAGE AWAY FROM ALL BUILDING FOUNDATIONS, STRUCTURES, AND

7. MAXIMUM SLOPE WITHIN DISTURBED AREAS SHALL NOT EXCEED 3:1, UNLESS OTHERWISE NOTED.

8. THE LANDSCAPE CONTRACTOR SHALL SUPPLY ALL PLANT MATERIALS IN QUANTITIES SUFFICIENT TO COMPLETE ALL

9. ALL MATERIALS SHALL CONFORM TO THE GUIDELINES ESTABLISHED BY THE AMERICAN NURSERY AND LANDSCAPE

IO. ALL PLANTS SHALL BEAR THE SAME RELATIONSHIP TO FINISH GRADE AS TO ORIGINAL GRADES BEFORE DIGGING.

12. MULCH FOR PLANTED AREAS TO BE AGED PINE BARK: PARTIALLY DECOMPOSED, DARK BROWN IN COLOR AND FREE

13. PLANTING SOIL MIX: LOAM THOROUGHLY INCORPORATED WITH ROTTED MANURE PROPORTIONED 5 C.Y. TO I C.Y. OR


14. THE LANDSCAPE CONTRACTOR SHALL GUARANTEE ALL PLANT MATERIALS FOR ONE (1) FULL YEAR FROM DATE OF

15. ALL PLANT MATERIALS ARE SUBJECT TO THE APPROVAL OF THE LANDSCAPE ARCHITECT, AT THE NURSERY, AND AT

16. ALL AREAS OF THE SITE WHICH HAVE BEEN DISTURBED AND NOT OTHERWISE DEVELOPED SHALL BE LOAMED AND

17. PLANT SPECIES AS INDICATED IN THE PLANT LIST ARE SUGGESTIONS ONLY. FINAL SELECTION OF SPECIES SHALL OCCUR AT THE TIME OF PLANT PURCHASE, DEPENDING ON AVAILABILITY. PLANT SIZE AND QUANTITY SHALL NOT

R=118.62 (BOL/ED)

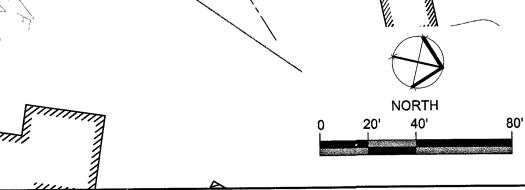



226 Causeway Street Boston MA U.S.A., 02114 www.stantec.com P.617.523.8103

Copyright Reserved

The Contractor shall verify and be responsible for all dimensions. DO NOT scale the drawing - any errors or omissions shall be reported to Stantec without delay. The Copyrights to all designs and drawings are the property of Stantec. Reproduction or use for any purpose other than that authorized by Stantec is forbidden.

Chestnut Hill Real




VARIOUS EDITS	JM	TPK	10.24.14
VARIOUS EDITS	CL/JM	TPK	08.29.14
SPECIAL PERMIT FILING	CL/JM	TPK	08.04.14
VARIOUS EDITS	CL/JM	TPK	07.14.14
SITE PLAN	JM	TPK	11.26.13
Issued	Ву	Appd.	MM.DD.YY

Dwn.

Chkd. Dsgn. MM.DD.YY

Permit-Seal

File Name:

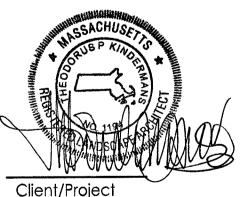

CHESTNUT HILL REALTY


THE RESIDENCES AT KESSELER WOODS

NEWTON, MA


Title

PLANTING PLAN


Project No. 210801167 Scale AS NOTED

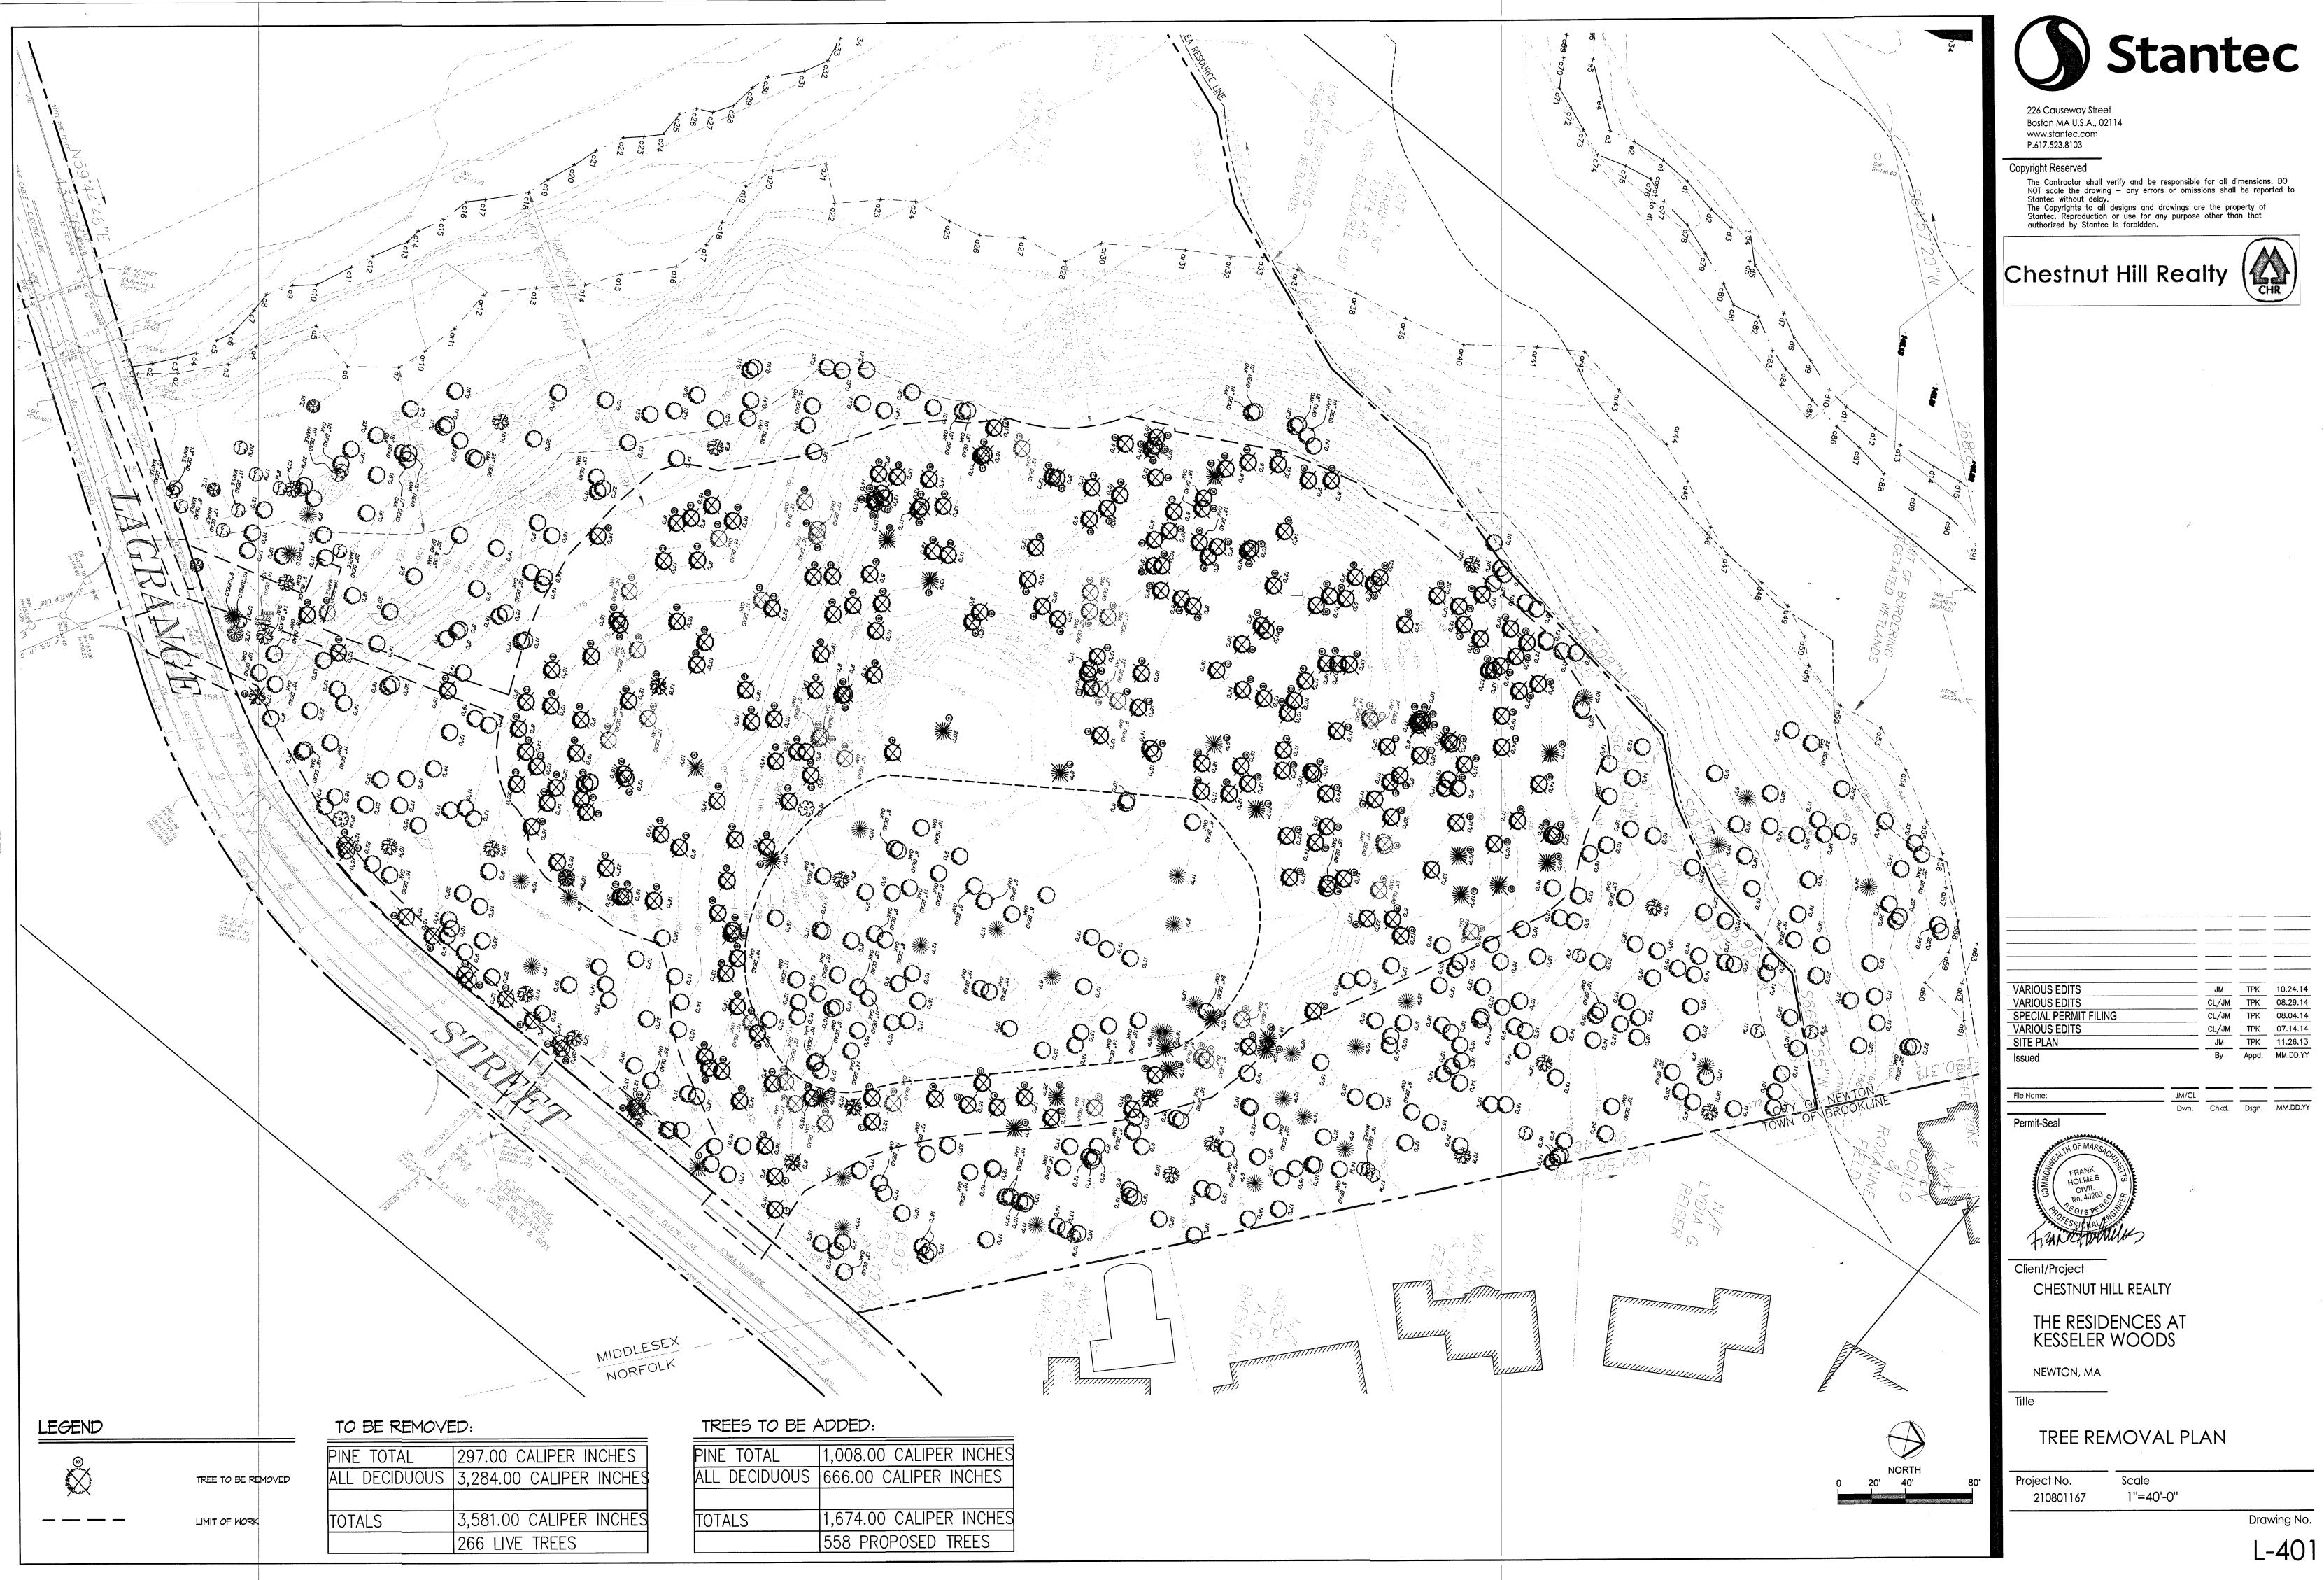



			<u></u>
VARIOUS EDITS	JM	TPK	10.24.14
VARIOUS EDITS	CL/JM	TPK	08.29.14
SPECIAL PERMIT FILING	CL/JM	TPK	08.04.14
VARIOUS EDITS	CL/JM	TPK	07.14.14
SITE PLAN	JM	TPK	11.26.13
Issued	By	Appd.	MM.DD.YY

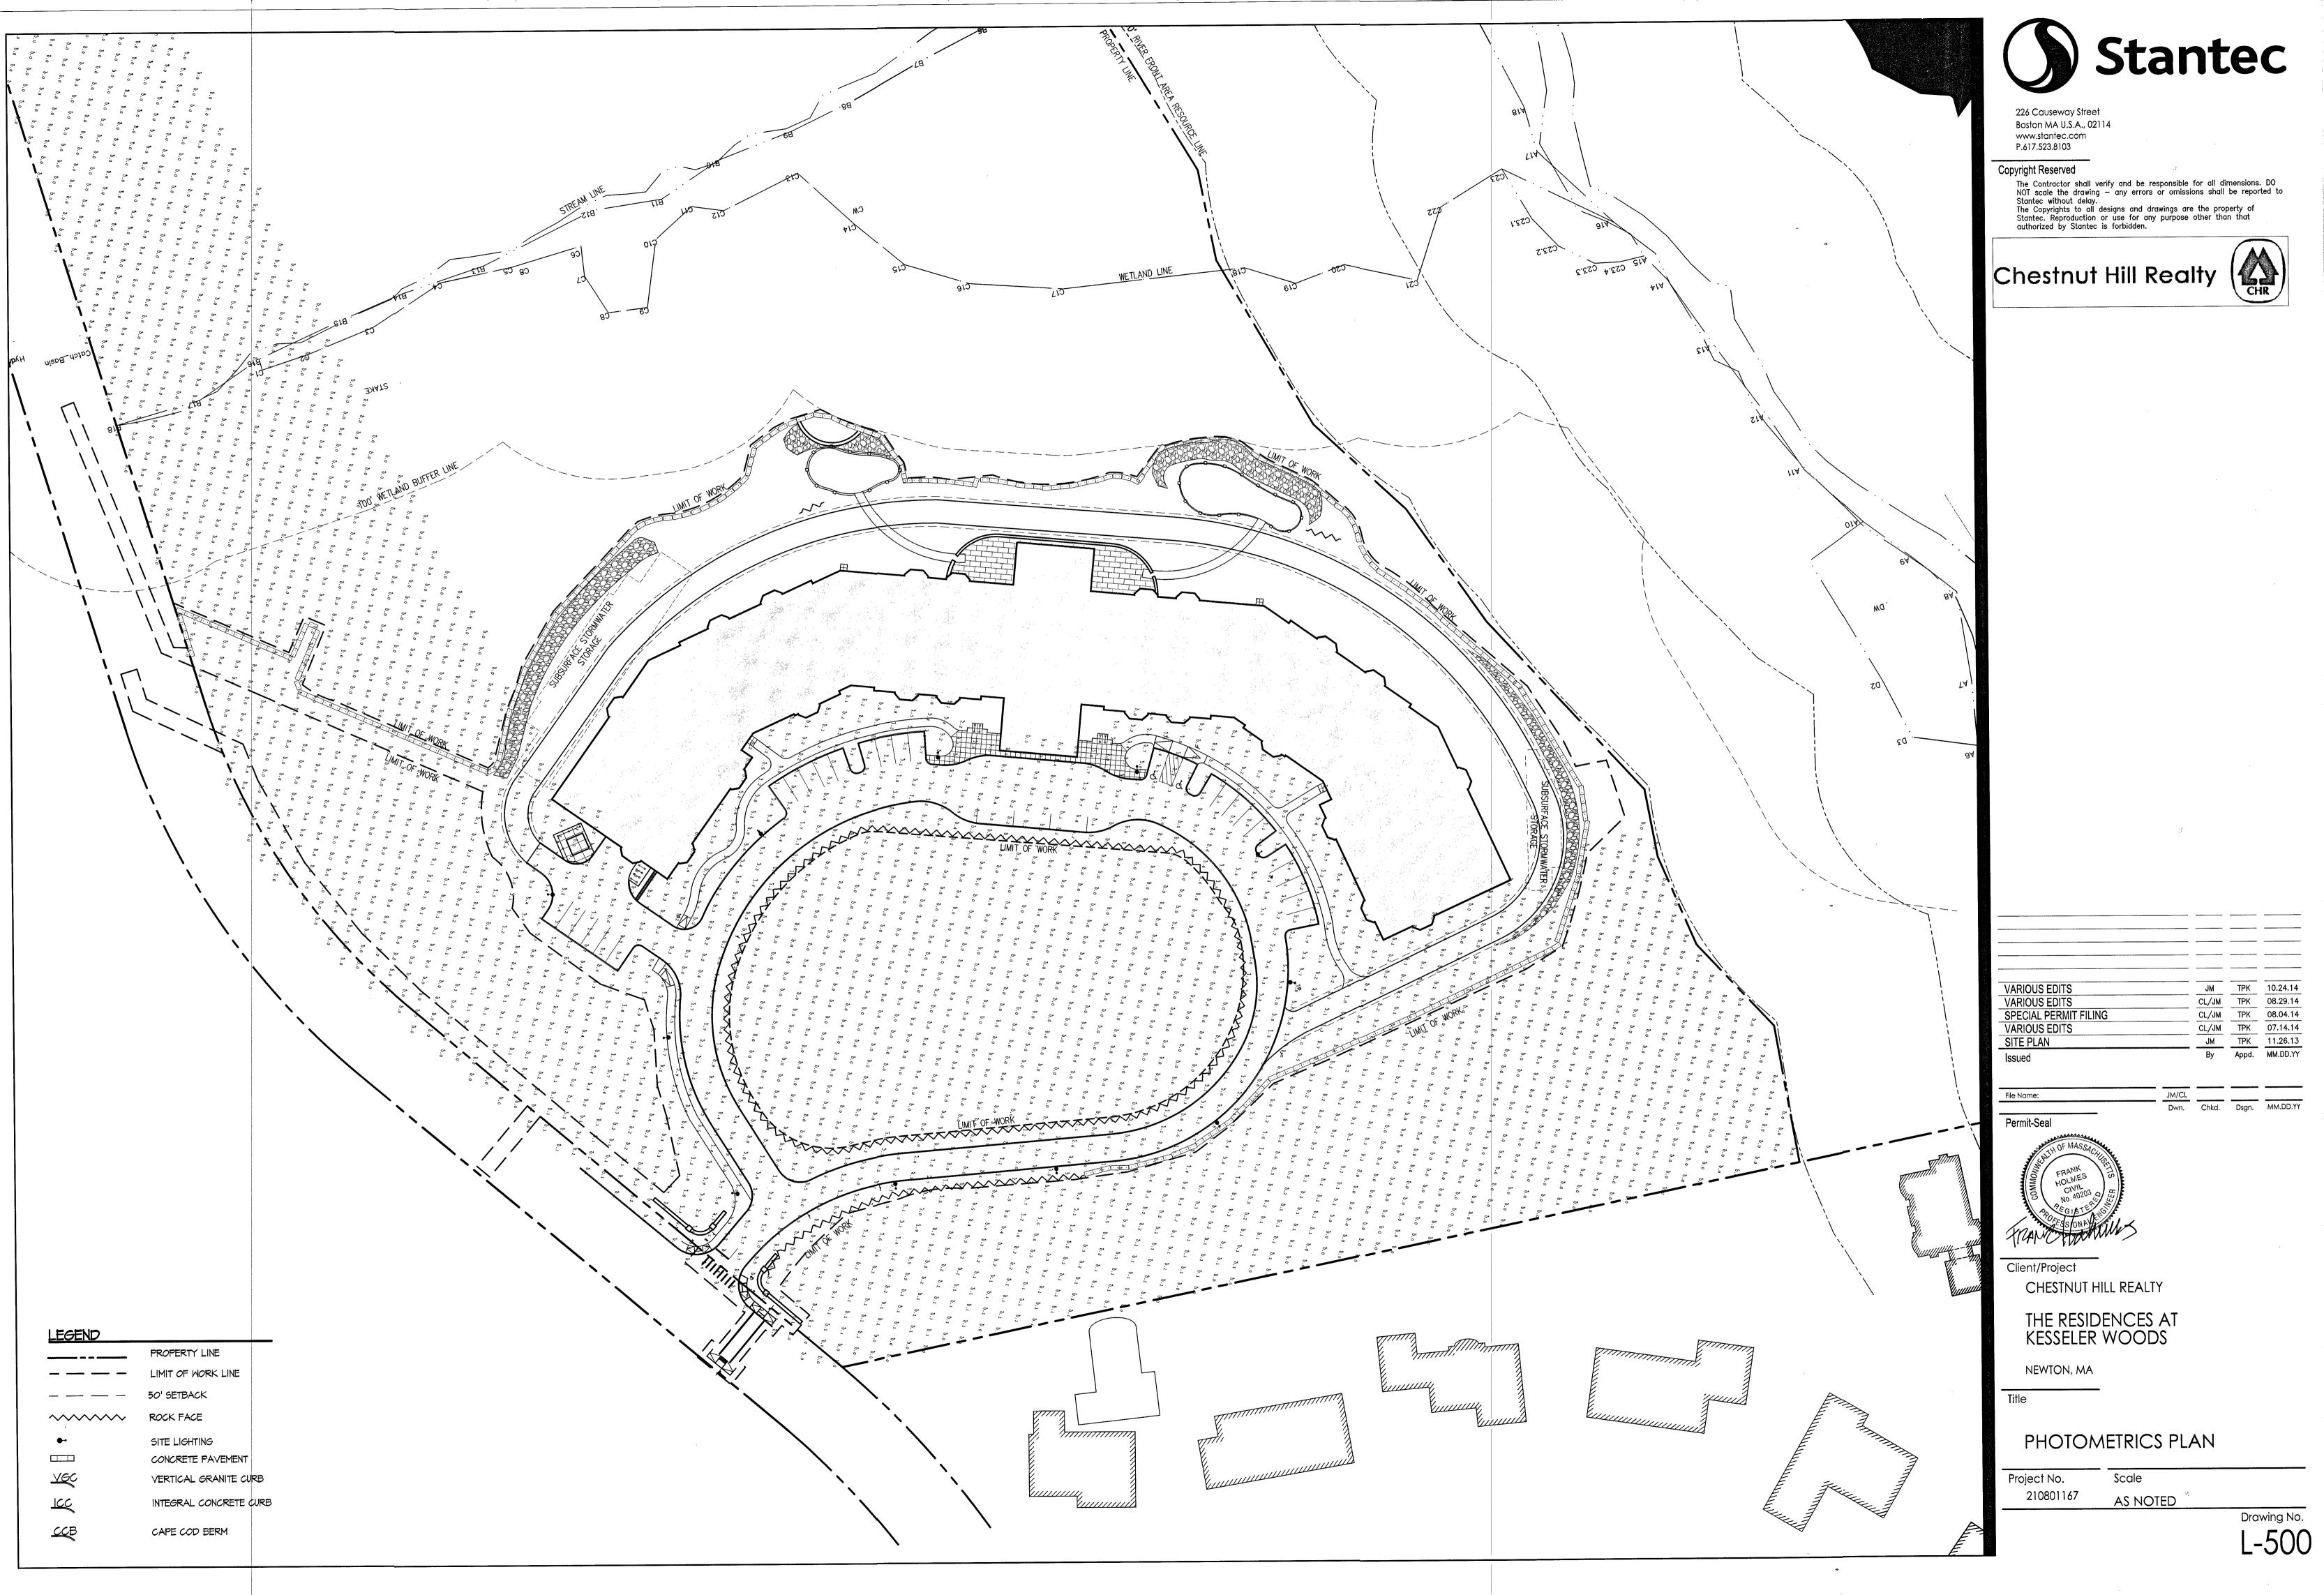

VARIOUS EDITS	JM	TPK	10.24.14
VARIOUS EDITS	CL/JM	TPK	08.29.14
SPECIAL PERMIT FILING	CL/JM	TPK	08.04.14
VARIOUS EDITS	CL/JM	TPK	07.14.14
SITE PLAN	JM	TPK	11.26.13
Issued	Ву	Appd.	MM.DD.YY

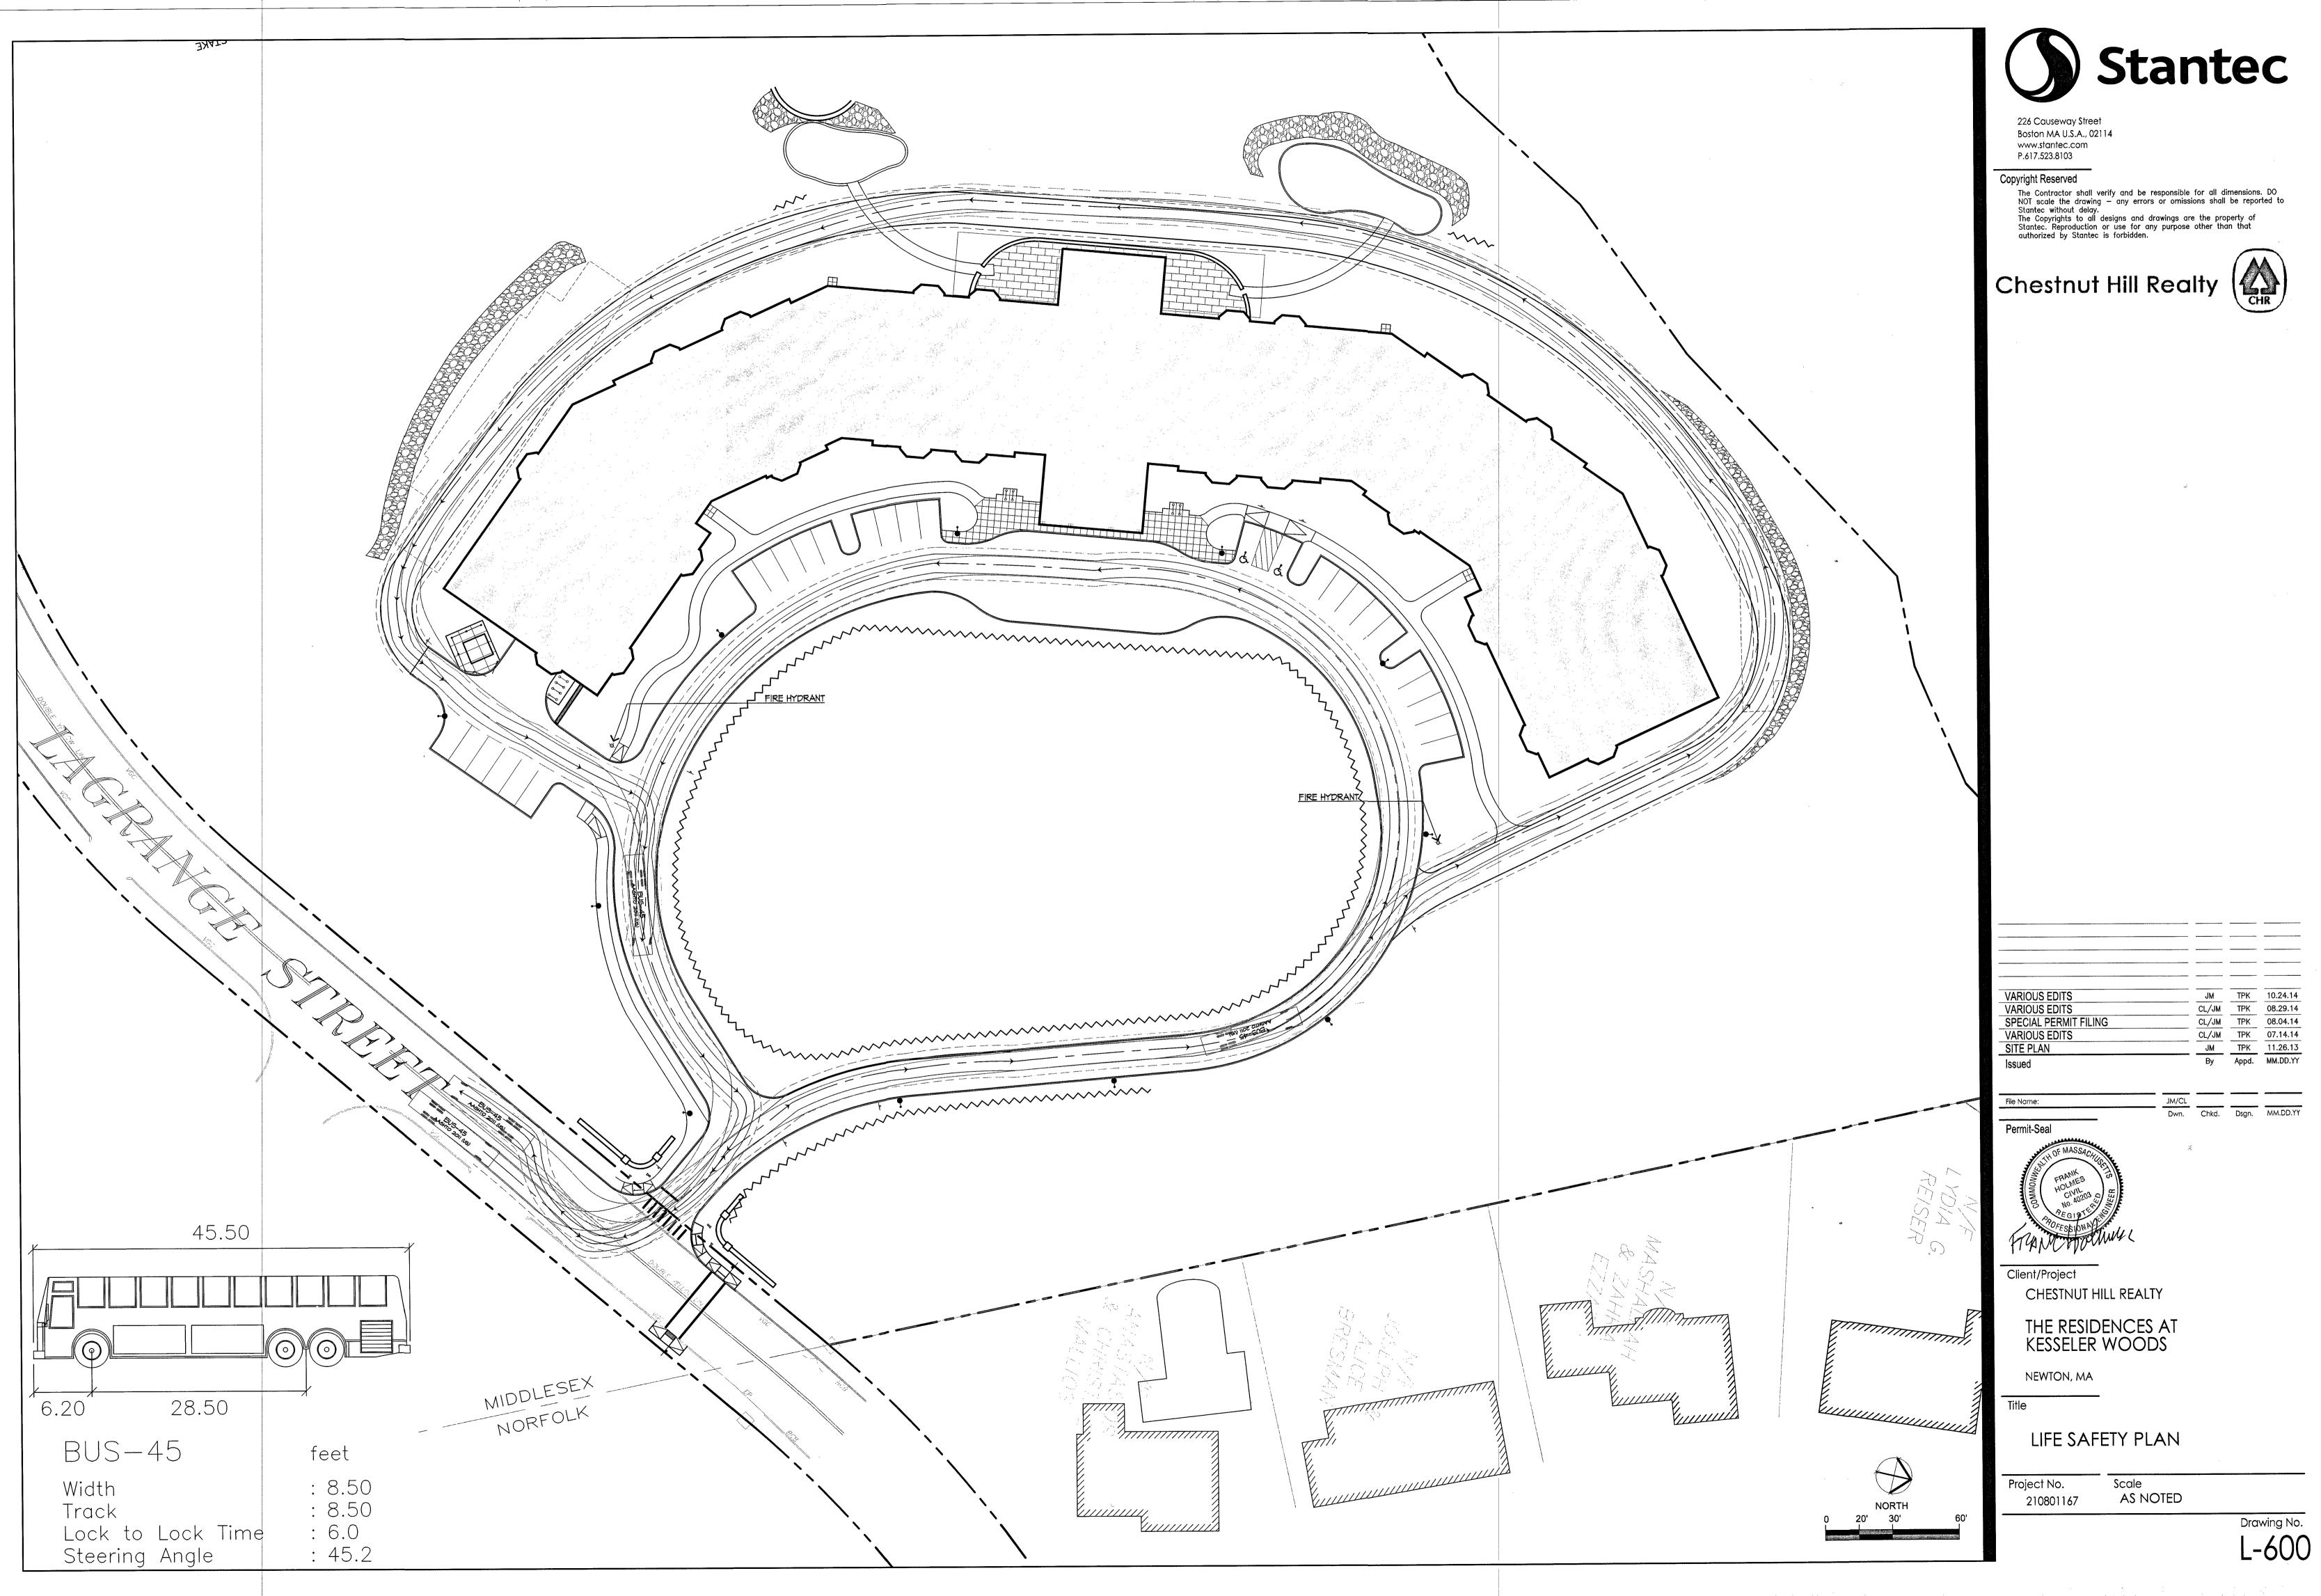

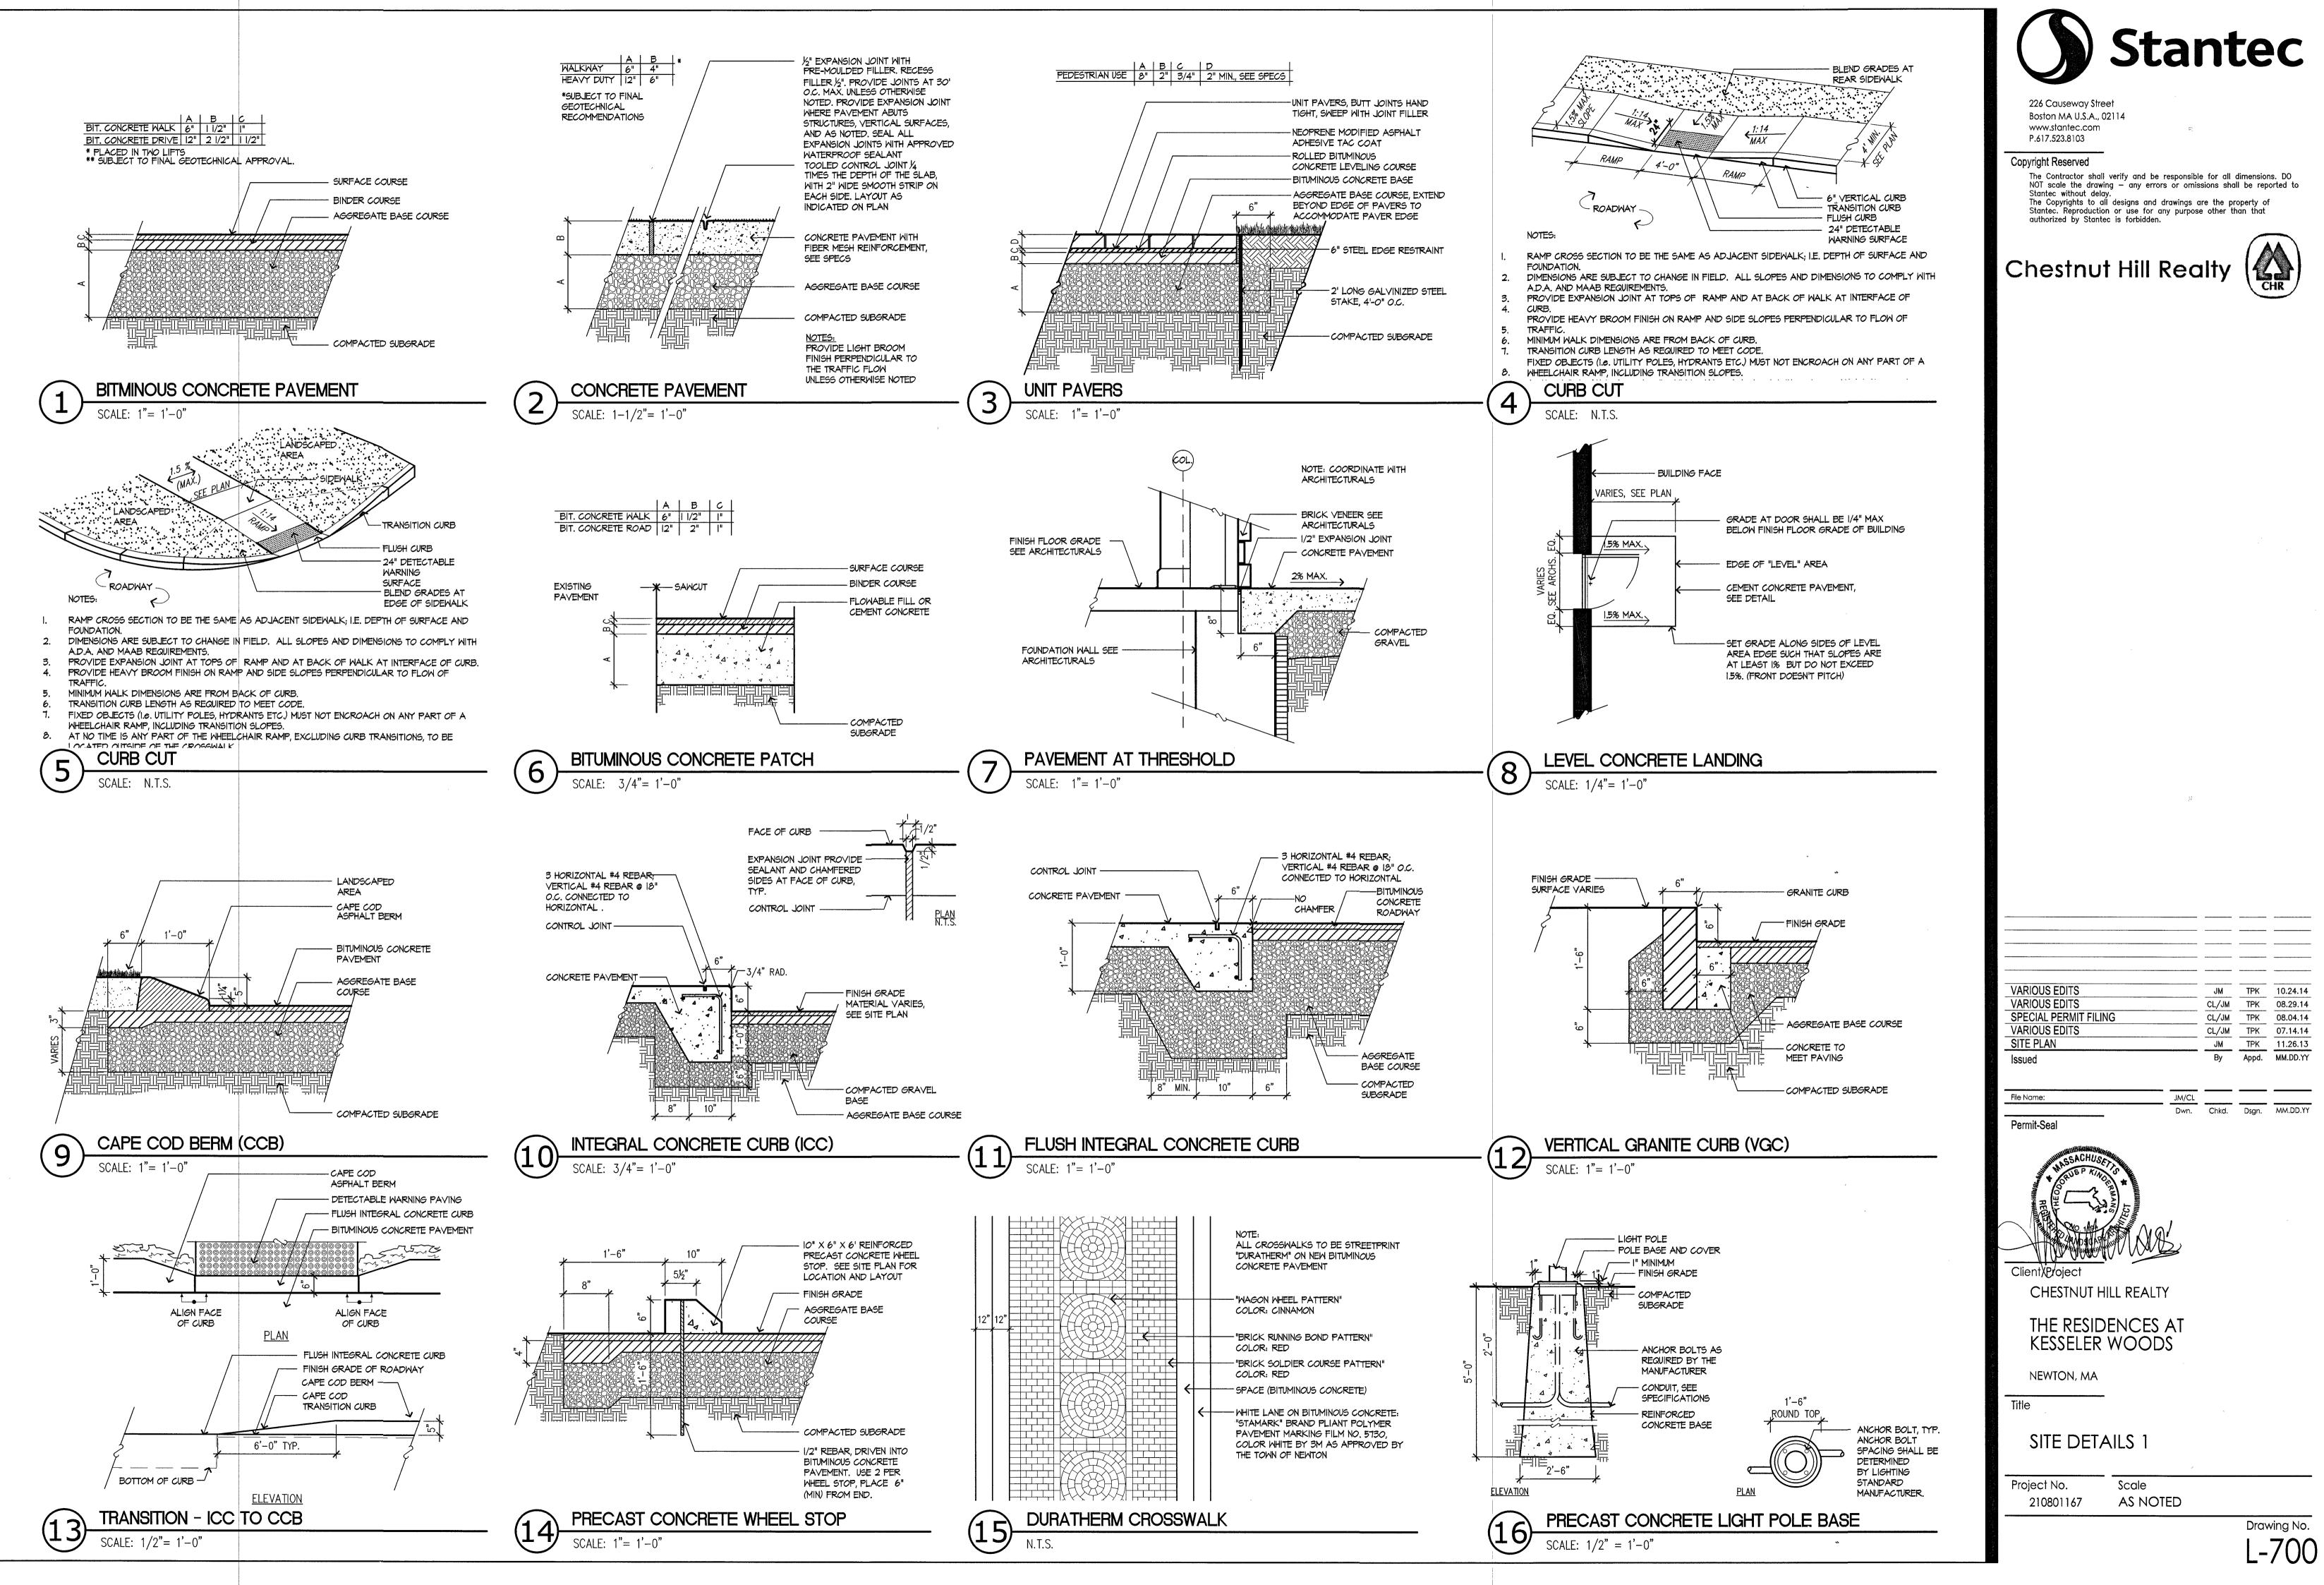

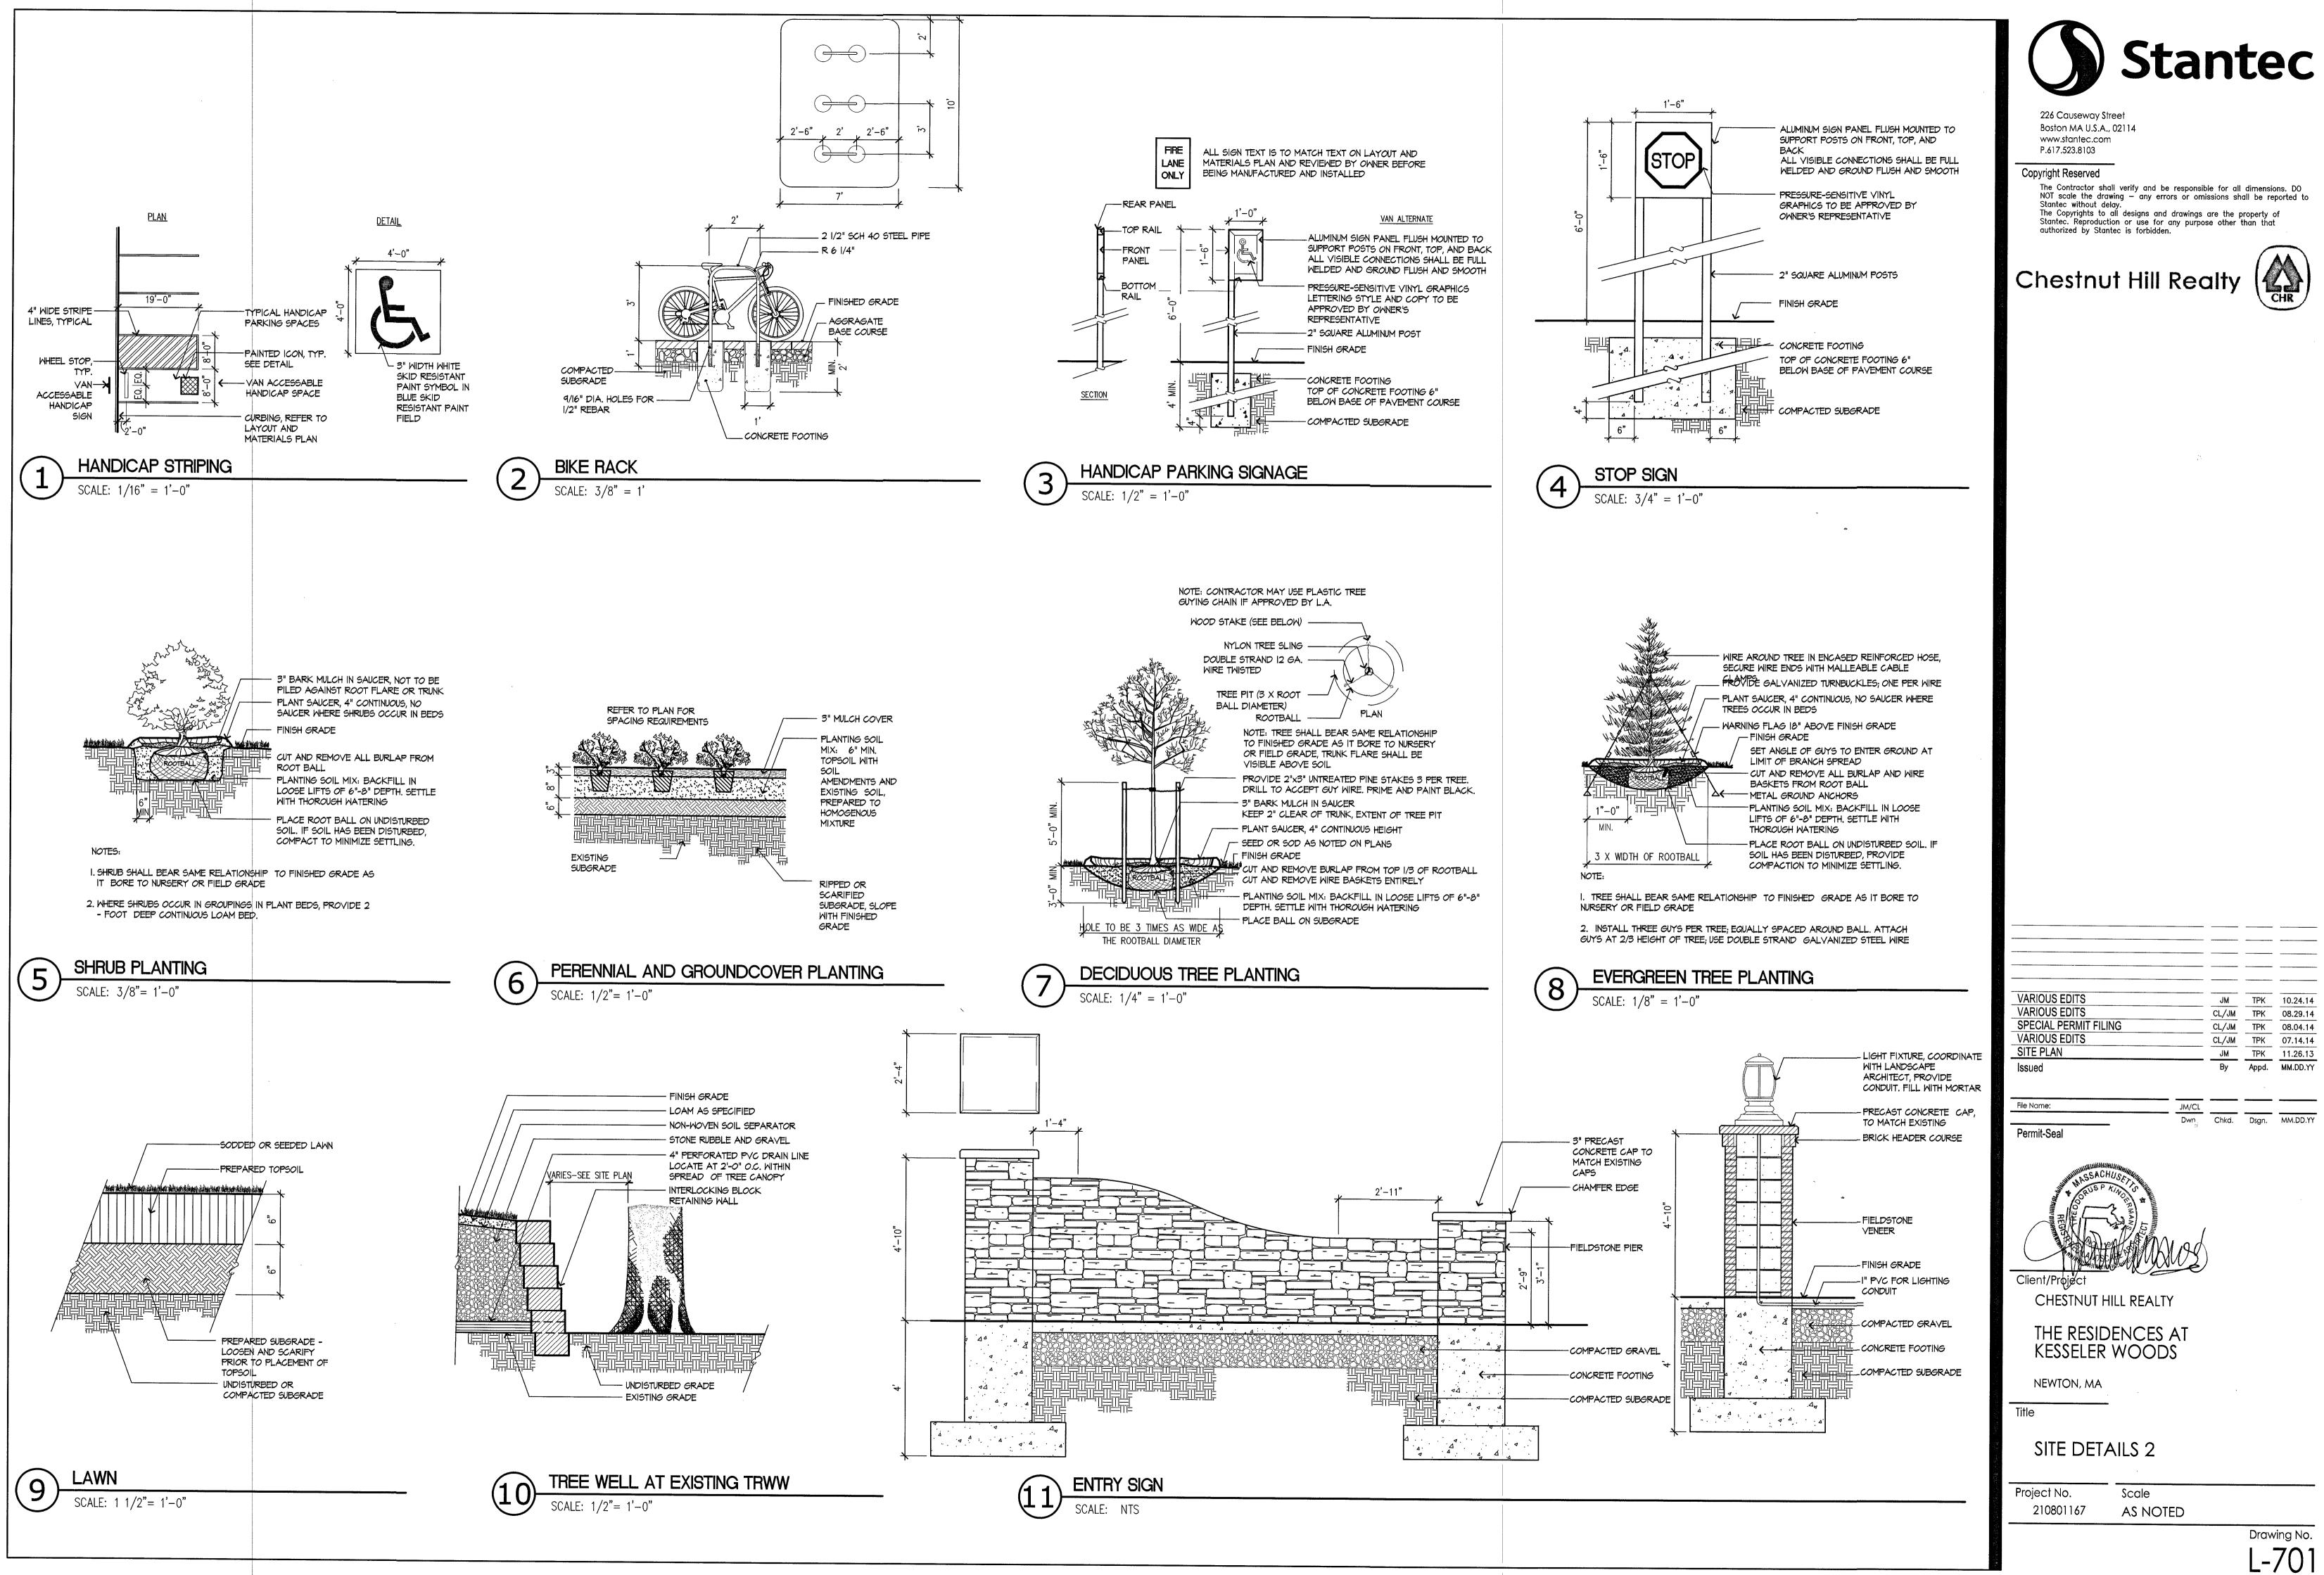

The Contractor shall verify and be responsible for all dimensions. DO NOT scale the drawing - any errors or omissions shall be reported to

The Copyrights to all designs and drawings are the property of Stantec. Reproduction or use for any purpose other than that

Chestnut Hill Realty



TPK 10.24.14 JM CL/JM TPK 08.29.14 CL/JM TPK 08.04.14 CL/JM TPK 07.14.14
 JM
 TPK
 11.26.13

 By
 Appd.
 MM.DD.YY
 Chkd. Dsgn. MM.DD.YY

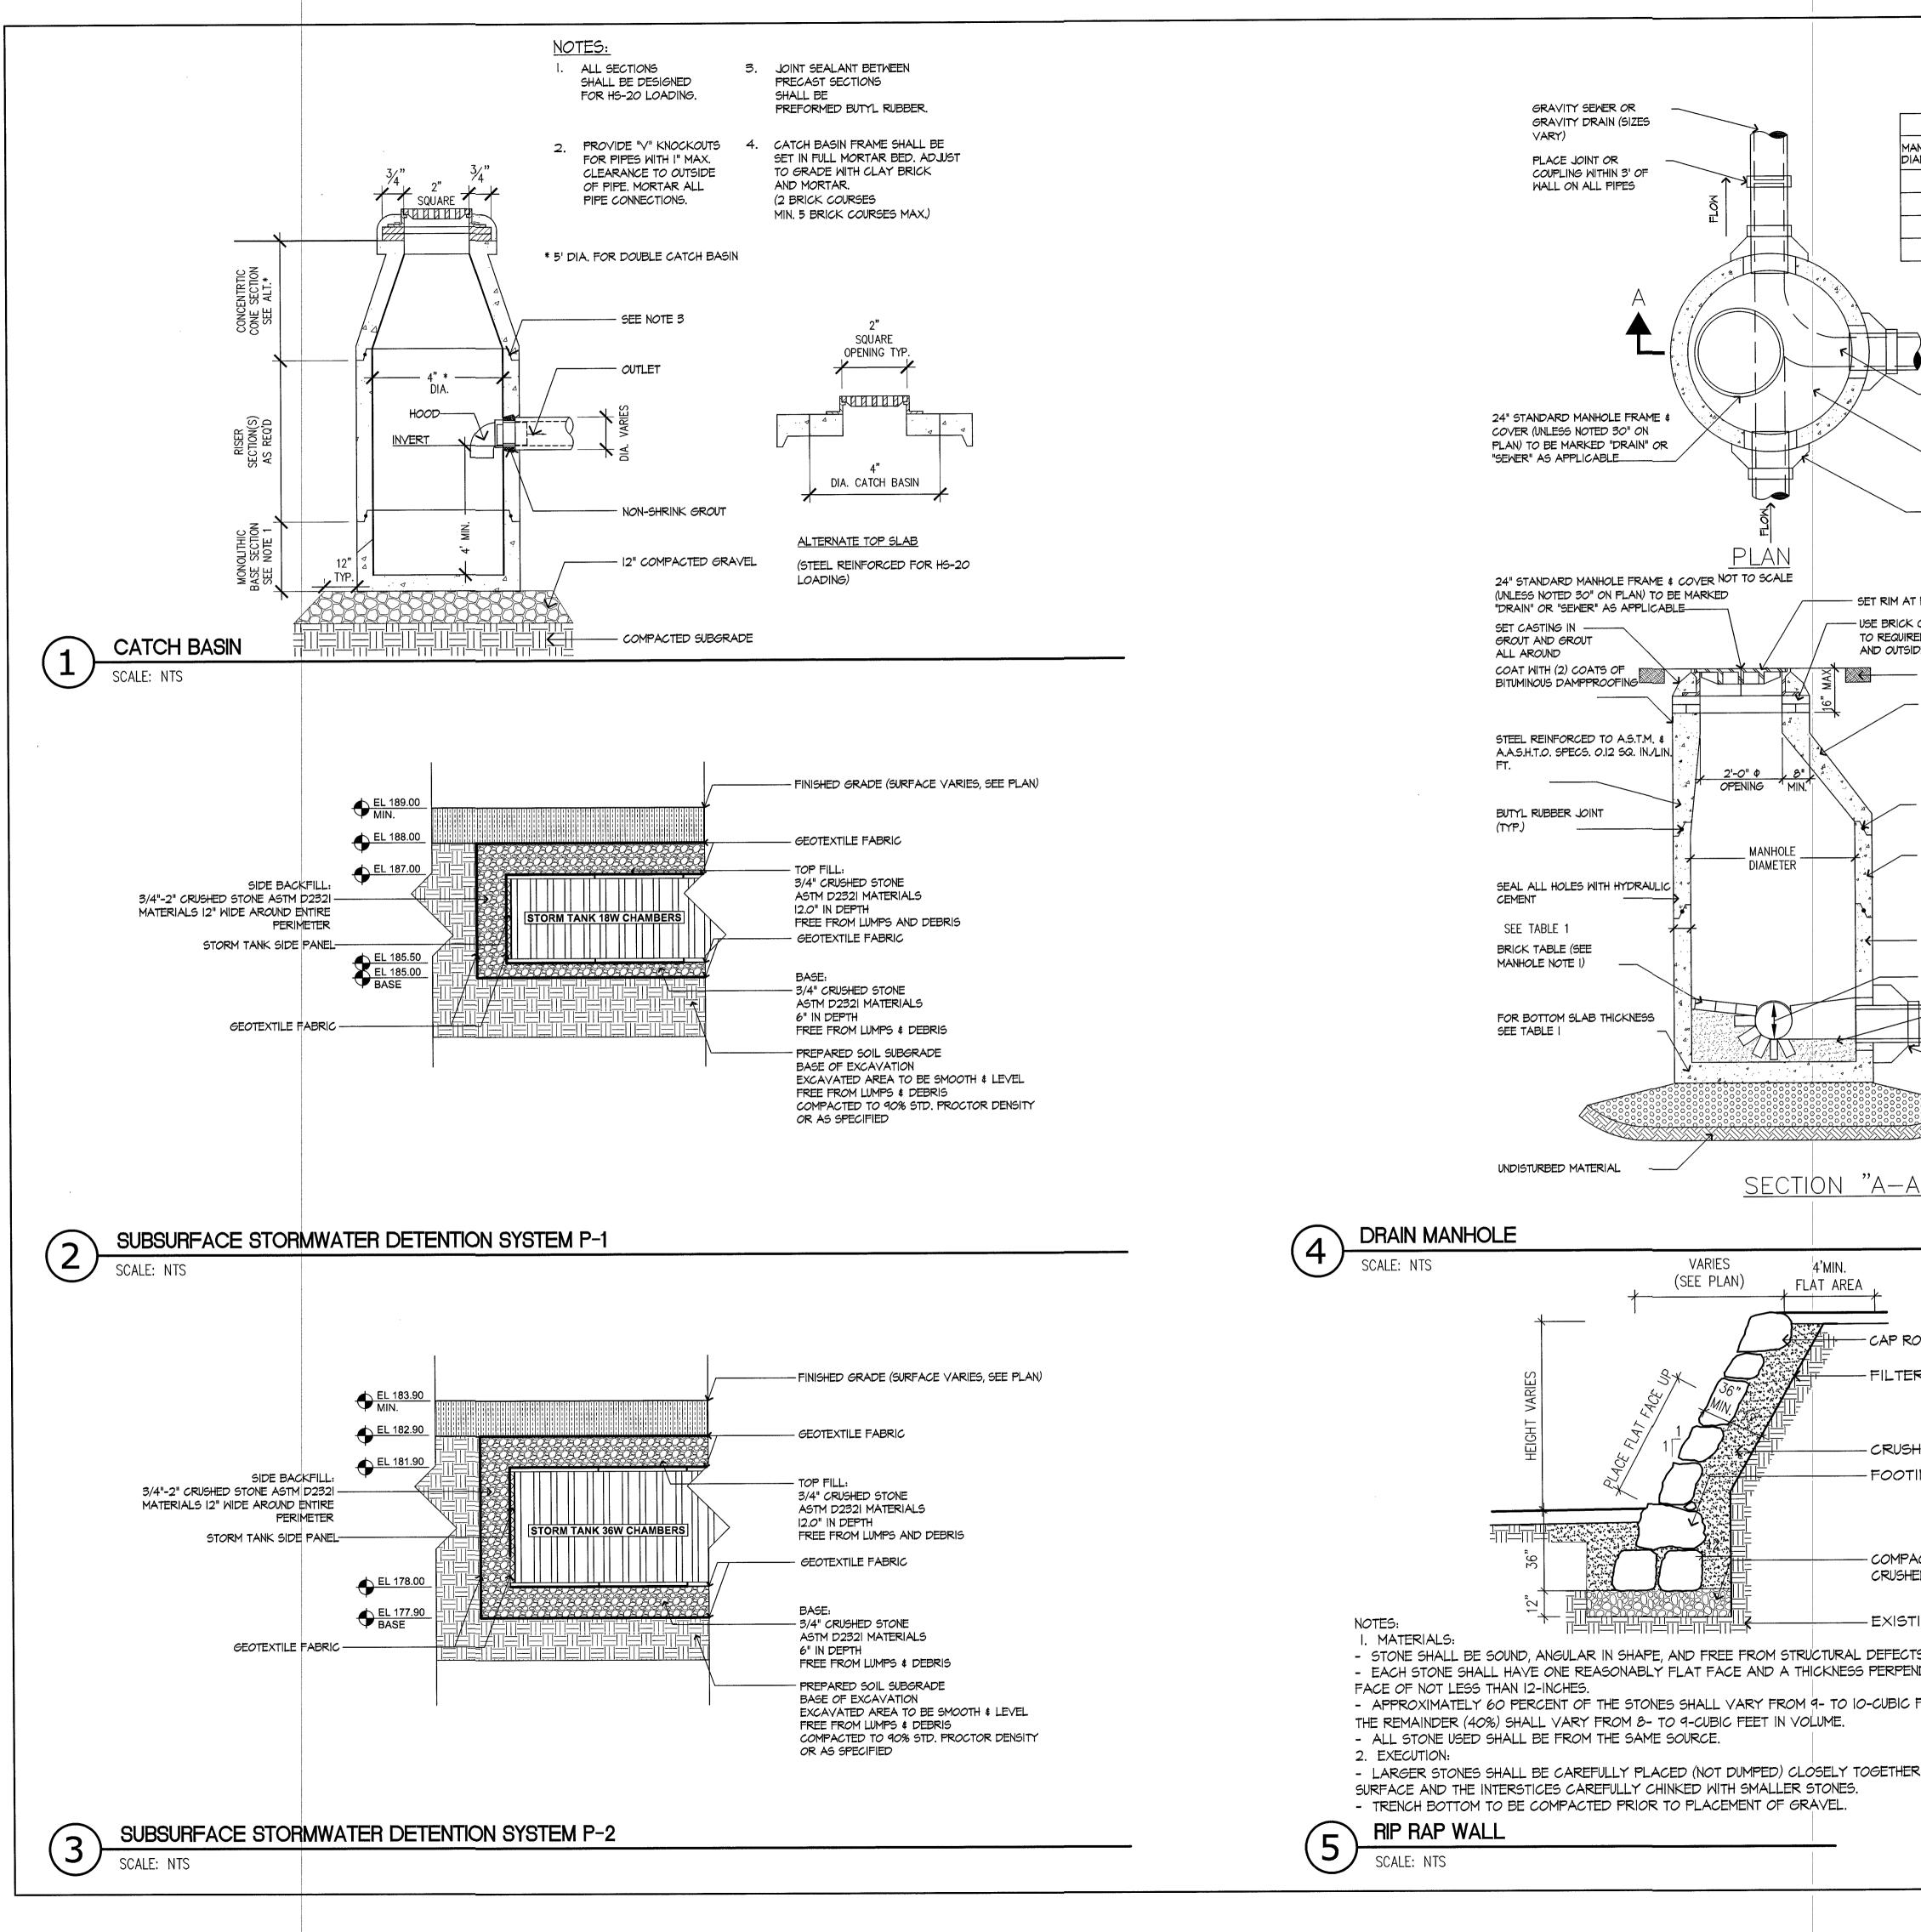


TABLE I : MANHOLE DIMENSIONS	226 Causeway Street
MANHOLESIDE WALLBOTTOM SLABMAX PIPE DIA DIAMETERTHICKNESS THICKNESS RCP DI	Boston MA U.S.A., 0211 www.stantec.com
4' 5" 6" 24" 30"	P.617.523.8103 Copyright Reserved
5' 6" 6" 36" 42" 6' 6" 6" 48" 54"	The Contractor shall ver NOT scale the drawing
8' 8" 8" 66" 72"	Stantec without delay. The Copyrights to all de Stantec. Reproduction of Stantec. Reproduction of
Λ	authorized by Stantec is
	Chestnut
	Cheshior
SHAPE SMOOTH ROUNDED	
INVERT FOR ALL SIDE ENTRANCE PIPES	
BRICK TABLE	
USE NON SHRINK GROUT FOR STORM	
DRAIN CONNECTIONS. CAST OPENING IN STRUCTURE OR CORE DRILL (TYP.)	
I AT FINISHED GRADE	
ICK COURSES AS NEEDED TO BRING MANHOLE RIM WIRED ELEVATION (MAX HEIGHT &") SEAL INSIDE	
ITSIDE WITH BRICK HYDRAULIC CEMENT FINISH GRADE	
3' \$ 4' LENGTHS WITH FLAT, CONCENTRIC OR ECCENTRIC CONICAL TOP (AS	
REQUIRED)	
SEAL ALL INTERIOR JOINTS WITH	
HYDRAULIC CEMENT	
STANDARD PRECAST BARREL SECTION COMBINATIONS OF I', 2', 3' OR 4' LENGTHS AS	
NEEDED TO BRING MANHOLE RIM TO REQUIRE ELEVATION	
STANDARD PRECAST BASE IN 3' LENGTHS (MIN.)	
DIAMETER OF LARGEST PIPE	•
3000 PSI CONCRETE	
FLEXIBLE WATERTIGHT SLEEVE	
REQUIRED FOR SEWERS. USE NON SHRINK GROUT FOR STORM DRAIN	
CONNECTIONS. CAST OPENING IN STRUCTURE OR CORE DRILL (TYP.)	
-A"	
	VARIOUS EDITS VARIOUS EDITS
	SPECIAL PERMIT FILING VARIOUS EDITS
	SITE PLAN Issued
ROCK	
TER FABRIC	Permit-Seal
	MASSACHUS
JSHED STONE	
OTING ROCK	
	Client/Project
1PACTED SHED STONE	CHESTNUT HIL
	THE RESIDE
STING EARTH	KESSELER V
ECTS. PENDICULAR TO THE	NEWTON, MA
IC FEET IN VOLUME AND	Title
	SITE DETA
HER THROUGH-OUT THE	SITE DETA
	Project No.
	210801167

Stantec

2114


erify and be responsible for all dimensions. DO - any errors or omissions shall be reported to I designs and drawings are the property of n or use for any purpose other than that c is forbidden.

Hill Realty (



TPK 10.24.14 JM TPK 08.29.14 CL/JM CL/JM TPK 08.04.14 CL/JM TPK 07.14.14 JM TPK 11.26.13 By Appd. MM.DD.YY

Dwn. Chkd. Dsgn. MM.DD.YY

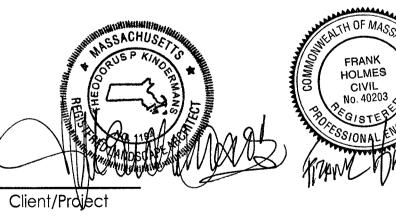


HILL REALTY

DENCES AT WOODS

AILS 3

Scale AS NOTED



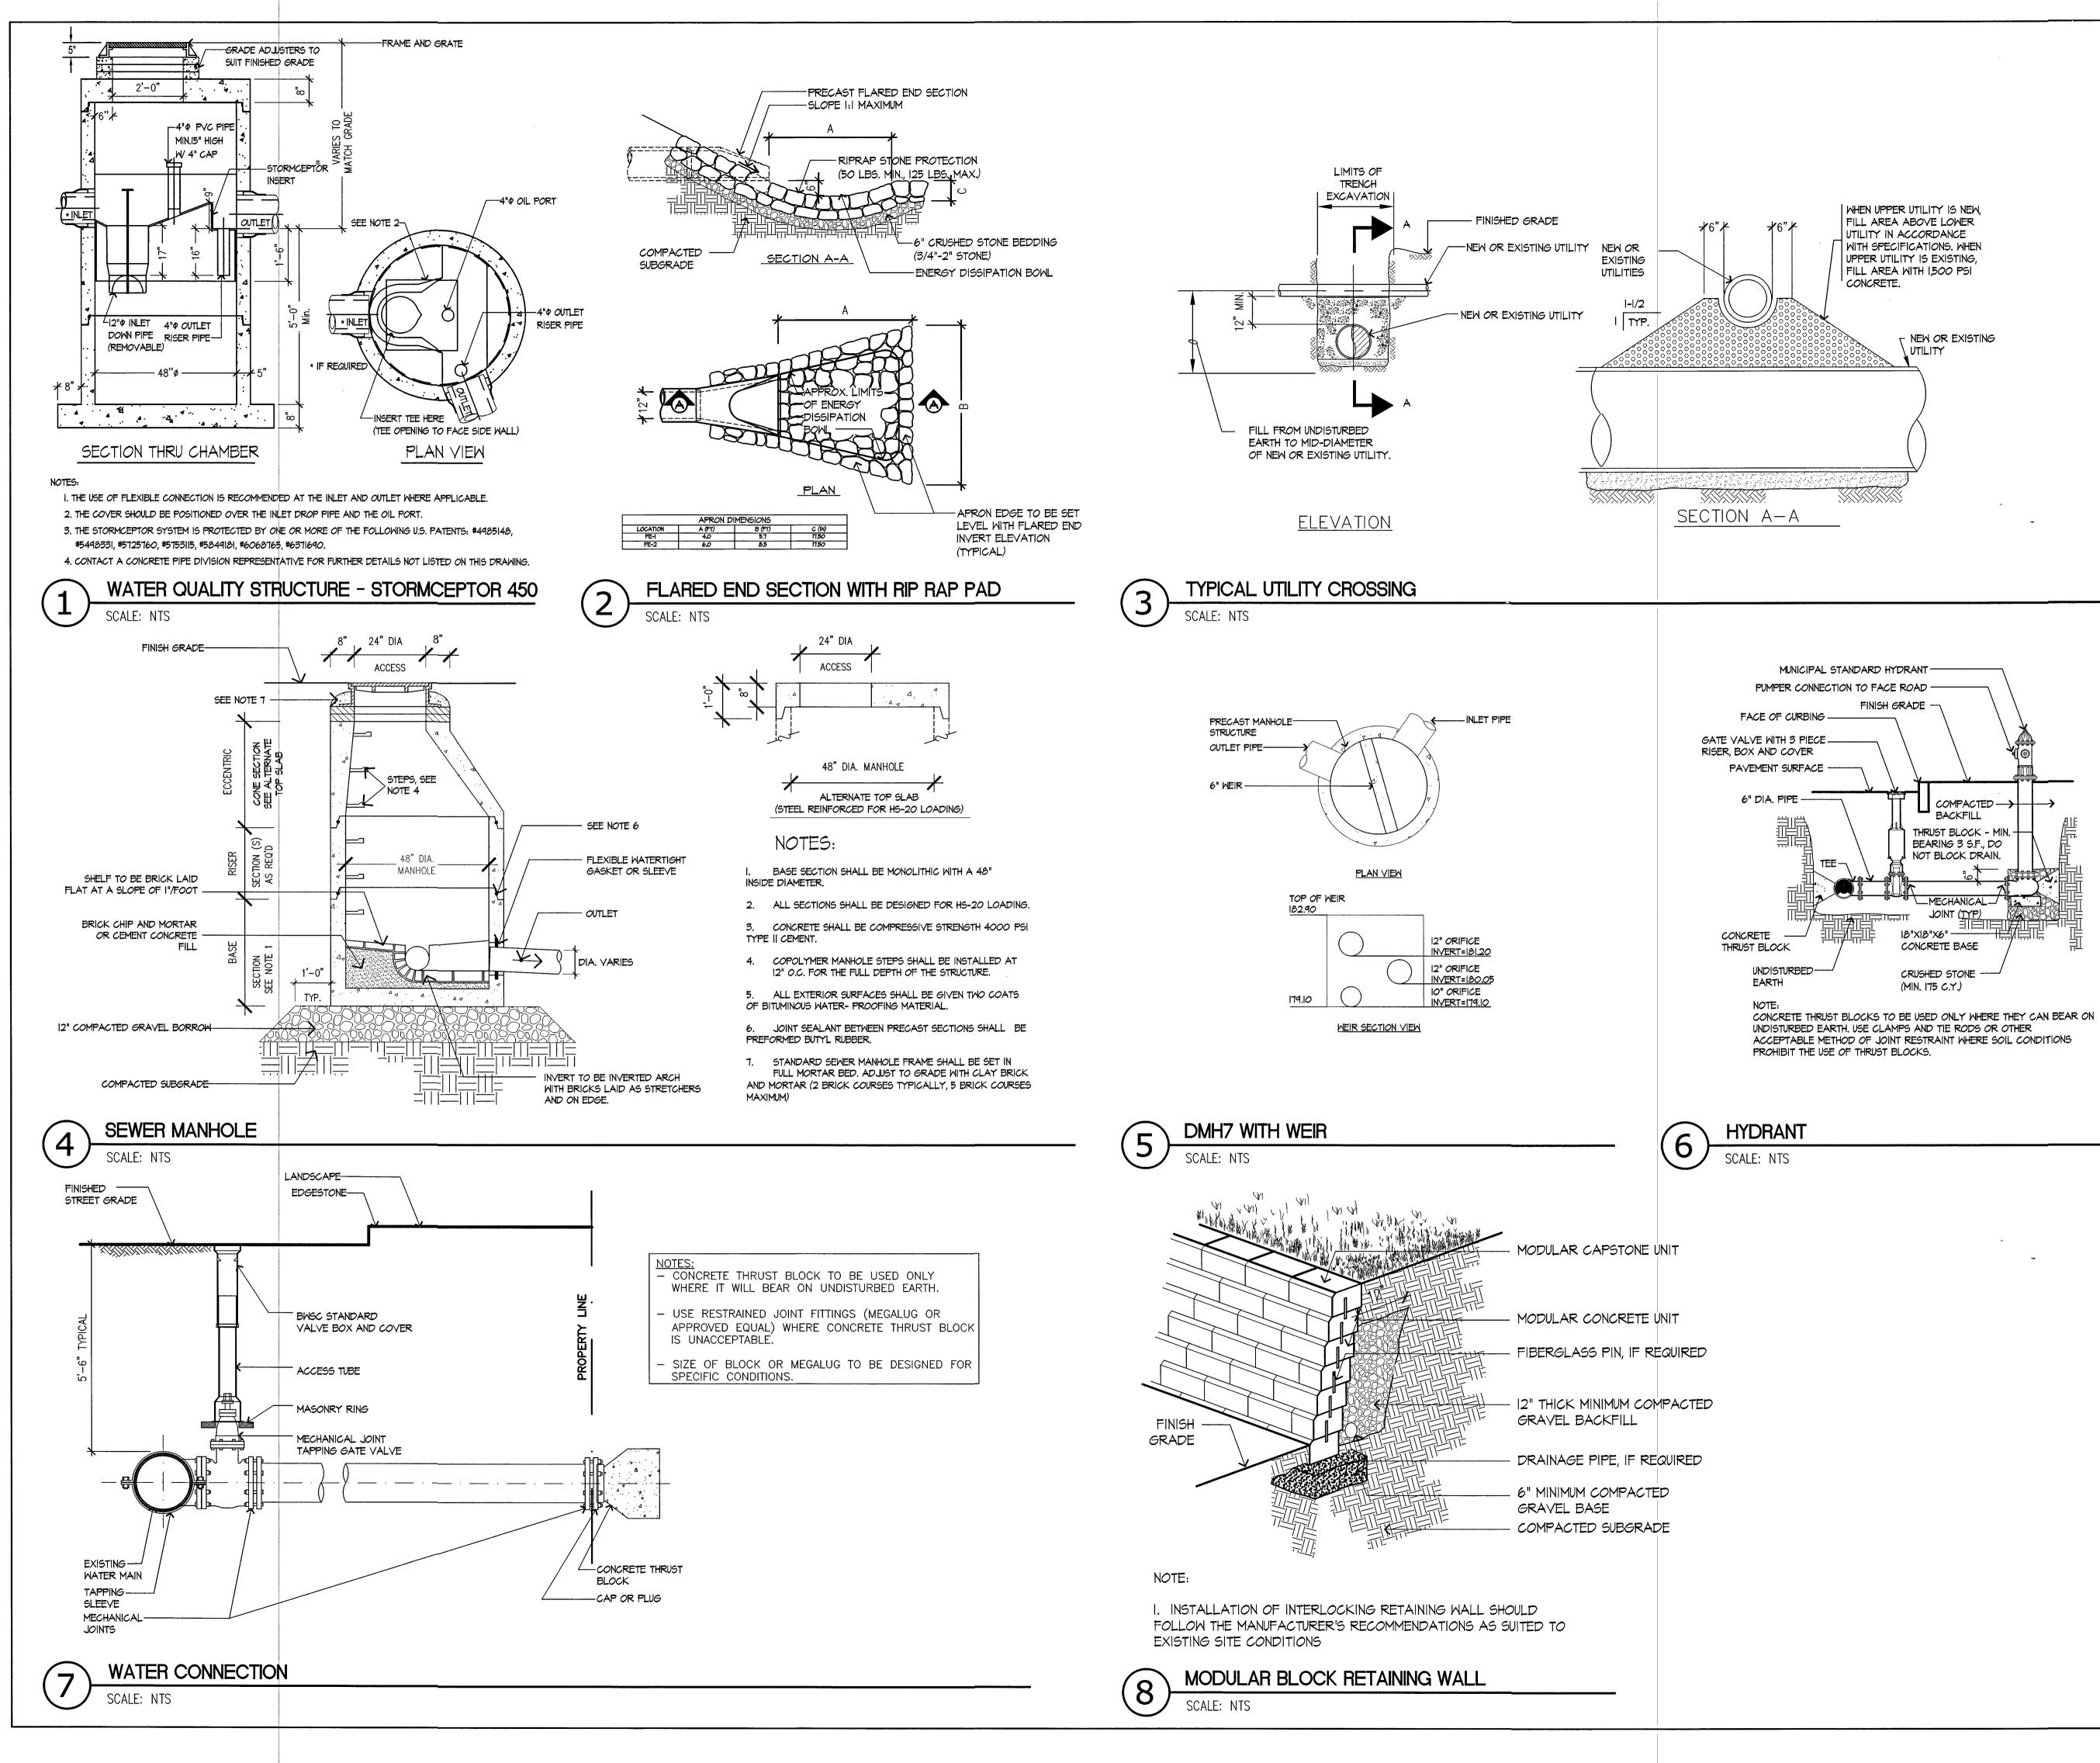



Copyright Reserved

The Contractor shall verify and be responsible for all dimensions. DO NOT scale the drawing - any errors or omissions shall be reported to Stantec without delay. The Copyrights to all designs and drawings are the property of Stantec. Reproduction or use for any purpose other than that authorized by Stantec is forbidden.

Chestnut Hill Realty




	······		
			••• ··· · · · · · · · · · · · · · · · ·
VARIOUS EDITS	JM	TPK	10.24.14
VARIOUS EDITS	CL/JM	TPK	08.29.14
SPECIAL PERMIT FILING	CL/JM	TPK	08.04.14
VARIOUS EDITS	CL/JM	TPK	07.14.14
SITE PLAN	JM	TPK	11.26.13
Issued	By	Appd.	MM.DD.YY

JM/CL Dwn.

Chkd. Dsgn. MM.DD.YY


File Name:

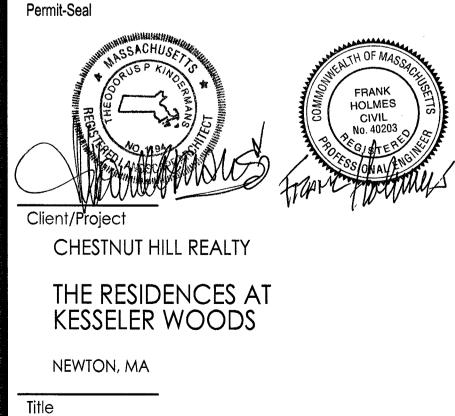


SITE DETAILS 4

Project No. 210801167

Scale AS NOTED

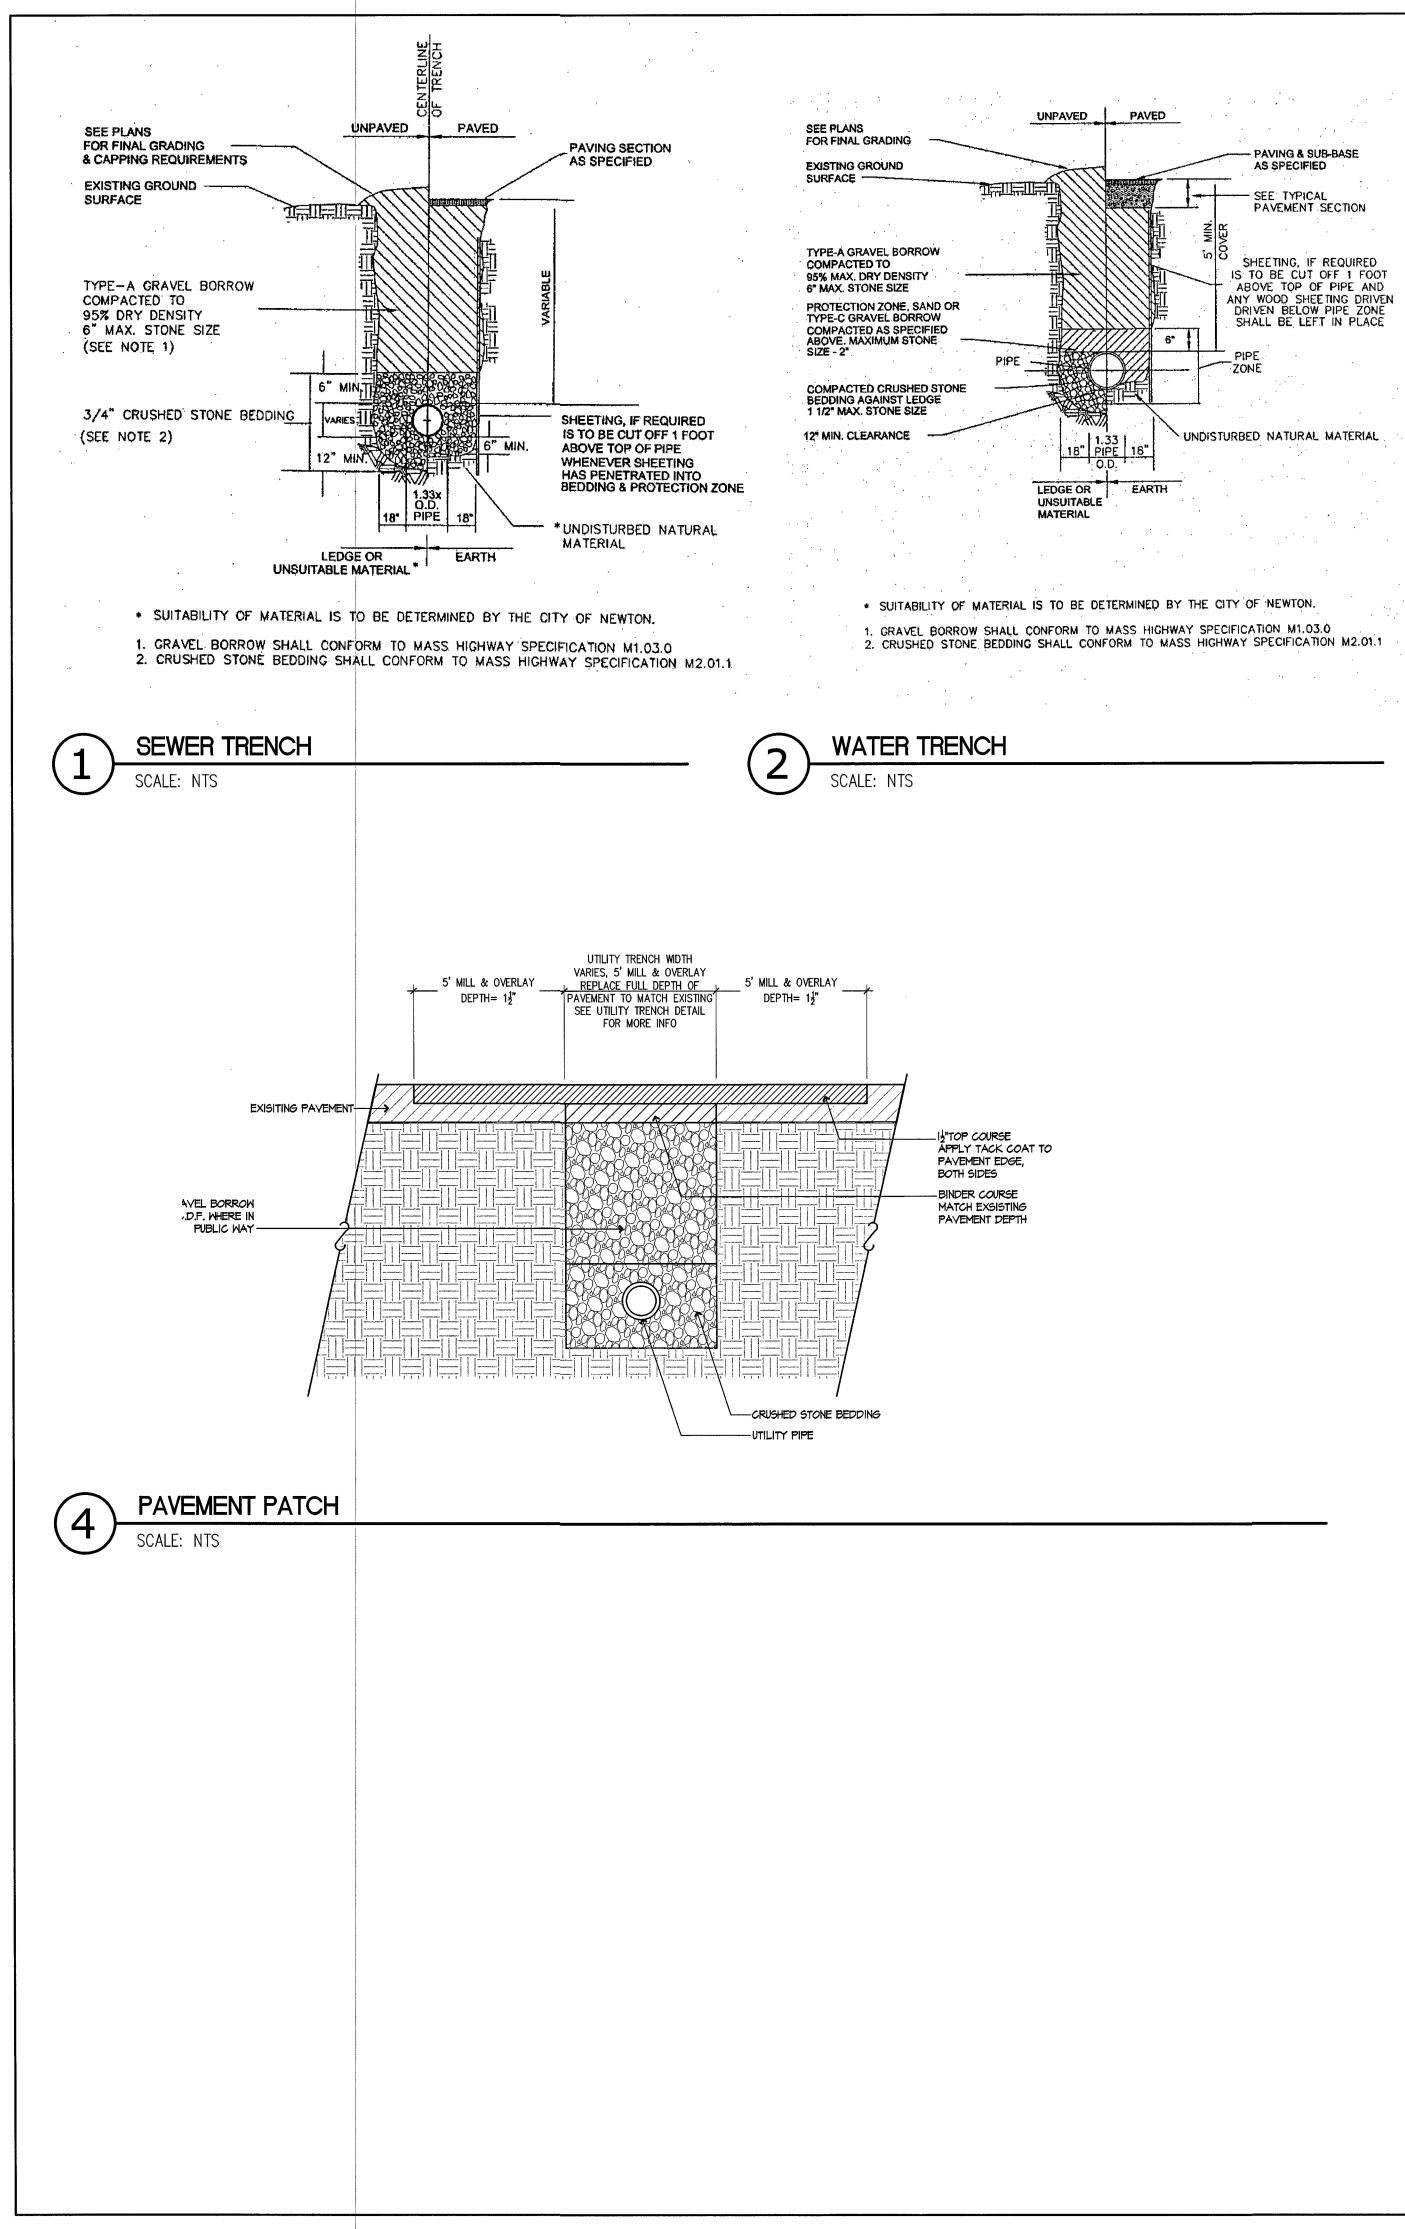

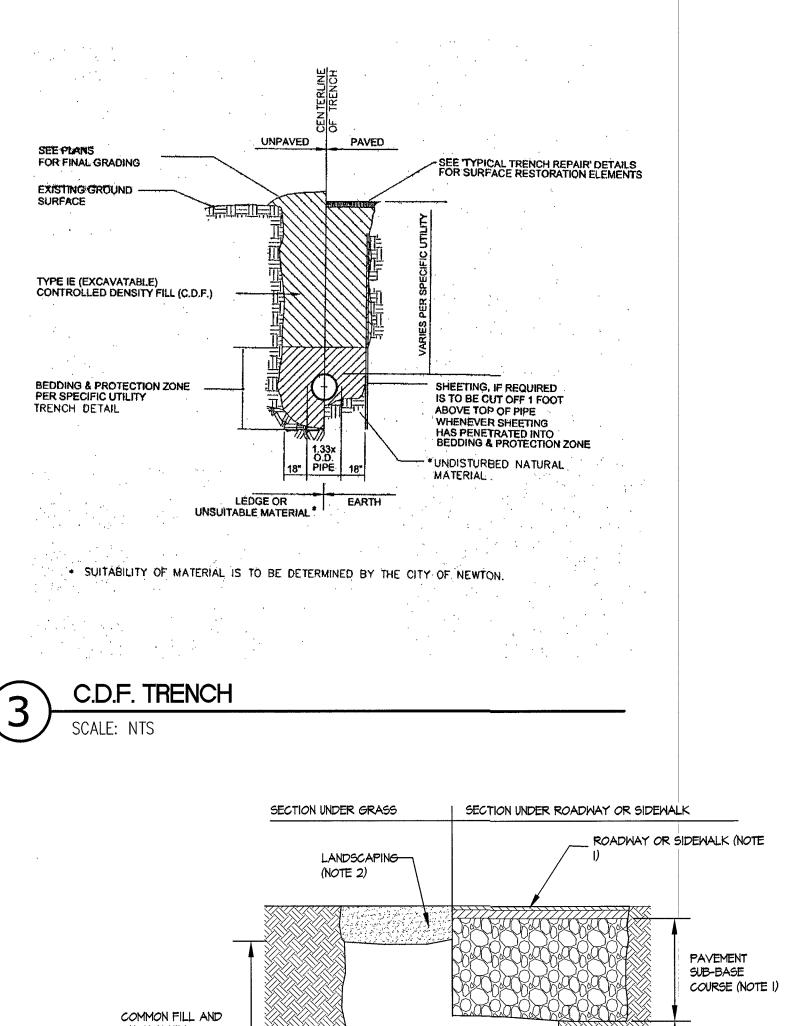

ON-SITE FILL TRENCH WIDTH & MATERIAL COMMON FILL AND PAYMENT LIMIT GEOTECHNICALLY ON-SITE FILL SUITABLE FOR REUSE (SEE TABLE) MATERIAL ON-SITE AS GEOTECHNICALLY BACKFILL SUITABLE FOR MINIMUM OF 2' REUSE ON-SITE AS OVERLAP FILTER FABRIC BACKFILL 3/4" CRUSHED STONE BEDDING USED FOR BOTH INSIDE - ³4" Crushed Stone Bedding DIAMETER PVC AND DI SEWER AND DRAINS FILTER FABRIC (SEE TABLE)

DRAINAGE TRENCH

5 SCALE: NTS Stantec

226 Causeway Street Boston MA U.S.A., 02114 www.stantec.com P.617.523.8103

Copyright Reserved

The Contractor shall verify and be responsible for all dimensions. DO NOT scale the drawing - any errors or omissions shall be reported to Stantec without delay. The Copyrights to all designs and drawings are the property of Stantec. Reproduction or use for any purpose other than that authorized by Stantec is forbidden.

Chestnut Hill Realty



			<u></u>
			·
			·
VARIOUS EDITS	JM	ТРК	10.24.14
VARIOUS EDITS	CL/JM	TPK	08.29.14
SPECIAL PERMIT FILING	CL/JM	TPK	08.04.14
VARIOUS EDITS	CL/JM	TPK	07.14.14
SITE PLAN	JM	TPK	11.26.13
Issued	By	Appd.	MM.DD.YY

JM/CL Dwn. Chkd. Dsgn. MM.DD.YY

File Name: Permit-Seal

Client/Project

CHESTNUT HILL REALTY

THE RESIDENCES AT **KESSELER WOODS**

NEWTON, MA

Title

SITE DETAILS 5

Project No. 210801167

Scale AS NOTED

> Drawing No. L-704

I. REFER TO PAVING AND SURFACING, AND CURBS, WALKS AND DRIVEWAYS REQUIREMENTS. 2. REFER TO LANDSCAPING REQUIREMENTS 3. REFER TO "TRENCH PAY LIMIT TABLE FOR PIPES" FOR

NOTES:

PAYMENT OF ALL ITEMS IN WHICH PAY TRENCH WIDTH IS A VARIABLE FOR CALCULATIONS OF QUANTITIES EXCEPT FOR TRENCH PAVEMENT 4. REFER TO TRENCH PAVEMENT DETAIL FOR PAVEMENT PAYMENT WIDTHS


TRENCH PAY LIMIT TABLE FOR PIPES


PIPE SIZE (DIA.)	MAX TRENCH WIDTH
LESS THAN 2"	2'-0"
2" TO 6"	3'-0"
8" TO 22"	4'-0"
24" & GREATER	I.D. + 2'-0"
I.D. = INSIDE DIMENSIO	N

FOR TRENCHES GREATER THAT 5' DEEP ADD MAXIMUM 3' FOR TEMPORARY

SUPPORT OF EXCAVATION

NG		FILTER FAI	BRIC USE
		SOIL	TYPE
		SILT OR CLAY	GRANULAR SOIL
	ABOVE GROUND WATER	FILTER FABRIC NOT REQUIRED	FILTER FABRIC NOT REQUIRED
5	BELOW GROUND WATER	FILTER FABRIC REQUIRED	FILTER FABRIC NOT REQUIRED

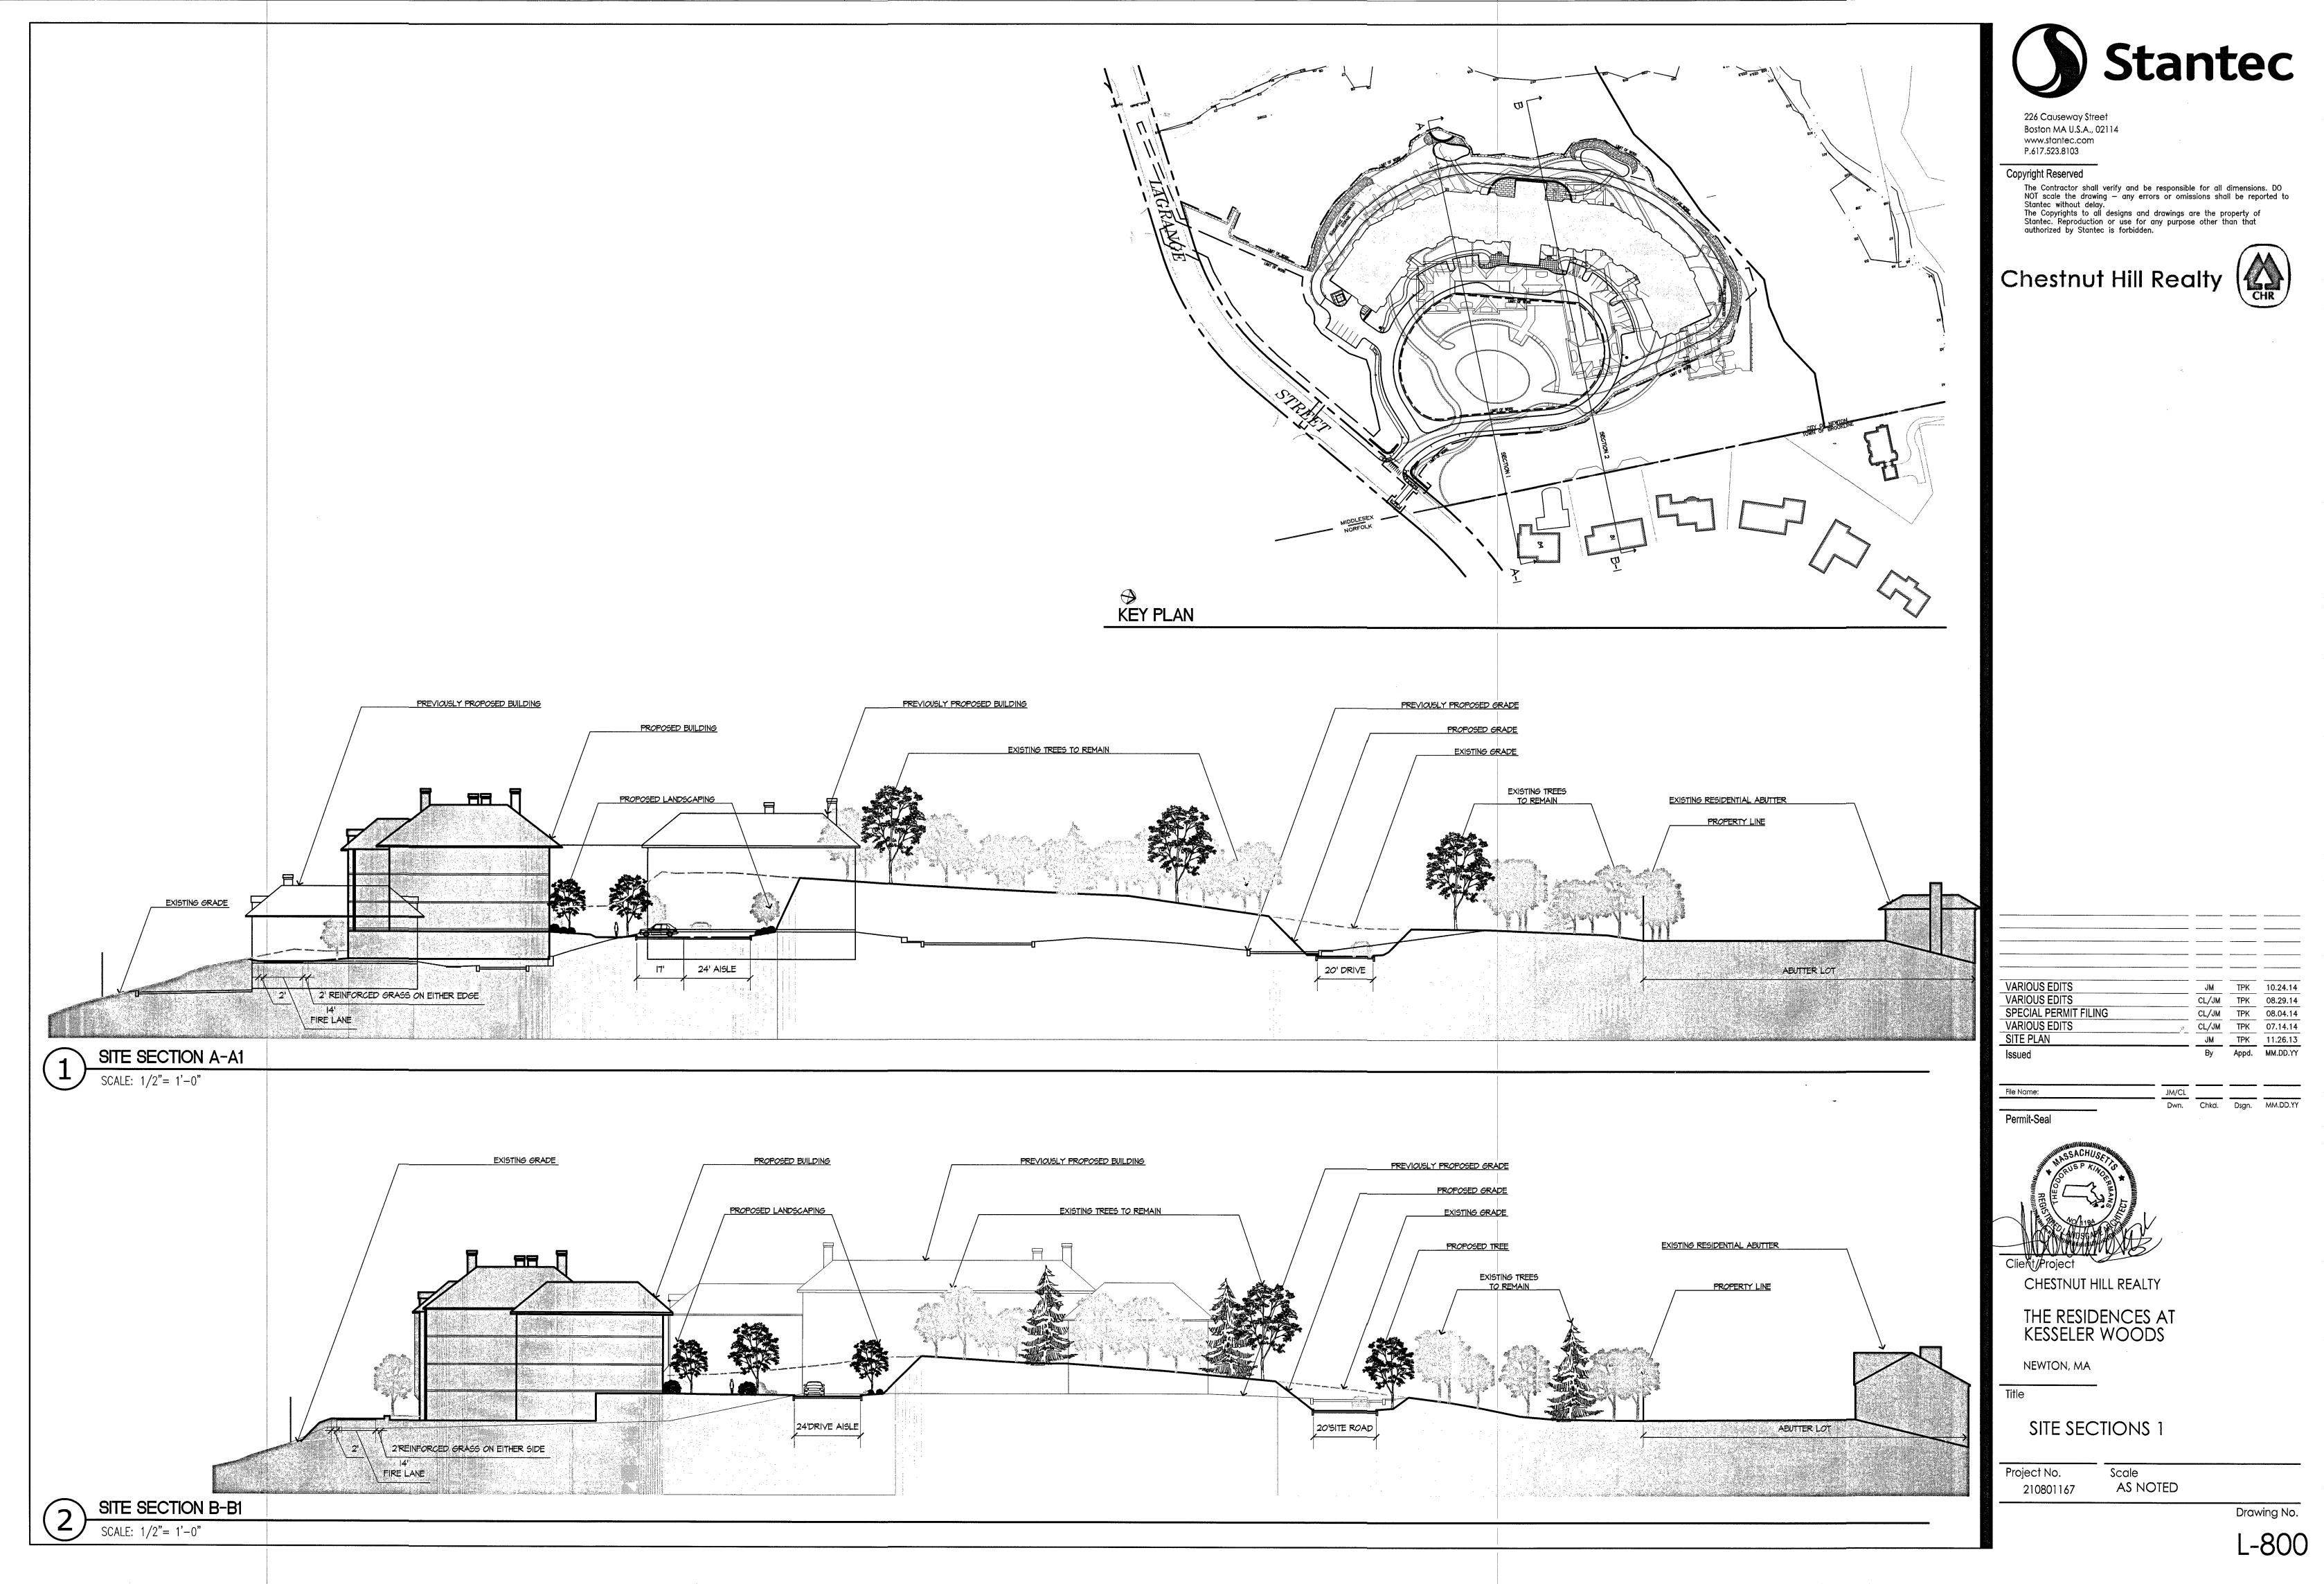

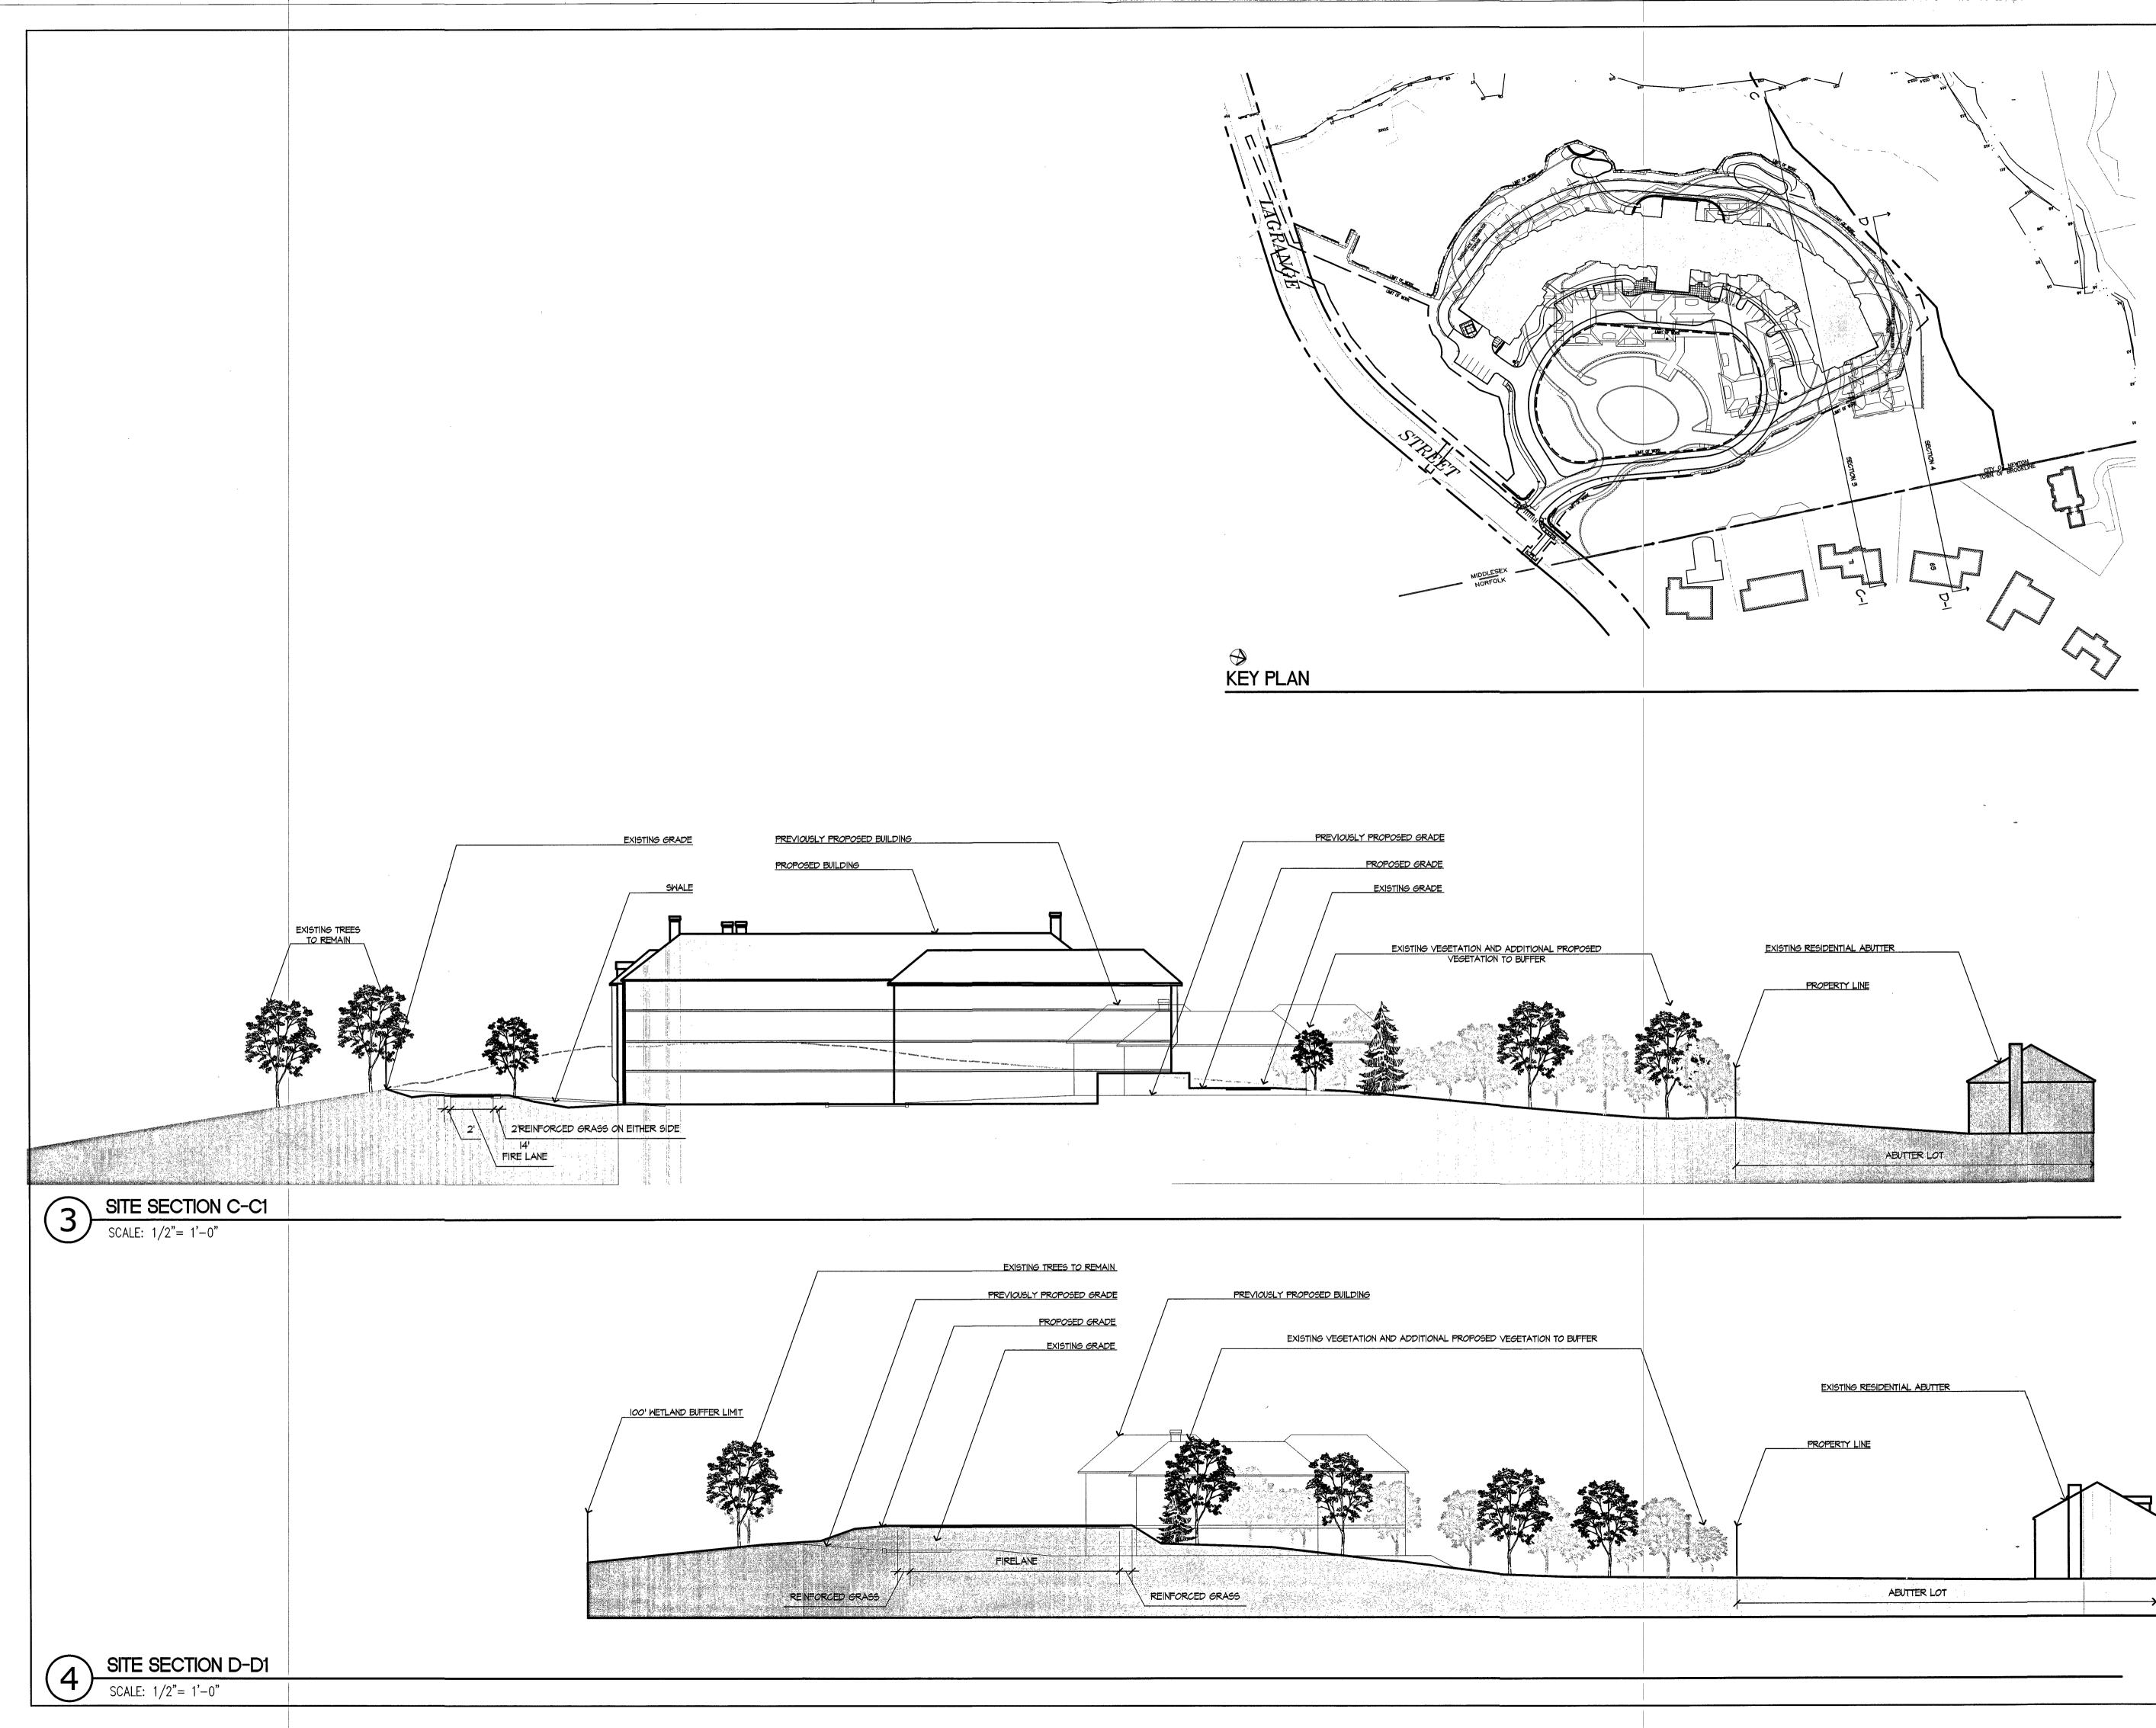



Copyright Reserved

The Contractor shall verify and be responsible for all dimensions. DO NOT scale the drawing — any errors or omissions shall be reported to Stantec without delay. The Copyrights to all designs and drawings are the property of Stantec. Reproduction or use for any purpose other than that authorized by Stantec is forbidden.

Chestnut Hill Realty



		<u> </u>	
VARIOUS EDITS	JM	TPK	10.24.14
VARIOUS EDITS	CL/JM	TPK	08.29.14
SPECIAL PERMIT FILING	CL/JM	TPK	08.04.14
VARIOUS EDITS	CL/JM	TPK	07.14.14
SITE PLAN	JM	TPK	11.26.13
lssued	Ву	Appd.	MM.DD.YY

JM/CL

Dwn. Chkd. Dsgn. MM.DD.YY

Permit-Seal

File Name:

Client/Project

CHESTNUT HILL REALTY


THE RESIDENCES AT KESSELER WOODS


NEWTON, MA

Title

SITE SECTIONS 2

Project No. Scale 210801167 AS NOTED Project No.

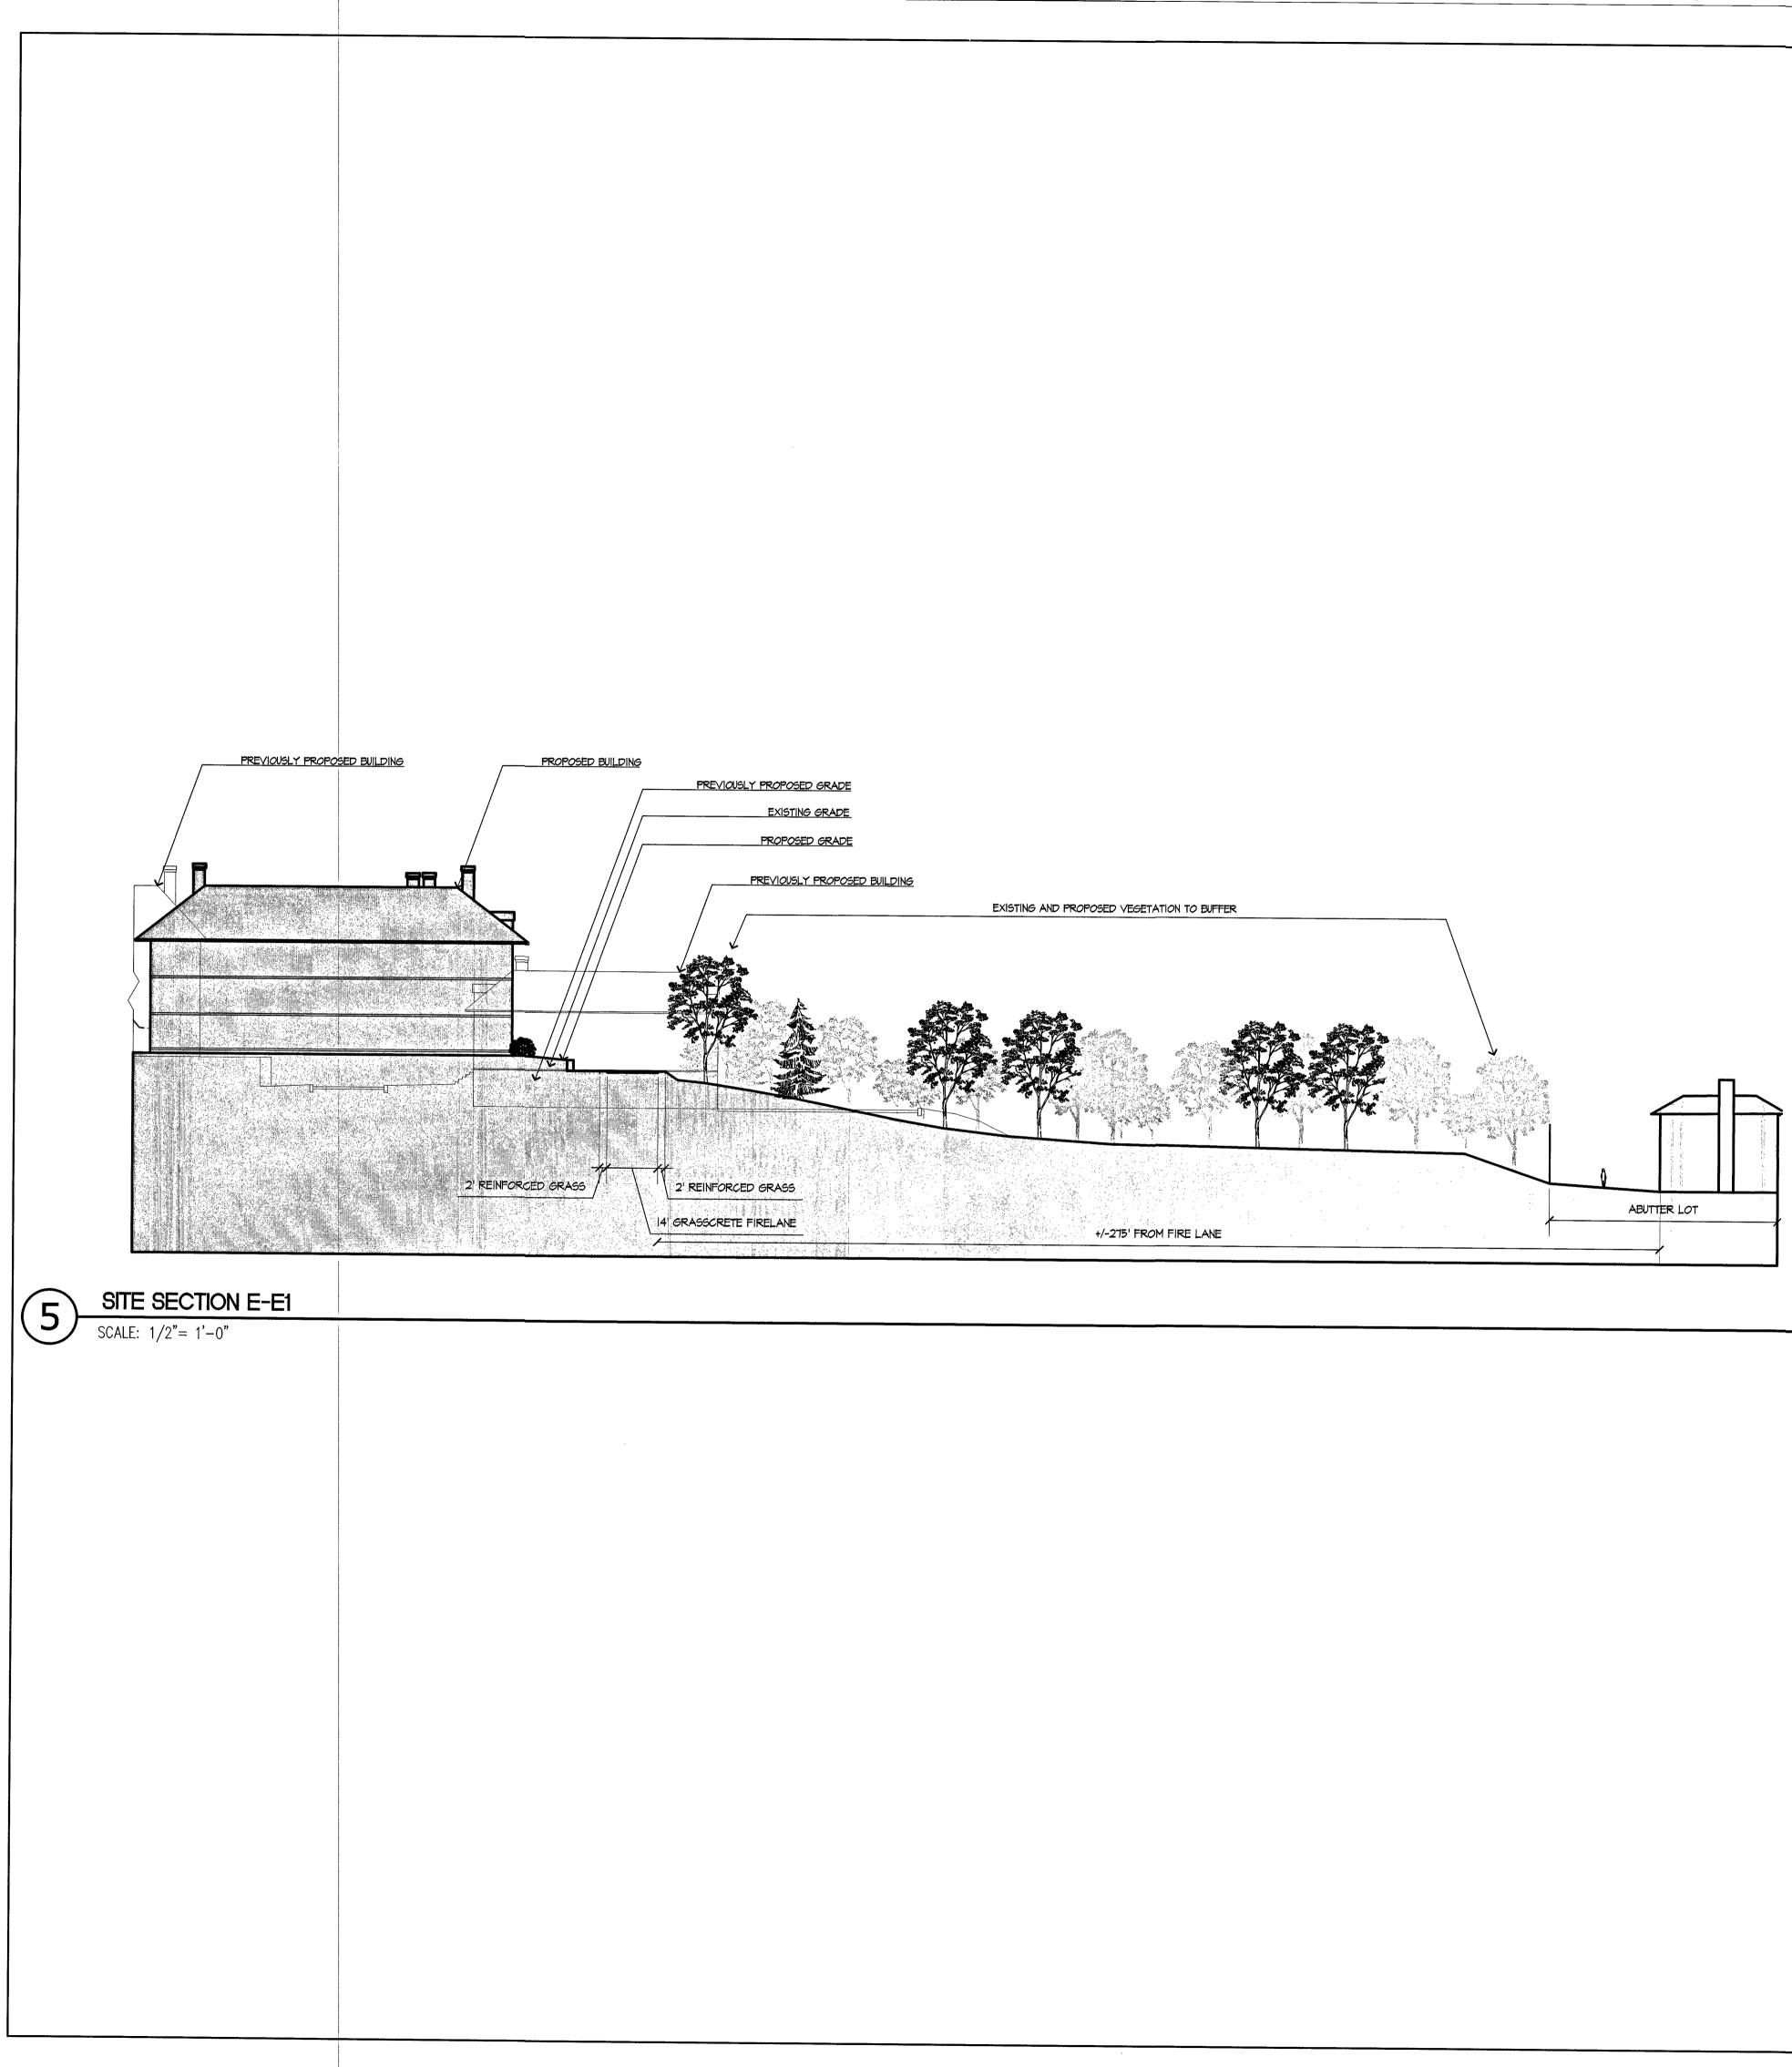

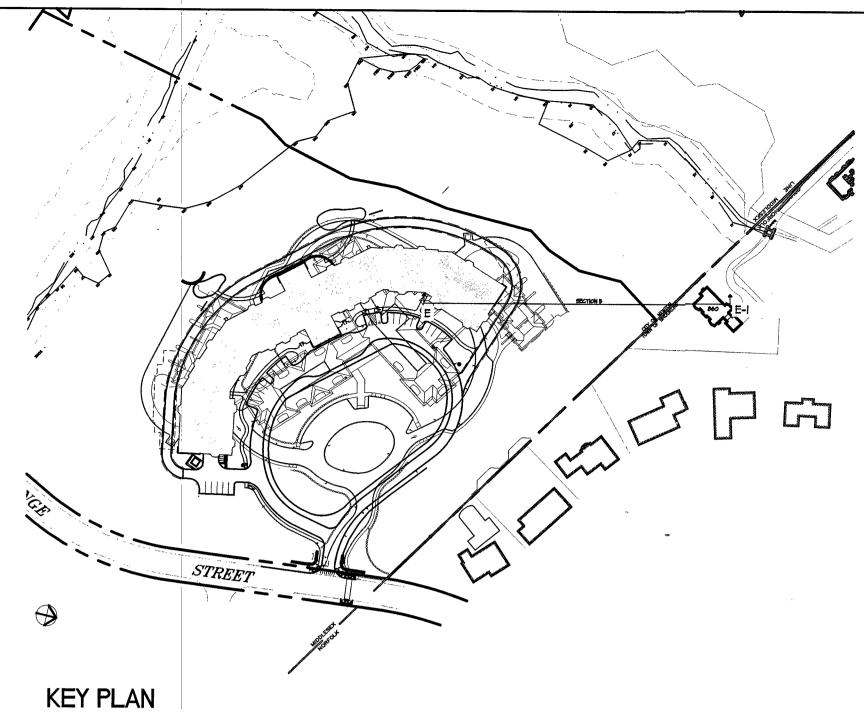



Copyright Reserved

The Contractor shall verify and be responsible for all dimensions. DO NOT scale the drawing — any errors or omissions shall be reported to Stantec without delay. The Copyrights to all designs and drawings are the property of Stantec. Reproduction or use for any purpose other than that authorized by Stantec is forbidden.

Chestnut Hill Realty



	·····		
	·····		
	ð.		
VARIOUS EDITS	JM	TPK	10.24.14
VARIOUS EDITS	CL/JM	TPK	08.29.14
SPECIAL PERMIT FILING	CL/JM	TPK	08.04.14
VARIOUS EDITS	CL/JM	TPK	07.14.14
SITE PLAN	JM	TPK	11.26.13
lssued	By	Appd.	MM.DD.Y

JM/CL

Dwn. Chkd. Dsgn. MM.DD.YY

Permit-Seal

File Name:

Client/Project

CHESTNUT HILL REALTY

THE RESIDENCES AT KESSELER WOODS


NEWTON, MA


Title

SITE SECTIONS 3

Project No. 210801167

Scale AS NOTED

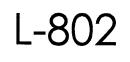

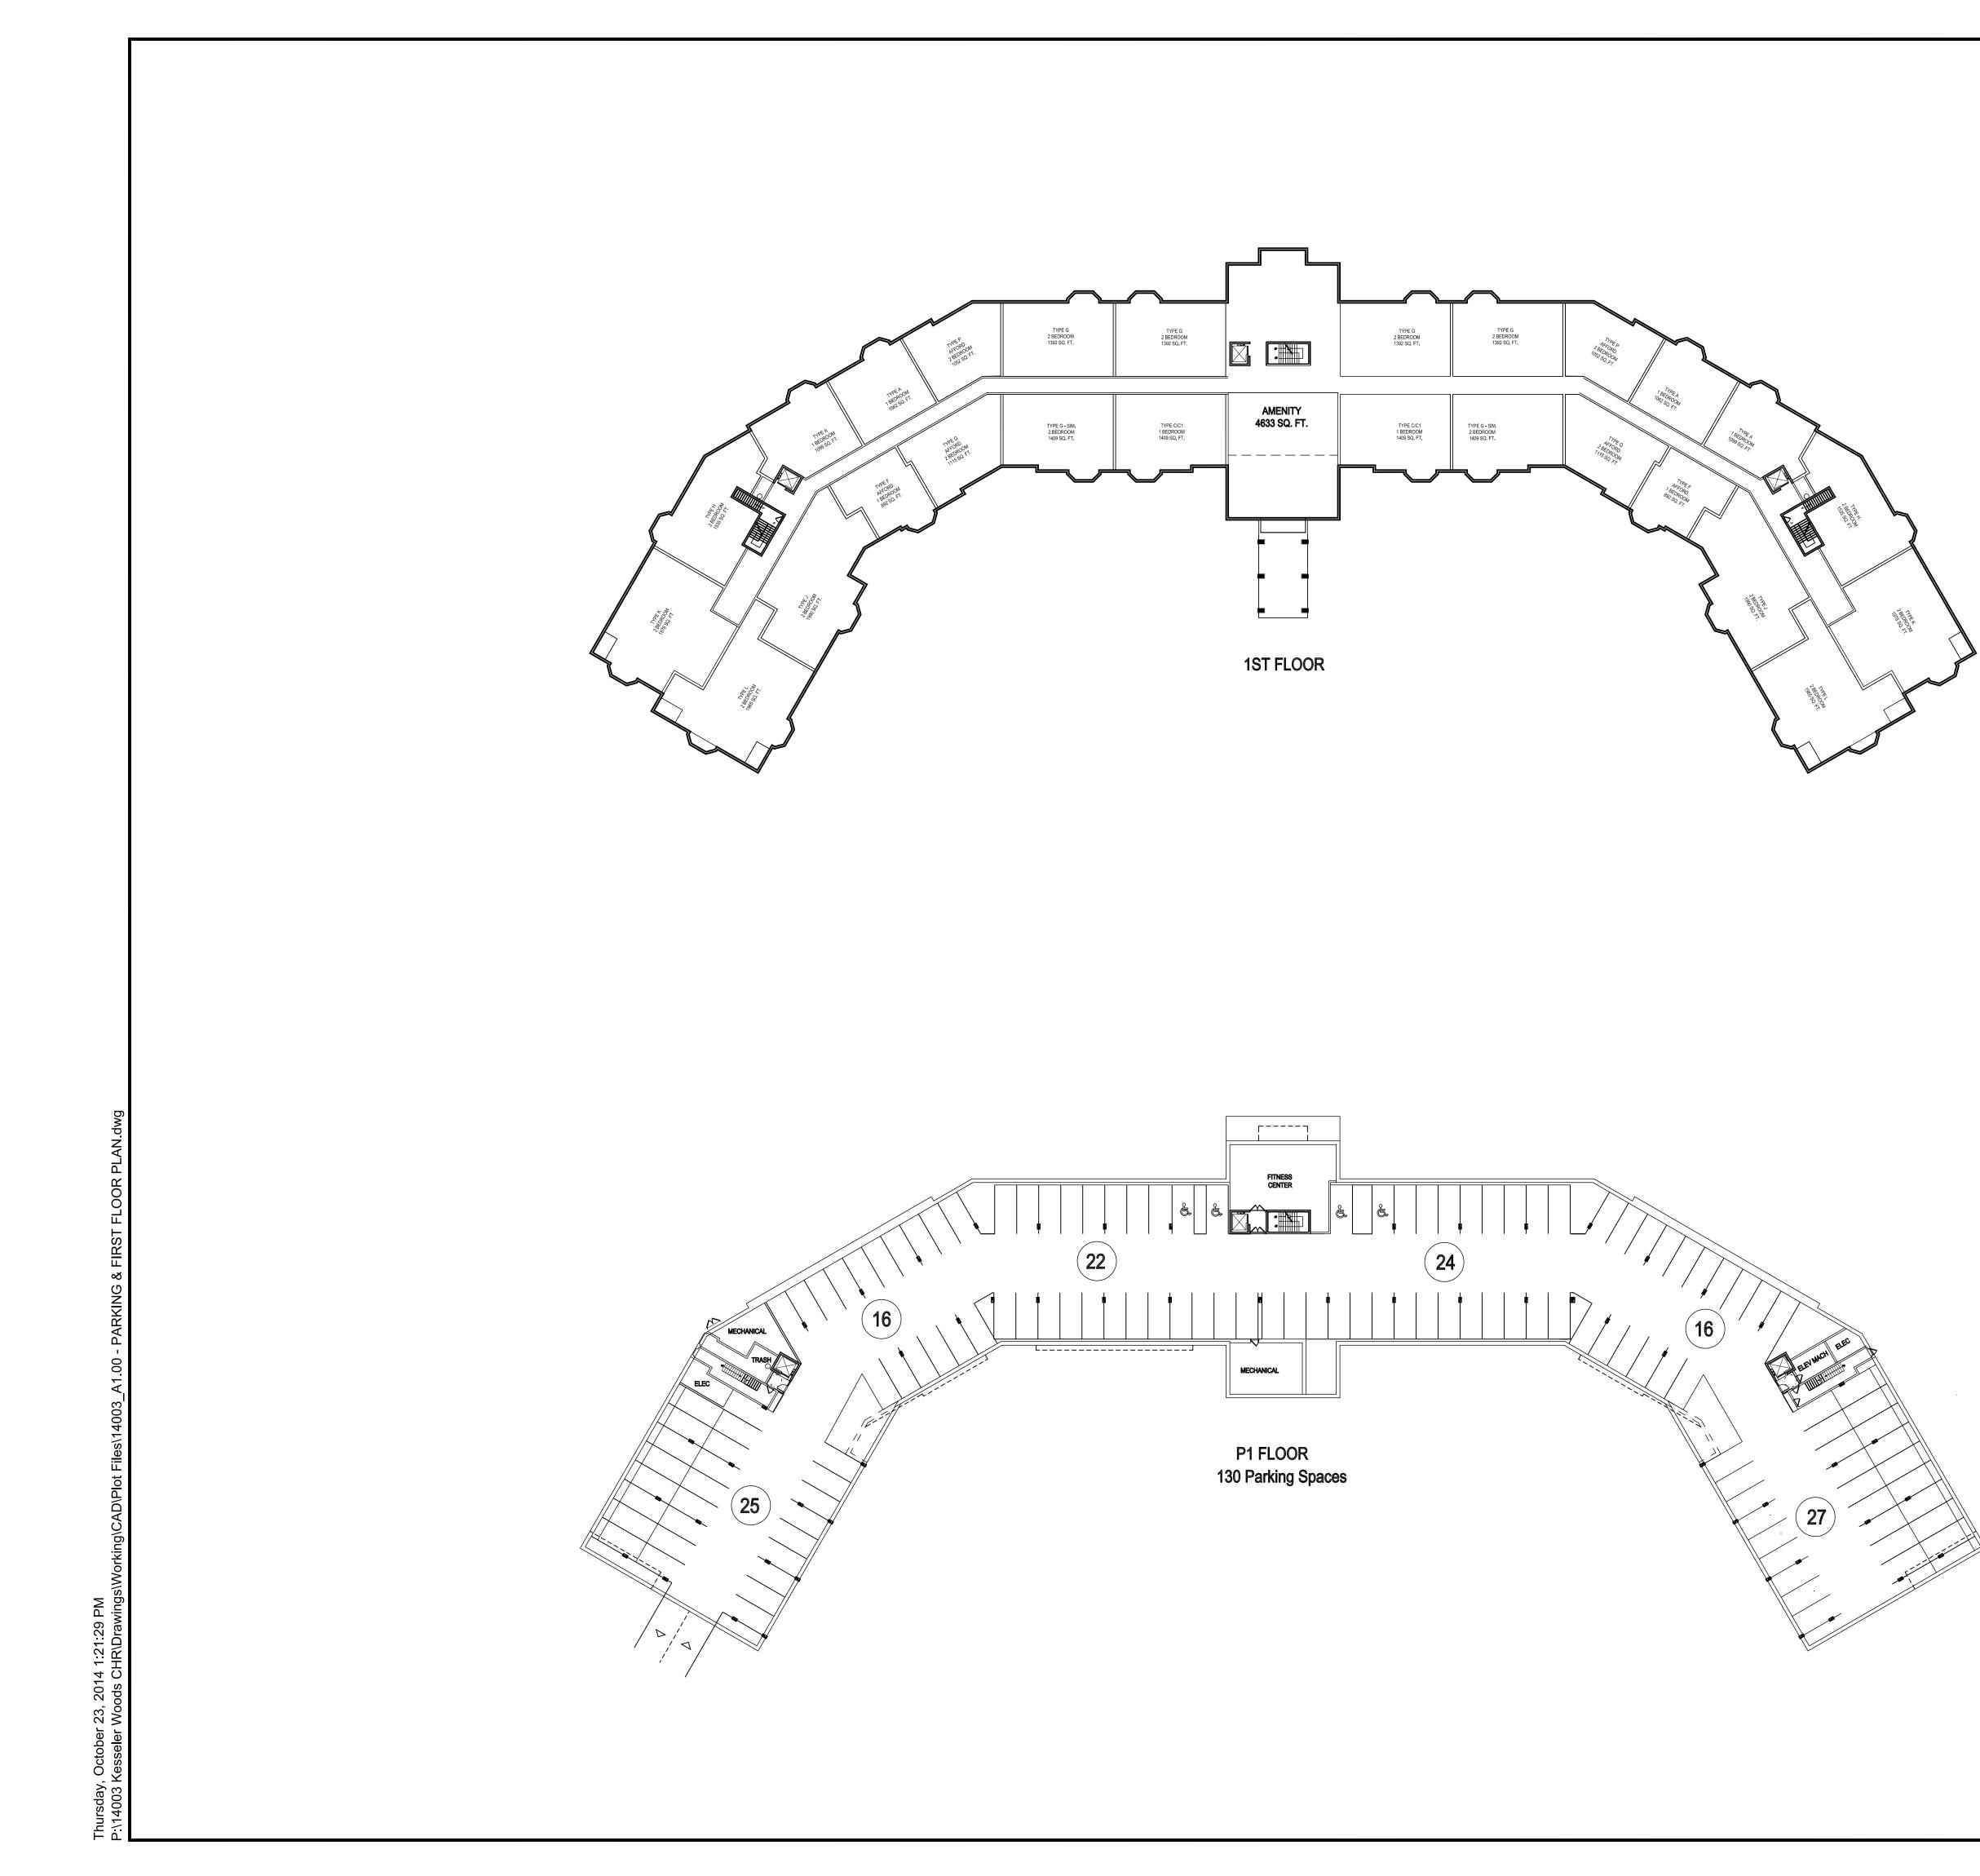

	BUILDING UNIT MIX	
	24 (1) BEDROOM UNITS	195,650 TOTAL
80 UNITS	56 (2) BEDROOM UNITS	
0 UNITS	130 PARKING SPACES (4 HP)	48,560 GSF
P1		
	2 (1) AFFORD. BEDROOM UNITS	48,950 GSF
26 UNITS	6 (1) MARKET. BEDROOM UNITS	
1st FLOOR	4 (2) AFFORD. BEDROOM UNITS	
	14 (2) MARKET BEDROOM UNITS	
	2 (1) AFFORD. BEDROOM UNITS	49,070 GSF
26 UNITS	4 (1) MARKET. BEDROOM UNITS	
2nd FLOOR	4 (2) AFFORD, BEDROOM UNITS	
	16 (2) MARKET BEDROOM UNITS	
28 UNITS	10 (1) MARKET BEDROOM UNITS	49,070 GSF
3rd FLOOR	18 (2) MARKET BEDROOM UNITS	



50 Commandant's Way at Admiral's Hill Chelsea MA 02150 **T** 617.889.4402 **F** 617.884.4329 www.architecturalteam.com ©2011 The Architectural Team, Inc.

Consultant:

Revision: $\underline{\uparrow}$ - REV 1 - AUGUST 29, 2014 $\underline{\uparrow}$ - REV 2 - OCTOBER 24, 2014

Architect of Record:

Drawn: A.S. Checked: T.E.S. Scale: 1/32" = 1'-0" Key Plan:

Project Name: Kesseler Woods

Sheet Name:

<u>FLOOR PLAN:</u> PARKING FLOOR PLAN & FIRST FLOOR PLAN


Project Number:

14003

Issue Date: August 22, 2014

Sheet Number:

A1.00

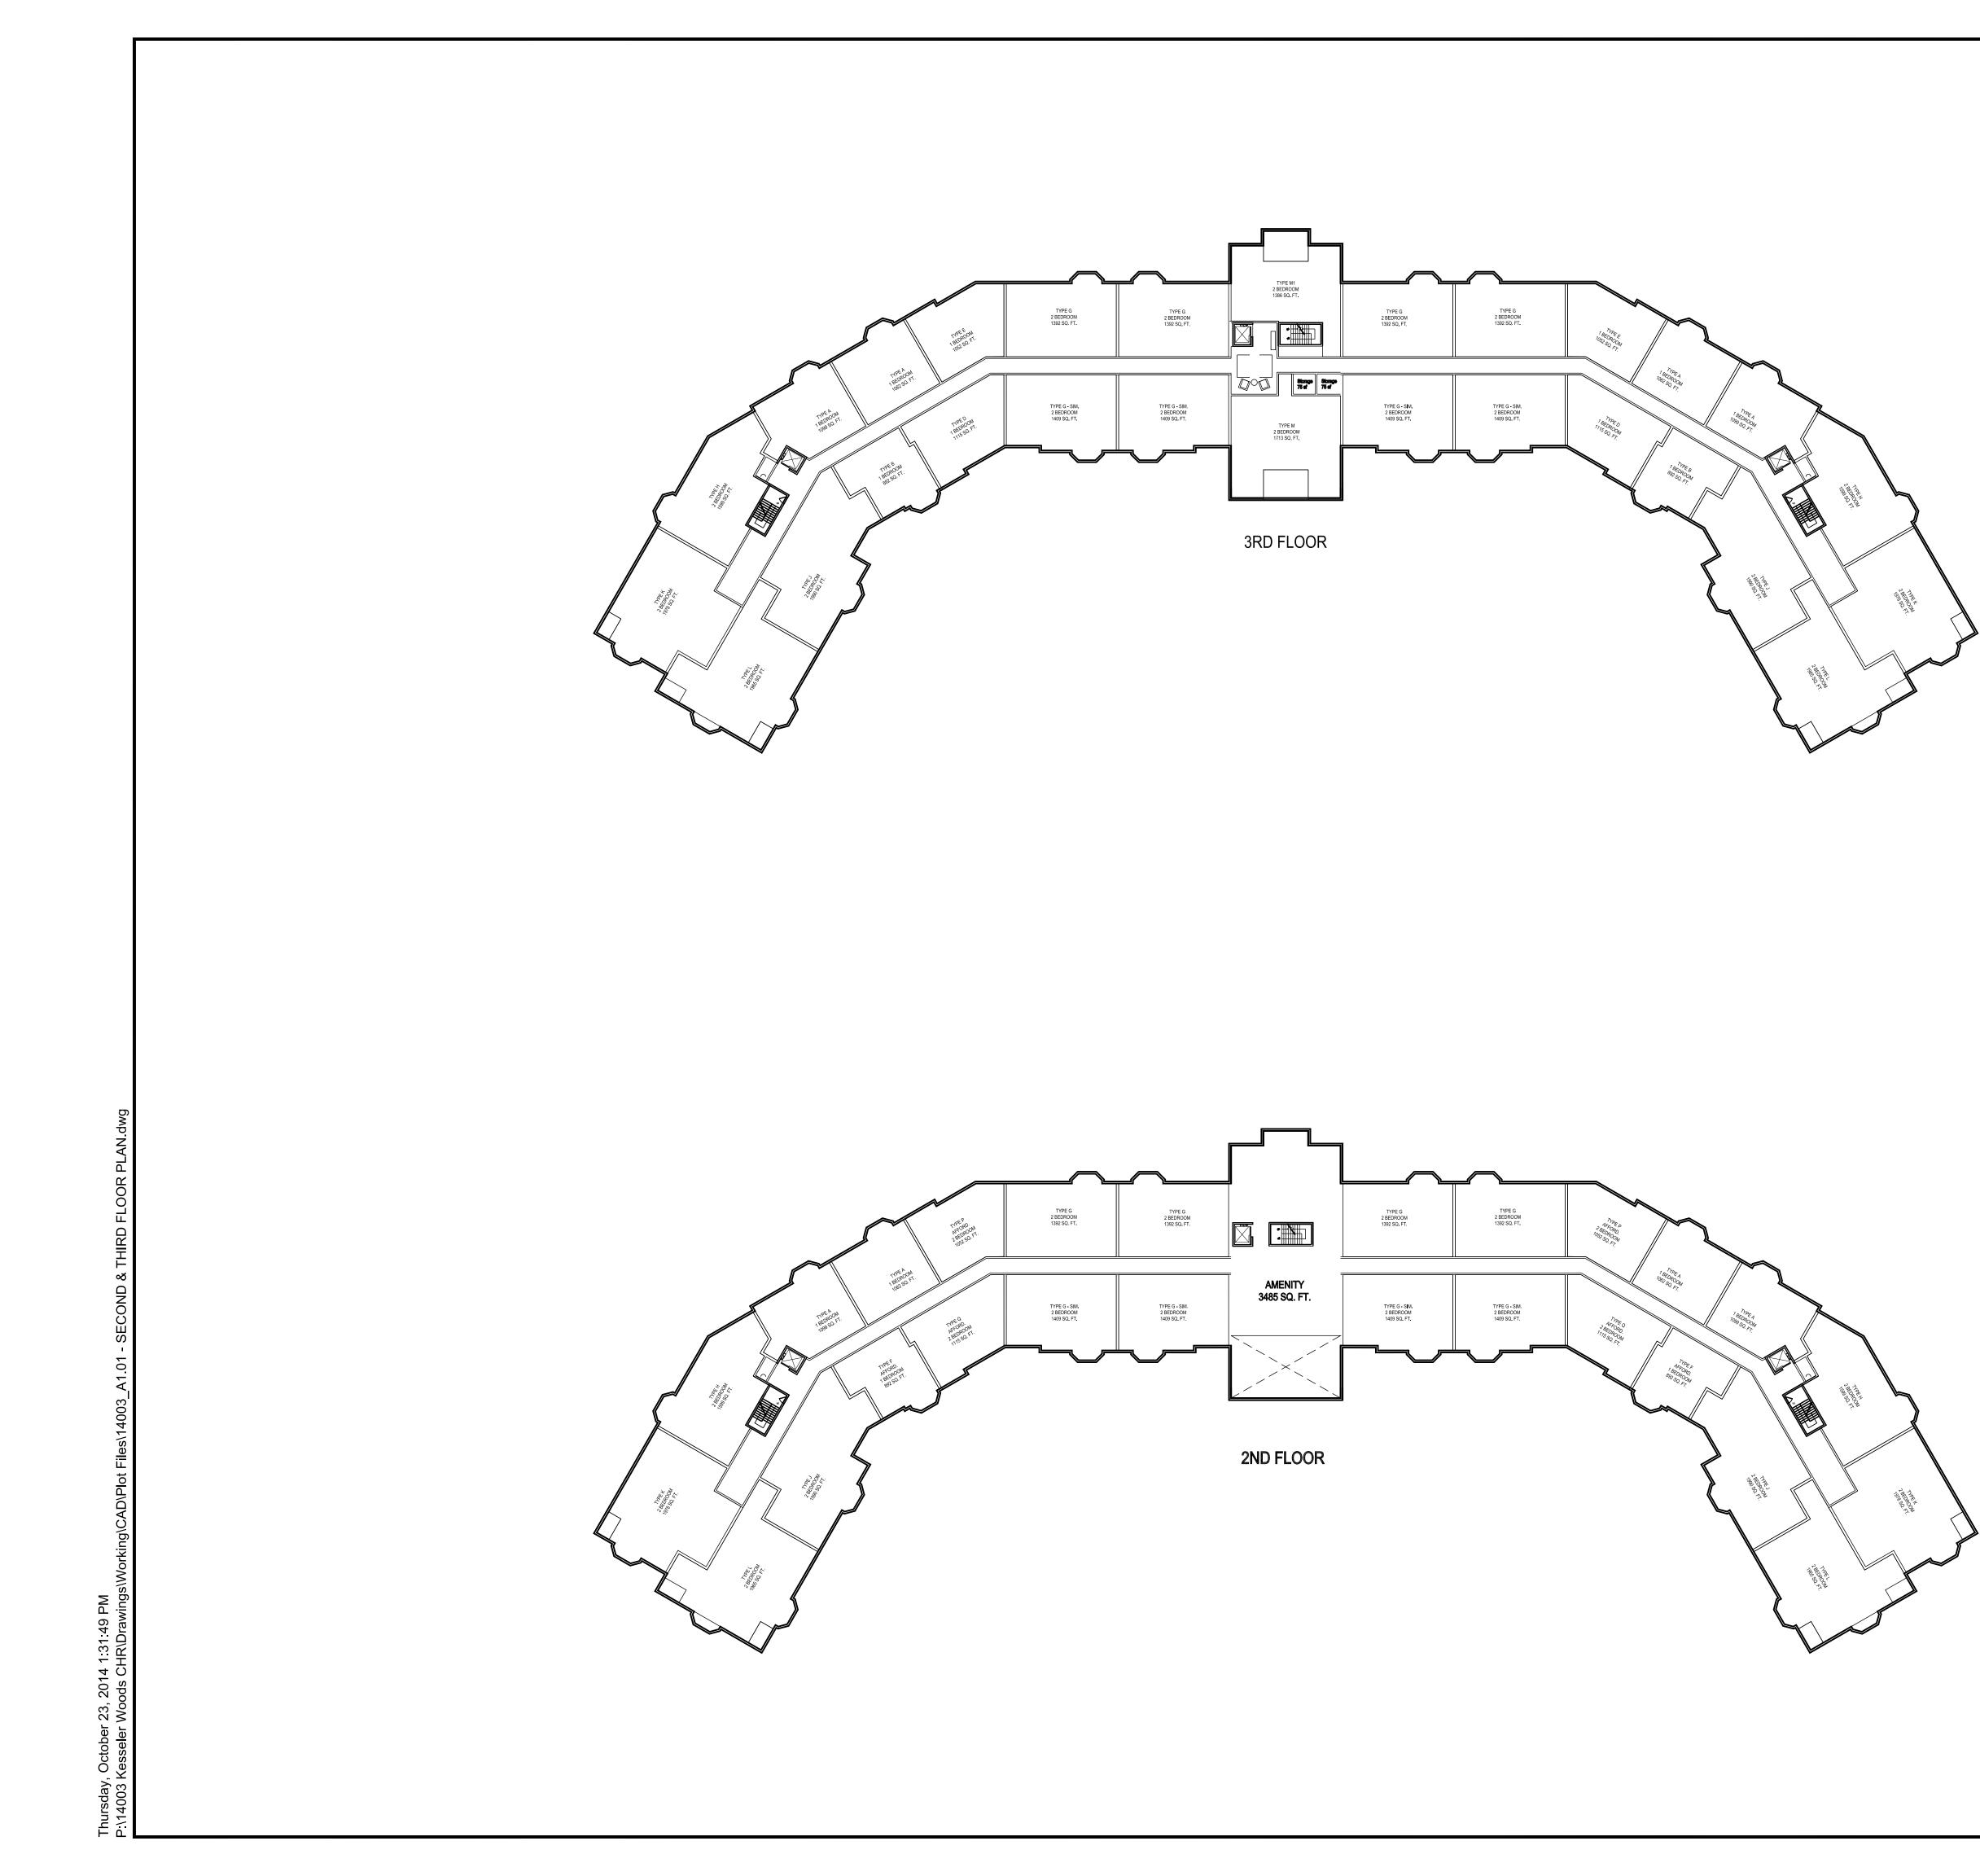

	BUILDING UNIT MIX	
	24 (1) BEDROOM UNITS	195,650 TOTAL
80 UNITS	56 (2) BEDROOM UNITS	
0 UNITS	130 PARKING SPACES (4 HP)	48,560 GSF
P1		
	2 (1) AFFORD. BEDROOM UNITS	48,950 GSF
26 UNITS	6 (1) MARKET. BEDROOM UNITS	
1st FLOOR	4 (2) AFFORD. BEDROOM UNITS	
	14 (2) MARKET BEDROOM UNITS	
	2 (1) AFFORD. BEDROOM UNITS	49,070 GSF
26 UNITS	4 (1) MARKET. BEDROOM UNITS	
2nd FLOOR	4 (2) AFFORD, BEDROOM UNITS	
	16 (2) MARKET BEDROOM UNITS	
28 UNITS	10 (1) MARKET BEDROOM UNITS	49,070 GSF
3rd FLOOR	18 (2) MARKET BEDROOM UNITS	



50 Commandant's Way at Admiral's Hill Chelsea MA 02150 **T** 617.889.4402 **F** 617.884.4329 www.architecturalteam.com ©2011 The Architectural Team, Inc.

Consultant:

Revision: $\underline{\uparrow}$ - REV 1 - AUGUST 29, 2014 $\underline{\uparrow}$ - REV 2 - OCTOBER 24, 2014

Architect of Record:

Drawn: A.S. Checked: T.E.S. Scale: 1/32" = 1'-0" Key Plan:

Project Name: Kesseler Woods

Sheet Name:

<u>FLOOR PLAN:</u> SECOND FLOOR PLAN & THIRD FLOOR PLAN


Project Number:

14003


Issue Date: August 22, 2014

Sheet Number:

A1.01

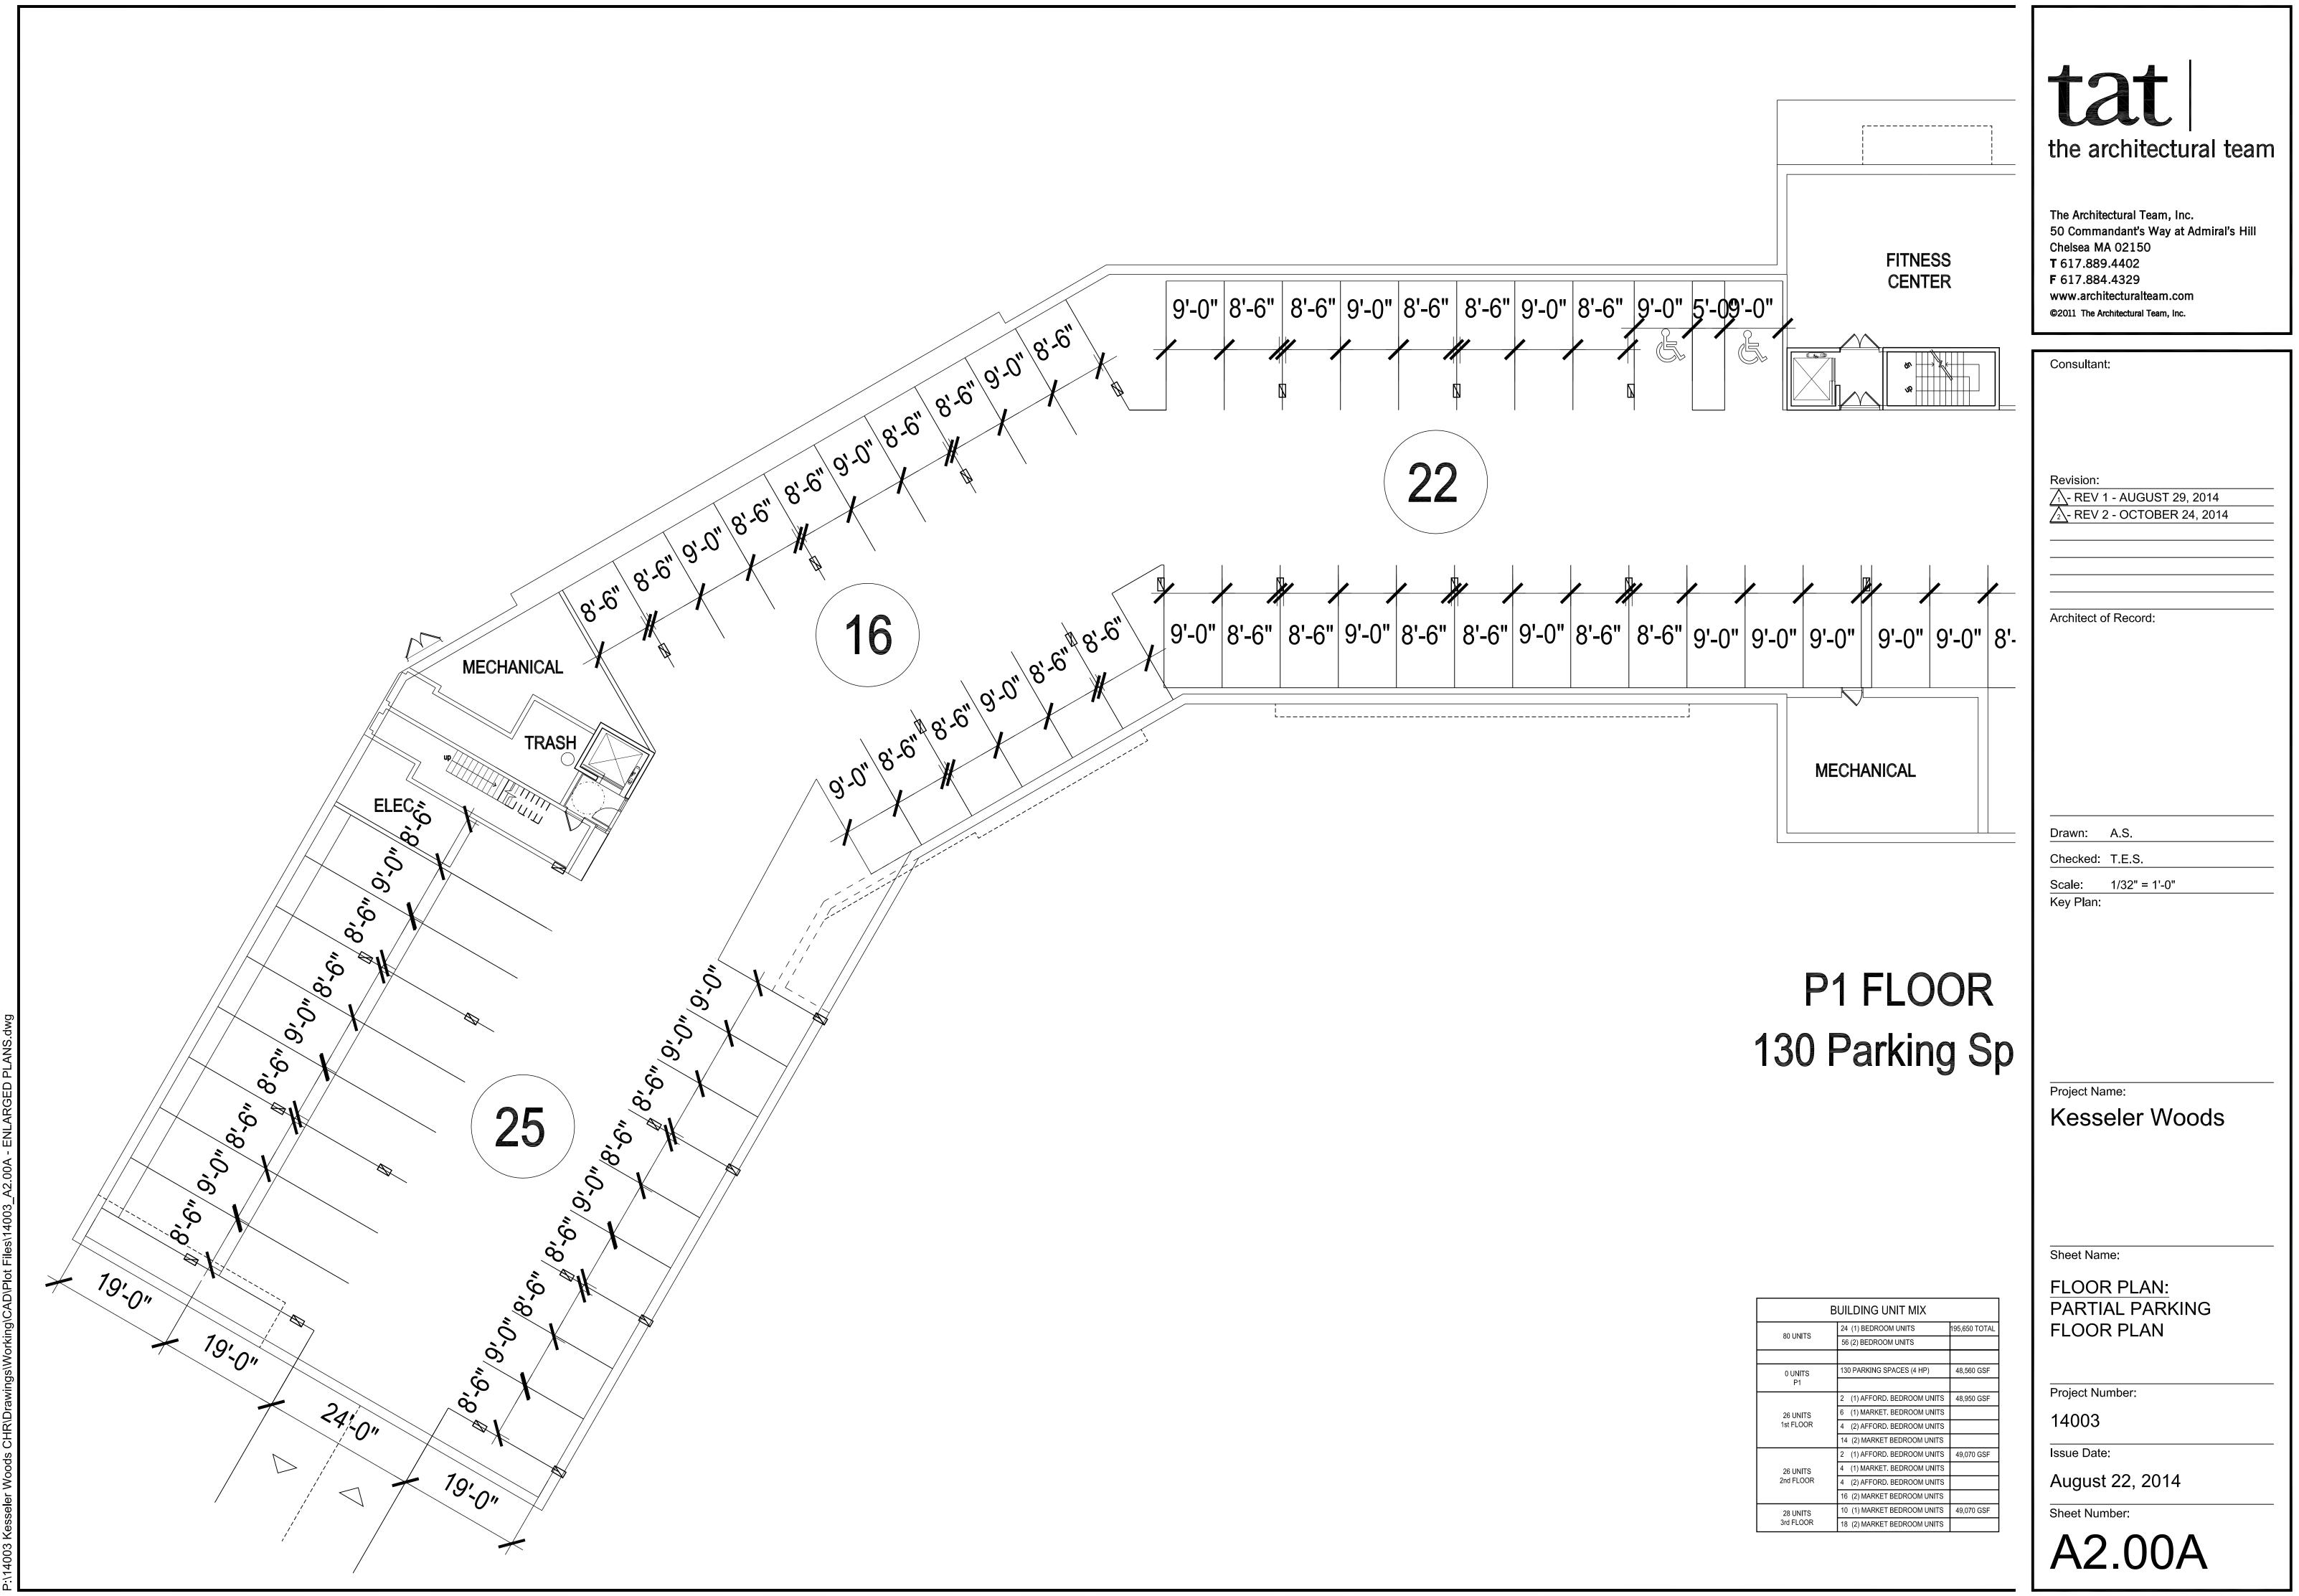

Thursday, October 23, 2014 1:19:06 PM P:\14003 Kesseler Woods CHR\Drawings\Working\CAD\Plot Files\14003_A2.00A - ENLARGED PLANS.dw(

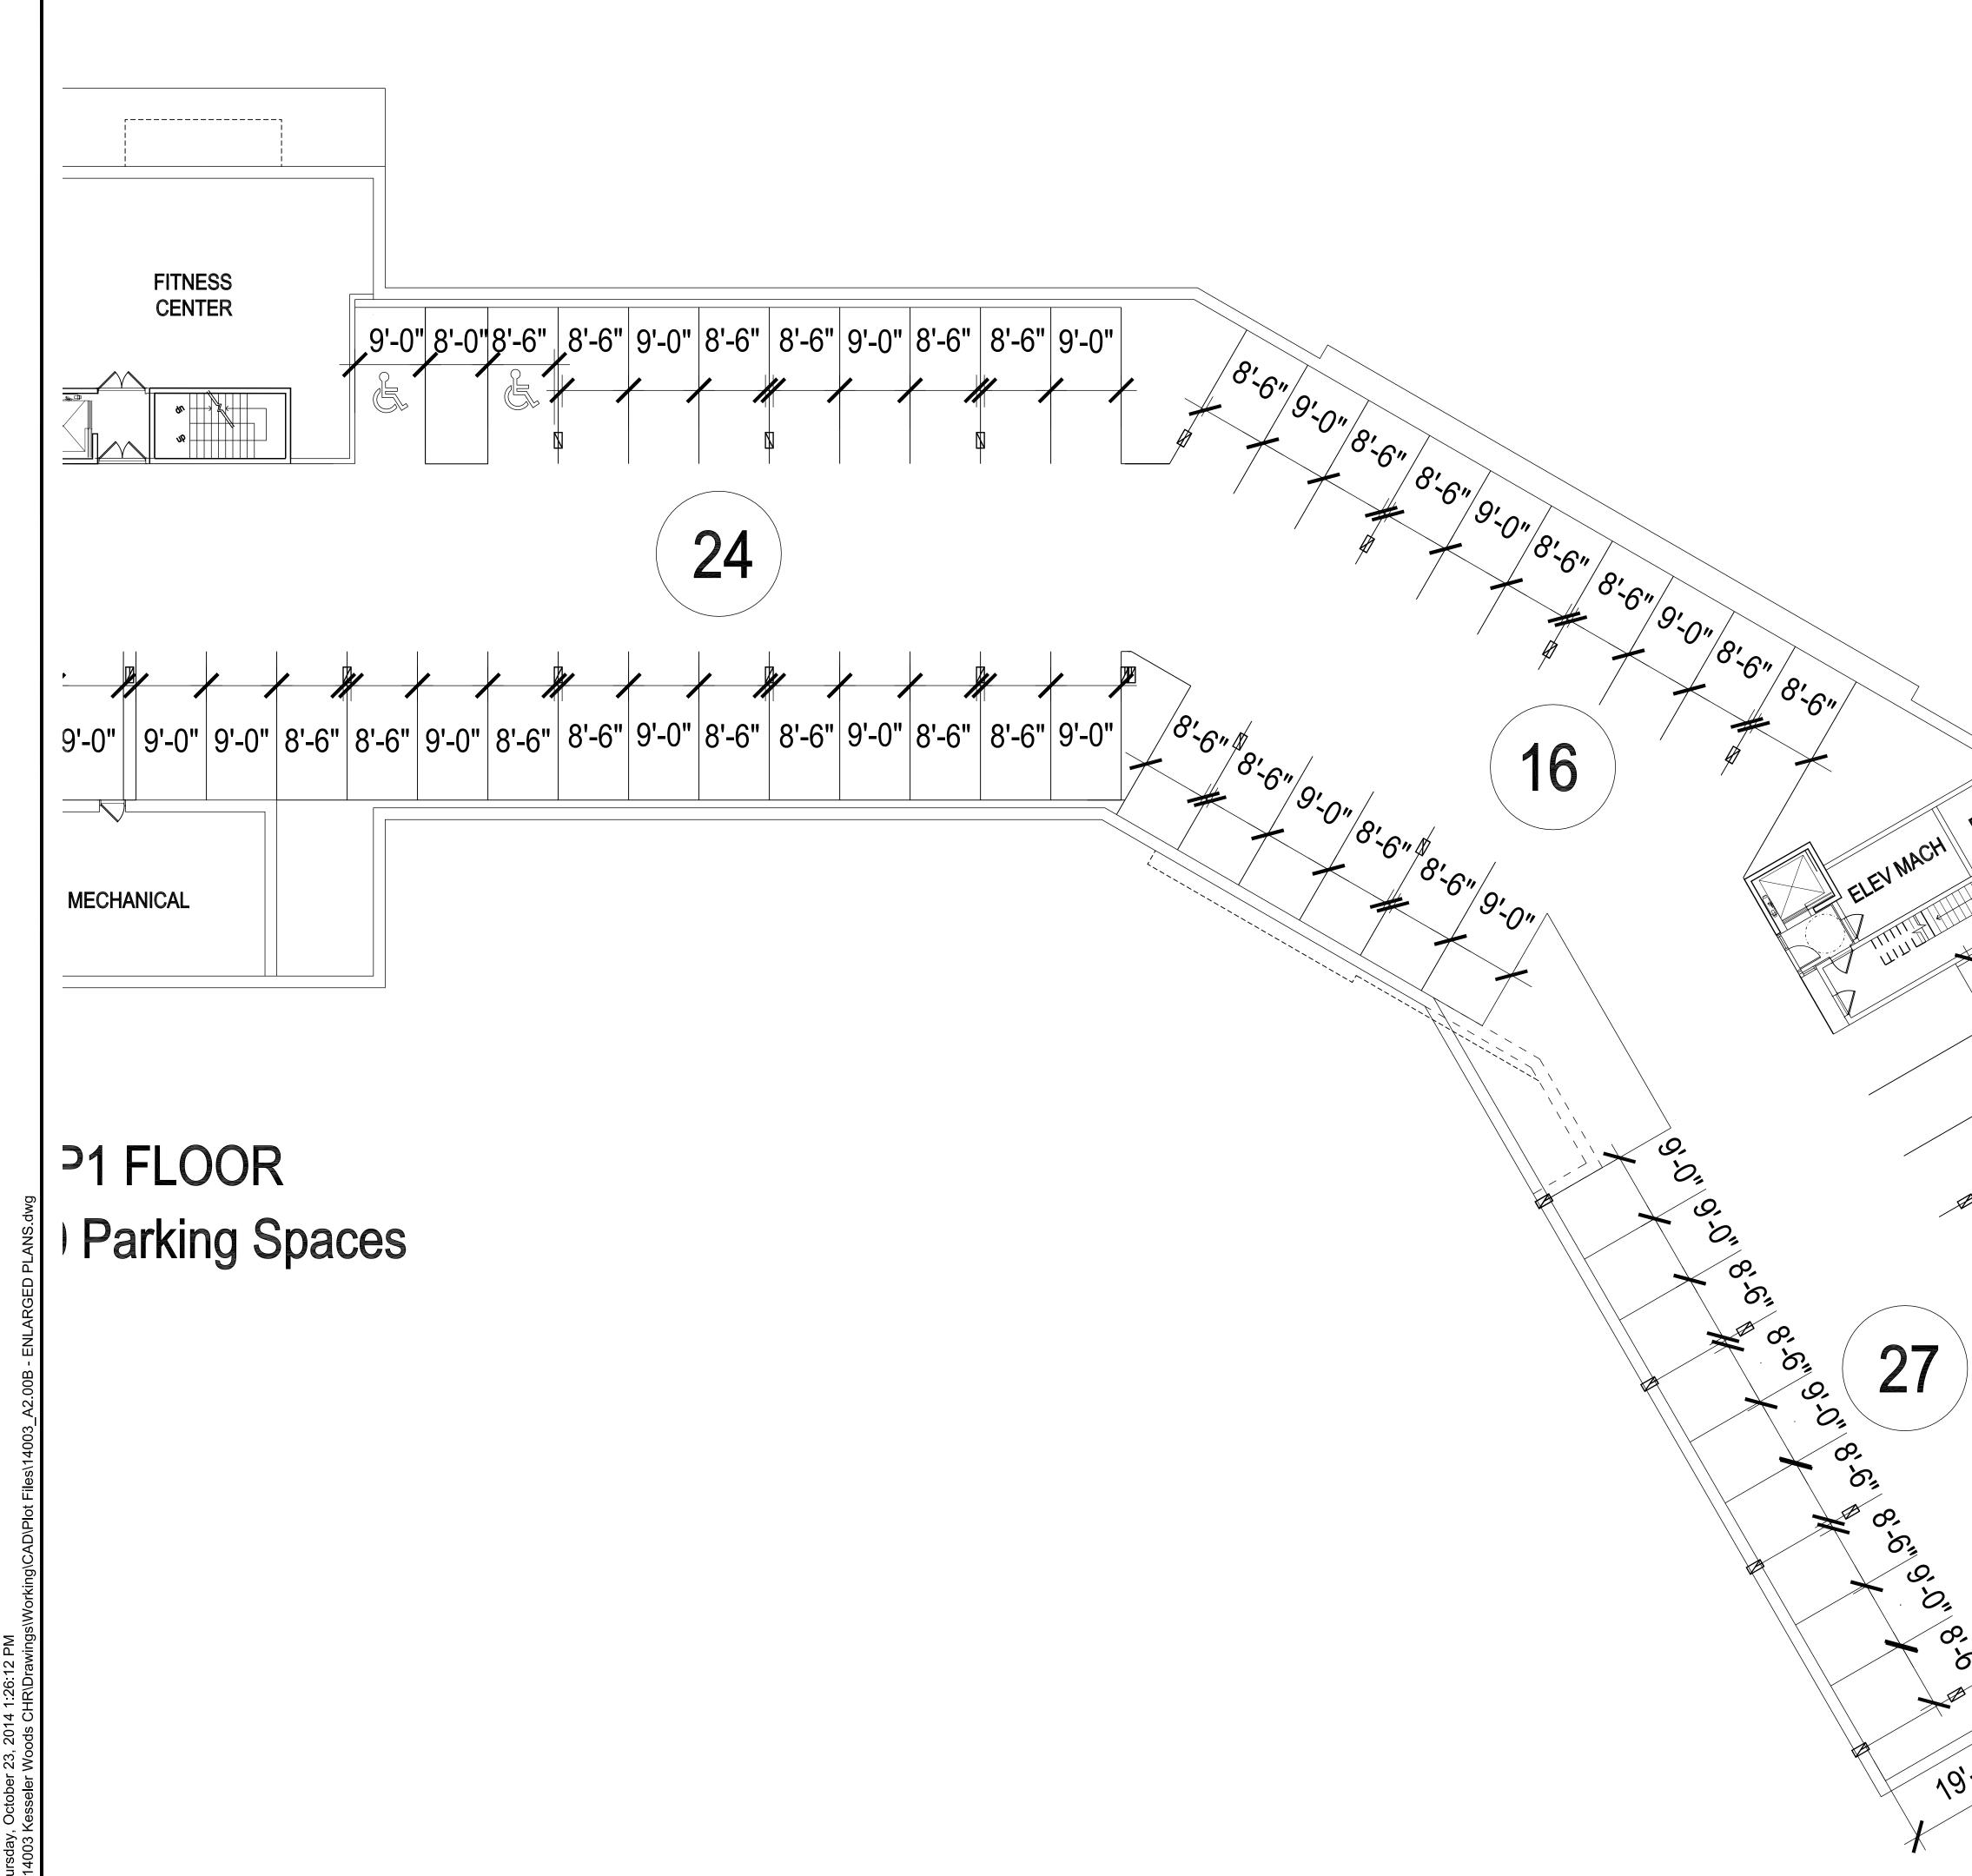

	BUILDING UNIT MIX	
	24 (1) BEDROOM UNITS	195,650 TOTAL
80 UNITS	56 (2) BEDROOM UNITS	
0 UNITS	130 PARKING SPACES (4 HP)	48,560 GSF
P1		
	2 (1) AFFORD. BEDROOM UNITS	48,950 GSF
26 UNITS	6 (1) MARKET. BEDROOM UNITS	
1st FLOOR	4 (2) AFFORD. BEDROOM UNITS	
	14 (2) MARKET BEDROOM UNITS	
	2 (1) AFFORD. BEDROOM UNITS	49,070 GSF
26 UNITS	4 (1) MARKET. BEDROOM UNITS	
2nd FLOOR	4 (2) AFFORD, BEDROOM UNITS	
	16 (2) MARKET BEDROOM UNITS	
28 UNITS	10 (1) MARKET BEDROOM UNITS	49,070 GSF
3rd FLOOR	18 (2) MARKET BEDROOM UNITS	

ELEC

0, 5,

19'-0"

Ф,

6.

0.

0,

С,

び

6.

 \mathbf{X}

24:-0"

0,

0,

0. 101

0. 0.

0,

19'-0"

0,

0,

6,

19'-0"



Consultant:

Revision: /1- REV 1 - AUGUST 29, 2014 2 - REV 2 - OCTOBER 24, 2014

Architect of Record:

Drawn: A.S. Checked: T.E.S. Scale: 1/32" = 1'-0" Key Plan:

Project Name: Kesseler Woods

Sheet Name:

FLOOR PLAN: PARTIAL PARKING FLOOR PLAN

Project Number:


14003

Issue Date:

August 22, 2014

Sheet Number:



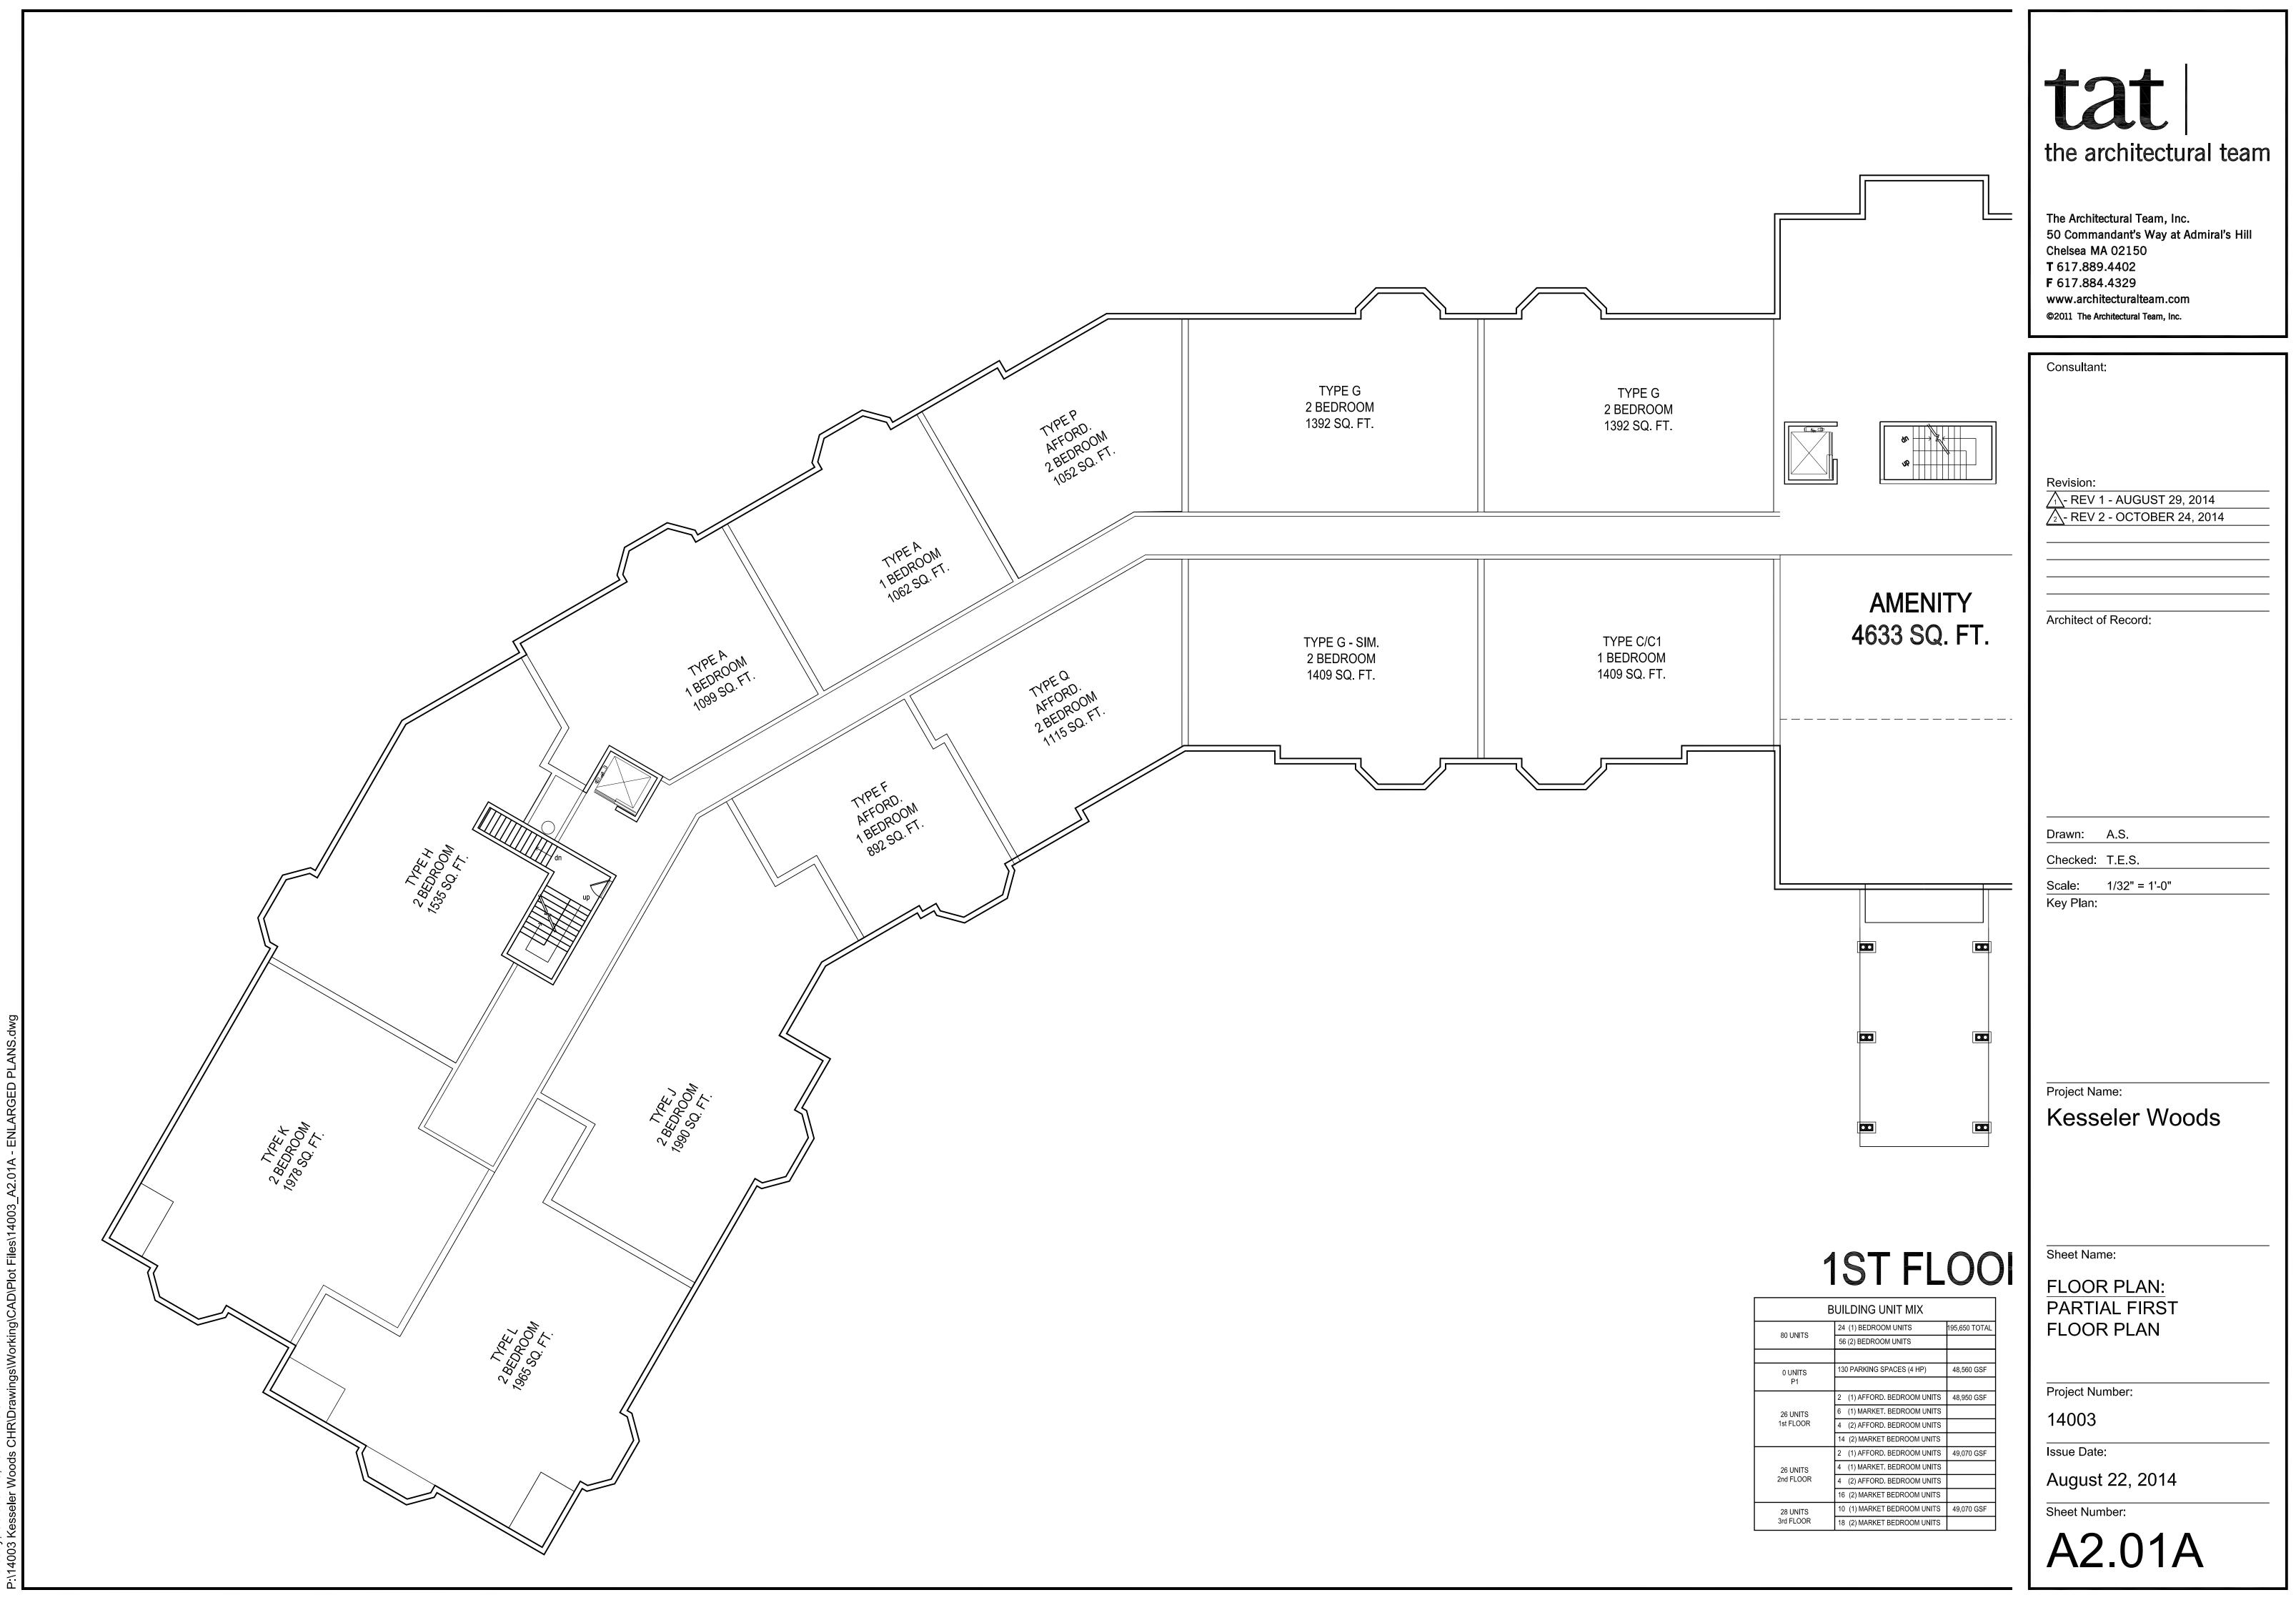

tober 23, 2014 1:25:32 PM seler Woods CHR\Drawing 2 2



⁻hursday, October 23, 2014 1:24:50 PM 2:\14003 Kesseler Woods CHR\Drawings\Working\CAD\Plot Files\14003_A2.01B - ENLARGED PLAN

	BUILDING UNIT MIX	
	24 (1) BEDROOM UNITS	195,650 TOTAL
80 UNITS	56 (2) BEDROOM UNITS	
0 UNITS	130 PARKING SPACES (4 HP)	48,560 GSF
P1		
	2 (1) AFFORD. BEDROOM UNITS	48,950 GSF
26 UNITS	6 (1) MARKET. BEDROOM UNITS	
1st FLOOR	4 (2) AFFORD. BEDROOM UNITS	
	14 (2) MARKET BEDROOM UNITS	
	2 (1) AFFORD. BEDROOM UNITS	49,070 GSF
26 UNITS	4 (1) MARKET. BEDROOM UNITS	
2nd FLOOR	4 (2) AFFORD. BEDROOM UNITS	
	16 (2) MARKET BEDROOM UNITS	
28 UNITS	10 (1) MARKET BEDROOM UNITS	49,070 GSF
3rd FLOOR	18 (2) MARKET BEDROOM UNITS	

1935 SQ. FT

NPEK 1978 SQ. FT



Consultant:

Revision: <u>1</u>- REV 1 - AUGUST 29, 2014 <u>2</u>- REV 2 - OCTOBER 24, 2014

Architect of Record:

Drawn: A.S. Checked: T.E.S. Scale: 1/32" = 1'-0" Key Plan:

Project Name: Kesseler Woods

Sheet Name:

<u>FLOOR PLAN:</u> PARTIAL FIRST FLOOR PLAN


Project Number:

14003

Issue Date: August 22, 2014

Sheet Number:



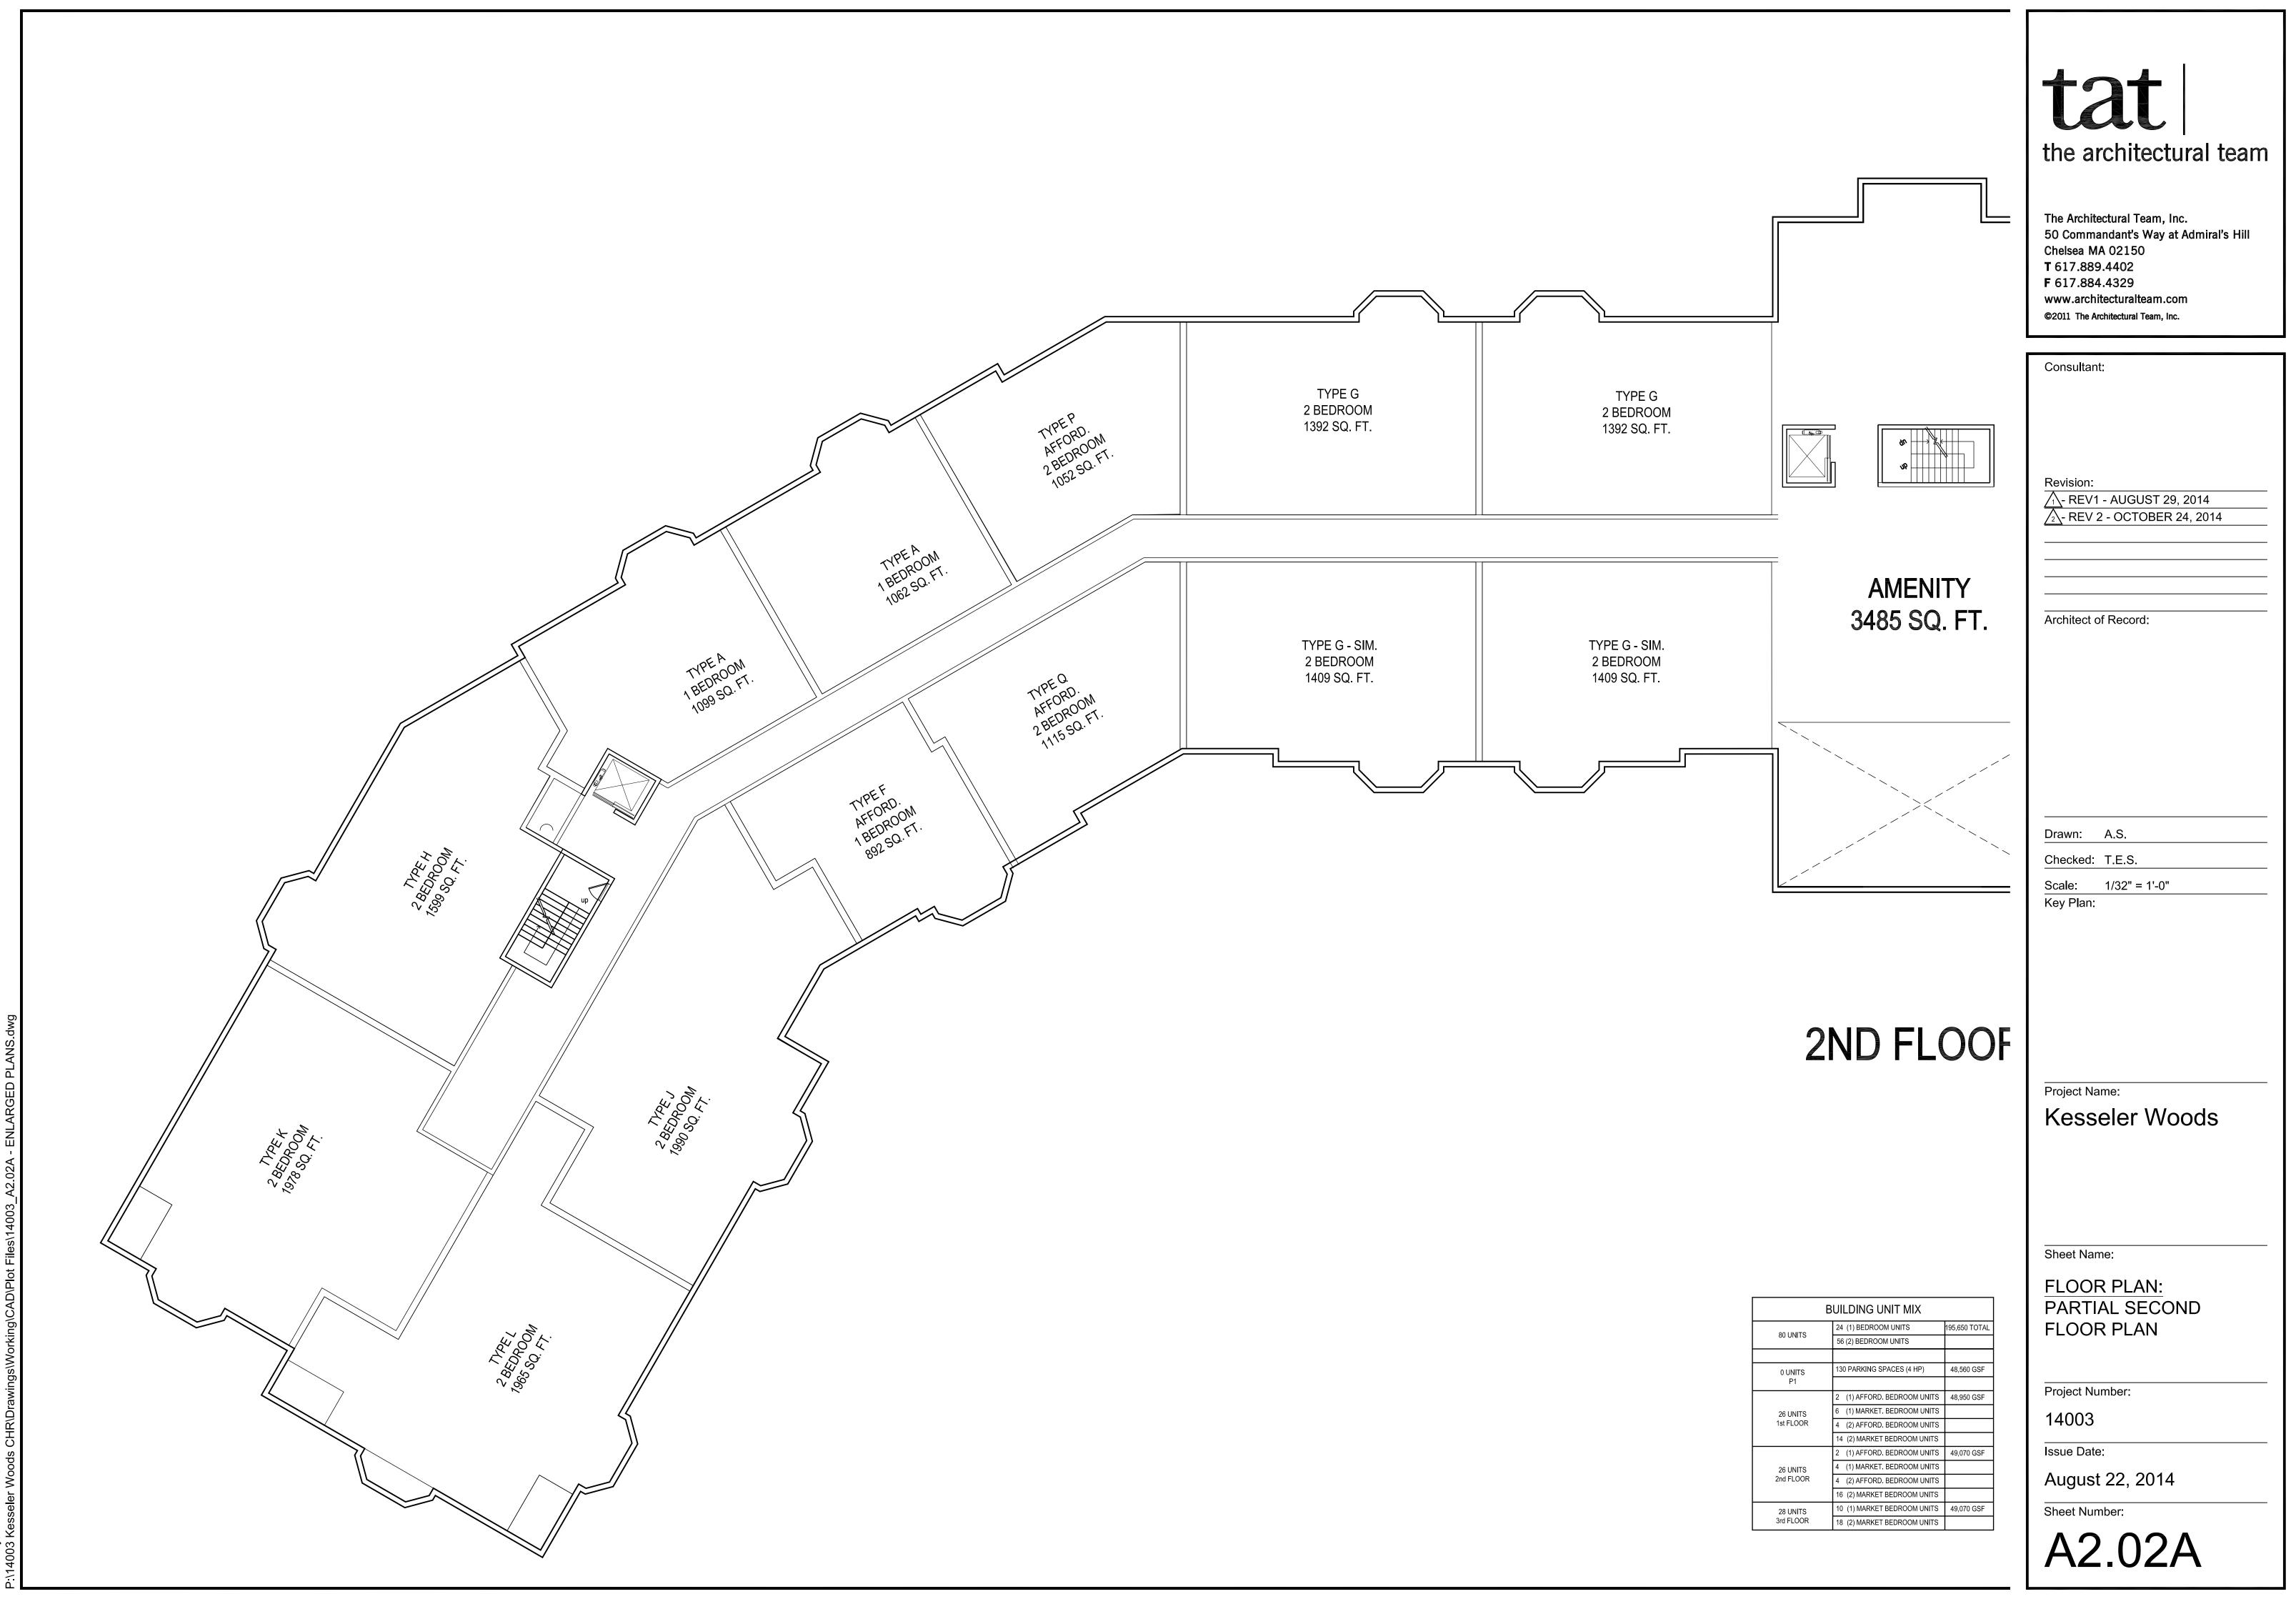

tober 23, 2014 1:33:46 PM seler Woods CHR\Drawing 2 2



tober 23, 2014 1:33:02 PM seler Woods CHR\Drawing day 03

	BUILDING UNIT MIX	
	24 (1) BEDROOM UNITS	195,650 TOTAL
80 UNITS	56 (2) BEDROOM UNITS	
0 UNITS	130 PARKING SPACES (4 HP)	48,560 GSF
P1		
	2 (1) AFFORD. BEDROOM UNITS	48,950 GSF
26 UNITS	6 (1) MARKET. BEDROOM UNITS	
1st FLOOR	4 (2) AFFORD. BEDROOM UNITS	
	14 (2) MARKET BEDROOM UNITS	
	2 (1) AFFORD. BEDROOM UNITS	49,070 GSF
26 UNITS	4 (1) MARKET. BEDROOM UNITS	
2nd FLOOR	4 (2) AFFORD. BEDROOM UNITS	
	16 (2) MARKET BEDROOM UNITS	
28 UNITS	10 (1) MARKET BEDROOM UNITS	49,070 GSF
3rd FLOOR	18 (2) MARKET BEDROOM UNITS	



Consultant:

Revision: <u>1</u>- REV 1 - AUGUST 29, 2014 2 - REV 2 - OCTOBER 24, 2014

Architect of Record:

Drawn: A.S. Checked: T.E.S. Scale: 1/32" = 1'-0" Key Plan:

Project Name: Kesseler Woods

Sheet Name:

FLOOR PLAN: PARTIAL SECOND FLOOR PLAN


Project Number:

14003

Issue Date: August 22, 2014

Sheet Number:



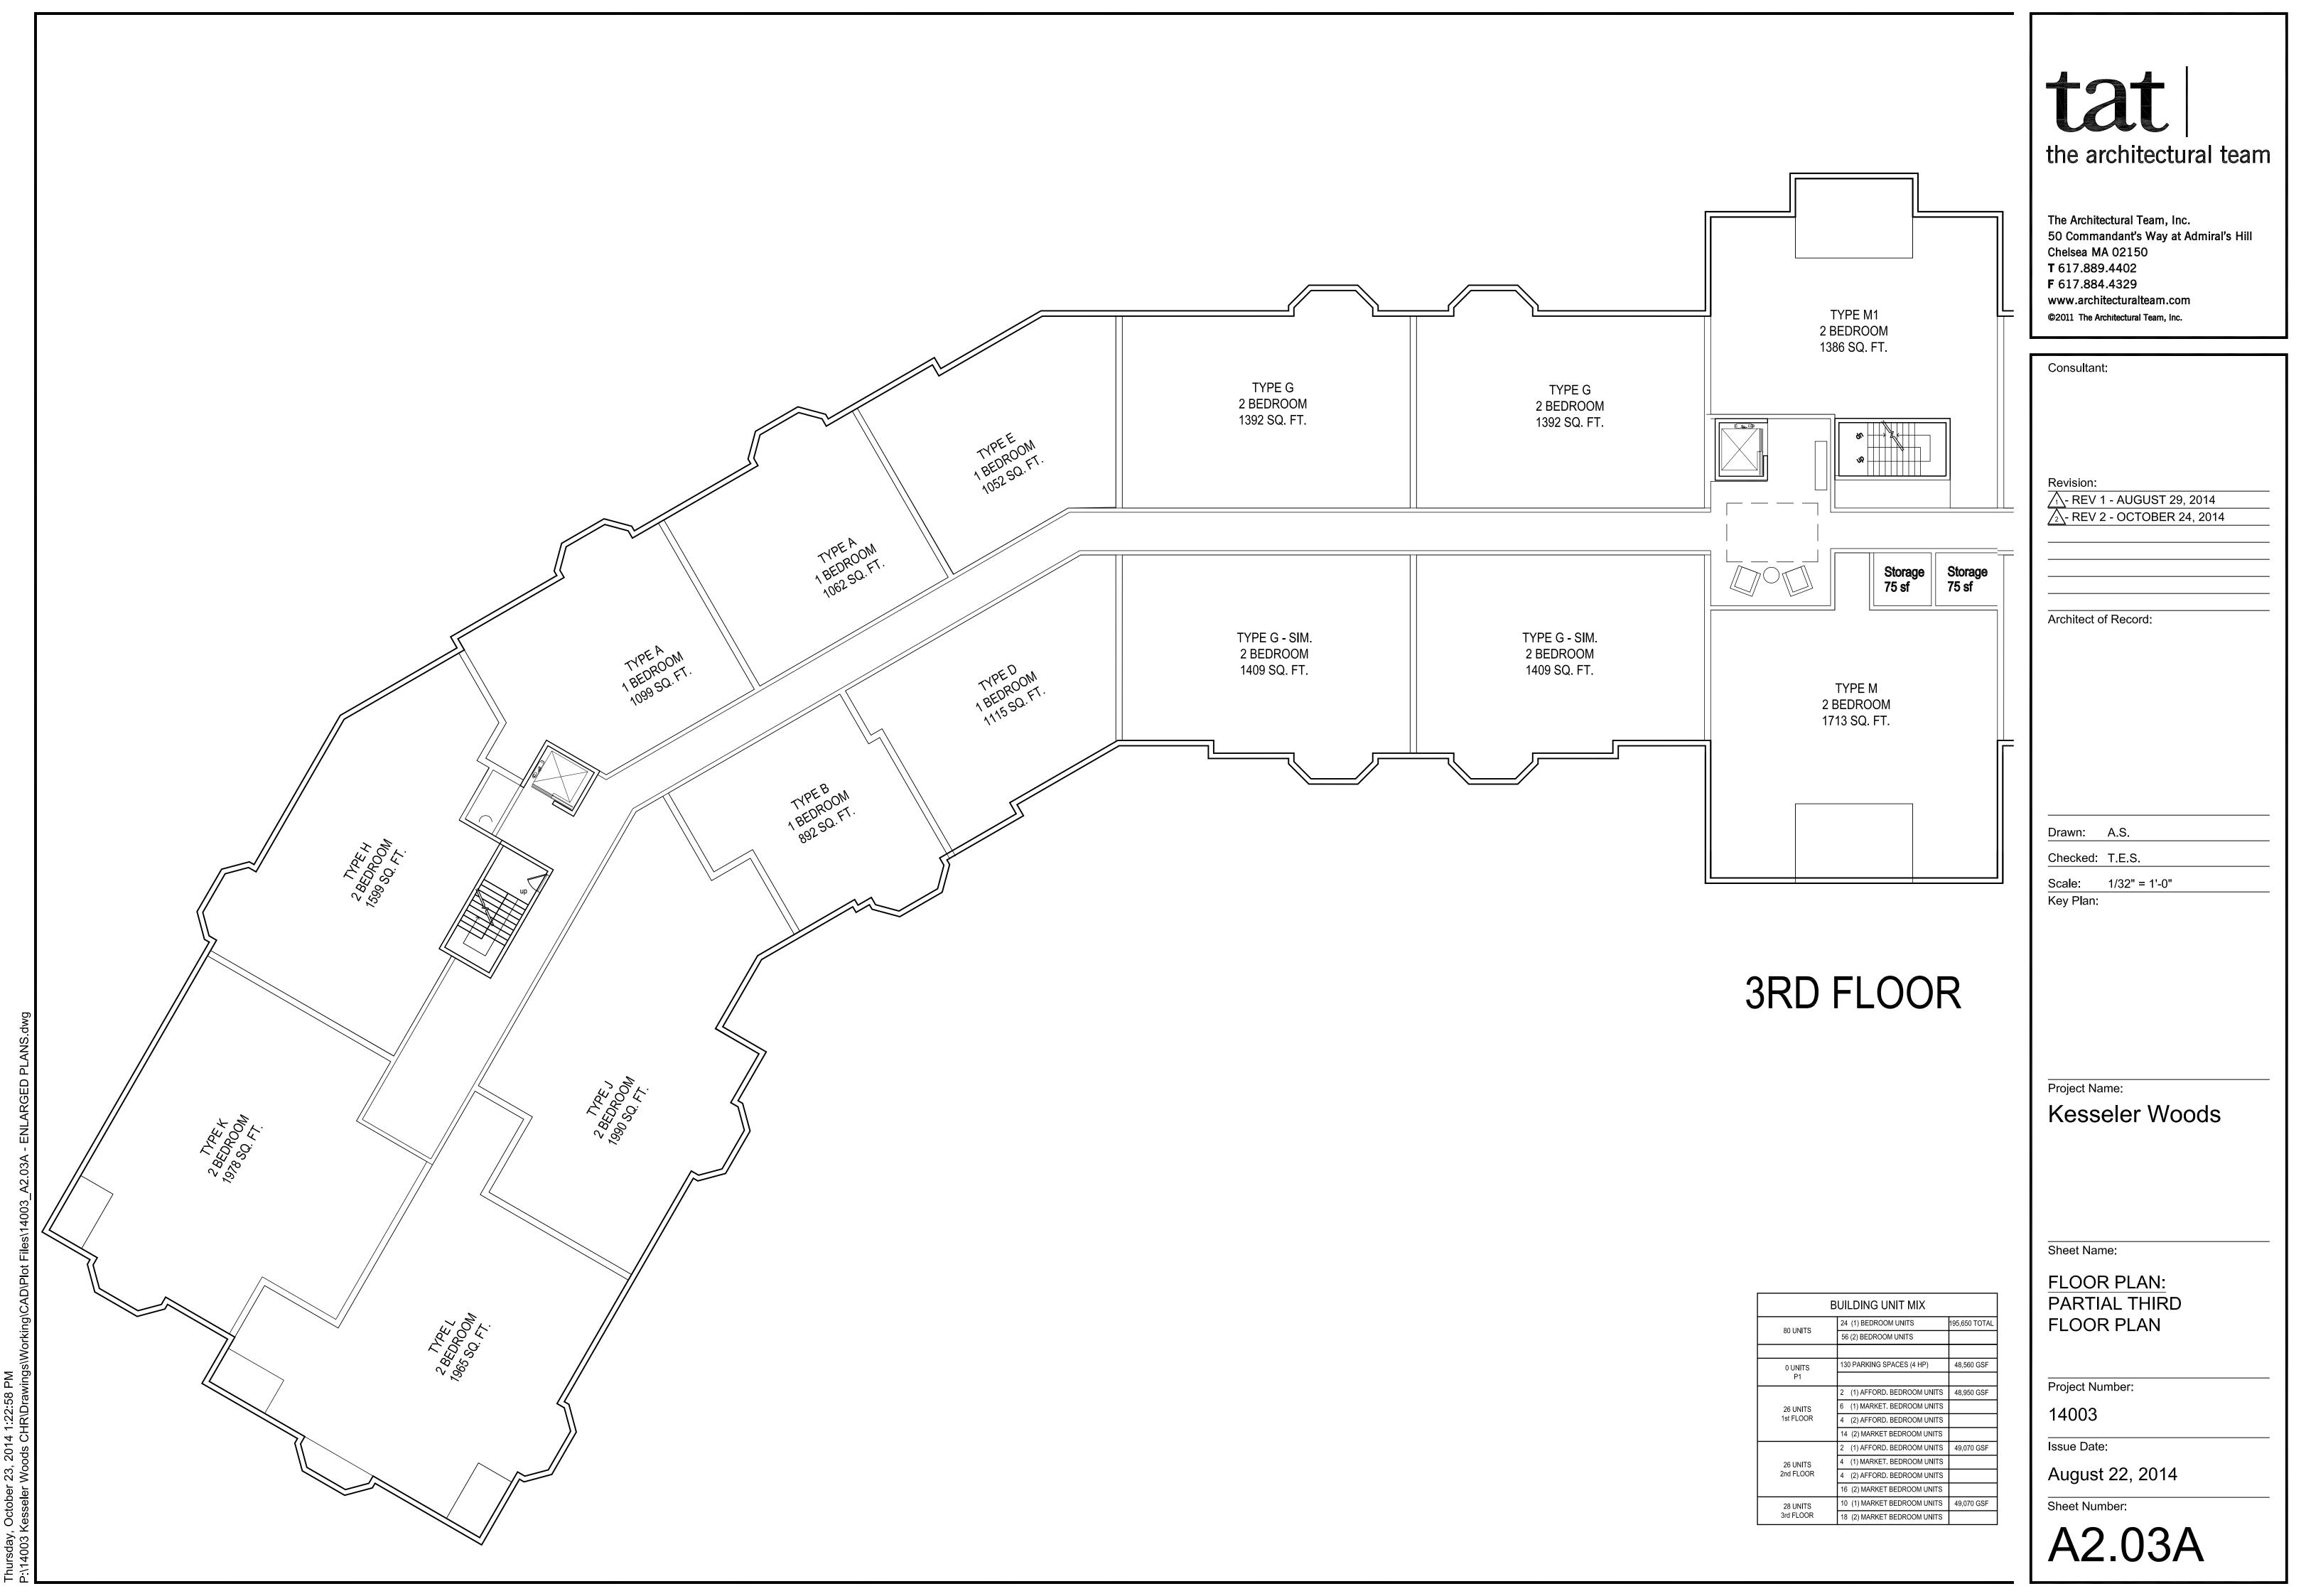



tober 23, 2014 6:15:54 PM seler Woods CHR\Drawing day 03

DR	AFT BUILDING UNIT MIX	
00.111.1170	24 (1) BEDROOM UNITS	195,650 TOT
80 UNITS	56 (2) BEDROOM UNITS	
0 UNITS	130 PARKING SPACES (4 HP)	48,560 GSI
P1		
	2 (1) AFFORD. BEDROOM UNITS	48,950 GSI
26 UNITS	6 (1) MARKET. BEDROOM UNITS	
1st FLOOR	4 (2) AFFORD. BEDROOM UNITS	
	14 (2) MARKET BEDROOM UNITS	
	2 (1) AFFORD. BEDROOM UNITS	49,070 GSI
26 UNITS	4 (1) MARKET. BEDROOM UNITS	
2nd FLOOR	4 (2) AFFORD, BEDROOM UNITS	
	16 (2) MARKET BEDROOM UNITS	
28 UNITS	10 (1) MARKET BEDROOM UNITS	49,070 GSI
3rd FLOOR	18 (2) MARKET BEDROOM UNITS	



Consultant:

Revision: <u>_1</u>- REV 1 - AUGUST 28, 2014 <u>_</u>2- REV 2 - OCTOBER 24, 2014

Architect of Record:



Drawn: A.S. Checked: T.E.S. Scale: 3/32" = 1'-0" Key Plan:

Project Name: Kesseler Woods

Sheet Name:

FLOOR PLAN: PARTIAL THIRD FLOOR PLAN

Project Number:

14003

Issue Date: August 22, 2014

Sheet Number:

A2.03B



iday, August 01, 2014 3:15:25 PM :\14003 Kesseler Woods CHR\Drawings\Working\CAD\Plot Files\14003 A4.01 - ELEVATI

⁻riday, August 01, 2014 3:15:25 PM ^o:\14003 Kesseler Woods CHR\Drawings\Working\CAD\Plot Files\14003 A4.01 - ELEVATIONS.



August 01, 2014 4:02:43 PM 03 Kesseler Woods CHR\Dra

