
Notice of Intent Approval Documents

February 22, 2021 Rev.1 March 10, 2021

Proposed Development

30 Riverdale Avenue Newton, Massachusetts 02459

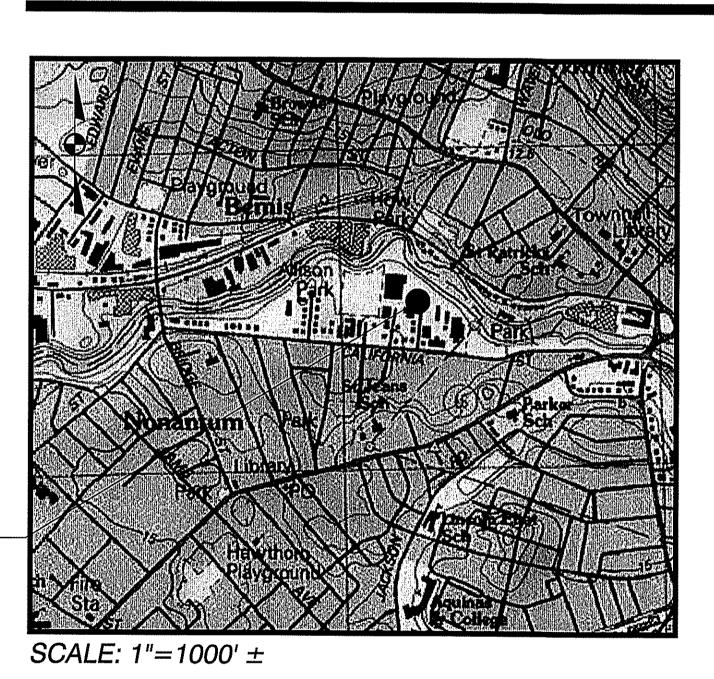

Applicant:

28-30 Riverdale LLC 31 Whitmore Road Newton, MA 02465

Owner: 28-30 Riverdale LLC 31 Whitmore Road Newton, MA 02465

Civil Engineer:

McCarty Engineering, Inc. 42 Jungle Road

Leominster, MA 01453 (978) 534-1318

Surveyor:

Tauper Land Survey, Inc. 25 Sutton Avenue Oxford, MA 01540 (508) 987-2266

Architect:

Goldman Reindorf Architects, Inc. (GRA) 427 Watertown Street Newton, MA 02458

(617) 467-3119


PROJECT SITE

Sheet Title Sheet No.

- Cover Sheet **Existing Conditions Plan**
- Existing Condition & Demolition Plan
- Layout & Materials Plan
- Grading, Drainage & Utility Plan
- Landscape Plan
- **Construction Details**
- **Construction Details**
- Stormtech Detail Sheet





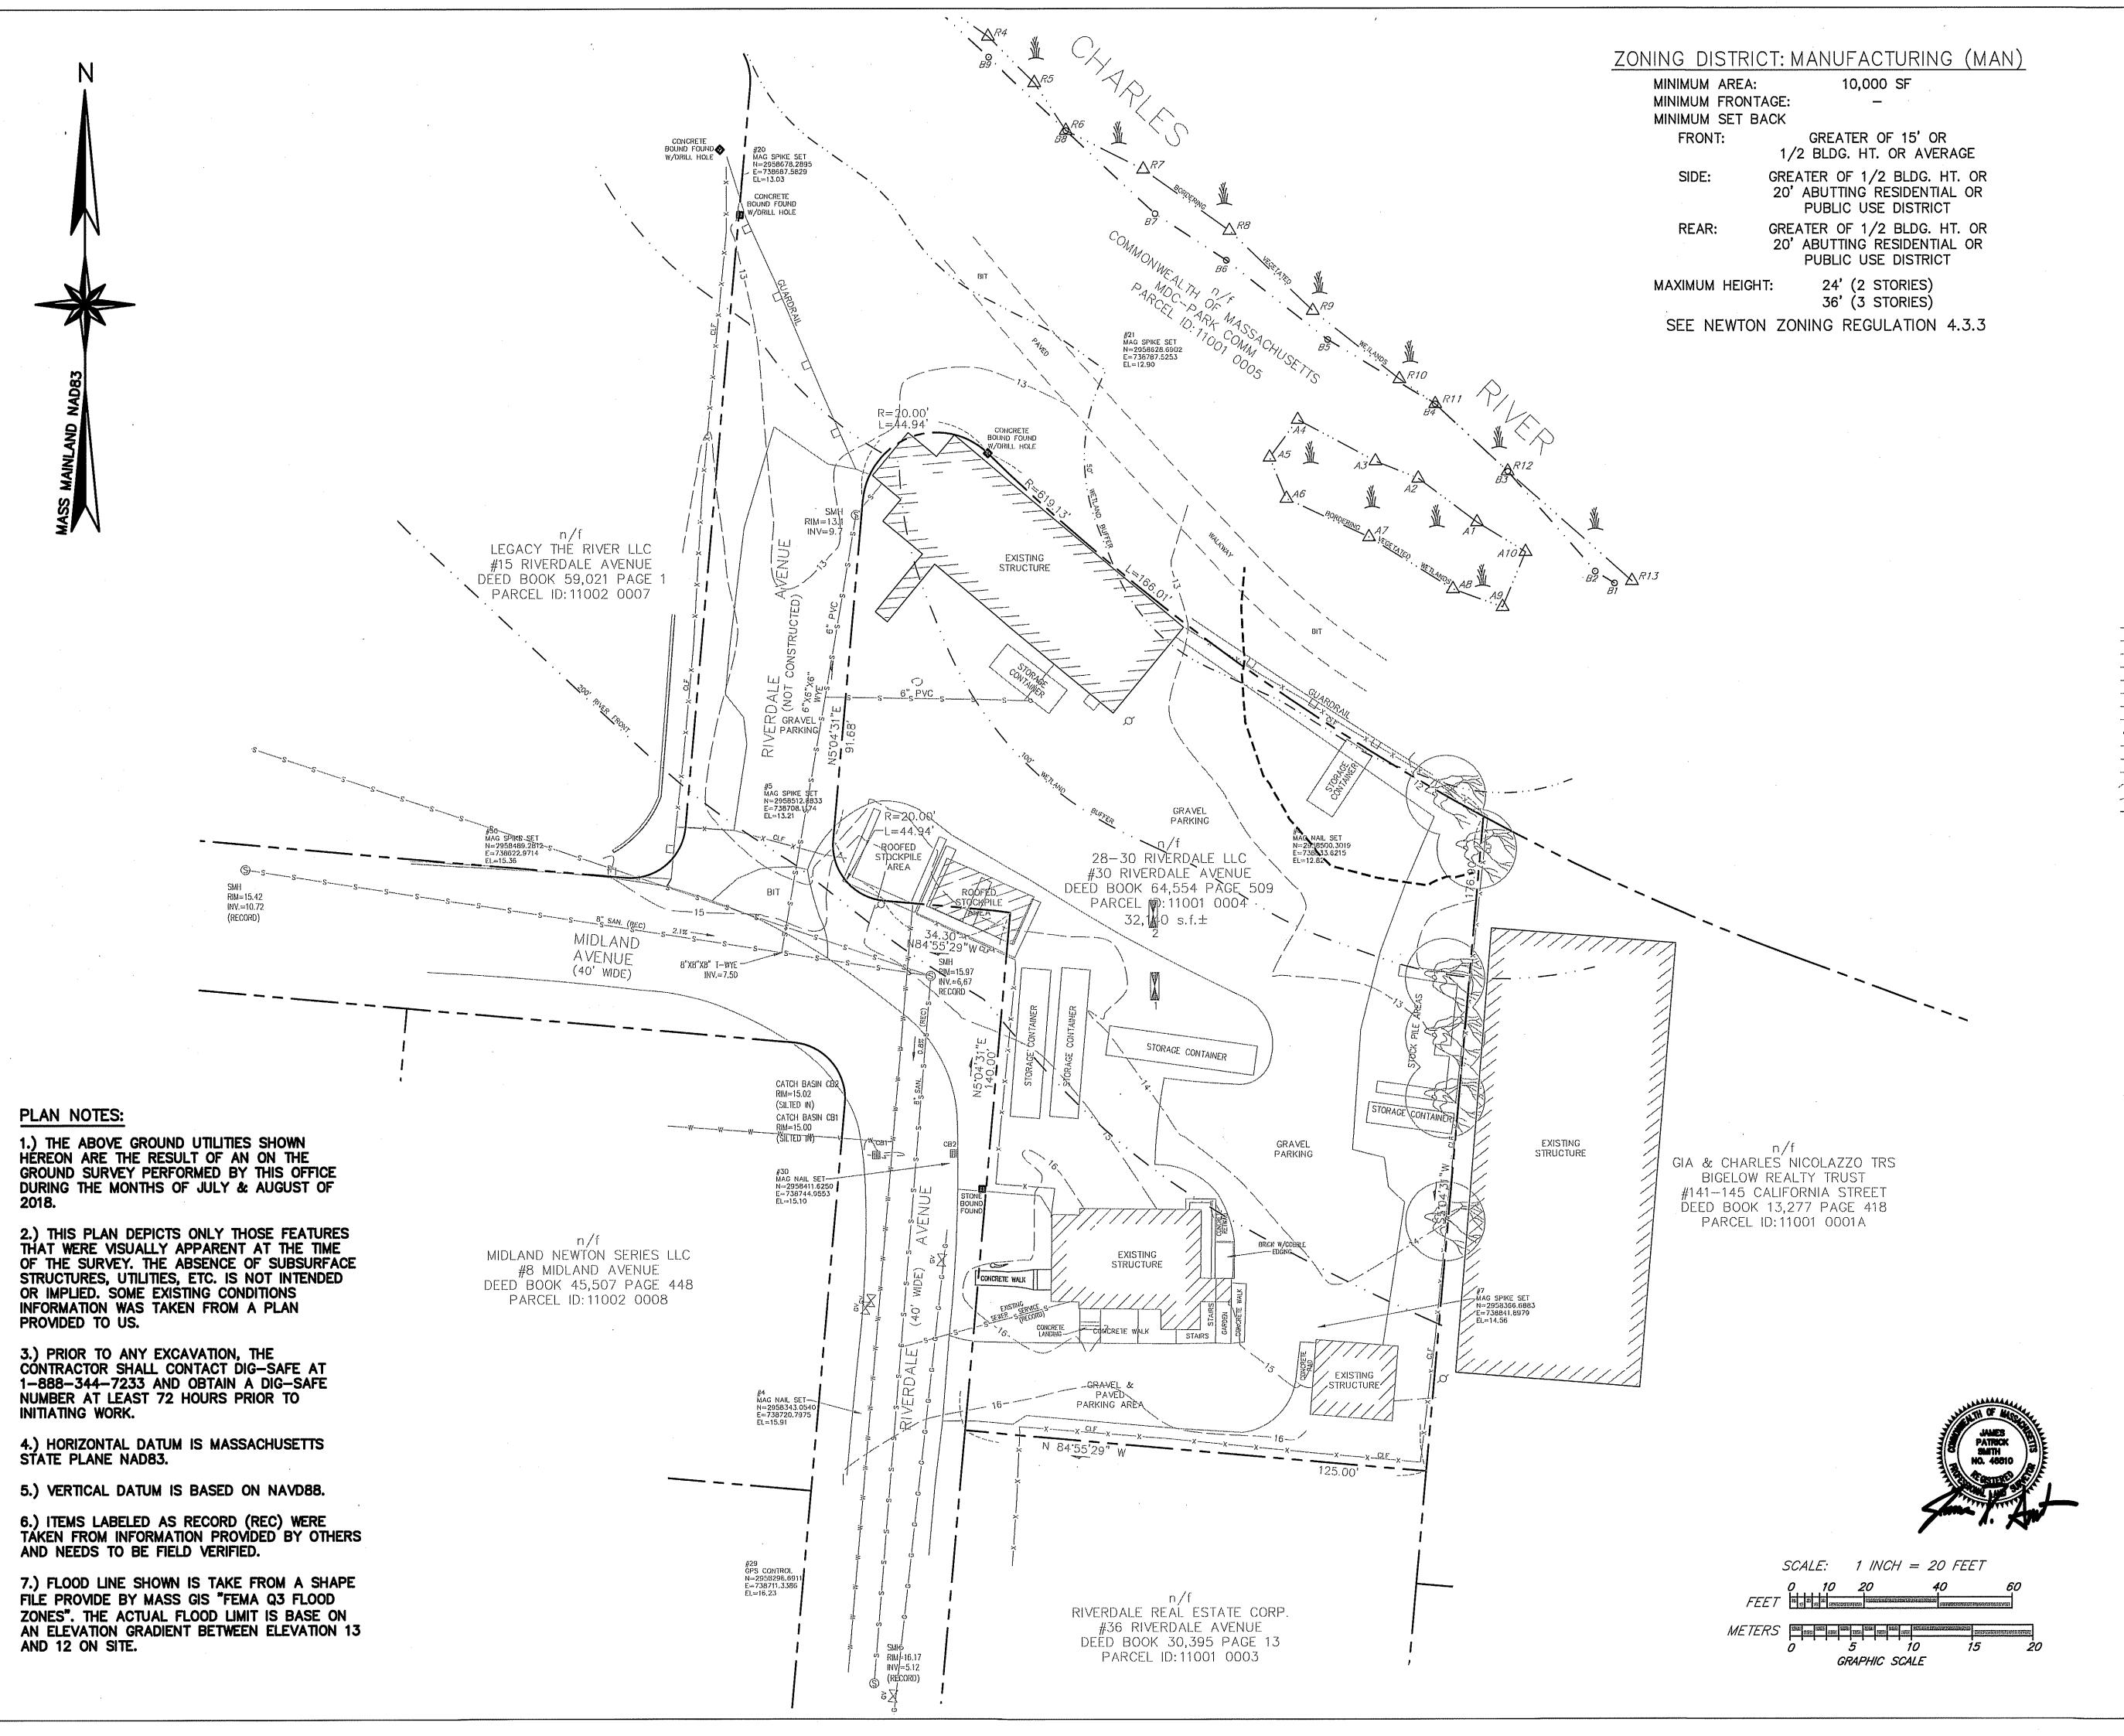

LEGEND

IRON PIPE FOUND DRILL HOLE FOUND STONE OR CONCRETE MONUMENTS SEWER MANHOLE DRAIN MANHOLE ELECTRIC MANHOLE TELEPHONE MANHOLE WATER MANHOLE UNDETERMINED MANHOLE CATCH BASIN CLEANOUT MONITORING WELL ANCHOR UTILITY POLE WATER GATE VALVE WATER SHUT OFF HYDRANT BENCHMARK GAS VALVE LIGHT POLE / LAMP POST SPOT LIGHT FLAG POLE (XBM) XOBJIAM BOLLARD SHRUBS, BUSHES, ETC. DECIDUOUS TREE CONIFEROUS TREE WETLAND FLAG RIVER BANK FLAG BOULDER VERTICAL GRANITE CURBING CONCRETE CURBING CAPE COD BERM (BITUMINOUS) BITUMINOUS CURBING (GENERIC) SLOPED GRANITE CURBING SLPGC SEWER LINE DRAIN LINE -----W-------WATER LINE GAS LINE TELEPHONE LINE CABLE TELEVISION ----x---x FENCING (AS NOTED) GUARD RAILING (AS NOTED) TREE LINE EDGE OF LANDSCAPING BORDERING VEGETATED WETLANDS

OWNER:
28-30 RIVERDALE LLC
30 RIVERDALE AVENUE
NEWTON, MA
DEED BOOK 64,554 PG. 509
ASSESSORS PARCEL ID: 11001 0004

EXISTING CONDITIONS PLAN
NEWTON, MASSACHUSETTS
PREPARED FOR
McCarty Companies
42 Jungle Road
Leominster, MA

SCALE: 1" = 20' DATE: AUGUST 13, 2018

PREPARED BY



TAUPER LAND SURVEY INC.


25 SUTTON AVENUE, OXFORD, MA 01540

TEL. 508-987-2266

FAX 508-987-2267

DWG: 18-158 30 RIVERDALE AVE NEWTON.DWG.dwg

JOB NO. 18-158

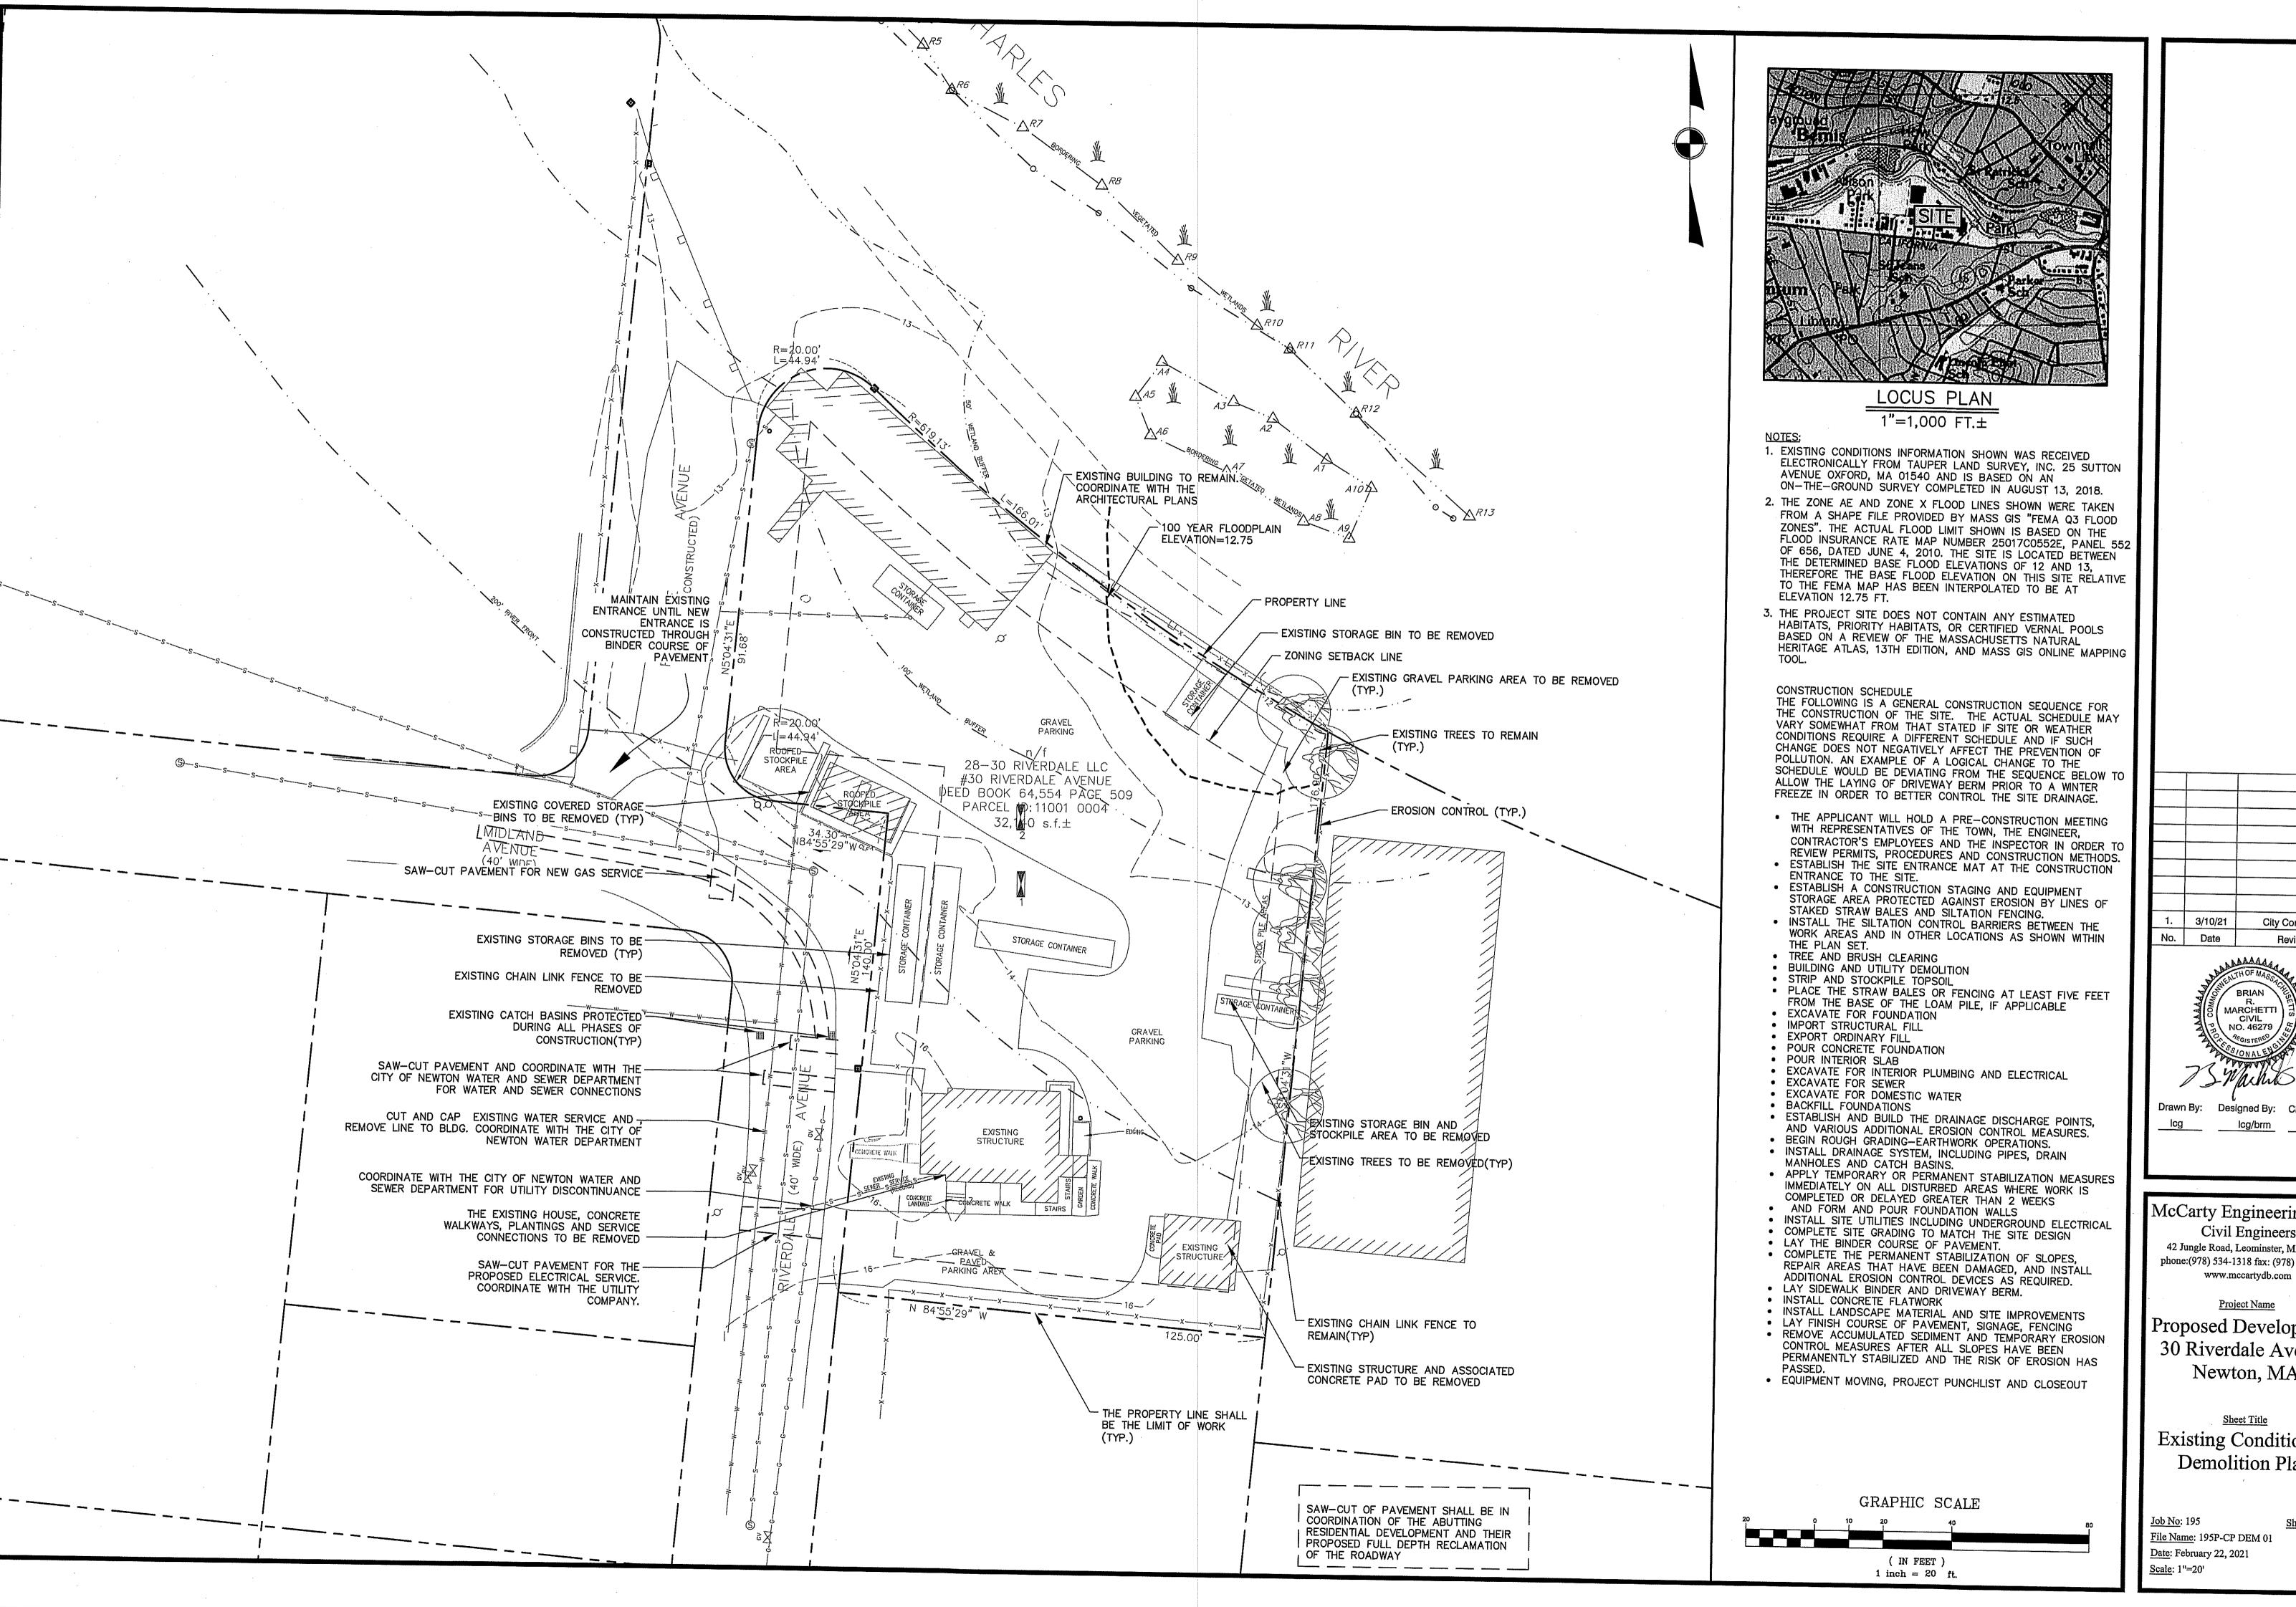


3/10/21 City Comments Date Revision BRIAN MARCHETTI | 3 CIVIL NO. 46279 / 5 Drawn By: Designed By: Checked By:


McCarty Engineering, Inc. Civil Engineers 42 Jungle Road, Leominster, MA 01453 phone:(978) 534-1318 fax: (978) 840-6907


Project Name Proposed Development 30 Riverdale Avenue Newton, MA


Sheet Title **Existing Condition & Demolition Plan**

Sheet No. File Name: 195P-CP DEM 01 <u>Date</u>: February 22, 2021

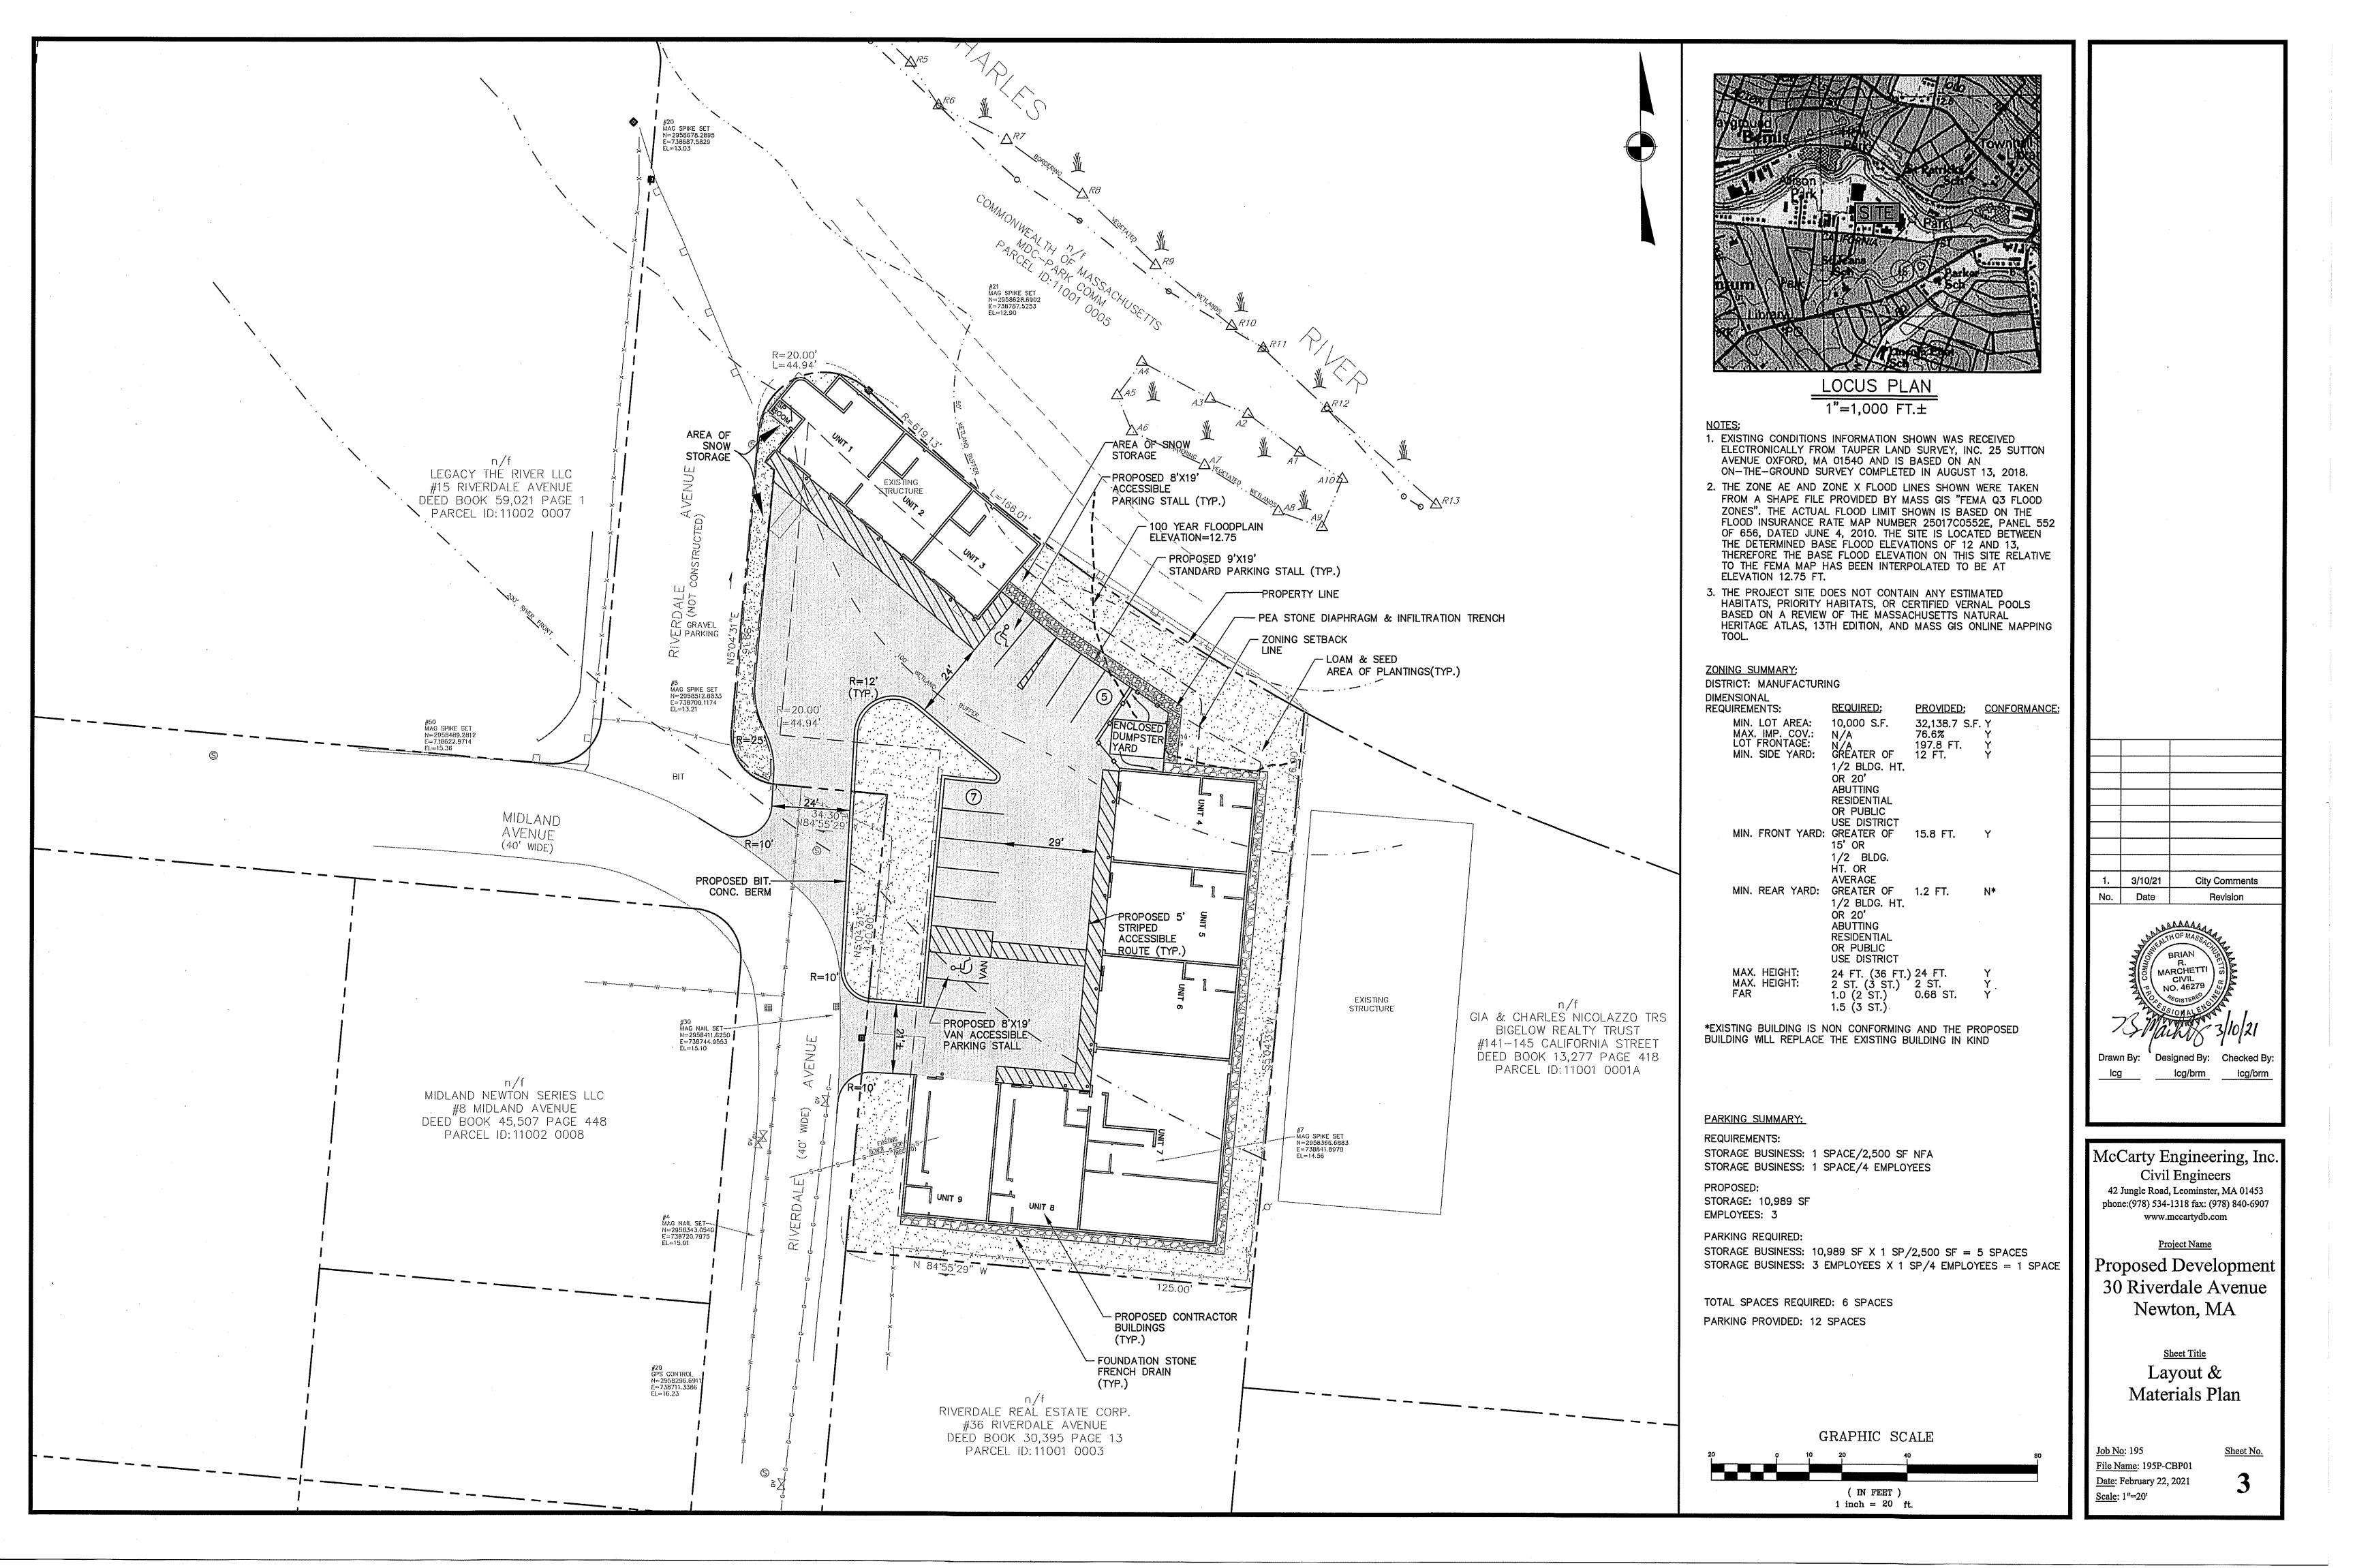

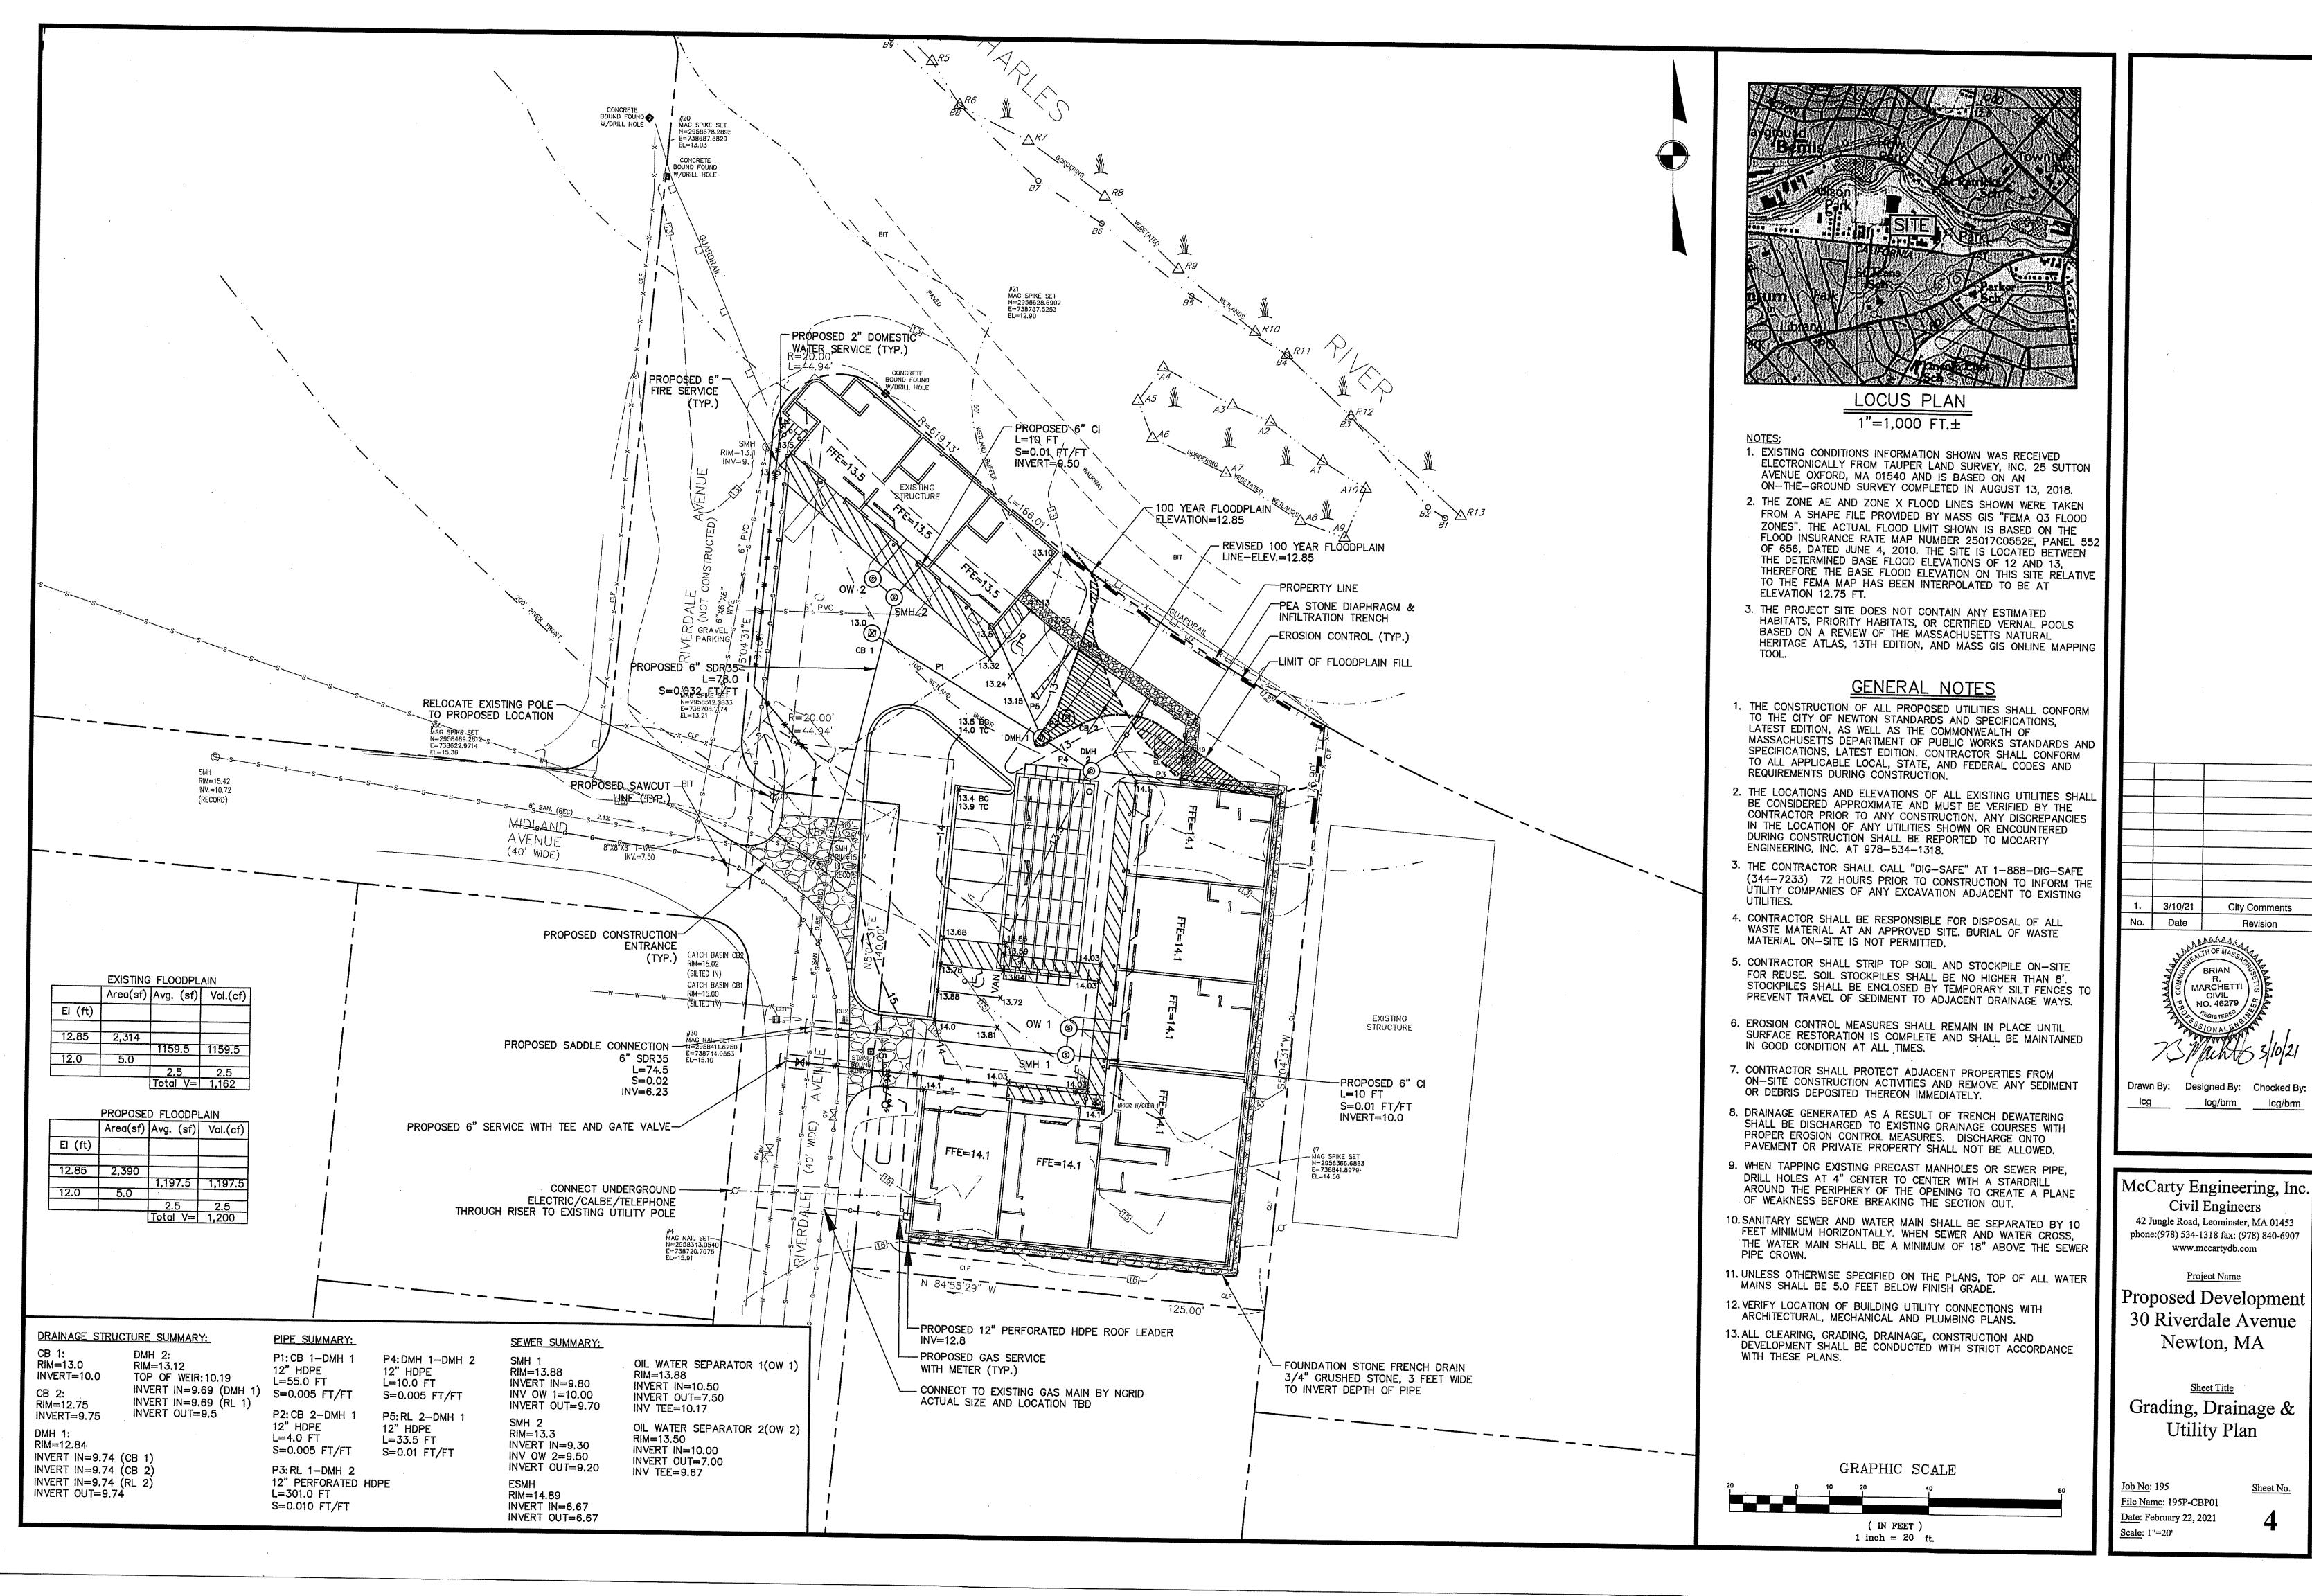

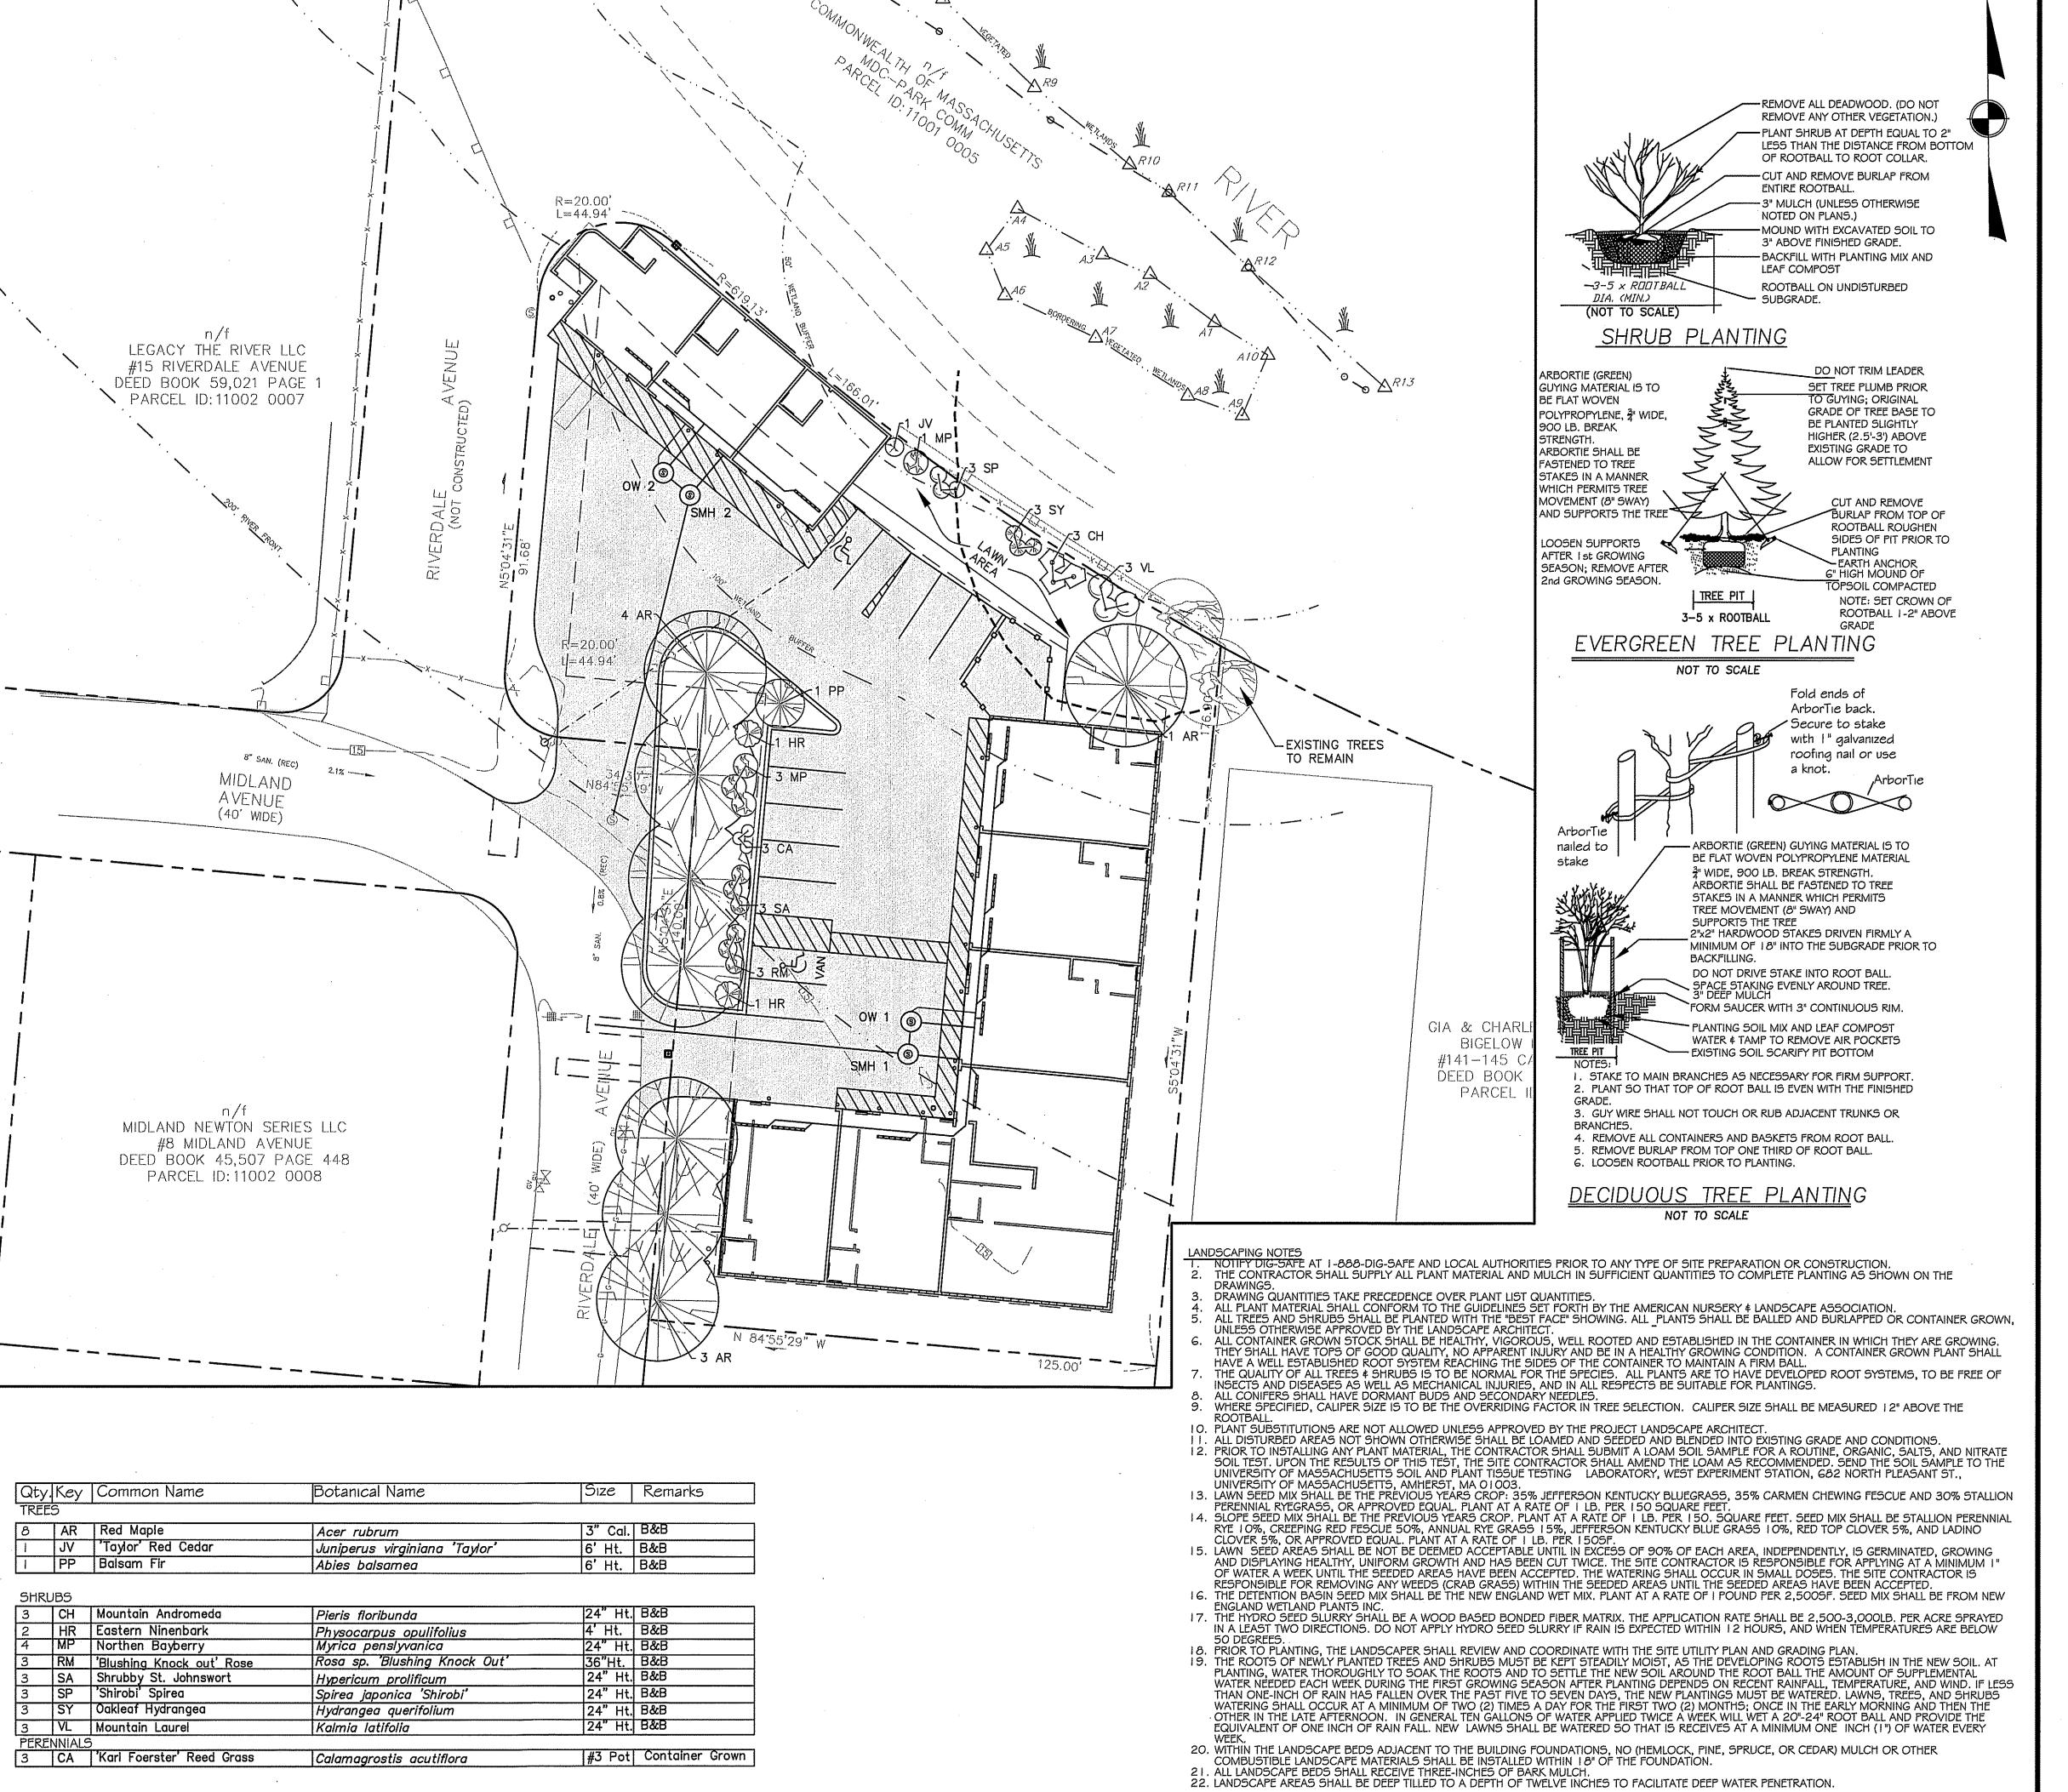

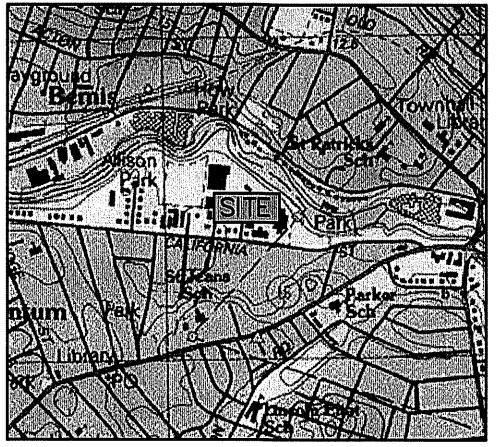


LOCUS PLAN 1"=1,000 FT.±

1. EXISTING CONDITIONS INFORMATION SHOWN WAS RECEIVED ELECTRONICALLY FROM TAUPER LAND SURVEY, INC. 25 SUTTON AVENUE OXFORD, MA 01540 AND IS BASED ON AN ON-THE-GROUND SURVEY COMPLETED IN AUGUST 13, 2018.

- 2. THE ZONE AE AND ZONE X FLOOD LINES SHOWN WERE TAKEN FROM A SHAPE FILE PROVIDED BY MASS GIS "FEMA Q3 FLOOD ZONES". THE ACTUAL FLOOD LIMIT SHOWN IS BASED ON THE FLOOD INSURANCE RATE MAP NUMBER 25017C0552E, PANEL 552 OF 656, DATED JUNE 4, 2010. THE SITE IS LOCATED BETWEEN THE DETERMINED BASE FLOOD ELEVATIONS OF 12 AND 13. THEREFORE THE BASE FLOOD ELEVATION ON THIS SITE RELATIVE TO THE FEMA MAP HAS BEEN INTERPOLATED TO BE AT ELEVATION 12.75 FT.
- 3. THE PROJECT SITE DOES NOT CONTAIN ANY ESTIMATED HABITATS, PRIORITY HABITATS, OR CERTIFIED VERNAL POOLS BASED ON A REVIEW OF THE MASSACHUSETTS NATURAL HERITAGE ATLAS, 13TH EDITION, AND MASS GIS ONLINE MAPPING

GENERAL NOTES

- THE CONSTRUCTION OF ALL PROPOSED UTILITIES SHALL CONFORM TO THE CITY OF NEWTON STANDARDS AND SPECIFICATIONS, LATEST EDITION, AS WELL AS THE COMMONWEALTH OF MASSACHUSETTS DEPARTMENT OF PUBLIC WORKS STANDARDS AND SPECIFICATIONS, LATEST EDITION. CONTRACTOR SHALL CONFORM TO ALL APPLICABLE LOCAL, STATE, AND FEDERAL CODES AND REQUIREMENTS DURING CONSTRUCTION.
- 2. THE LOCATIONS AND ELEVATIONS OF ALL EXISTING UTILITIES SHALL BE CONSIDERED APPROXIMATE AND MUST BE VERIFIED BY THE CONTRACTOR PRIOR TO ANY CONSTRUCTION. ANY DISCREPANCIES IN THE LOCATION OF ANY UTILITIES SHOWN OR ENCOUNTERED DURING CONSTRUCTION SHALL BE REPORTED TO MCCARTY ENGINEERING, INC. AT 978-534-1318.
- 3. THE CONTRACTOR SHALL CALL "DIG-SAFE" AT 1-888-DIG-SAFE (344-7233) 72 HOURS PRIOR TO CONSTRUCTION TO INFORM THE UTILITY COMPANIES OF ANY EXCAVATION ADJACENT TO EXISTING
- 4. CONTRACTOR SHALL BE RESPONSIBLE FOR DISPOSAL OF ALL WASTE MATERIAL AT AN APPROVED SITE, BURIAL OF WASTE MATERIAL ON-SITE IS NOT PERMITTED.
- 5. CONTRACTOR SHALL STRIP TOP SOIL AND STOCKPILE ON-SITE FOR REUSE. SOIL STOCKPILES SHALL BE NO HIGHER THAN 8'. STOCKPILES SHALL BE ENCLOSED BY TEMPORARY SILT FENCES TO PREVENT TRAVEL OF SEDIMENT TO ADJACENT DRAINAGE WAYS.
- 6. EROSION CONTROL MEASURES SHALL REMAIN IN PLACE UNTIL SURFACE RESTORATION IS COMPLETE AND SHALL BE MAINTAINED IN GOOD CONDITION AT ALL TIMES.
- 7. CONTRACTOR SHALL PROTECT ADJACENT PROPERTIES FROM ON-SITE CONSTRUCTION ACTIVITIES AND REMOVE ANY SEDIMENT OR DEBRIS DEPOSITED THEREON IMMEDIATELY.
- 8. DRAINAGE GENERATED AS A RESULT OF TRENCH DEWATERING SHALL BE DISCHARGED TO EXISTING DRAINAGE COURSES WITH PROPER EROSION CONTROL MEASURES. DISCHARGE ONTO PAVEMENT OR PRIVATE PROPERTY SHALL NOT BE ALLOWED.
- 9. WHEN TAPPING EXISTING PRECAST MANHOLES OR SEWER PIPE, DRILL HOLES AT 4" CENTER TO CENTER WITH A STARDRILL AROUND THE PERIPHERY OF THE OPENING TO CREATE A PLANE OF WEAKNESS BEFORE BREAKING THE SECTION OUT.
- 10. SANITARY SEWER AND WATER MAIN SHALL BE SEPARATED BY 10 FEET MINIMUM HORIZONTALLY. WHEN SEWER AND WATER CROSS, THE WATER MAIN SHALL BE A MINIMUM OF 18" ABOVE THE SEWER PIPE CROWN.
- 11. UNLESS OTHERWISE SPECIFIED ON THE PLANS, TOP OF ALL WATER MAINS SHALL BE 5.0 FEET BELOW FINISH GRADE.
- 12. VERIFY LOCATION OF BUILDING UTILITY CONNECTIONS WITH ARCHITECTURAL, MECHANICAL AND PLUMBING PLANS.
- 13. ALL CLEARING, GRADING, DRAINAGE, CONSTRUCTION AND DEVELOPMENT SHALL BE CONDUCTED WITH STRICT ACCORDANCE WITH THESE PLANS.
- 14. CONTRACTOR SHALL REFER TO THE SOTRMWATER POLLUTION PREVENTION PLAN PREPARED FOR THIS PROJECT SITE FOR ALL CONSTRUCTION PERIOD INSPECTIONS, CONTROLS, AND MANAGEMENT PRACTICES REQUIRED.

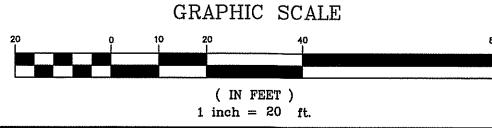

1. 3/10/21 City Comments No. Date Revision



McCarty Engineering, Inc. Civil Engineers

42 Jungle Road, Leominster, MA 01453 phone: (978) 534-1318 fax: (978) 840-6907 www.mccartydb.com

Project Name


Proposed Development 30 Riverdale Avenue Newton, MA

Landscape Plan

File Name: 195P-CB LA01

Scale: 1"=20'

Date: February 22, 2021

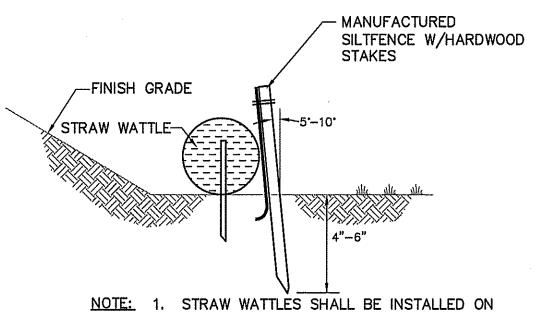

NOTE: 1. STRAW WATTLES SHALL BE INSTALLED ON CONTOUR AND STAKED WITH 18 OR 24 INCH WOOD STAKES AT FOUR FEET ON CENTER

2. ACCUMULATED SEDIMENT SHALL BE REMOVED WHEN IT REACHES ₹ OF ROLL HEIGHT

STRAW WATTLE / SILT FENCE DETAIL N.T.S.

CAST IRON GRATE

SILT SACK OR APPROVED EQUAL

NOTE:
ALL CATCH BASINS WITHIN LIMIT OF WORK
SHALL BE EQUIPPED WITH SILT SACKS OR
APPROVED EQUAL.

TEMPORARY CATCHBASIN FILTER

N.T.S.

NOTES:

THE PURPOSE OF THIS TEMPORARY BERM IS TO REMOVE MUD FROM THE TIRES OF VEHICLES LEAVING THE SITE DURING CONSTRUCTION.

PROVIDE LEVEL AREA OF CRUSHED STONE 50 FEET IN FROM EDGE OF EXISTING ROAD.

TEMPORARY ENTRANCE BERM N.T.S..

TACK COAT


-3.5" BIT. CONC. PAVEMENT TYPE I—1
PLACED IN 2 LAYERS, 1.5" TOP COURSE
OVER 2" BINDER COURSE

4" DENSE GRADED
CRUSHED STONE

8" COMPACTED
GRAVEL SUBBASE


COMPACTED SUBGRADE

BITUMINOUS CONCRETE PAVEMENT DETAIL N.T.S.

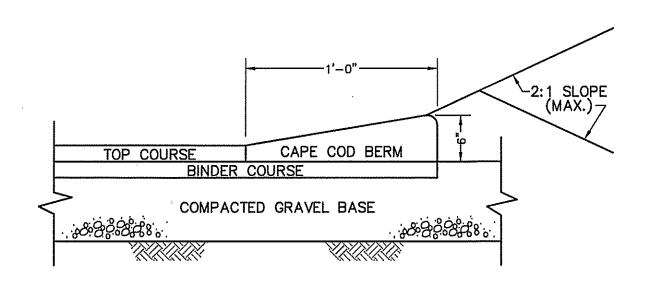


BITUMINOUS CONCRETE BERM DETAIL

N.T.S.

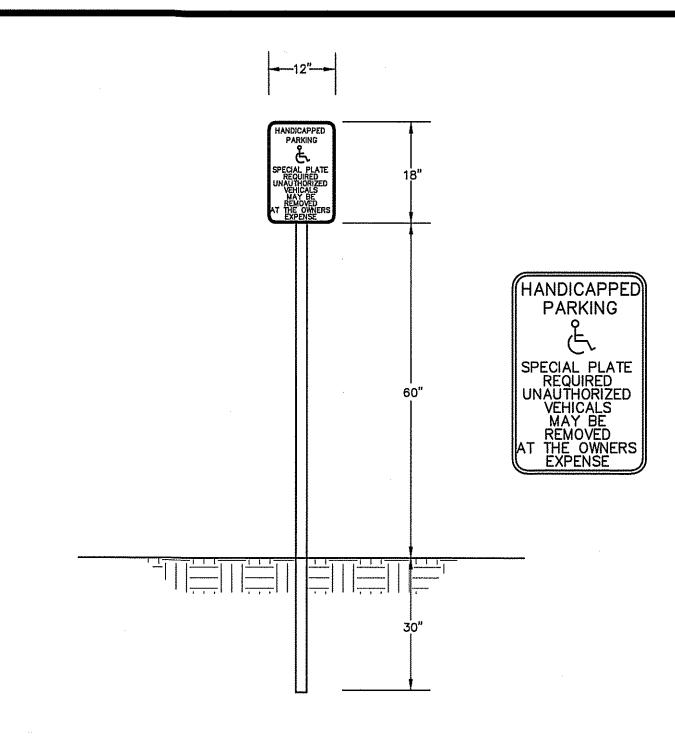

HANDICAPPED PARKING SIGN DETAIL N.T.S.

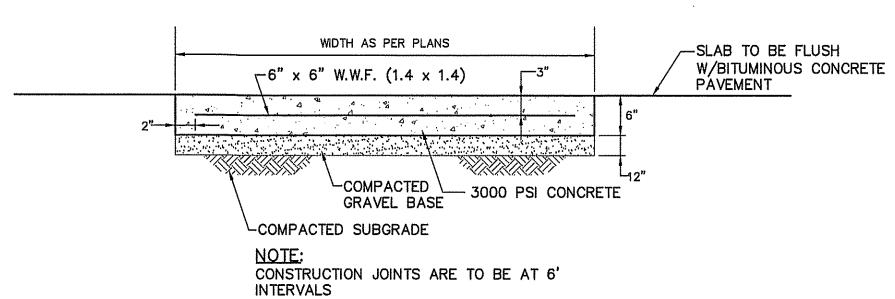

CONCRETE DUMPSTER PAD DETAIL

WIDTH AS PER PLANS


-6" × 6" W.W.F. (1.4 × 1.4)

BANK RUN
SAND CUSHION

COMPACTED SUBGRADE

NOTE:
CONSTRUCTION JOINTS ARE TO BE AT 6'


CONCRETE SIDEWALK DETAIL N.T.S.

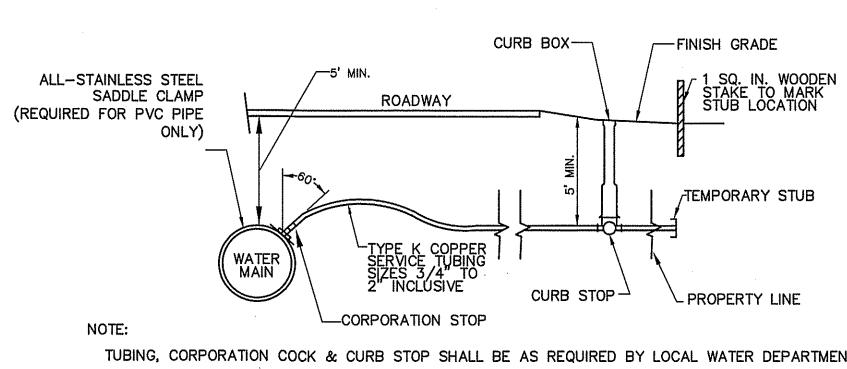


TUBING, CORPORATION COCK & CURB STOP SHALL BE AS REQUIRED BY LOCAL WATER DEPARTMENT


WATER SERVICE DETAIL


N.T.S.

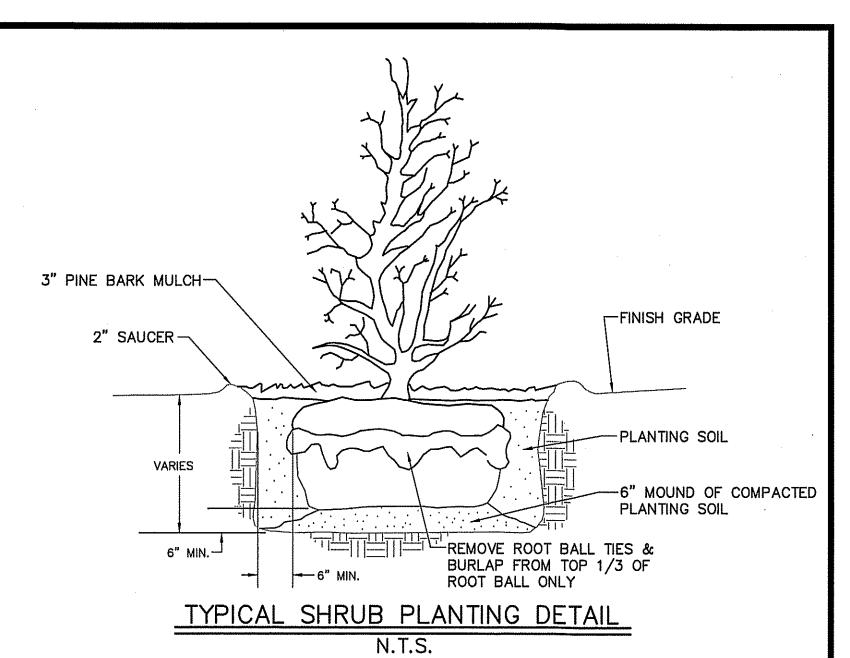

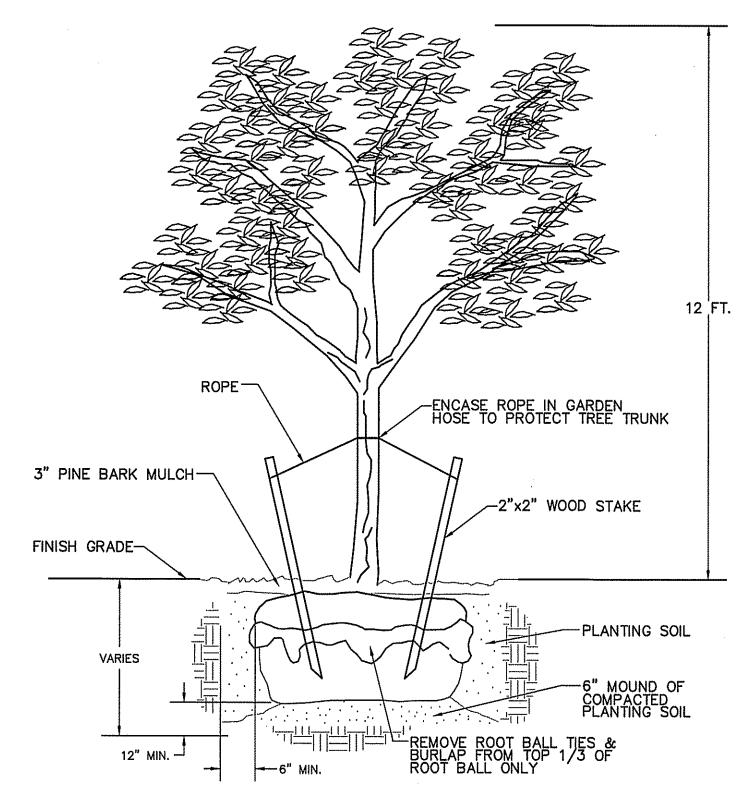

TYPICAL TREE PLANTING DETAIL N.T.S.

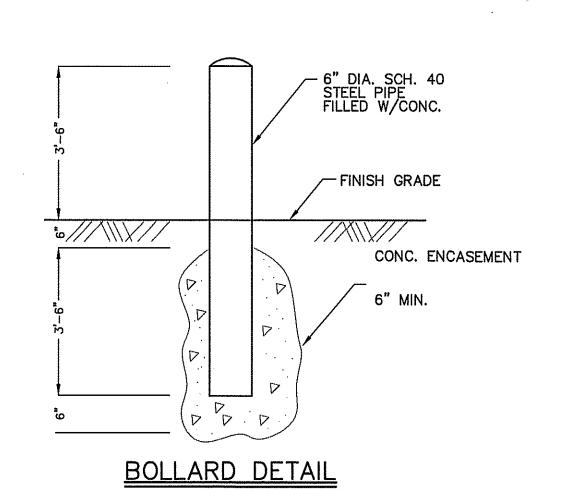

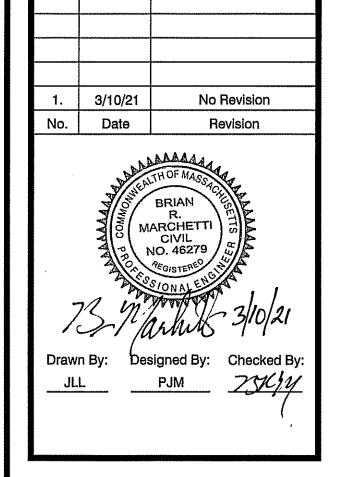


McCarty Engineering, Inc.
Civil Engineers
42 Jungle Road, Leominster, MA 01453
phone: (978) 534-1318 fax: (978) 840-6907
www.mccartydb.com


Riverdale
30 Riverdale Avenue
Newton, MA

Sheet Title
Construction
Details

<u>Job No</u>: 195
<u>File Name</u>: 195P-DET01
<u>Date</u>: February 22, 2021
<u>Scale</u>: N.T.S.

Sheet No.

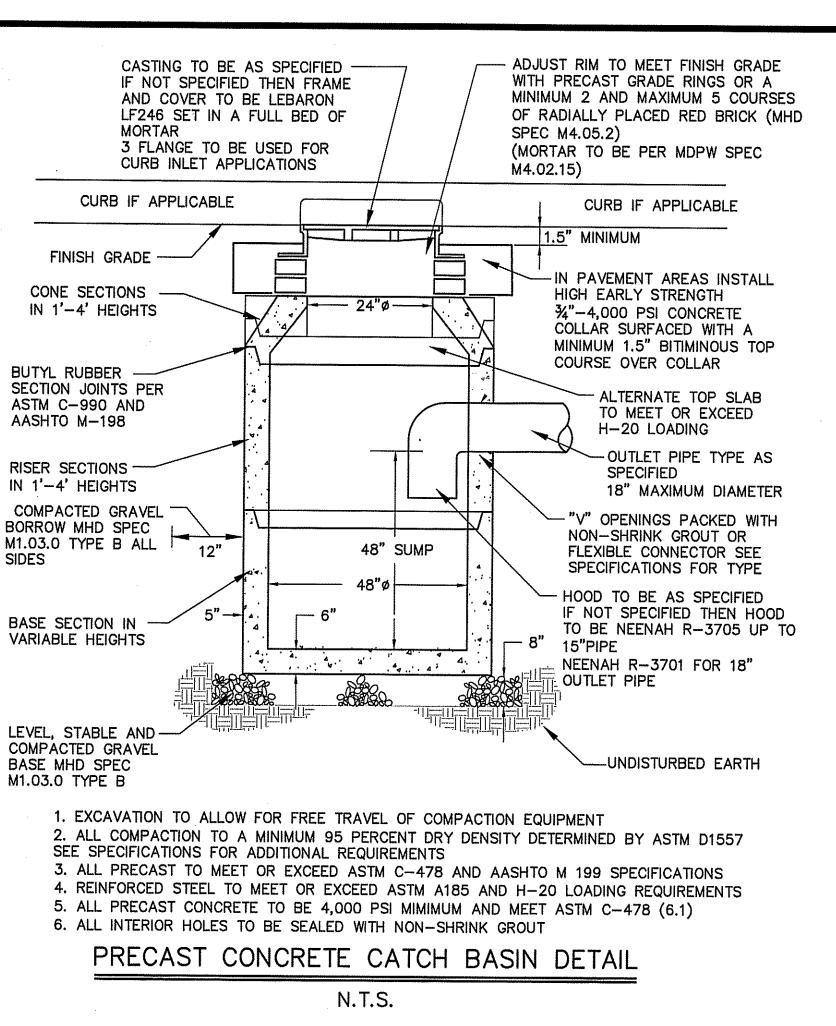

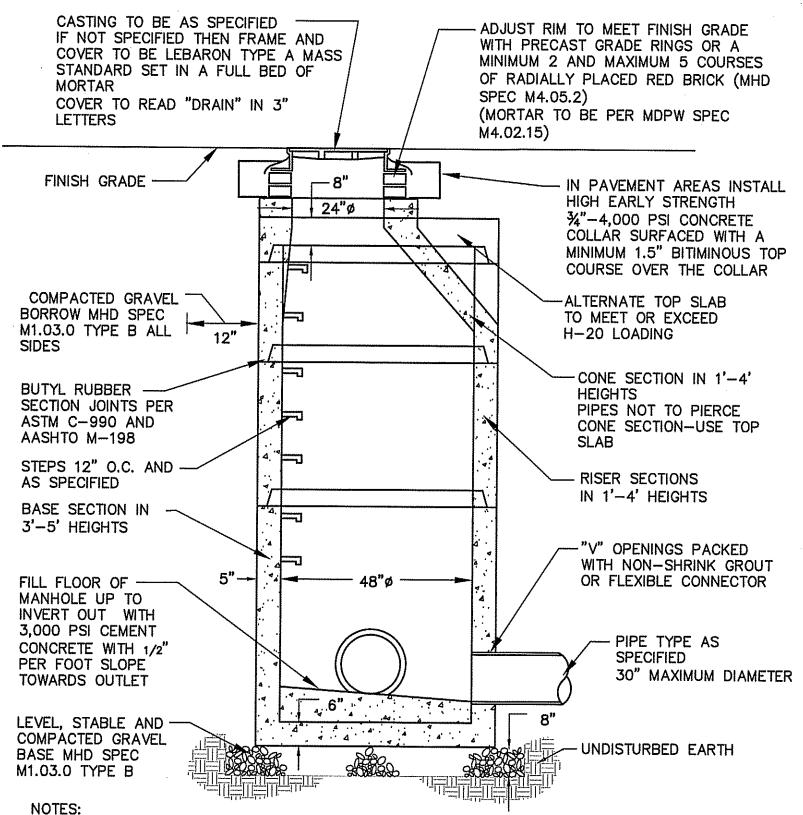


1. EXCAVATION TO ALLOW FOR FREE TRAVEL OF COMPACTION EQIPMENT 2. ALL COMPACTION TO A MINIMUM 95 PERCENT DRY DENSITY DETERMINED BY ASTM D1557 SEE SPECIFICATIONS FOR ADDITIONAL REQUIREMENTS

- 3. ALL PRECAST TO MEET OR EXCEED ASTM C-478 AND ASSHTO M 199 SPECIFICATIONS 4. REINFORCED STEEL TO MEET OR EXCEED ASTM A185 AND H-20 LOADING REQUIREMENTS 5. ALL PRECAST CONCRETE TO BE 4,000 PSI MIMIMUM AND MEET ASTM C-478 (6.1) 6. IF NO STEPS ARE SPECIFIED THAN AS THE LOCAL MUNICIPALITY REQUIRES OR IF NO MUNICIPLAITY REQUIREMENTS THEN COPOLYMER POLYPROPYLENE COATED REINFORCED PER ASTM C-478 AND OSHA (STD 1-1.9)
- 7. CONTRACTOR TO CONFIRM WITH CITY OR TOWN DPW THAT BRICK INVERTS ARE NOT A REQUIREMENT 8. FILL ALL INTERNAL AND EXTERNAL HOLES WITH NON-SHRINK GROUT

PRECAST CONCRETE DRAIN MANHOLE DETAIL

N.T.S.

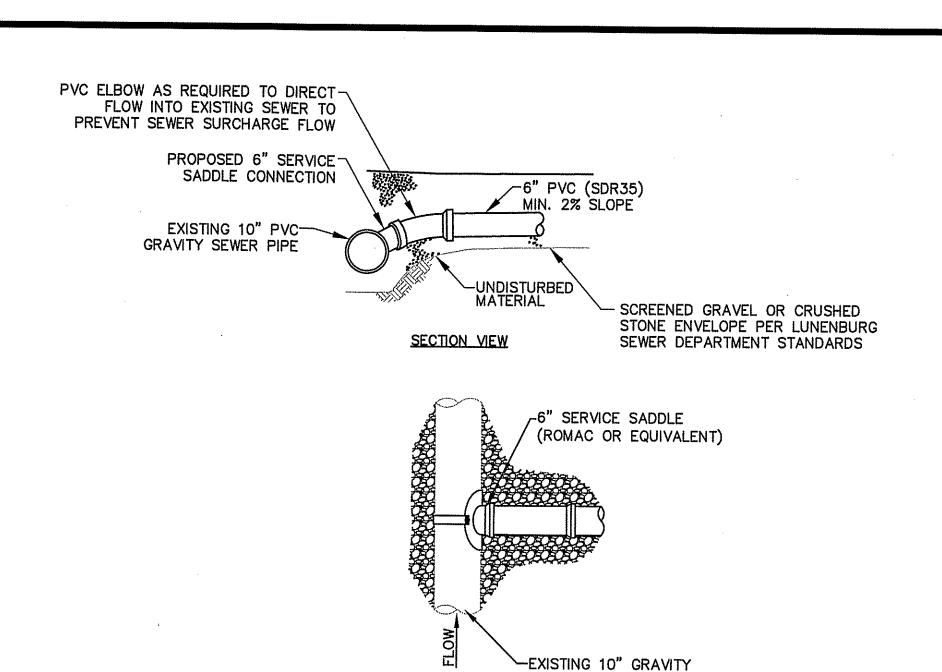

1. INSTALL SADDLE FIRST, THEN CORE HOLE. 2. INSERTA-TEE SERVICE CONNECTORS OR WYE CONNECTORS MAY BE ALLOWED UPON DPW APPROVAL IF UTILITY CONFLICTS ARE ENCOUNTERED THAT ALTER DESIGN INVERTS.

PLAN VIEW

SEWER PIPE

FABRIC OR

EQUIVALENT

RISER PIPE CAP ELEVATION TO BE SET FLUSH W/GRADE.

2. ALTERNATE CLEANOUTS MAY BE UTILIZED WITH PRIOR

CLEANOUT/YARD DRAIN DETAIL

N.T.S.

PROPOSED -


GEOTEXTILE FABRIC-

APPROVAL.


PAVEMENT AREA

SEWER SERVICE CONNECTION DETAIL

N.T.S.

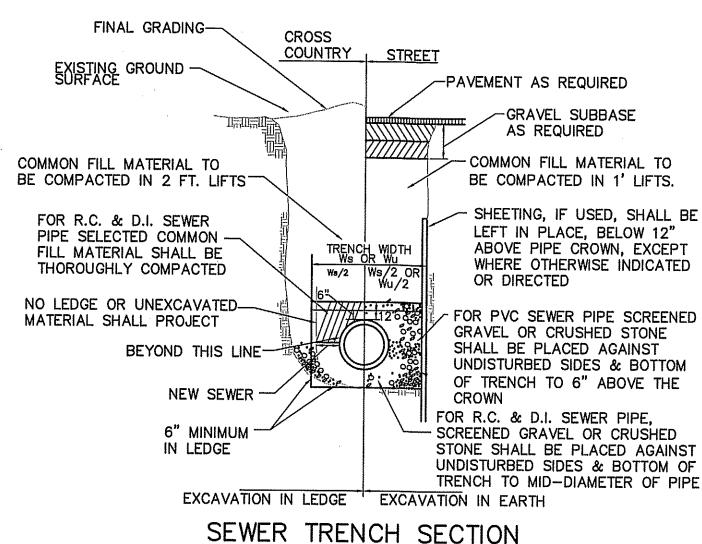

SEWER TRENCH SECTION N.T.S.

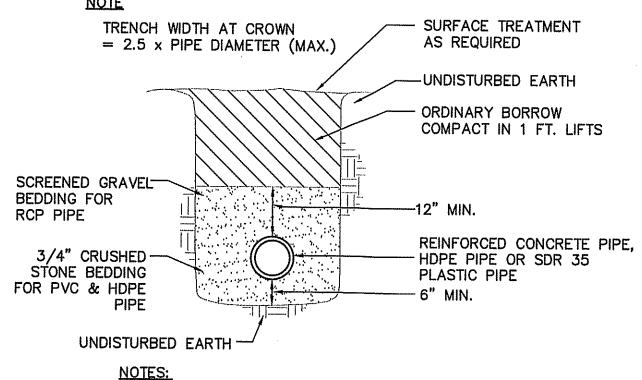


1. TRENCH EXCAVATION WIDTH TO ALLOW FOR FREE TRAVEL OF COMPACTION EQUIPMENT 2. ALL COMPACTION TO A MINIMUM 95 PERCENT DRY DENSITY DETERMINED BY ASTM D1557.

3. SEE MANUFACTURERS SPECIFICATIONS FOR ADDITIONAL INSTALLATION REQUIREMENTS

4. AVOID HEAVY EQUIPMENT LOADS OVER PIPE DURING CONSTRUCTION

DRAIN PIPE TRENCH DETAIL

N.T.S.

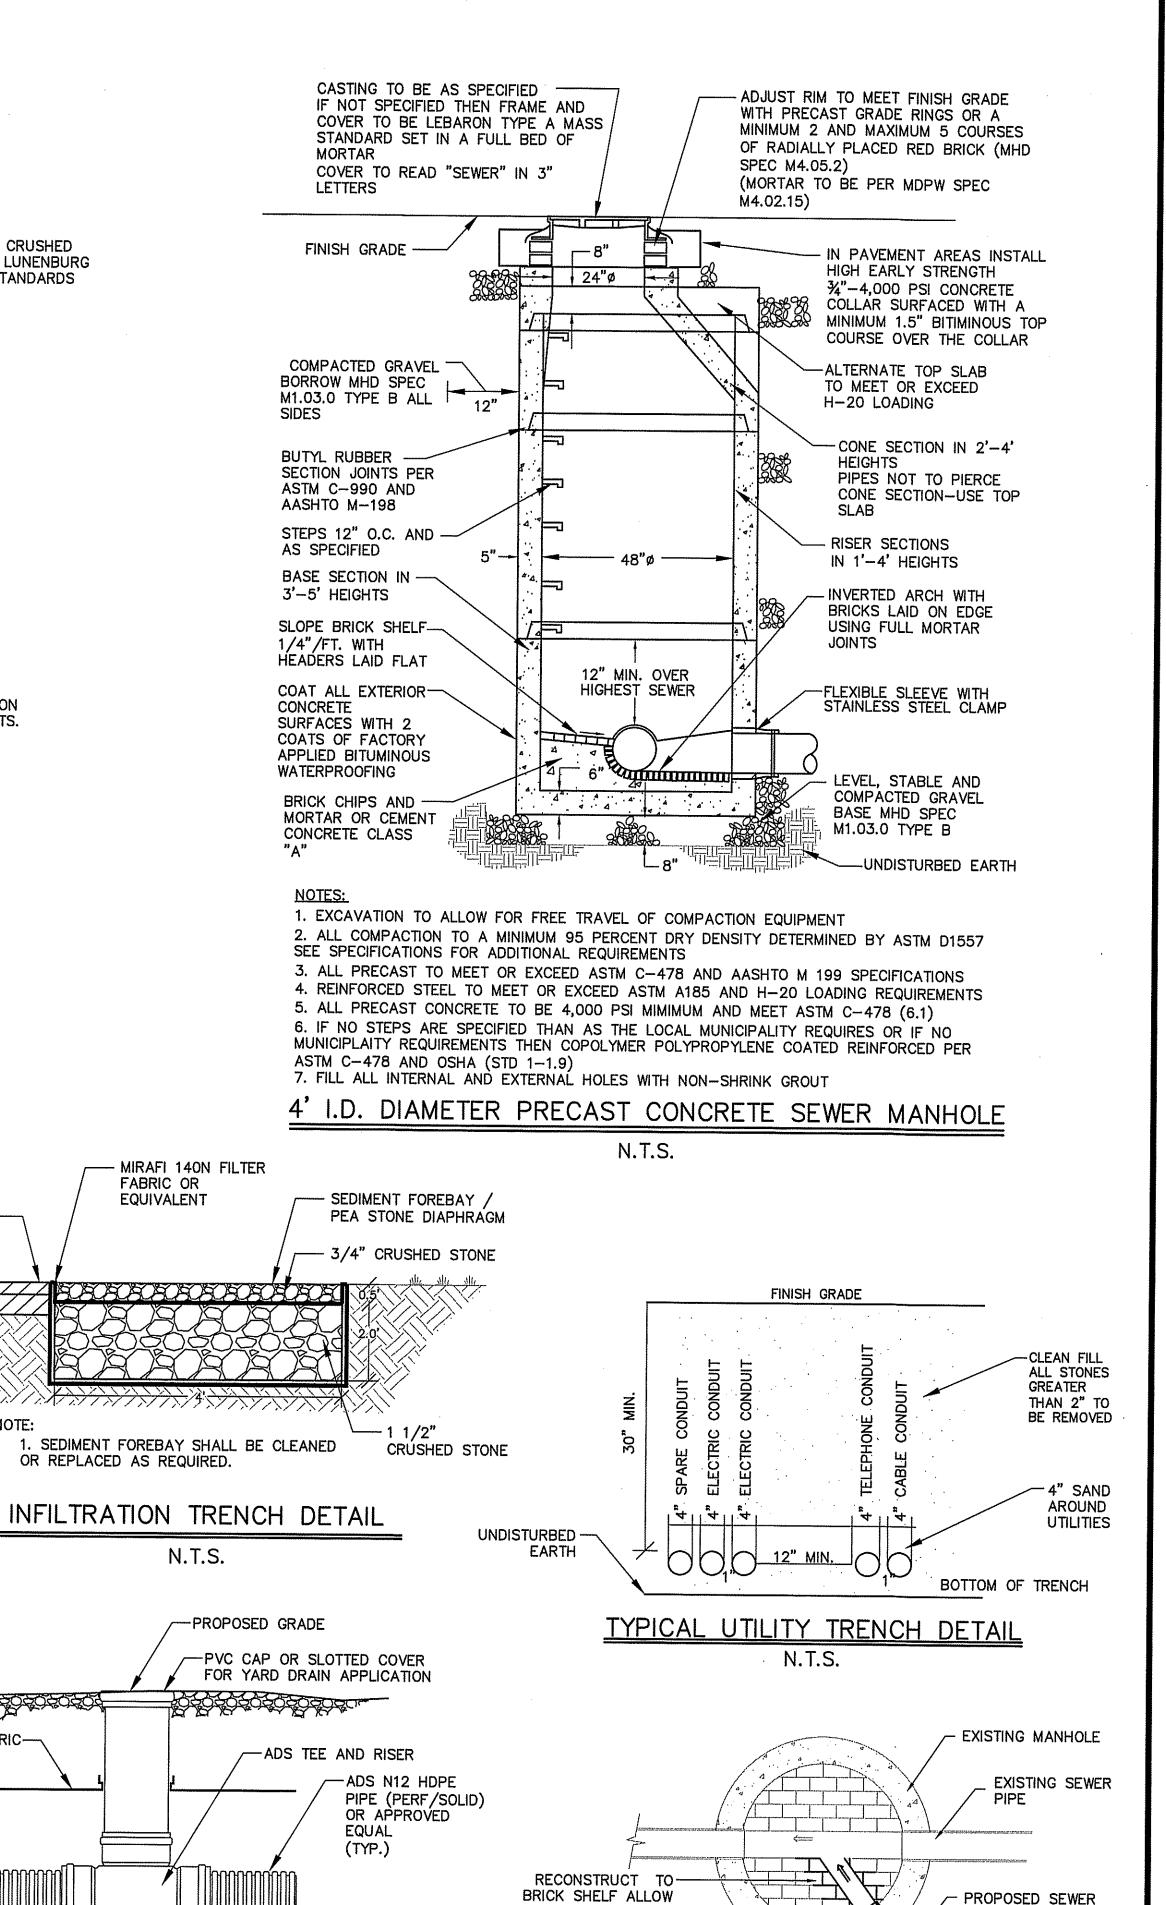

FLOW FROM PROPOSED

SEWER TO ENTER

INTERUPTING THE

EXISTING FLOW

MAKE CONNECTION TO EXISTING SEWER -

MANHOLE USING CORE BORING AND A

RUBBER BOOT

CONNECTION TO EXISTING SMH

N.T.S.

MANHOLE WITHOUT

McCarty Engineering, Inc. Civil Engineers 42 Jungle Road, Leominster, MA 01453 phone:(978) 534-1318 fax: (978) 840-6907 www.mccartydb.com Project Name

3/10/21

Date

No Revision

Revision

BRIAN R. MARCHETTI

CIVIL

NO. 46279

PEGISTERED

Drawn By: Designed By: Checked By


PJM

Riverdale 30 Riverdale Avenue Newton, MA

> Sheet Title Construction Details

<u>Job No</u>: 195 File Name: 195P-DET02 Date: February 22, 2021

Sheet No. Scale: N.T.S.

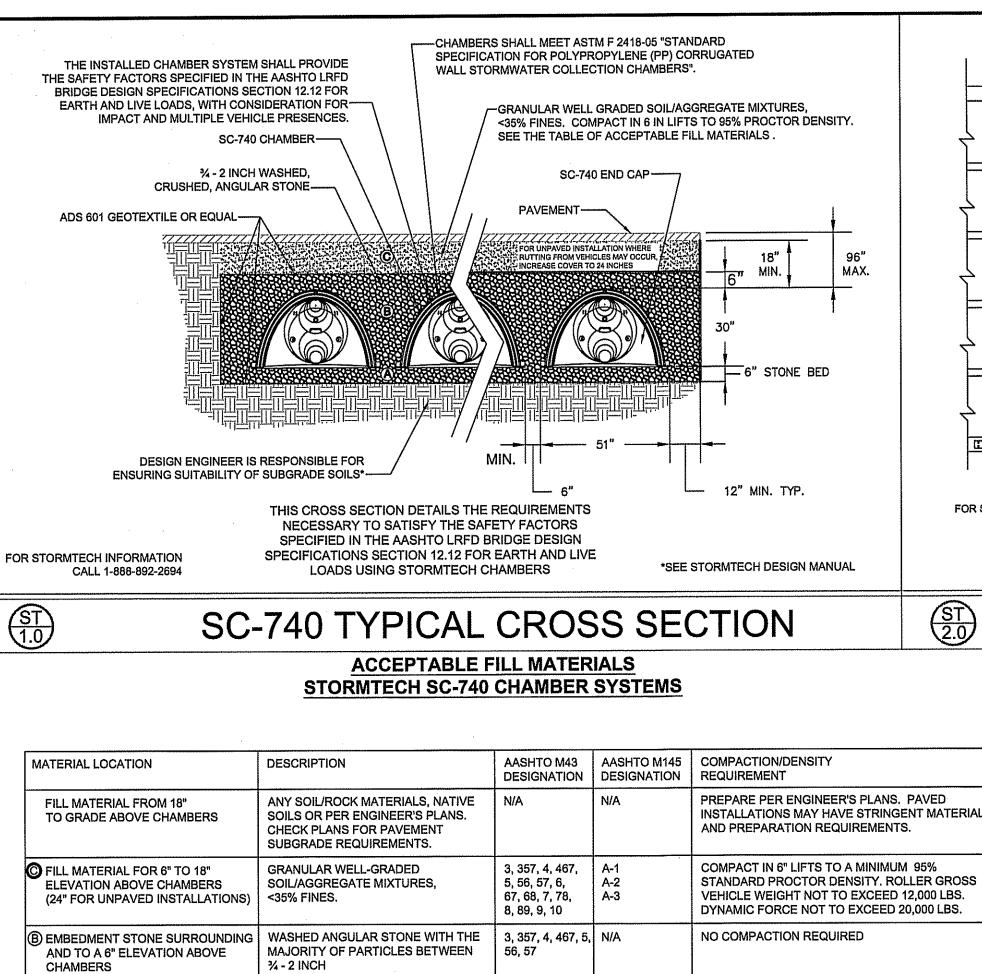

WASHED ANGULAR STONE WITH THE | 3, 357, 4, 467,

PLEASE NOTE: THE LISTED AASHTO DESIGNATIONS ARE FOR GRADATIONS ONLY. THE STONE MUST ALSO BE WASHED CRUSHED ANGULAR. FOR EXAMPLE, THE

STORMTECH ACCEPTABLE FILL MATERIALS

MAJORITY OF PARTICLES BETWEEN

A FOUNDATION STONE BELOW

MANHOLE WITH -

OVERFLOW WEIR

ECCENTRIC


PREFABRICATED

PLACE MINIMUM 12.5' OF AASHTO M288

SEDDING STONE FOR SCOUR PROTECTION

CLASS 1 WOVEN GEOTEXTILE OVER

AT ALL CHAMBER INLET ROWS

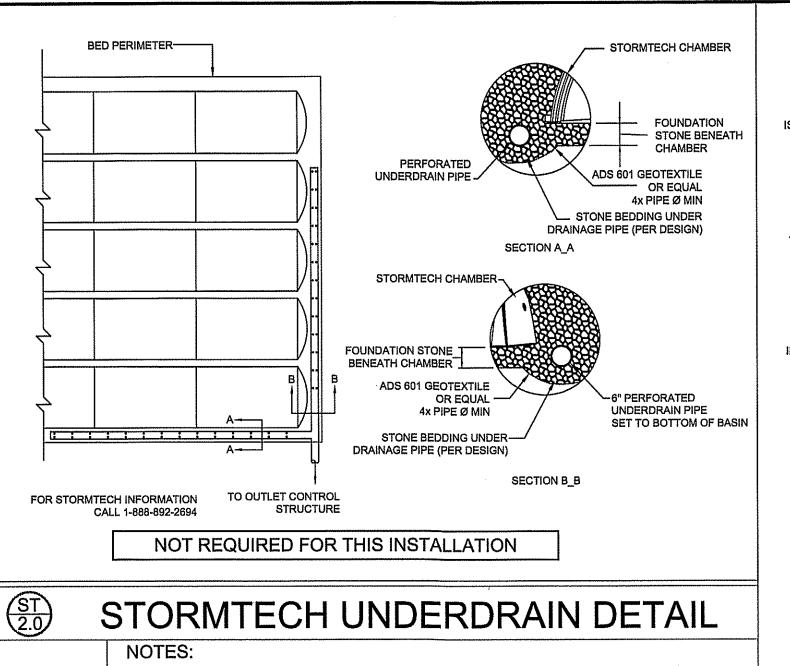

ACCORDANCE WITH THE LATEST STORMTECH INSTALLATION

WWW.STORMTECH.COM TO RECEIVE A COPY OF THE LATEST

4. CHAMBERS SHALL MEET THE DESIGN REQUIREMENTS AND

SAFETY FACTORS SPECIFIED IN SECTION 12.12 OF THE LATEST

EDITION OF THE AASHTO LRFD BRIDGE DESIGN SPECIFICATIONS.

INSTALLATION. CALL 1-888-892-2694 OR VISIT

STORMTECH INSTALLATION INSTRUCTIONS.

3. THE CONTRACTOR IS ADVISED TO REVIEW AND UNDERSTAND

THE INSTALLATION INSTRUCTIONS PRIOR TO BEGINNING SYSTEM


INSTRUCTIONS.


PLATE COMPACT OR ROLL TO ACHIEVE A


STORMTECH

—STORMTECH CHAMBERS


ISOLATOR ROW

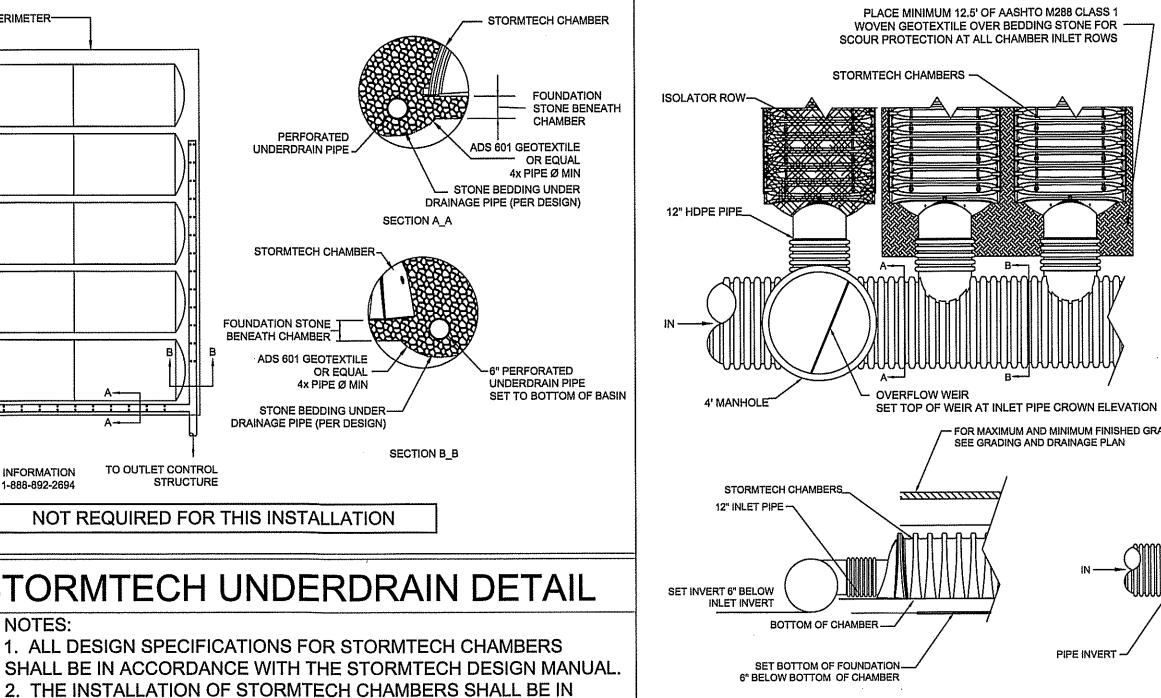

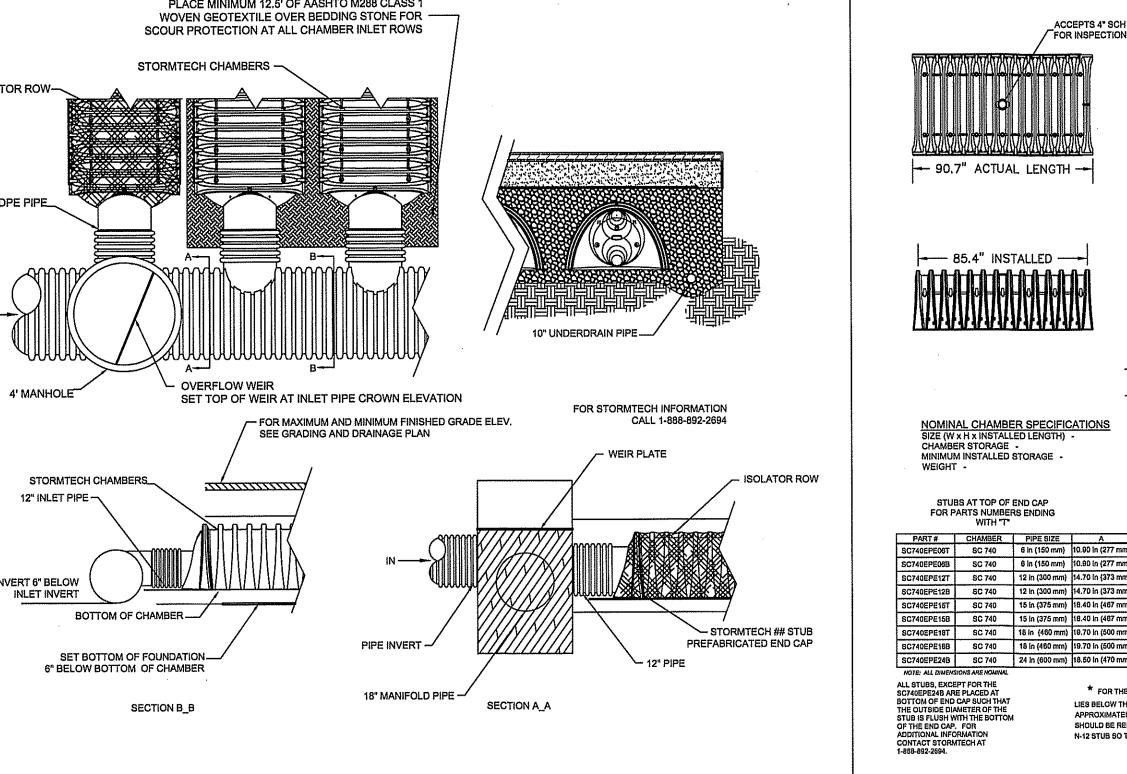

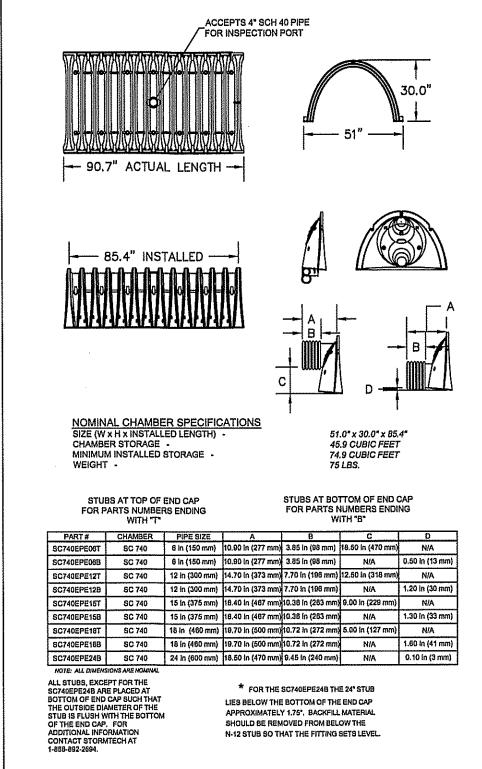


TECHNICAL DETAILS

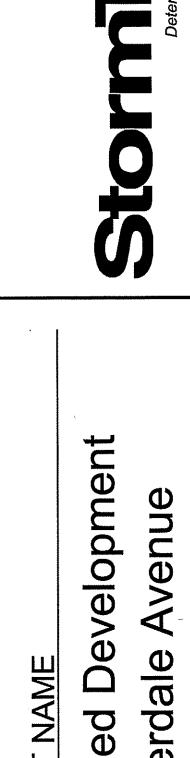

STORMTECH ELEVATIONS

PROPOSED LAYOUT (16) STORMTECH SC-740 CHAMBERS INSTALLED WITH 6" COVER STONE, 6" BASE STONE, 40% STONE VOID **INSTALLED SYSTEM VOLUME: 1,465 CF**

PROPOSED BASIN TOP OF STONE: 11.87 **BOTTOM OF STONE: 8.37 BOTTOM OF CHAMBER: 8.87**

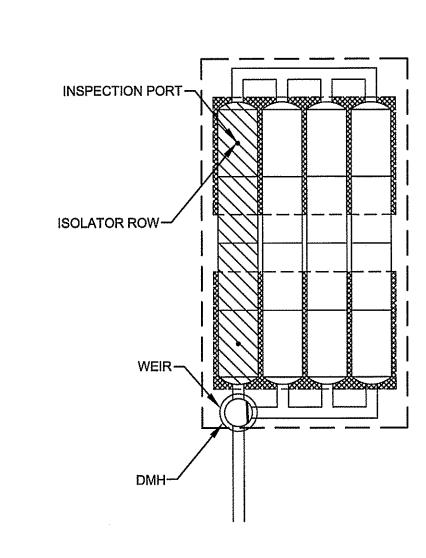

UNDERGROUND INFILTRATION BASINS (SC-740 - 16 CHAMBERS)



This drawing was prepared to support the sign engineer for the proposed conversion. It is the ultimate responsibility of the design engineer to issure that the stormwater system's desi s in full compliance with all applicable laws and regulations. It is the design engineer's responsibility to ensure that the StormTech products a designed in accordance with StormTech minimum requirements StormTech LLC does not approve plans sizing, or system designs. The design engineer is responsible for all design decisions.

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wton

No Revisions	3/10/21
STORMTECH 20/BEAVER(RD/ISL WETHERSFIELD, IC tell 888-892-20 fax 866-328-8	T 06109 394 \


DRAWING TITLE

Stormtech Infiltration Basin Details

CHAMBER DETAIL SHEET			
/ED AS	195P-DET03		
WN BY	BRM	CHECKED BY	BRM
\LE	NTS	DRAWING NO.	

FLOOR BOX FRAME AND LID W/S.S. CAP SCREW LID CLOSURE INSPECTION PORT WITH SCREW-IN CAP PAVEMENT -- CLASS "C" CONCRETE AASHTO M288 CLASS 2 NON-WOVEN GEOTEXTILE **INSPECTION PORT TO BE** SC-740 CHAMBER-ATTACHED THROUGH KNOCK-OUT LOCATED AT CENTER OF CHAMBER AASHTO M288 CLASS 2 NON-WOVEN GEOTEXTILE FOR STORMTECH INFORMATION CALL 1-888-892-2694

STORMTECH INSPECTION PORT DETAIL

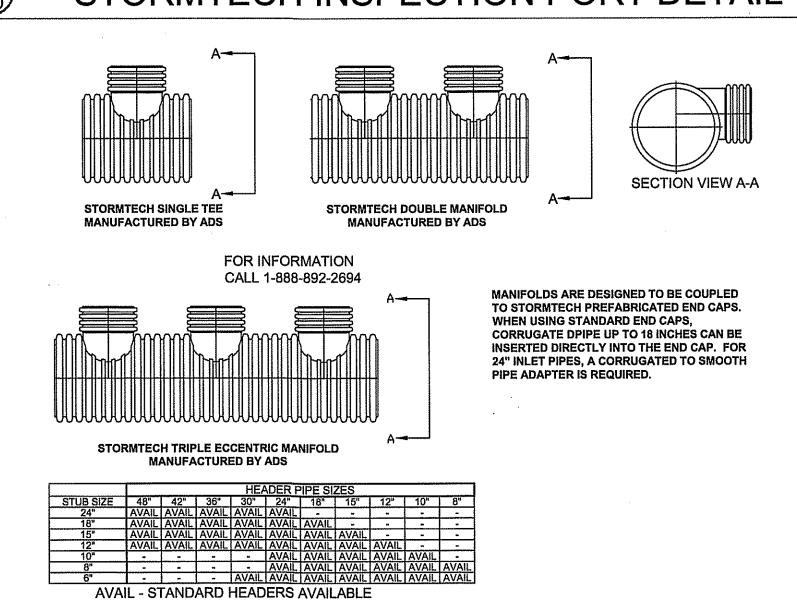

CHAMBERS SHALL MEET THE DESIGN REQUIREMENTS AND SAFETY FACTORS SPECIFIED IN SECTION 12.12 OF THE LATEST EDITION OF THE AASHTO LRFD BRIDGE DESIGN SPECIFICATIONS LOADS SHALL BE CALCULATED IN ACCORDANCE WITH SECTION 3 AND SHALL INCLUDE H20 DESIGN TRUCK, IMPACT FACTOR, MULTIPLE PRESENCE, AND LANE LOAD.

STORMTECH ISOLATOR™ ROW DETAIL

STORMTECH SC-740 CHAMBER LAYOUT

FOR STORMTECH INFORMATION CALL 1-888-892-2694 STORMTECH ISOLATOR™ ROW MANIFOLD DETAIL **COVER ENTIRE ROW WITH** - AASHTO M288 CLASS 2 NON-WOVEN **GEOTEXTILE OR EQUAL** SC-740--8' WIDE STRIP INSPECTION PORT SC-310--5' WIDE STRIP BY DESIGN ENGINEER - STORMTECH ENDCAP MANHOLE BY DESIGN ASHTO M288 CLASS 1 WOVEN GEOTEXTILE OR EQUAL, FOR STORMTECH INFORMATION BETWEEN FOUNDATION STONE AND CHAMBERS SC-740--5'-6' WIDE STRIP

ADS MANIFOLD DETAILS

DATE REVISIONS

ROJECT NO.