# FISHMAN RESIDENCE

# 43 KENWOOD AVE, NEWTON, MA 02459 SINGLE FAMILY ALTERATION

BUILDING PERMIT SUBMISSION 2/8/21

#### **SCOPE OF WORK:**

-INTERIOR IMPROVEMENTS TO PRIVATE HOME CONSISTING OF NON-LOAD BEARING DEMOLITION AND RECONFIGURATION OF SPACE ON SECOND FLOOR.

-SECOND FLOOR REAR ADDITION WITHIN EXISTING BUILDING FOOTPRINT. ALL STRUCTURAL ALTERATIONS WILL BE PERFORMED IN FULL COMPLIANCE WITH THE STATE BUILDING CODE. INCREASED FAR BY 0.02. PROPOSED WINDOW SEAT DOES NOT AFFECT FAR.

-PROPOSED SECOND STORY DORMER IS ENTIRELY BELOW EAVE LINE OF EXISTING PARTIAL THIRD FLR. DOES NO EXTEND EXTERIOR FOOTPRINT OF STRUCTURE. NO INCREASE TO FAR.

#### **GENERAL NOTES:**

1. ALL AREA CALCULATIONS ARE BASED ON DATA FROM EXISTING DEEDS CITY RESOURCES AND FIELD MEASUREMENTS WHERE POSSIBLE. ALL DIMENSIONS AND EXISTING CONDITIONS SHALL BE CHECKED AND VERIFIED BY THE CONTRACTOR AT THE SITE.

2. ALL CODES HAVING JURISDICTION SHALL BE STRICTLY APPLIED IN THE CONSTRUCTION OF THE PROJECT, INCLUDING ALL APPLICABLE STATE, CITY AND COUNTY BUILDING, ZONING, ELECTRICAL, MECHANICAL, PLUMBING AND FIRE CODES. ALL CODES, TRADE STANDARDS AND MANUFACTURER'S INSTRUCTIONS REFERRED TO SHALL BE THE LATEST EDITION.

3. ALL STRUCTURAL ALTERATIONS WILL BE PERFORMER IN FULL COMPLIANCE WITH THE STATE BUILDING CODE. SEE STRUCTURAL DWGS.

4. HOLD INDICATED DIMENSIONS. CONFIRM DIMENSIONS BEFORE PROCEEDING. PLANS ARE BASED ON EXISTING DRAWINGS. ALL MEASUREMENTS SHOULD BE CONSIDERED APPROXIMATE UNTIL VERIFIED IN FIELD. ANY DISCREPENCIES MUST BE RESOLVED BY COMMUNICATION WITH ARCHITECT BEFORE PROCEEDING.

5. ALIGNMENT NOTES SUPERCEDE DIMS WHERE NOTED. WHERE CONFLICTING INFORMATION IS NOTED, DIRECTION TO BE PROVIDED BY ARCHITECT.

6. MAINTAIN EXISTING LEVEL OF FIRE PROTECTION THROUGHOUT CONSTRUCTION, PER IEBC 2009 SECTION 603.1

7. DO NOT SCALE DRAWINGS.

**ABOVE** 

INTERIOR

JOINT LOCATION

LIGHT

LOC

## **ABBREVIATIONS:**

ADV	ADOVL		
ADDNL	ADDITIONAL		
ADJ	ADJACENT		
AFF	ABOVE FINISHED FLOOR	NAANIT	MANUEACTURED
AHU	AIR HANDLING UNIT	MANF	MANUFACTURER
ALN	ALIGN	MAS	MASONRY
ALT	ALTERNATE	MAT	MATERIAL
		MECH	MECHANICAL
@	AT A PPP OVINA TE	MTL	METAL
APRX	APPROXIMATE	N	NORTH
BLW	BELOW	NIC	NOT IN CONTRACT
ВО	BOTTOM OF	NTS	NOT TO SCALE
CEM	CEMENT, CEMENTITIOUS	OC	ON CENTER
CLG	CEILING	OFCI	OWNER FURNISHED
COL	COLUMN	01 01	CONTRACTOR INSTALLED
CONT	CONTINUOUS	OPG	OPENING
CONTR	CONTRACTOR	NOM	NOMINAL
COORD	COORDINATE		
CPT	CARPET	PLYWD	PLYWOOD
DEMO	DEMOLITION	PNTD	PAINTED
DIA	DIAMETER	PNT	PAINT
DIM	DIMENSION	PL	PROPERTY LINE
DN	DOWN	RA	RETURN AIR REGISTER
		RECP	RECEPTACLE
DR DT	DOOR	REINF	REINFORCEMENT
DTL	DETAIL	REM	REMOVE
E	EAST	REQ	REQUIRED
ELEV	ELEVATOR	RF	ROOF
EQ	EQUAL	RO	ROUGH OPENING
EQUIP	EQUIPMENT	SA	SUPPLY AIR REGISTER
EXP	EXPOSED	SCHD	SCHEDULE
EXT	EXTERIOR	SECT	SECTION
EXSTG	EXISTING	SF	SQUARE FEET
FD	FLOOR DRAIN	SHT	
FDN	FOUNDATION		SHEET
		SIM	SIMILAR
FIN	FINISH	STL	STEEL
FLR	FLOOR	ST STL	STAINLESS STEEL
FO	FACE OF	TO	TOP OF
FRM	FROM	TYP	TYPICAL
FTG	FOOTING	UNO	UNLESS NOTED OTHERWISE
GALV	GALVANIZED	W/	WITH
GC	GENERAL CONTRACTOR	W/O	WITHOUT
GWB	GYPSUM WALL BOARD	WD	WOOD
GRD	GRADE	WP	WORK POINT
HDR	HEADER	WTR	WATER
HT	HEIGHT		· · · · · · · ·
INSUL	INSULATION		
-	<del></del>		

#### **ZONING CODE SUMMARY**

APPROVED UNDER PERMIT #513-18 - ZONING, SPECIAL PERMIT; HISTORIC - NOT REQUIRED BECAUSE OF SIZE OF PROJECT

#### **GOVENING ZONING CODE:**

ORDINANCES OF THE CITY OF NEWTON
CHAPTER 30: ZONING ORDINANCE (11/1/2015)

ZONING DISTRICT: SR-2 SINGLE-FAMILY RESIDENCE

**CURRENT USE:** SINGLE FAMILY RESIDENCE

PROPOSED USE: NO CHANGE

CRITERIA:	<b>REQUIRED:</b>	<b>EXISTING:</b>	PROPOSED:
LOT AREA	10,000 SF	10,667 SF	NO CHANGE
LOT AREA PER UNIT	15,000 SF	10,610 SF	NO CHANGE
FRONTAGE	80'	82'	NO CHANGE
FRONT SETBACK	25'	30'	NO CHANGE
SIDE SETBACK	7.5'	9.2'	NO CHANGE
REAR SETBACK	15'	39.8'	NO CHANGE
BUILDING HEIGHT	36' SLOPED	29.2'	NO CHANGE
MAX STORIES	2.5	2.5	NO CHANGE
OPEN SPACE	5,305 SF (50%)	7,911 SF (74.6%)	NO CHANGE
LOT COVERAGE	3,183 SF (30%)	1660 SF (15.6%)	NO CHANGE
ΕΛR	37	.42	.44

## BUILDING CODE SUMMARY: GOVERNING CONSTRUCTION CODE:

MASSACHUSETTS STATE BUILDING CODE: NINTH ADDITION, RESIDENTIAL BUILDING CODE

## SECTION R302 FIRE RESISTANT CONSTRUCTION:

R302.1 EXTERIOR WALLS PER TABLE R302.1(1), EXTERIOR WALLS W/ EQ OR > 5 FEET OF SEPARATION DISTANCE IS NOT REQUIRED TO BE FIRE-RESISTANCE RATED

A. ROOF EAVE FIRE-RESISTANCE RATING SHALL BE PERMITTED TO BE REDUCED TO 0 HOURS ON THE UNDERSIDE OF THE EAVE IF FIREBLOCKING IS PROVIDED FROM THE WALL TOP PLATE TO THE UNDERSIDE OF THE ROOF SHEATHING.

B. ROOF EAVE FIRE-RESISTANCE RATING SHALL BE PERMITTED TO BE REDUCED TO 0 HOURS ON THE UNDERSIDE OF THE EAVE PROVIDED THAT GABLE VENT OPENINGS ARE NOT INSTALLED.

## R302.9.1 FLAME SPREAD INDEX

WALL AND CEILING FINISHES SHALL HAVE A FLAME SPREAD INDEX OF NOT GREATER THAN 200.

## R302.13 FIRE PROTECTION OF FLOORS

FLOOR ASSEMBLIES THAT ARE NOT REQUIRED ELSEWHERE IN THIS CODE TO BE FIRE-RESISTANCE RATED, SHALL BE PROVIDED WITH A 1/2-INCH (12.7 MM) GYPSUM WALLBOARD MEMBRANE, 5/8-INCH (16 MM) WOOD STRUCTURAL PANEL MEMBRANE, OR EQUIVALENT ON THE UNDERSIDE OF THE FLOOR FRAMING MEMBER.

PENETRATIONS OR OPENINGS FOR DUCTS, VENTS, ELECTRICAL OUTLETS, LIGHTING, DEVICES, LUMINAIRES, WIRES, SPEAKERS, DRAINAGE, PIPING AND SIMILAR OPENINGS OR PENETRATIONS SHALL BE PERMITTED.

303.3 BATHROOMS MECHANICAL VENTILATION IN ACCORDANCE WITH SECTION M1507 IS REQUIRED FOR ALL BATHROOMS WITH A SHOWER OR BATHTUB AND ROOMS WITH A TOILET.

## ELECTRICAL SCOPE + PERMITTING


ELECTRICAL PERMITS SHALL BE DESIGN BUILD UNDER A SEPARATE PERMIT APPLICATION AND SHALL MEET REQUIRED MINIMUMS PER BUILDING CODE JURISDICTION

## MECHANICAL SCOPE + PERMITTING

MECHANICAL PERMITS SHALL BE DESIGN BUILD UNDER A SEPARATE PERMIT APPLICATION AND SHALL MEET REQUIRED MINIMUMS PER BUILDING CODE JURISDICTION

## PLUMBING SCOPE + PERMITTING

PLUMBING PERMITS SHALL BE DESIGN BUILD UNDER A SEPARATE PERMIT APPLICATION AND SHALL MEET REQUIRED MINIMUMS PER BUILDING CODE JURISDICTION

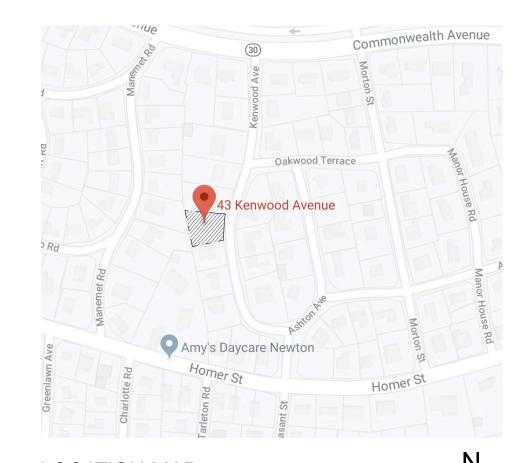

#### **DRAWING LIST:**

A100 DEMOLITION SCOPE
A200 FLOOR PLANS & INTERIOR ELEVATIONS
A300 ELEVATIONS AND BLDG SECTIONS
S1 STRUCTURAL

S2 STRUCTURAL

#### PROJECT INFORMATION

## PROJECT LOCATION:


43 KENWOOD AVE NEWTON. MA 02459

## ARCHITECTS:

STANEV POTTS ARCHITECTS
1103 SPRUCE STREET
PHILADELPHIA, PA 19107
215.625.3590

# OWNERS: MARTHA AND MARK FISHMAN 43 KENWOOD AVE

43 KENWOOD AVE NEWTON, MA 02459

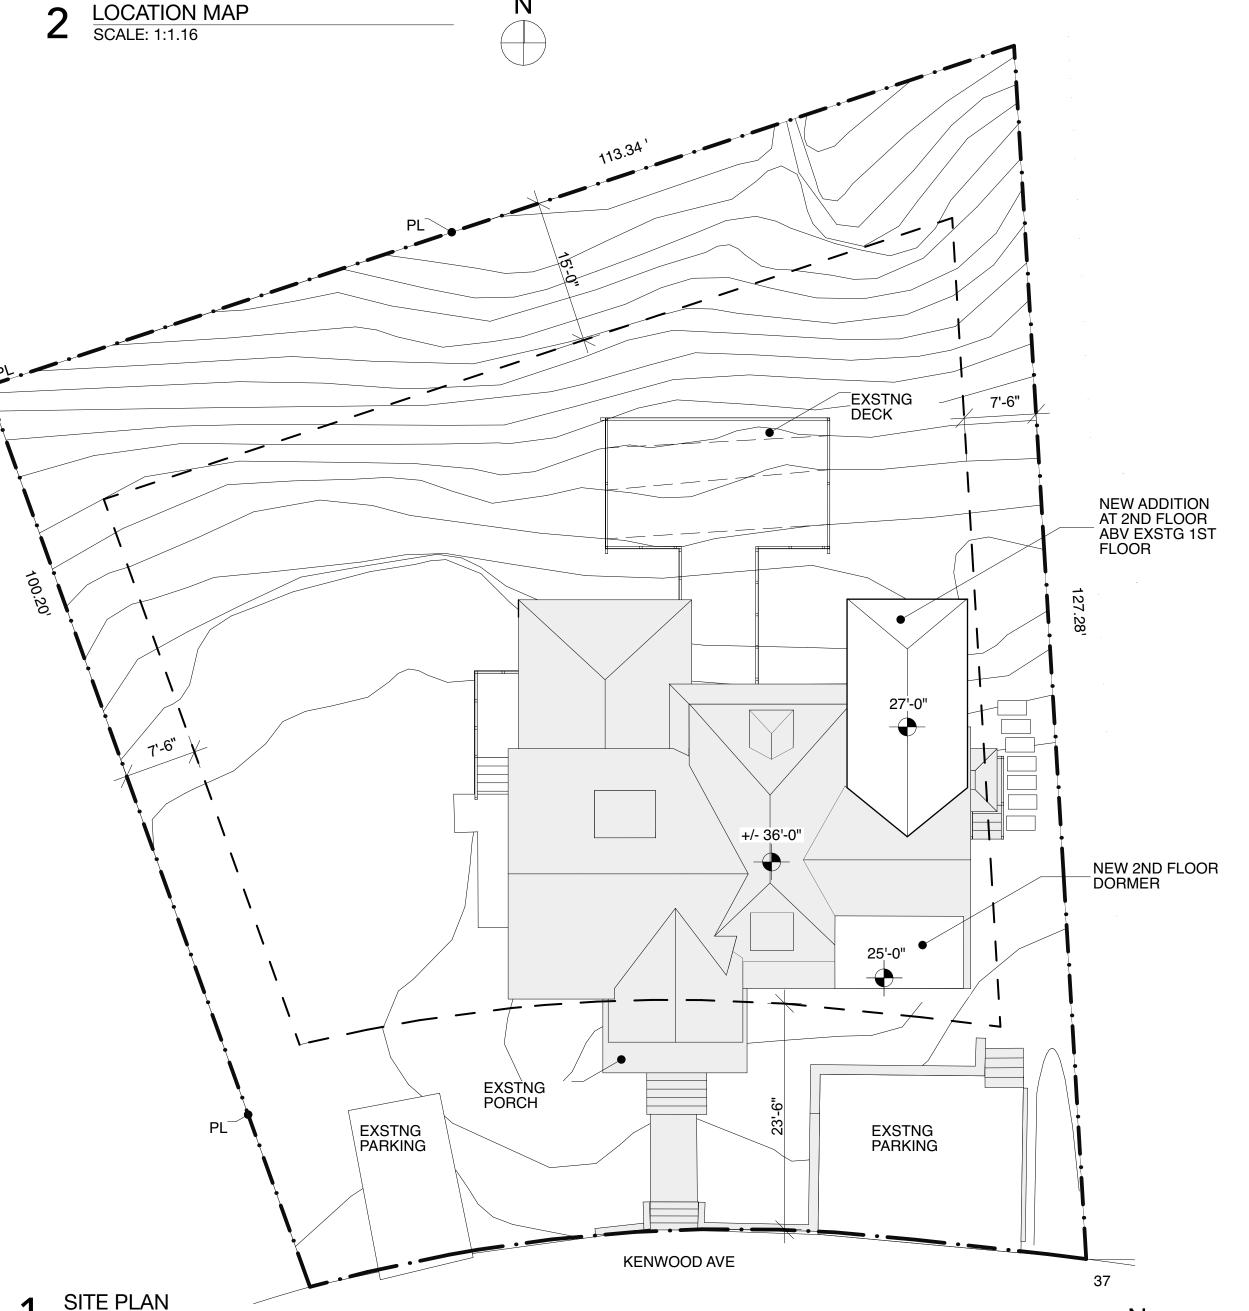

DRS MARTHA & MARK FISHMAN

PROJECT NAME

## FISHMAN RESIDENCE



Merrill
Engineers and Land Surveyors
427 Columbia Road, Hanover, MA 02339

26 Union Street, Plymouth MA 02360 /

(508) 746-6060

STRUCTURAL ENGINEERING

## Thornton Tomasetti

BUILDING STRUCTURES
75 YORK STREET
PORTLAND, MAINE 04101
207-879-1838

MEP/FP ENGINEERING

N/A

stanev potts architects

1103 Spruce Street Philadelphia PA 19107 v 215-625-3590 f 215-625-3591

**COVER SHEET** 


SCALE

SEE DRAWING



DRAWN BY
SM
CHECKED BY
PS/ SP
DATE

**G001** 

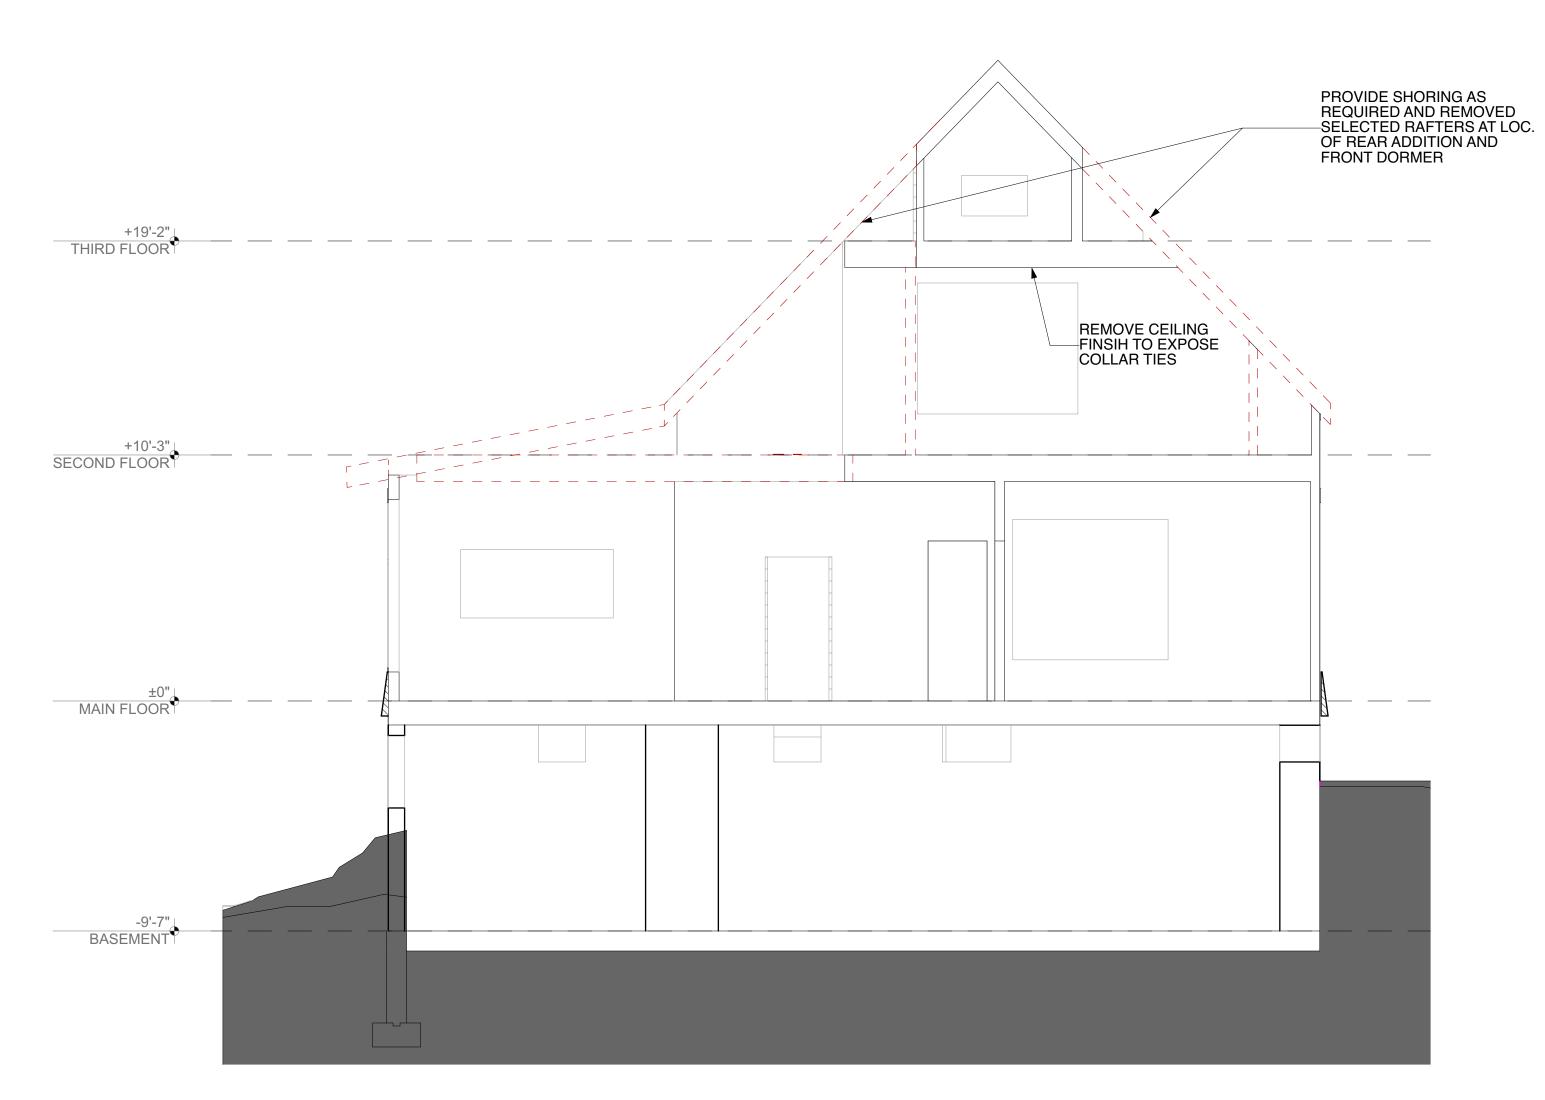

## 2 PARTIAL E/W DEMOLITION SECTION SCALE: 1/4" = 1'-0"

## **DEMO NOTES:**

DASH LINE INDICATES SCOPE OF REMOVAL & MODIFICATION. GC TO COORDINATE ANY TEMPORARY SHORING. SEE STRUCTURAL DWGS FOR ADDITIONAL INFO


DRS MARTHA & MARK

# **FISHMAN**


PROJECT NAME

ISSUANCE

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2ND FLOOR DEMO SCALE: 1/4" = 1'-0"

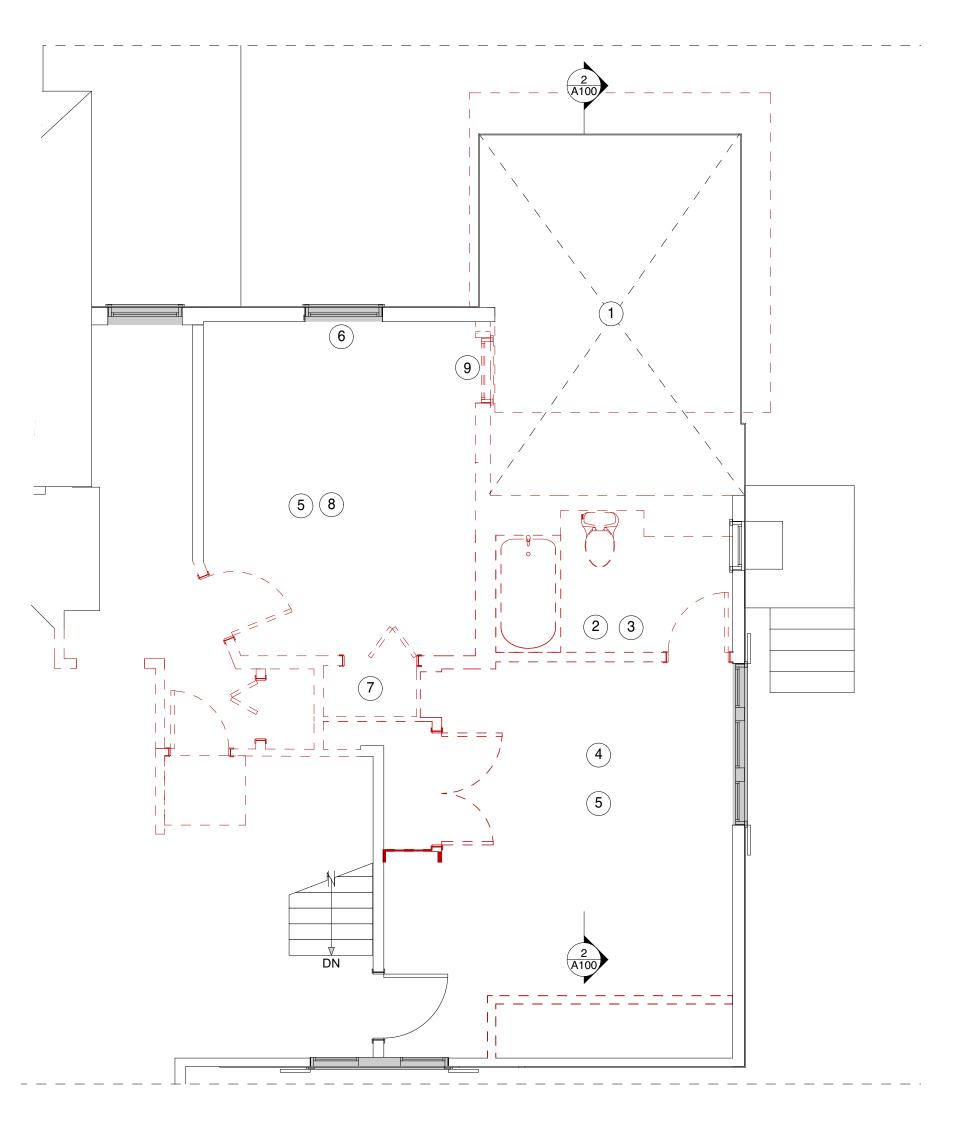

## **DEMOLITION NOTES:**

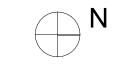EXISTING TO REMAIN

ITEMS TO BE DEMOLISHED

GC TO COORDINATE ANY REQUIREMENT FOR TEMPORARY SHORING OF BEARING WALLS WITH STRUCTURAL ENGINEER PRIOR TO DEMO.

SEE STRUCTURAL DWGS FOR ADDITIONAL DEMO NOTES.

- 1 REMOVE EX ROOF + FRAMING
- 2 REMOVE EX TILE FLOOR FINISH
- 3 REMOVE PLUMBING FIXTURES
- (4) REMOVE EX CARPET + WALL BASE
- 5 REMOVE CEILING LIGHT FIXTURES
- 6 REMOVE WINDOW TREATMENTS
- REMOVE BUILT IN SHELVES
- REMOVE EX WOOD FLOOR FINISH
- 9 SALVAGE AND REMOVE WINDOW FOR REINSTALLATION ("W5")

ISS# DATE DESCRIPTION 01 2/8/21 **BUILDING PERMIT** CONSULTANTS Merrill Engineers and Land Surveyors

**Thornton Tomasetti** 

427 Columbia Road, Hanover, MA 02339 / T: (781) 826-9200 26 Union Street, Plymouth MA 02360 / T: (508) 746-6060

**BUILDING STRUCTURES** 75 YORK STREET PORTLAND, MAINE 04101 207-879-1838

MEP/FP ENGINEERING

N/A

ARCHITECT **stanev potts** architects

1103 Spruce Street Philadelphia PA 19107 v 215-625-3590 f 215-625-3591

DRAWING TITLE

DEMOLITION SCOPE

SEE DRAWING



PROJECT NO 1708

DRAWN BY

SM CHECKED BY
PS/ SP

**A100** 


#### **GENERAL NOTES:** MILLWORK AND HARDWARE CLEAR FINISH VERTICAL GRAIN CHERRY CONCEALED EURO HINGES, SOFT CLOSE HARDWARE, DOVE TAIL JOINERY

TERIAL SCHEDULE						
TAG	DESCRIPTION	MANUFACTURER	MODEL/TYPE	FINISH/COLOR	COMMENTS	
T-1	MOSAIC FLOOR TILE					
T-2	PORCELAIN WALL TILE		16 X 36			
T-3	PORCELAIN WALL TILE					
WF-1	WOOD FLOOR		WHITE OAK			
CPT-1	BROADLOOM CARPET					
WS-1			WHITE OAK	STAINED		
WV-1			WHITE OAK	STAINED		
WS-2			POPLAR	PAINTED		
MAR-1	COUNTER		STATUARY WHITE MARBLE			
MAR-2	THRESHOLD					

FIXTURE SCHEDULE					
FIXTURE	MANUFACTURER	MODEL	COLOR/FINISH	PART NO.	NOTES
MASTER BATHROOM			!		
SHOWER HEAD	KOHLER	PURIST	POLISHED CHROME	K-965-AK-CP	
SHOWER CONTROL	KOHLER	PURIST RITE TEMP w/ LEVER HANDLE	POLISHED CHROME	K-TS14423-4-CP	
SHOWER BED	CUSTOM				
TOILET	тото	MH WALL HUNG	OI COTTON	CT437FG#01	
SINK	тото	KIWAMI RENESSE	OI COTTON	LT1719#01	
SINK FAUCET	KOHLER	HONESTY	POLISHED CHROME	K-99760-4-CP	

TAG	MANUFACTURER	MODEL/TYPE	FINISH/COLOR	HEIGHT	WIDTH	NOTES
W-1	LOEWEN	FIXED	METAL CLAD	6'-0"	5'-0"	STYLE TO MATCH EXISTNG WINDOWS
W-2	LOEWEN	CASE	METAL CLAD	4'-6"	2'-6"	STYLE TO MATCH EXISTNG WINDOWS
W-3	LOEWEN	CASE	METAL CLAD	4'-6"	2'-6"	STYLE TO MATCH EXISTNG WINDOWS
W-4	VELUX		METAL CLAD			
W-5	EXISTING					RELOCATED, ADD IN- SWING LAMINATED GLASS STORM WINDOW
W-6						STYLE TO MATCH EXISTING WINDOW

DOOR SCHEDULE						
TAG	MANUFACTURER	DESCRIPTION	MODEL/TYPE	FINISH/COLOR	NOTES	
D-01						
D-02						
D-03						
D-04						
D-05		POCKET DOOR				

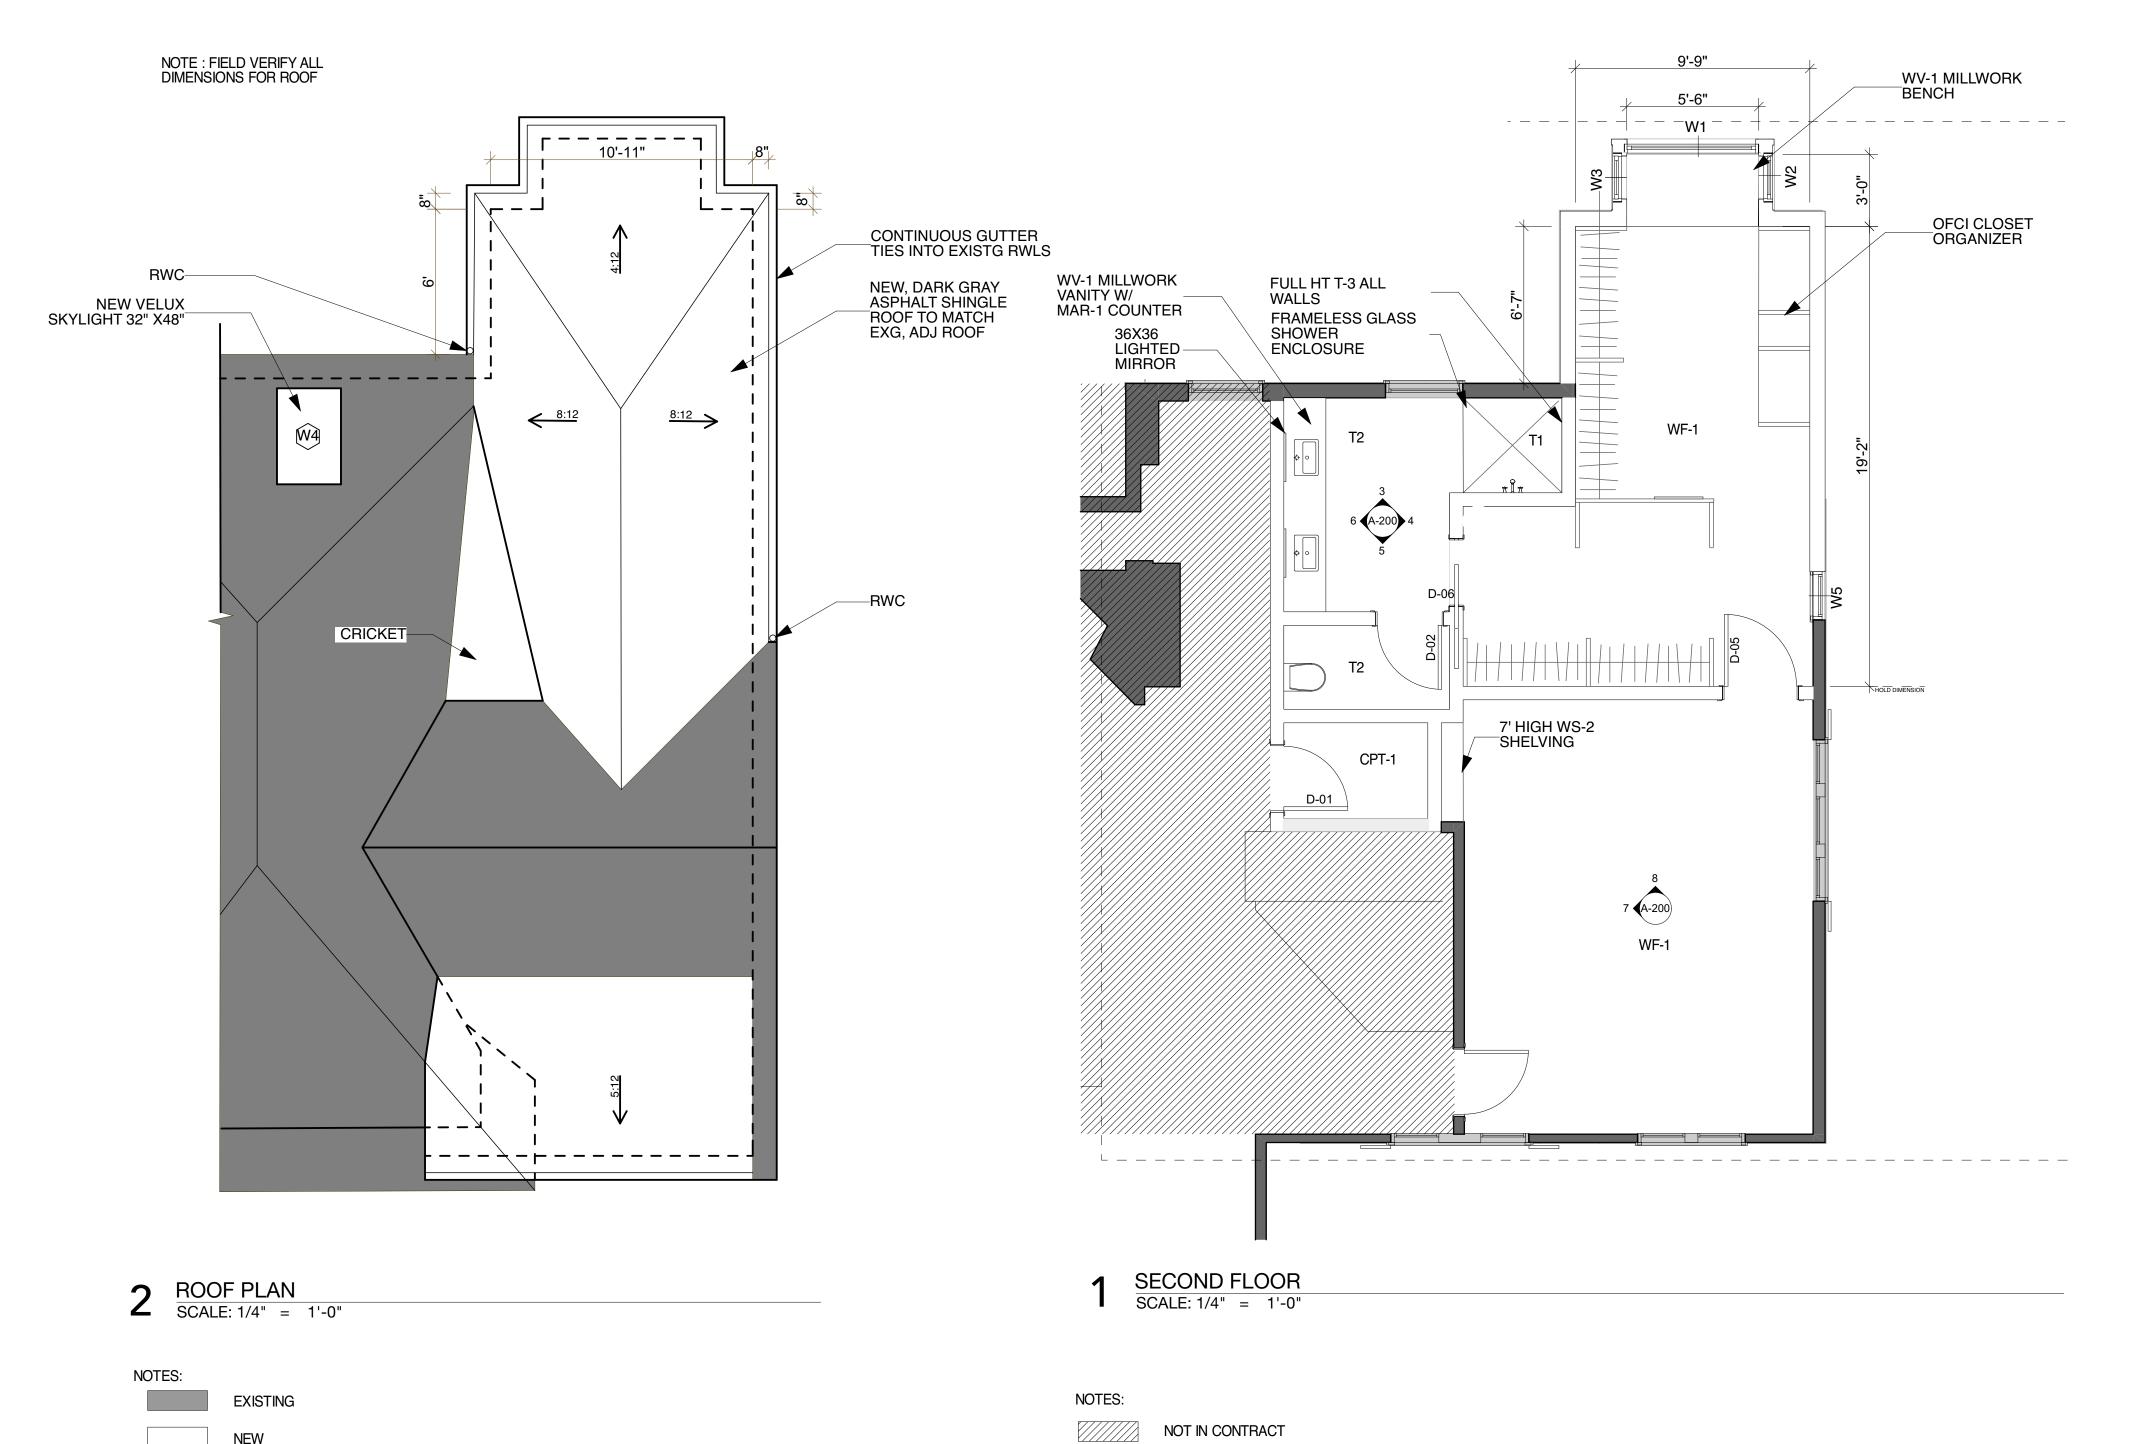

## DRS MARTHA & MARK **FISHMAN**

PROJECT NAME

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ISSUANCE ISS# DATE DESCRIPTION 01 2/8/21 **BUILDING PERMIT** 

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N/A


**stanev potts architects**1103 Spruce Street Philadelphia PA 19107
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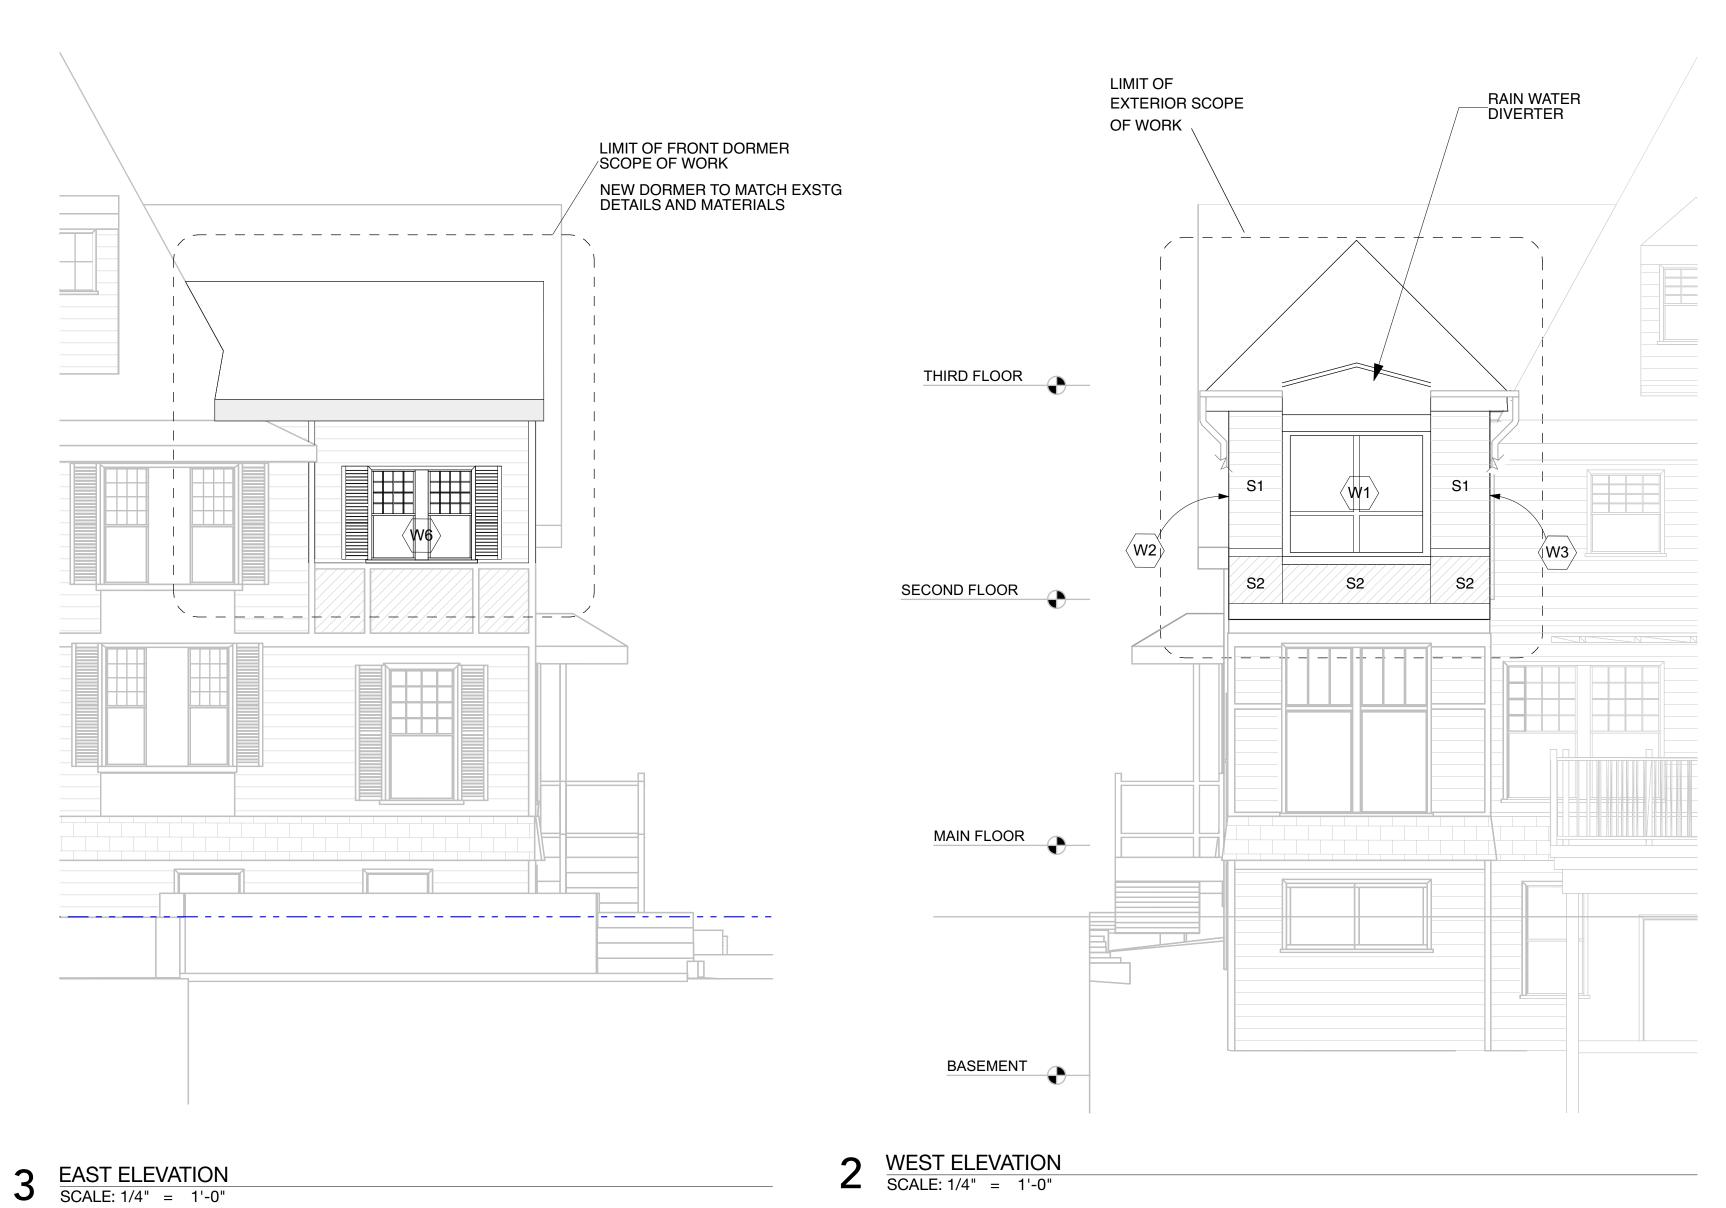
FLOOR PLANS & INTERIOR ELEVATIONS

SEE DRAWING




**A200** 




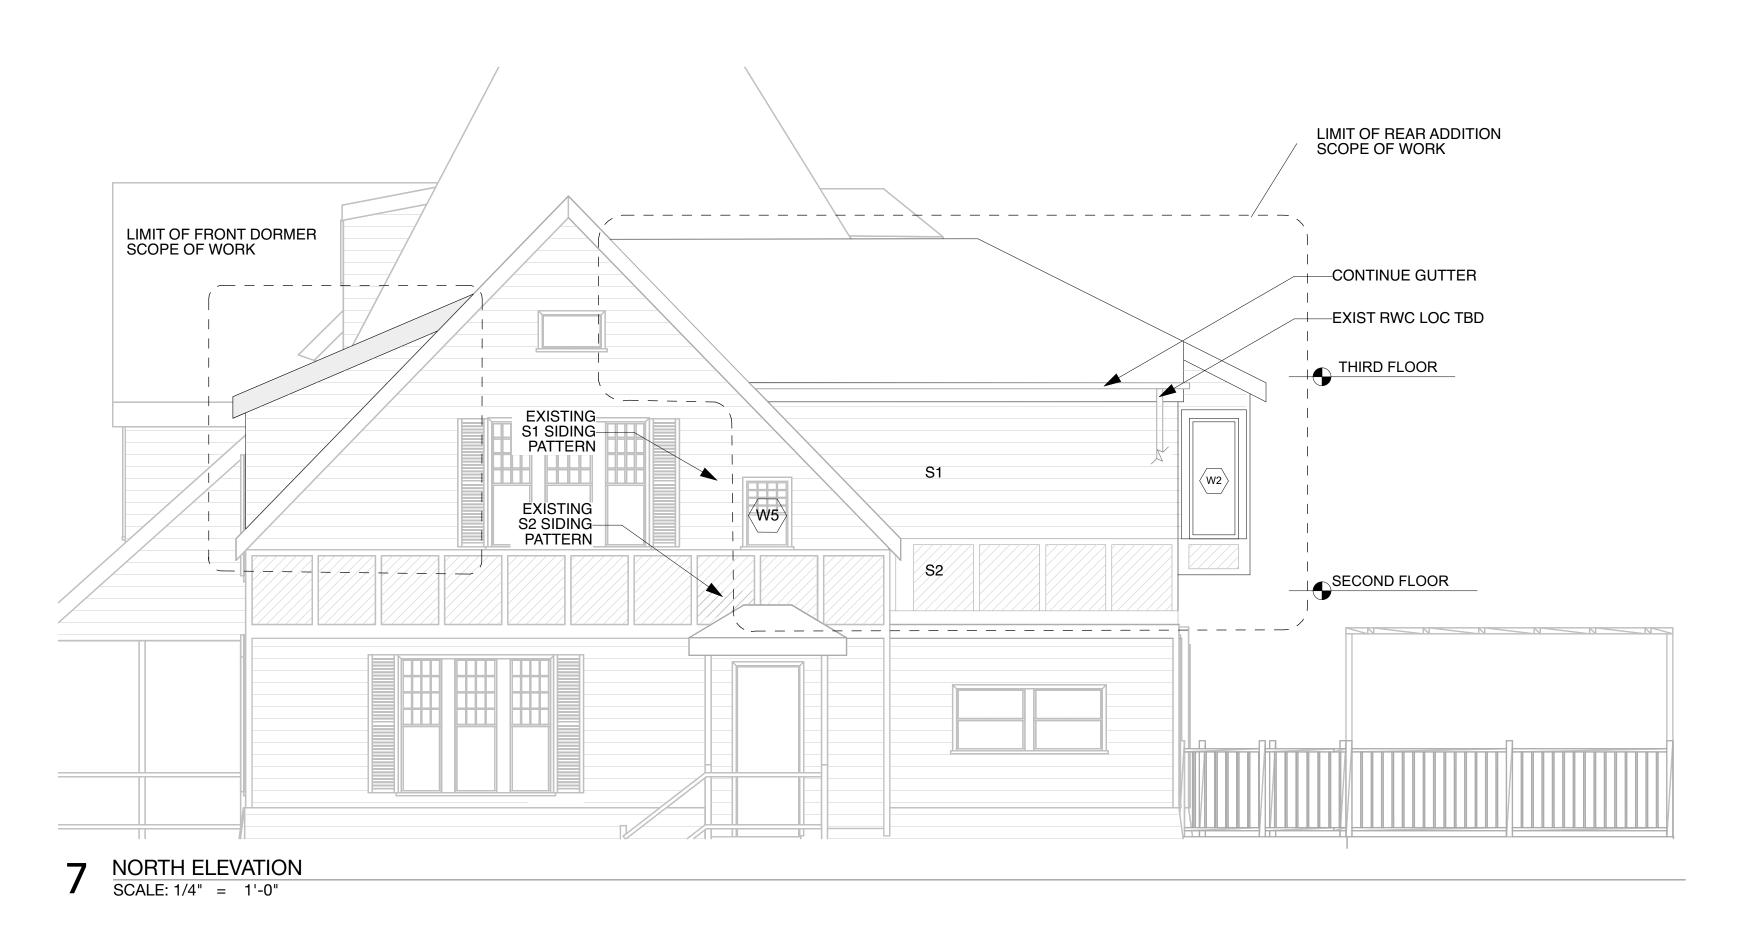

ROOF RAFTER BEYOND CONT. SPF
INSULATION

6 ROOF SOFFIT DTL SCALE: 1 1/2"= 1'-0"

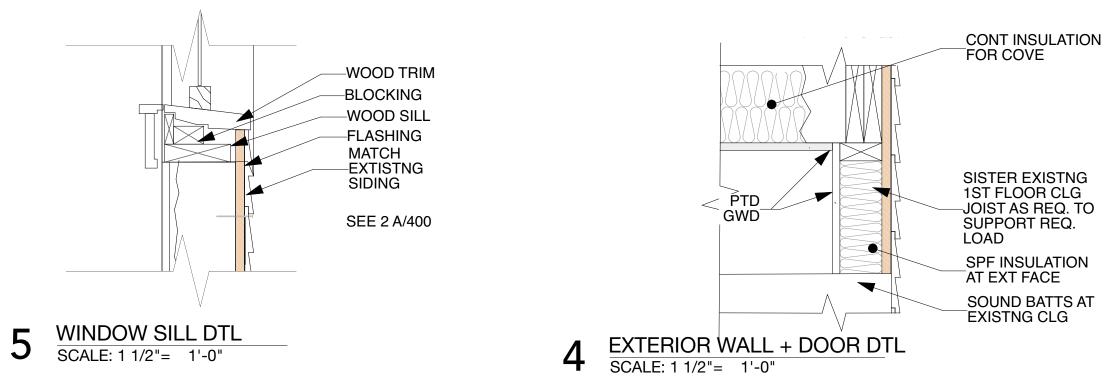

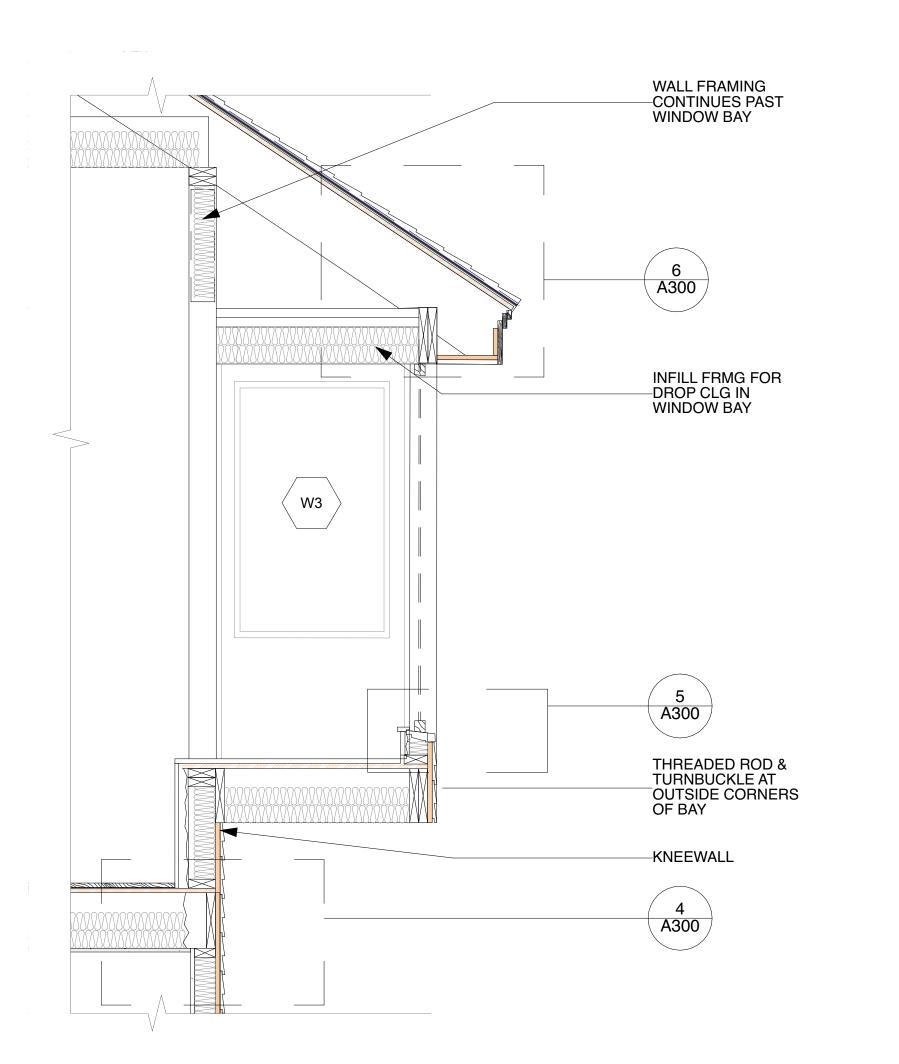

DTL @ WINDOW BOX SCALE: 3/4" = 1'-0"

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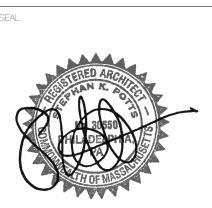
MEP/FP ENGINEERING

N/A

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**ELEVATIONS AND BLDG** SECTIONS

SEE DRAWING



PROJECT NO
1708

DRAWN BY

SM

CHECKED BY

PS/ SP

**A300**