

NOTE:

AFRIAL IMAGERY AND SITE FEATURE/INFORMATION TAKEN FROM TOWN OF NEWTON TAX ASSESSOR DATABASE & GIS.

OVERALL SITE PLAN

Project No.: 7661

Designed By: EMD

Drawn By: EMD Checked By: JJP Date: JULY 2021

Scale: AS SHOWN

SHEET\_1 OF 4

- 25' BUFFER ZONE
- 50' BUFFER ZONE
- 100' BUFFER ZONE
- CITY FLOOD ZONE

GRAPHIC SCALE
30 0 15 30 60 9

(in feet)
1 INCH EQUALS 60 FEET

LEGEND & ABBREVIATIONS

- GAS --- EXISTING GAS LINE


- PROPERTY LINE
- - EASEMENT LINE


- BRUNNEN BROOK PATHWAY
- 7' HIGH MAX. RETAINING WALL
- 4' HIGH MAX. RETAINING WALL


- PROPOSED EROSION CONTROLS/LOD

X 100.00 TOW - TOP OF WALL SPOT ELEVATION

X 100.00 BOW - BOTTOM OF WALL SPOT ELEVATION

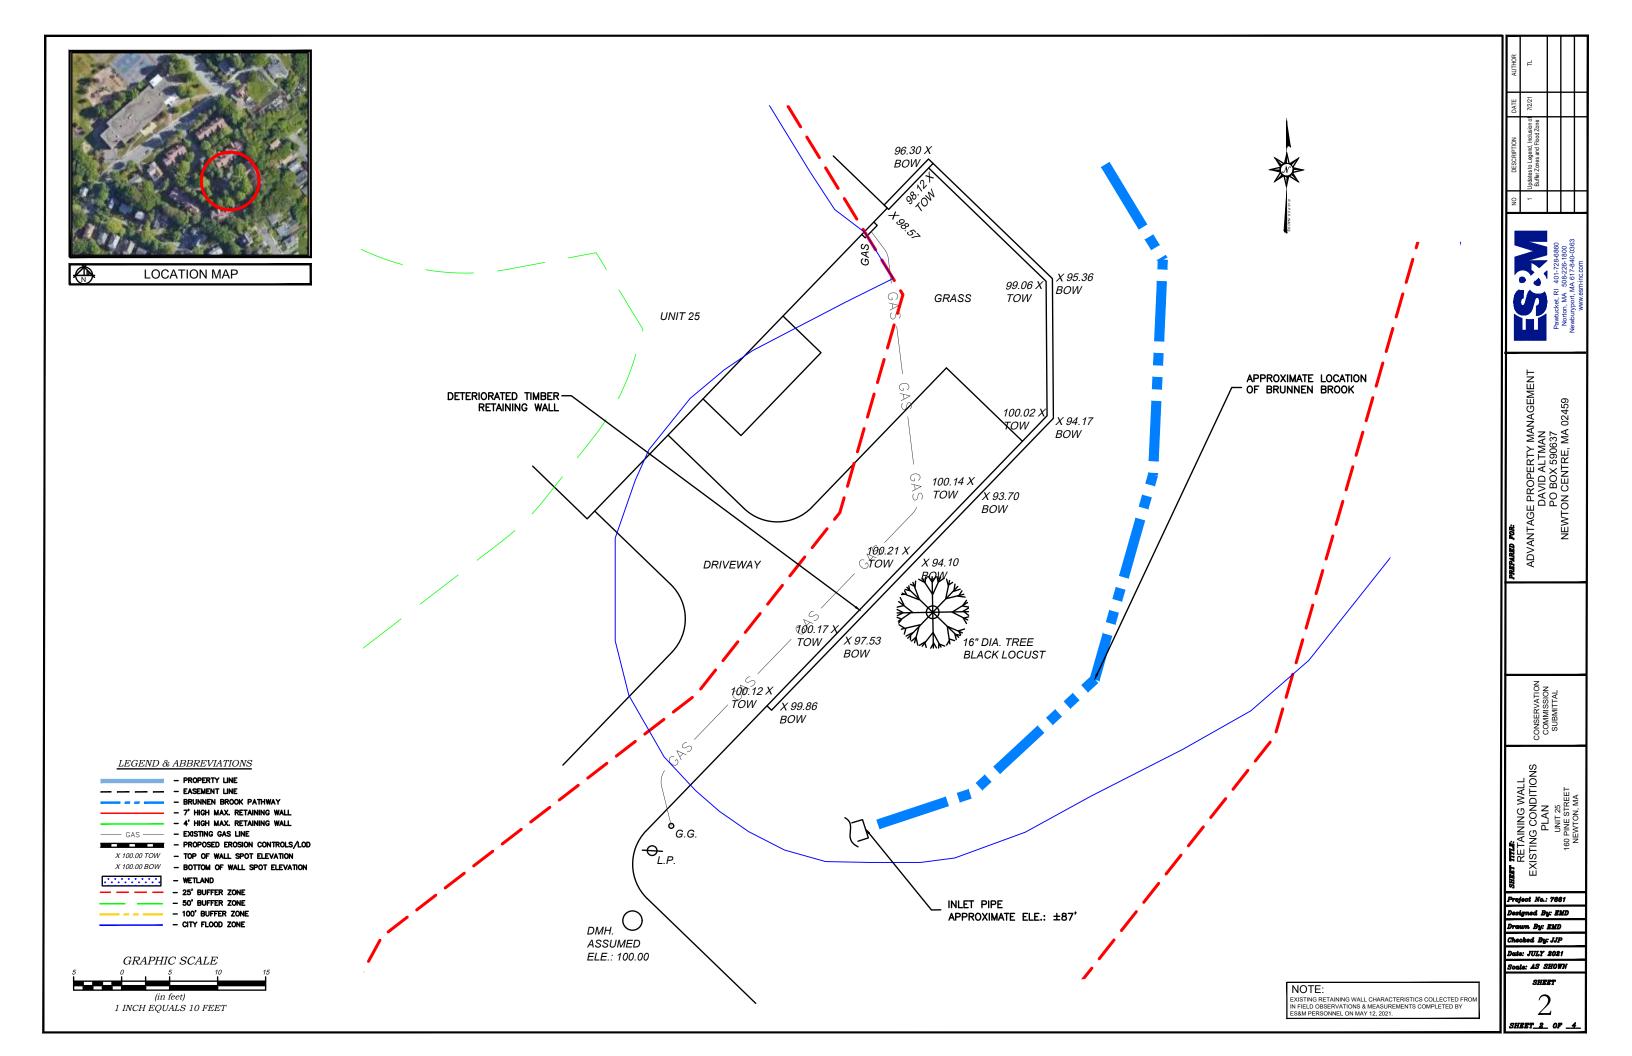

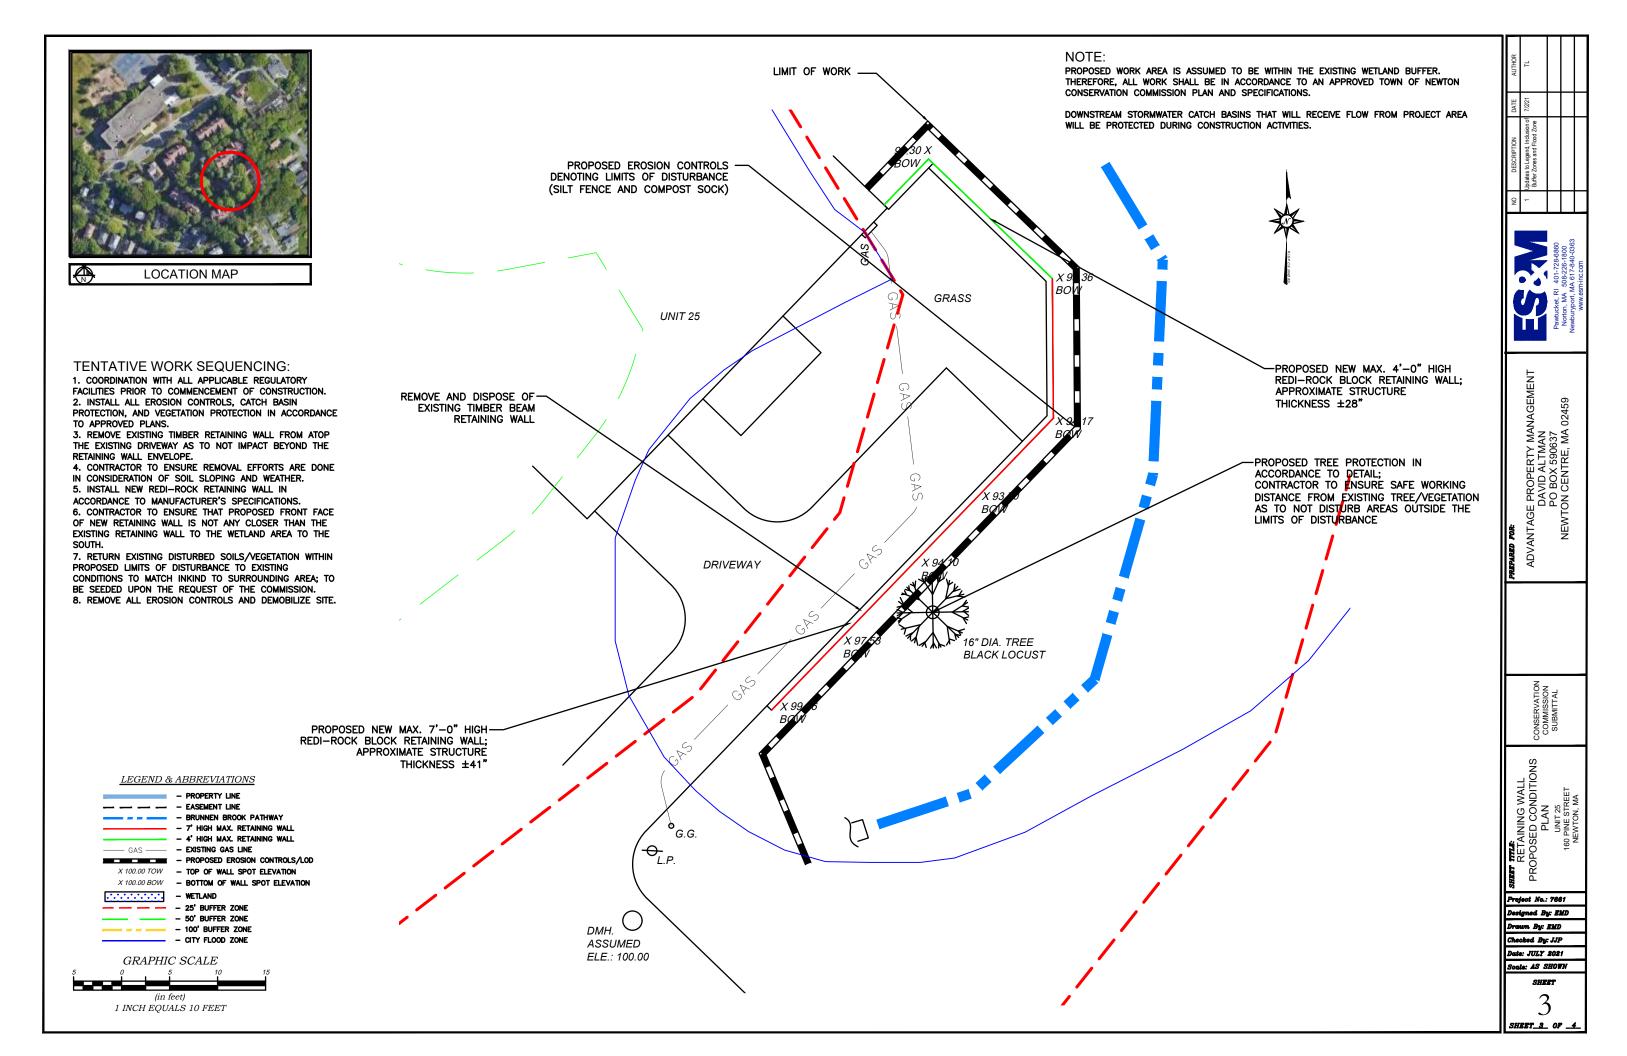

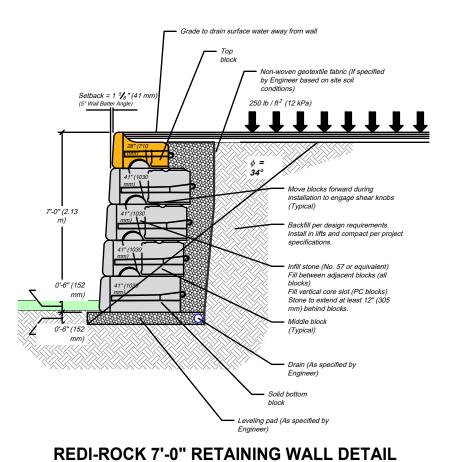

Grout fence or railing post in place

Moment Slab

Connection

Grouted Connection

(2 Blocks)

Flange base plate attached to top block with adhesive

These generic pedestrian guard and fence details show a few potential options for their installation on the top of a Redi-Rock

retaining wall. It is the design engineer's responsibility to fully design and detail the

connection of the guard posts to the retaining

wall blocks and assure acceptable resistance to the applied forces. Redi-Rock blocks are

plain concrete, without steel reinforcement

Fence or railing post Core and grout or connect with flanged base plate

Reinforced concrete sidewalk


Grout fence or railing post in place

Flange Bolted

Connection

**Grouted Connection** 


(1 Block)

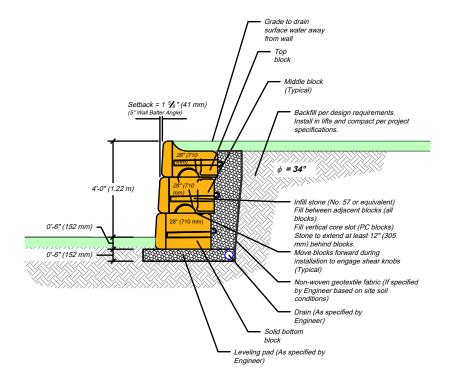


## 1'-0" CLEARANCE AROUND DECIDUOUS TREE-6'-0" STANDARD STEEL POST-2'-0" (MIN.

## **REDI-ROCK 4'-0" RETAINING WALL DETAIL**

SCALE: 1"=4"

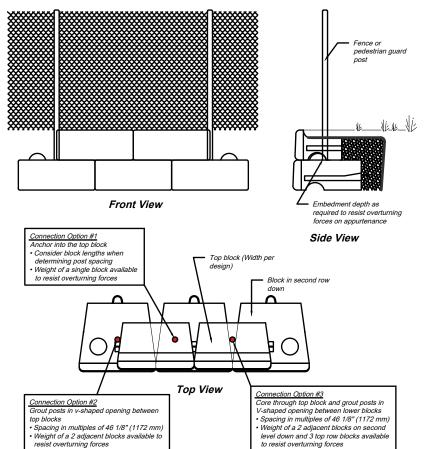

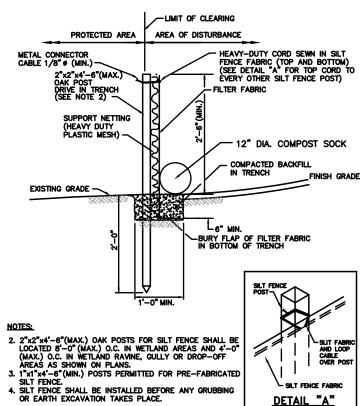

This drawing is for reference only. Determination of the suitability and/or manner of use of any details contained in this document is the sole responsibility of the design engineer of record. Final project designs, including all construction details, shall be prepared by a licensed profesengineer using the actual conditions of the proposed site.

## **REDI-ROCK PEDESTRIAN GUARD DETAIL**

NOT TO SCALE

ADVANTAGE PROPERTY MANAGEMENT DAVID ALTMAN PO BOX 590637 NEWTON CENTRE, MA 02459 DETAILS Project No.: 7661 Designed By: EMD Drawn By: EMD Checked By: JJP Date: JULY 2021 Scale: AS SHOWN

SHEET\_4\_ OF \_4

TREE PROTECTION DETAIL NOT TO SCALE

> **SILT FENCE DETAIL** NOT TO SCALE