

Zoning District: SR-3 Old Lot Status

Note: Existing zoning district information and lot status is based on information obtained from the City of Newton on-line data base and property deeds and plans obtained from Middlesex South District Registry of Deeds. Final zoning district and lot status to be determined by the City of Newton Inspectional Services

Allowed/Required Lot Coverage=30.0% Open Space=50.0%


Existing Lot Coverage=32.40% Open Space=59.11%

Existing Impervious Surface=2940±sf

Average Front Setback Calculation
Parmenter Road (18.4')
Existing Front Setback #154 Parmenter Rd=20.3'
Existing Front Setback #166 PArmenter Rd=16.5'
20.3'+16.5'=36.8'/2=18.4'
Average Front Setback=18.4'

Note: Falmouth Road Front Setback Requirement is 25' There is No Average Front Setback For Falmouth Road

Existing utilities shown are from field locations and available plans of record and may or may not be correct. Field verify all locations prior to any excavation.

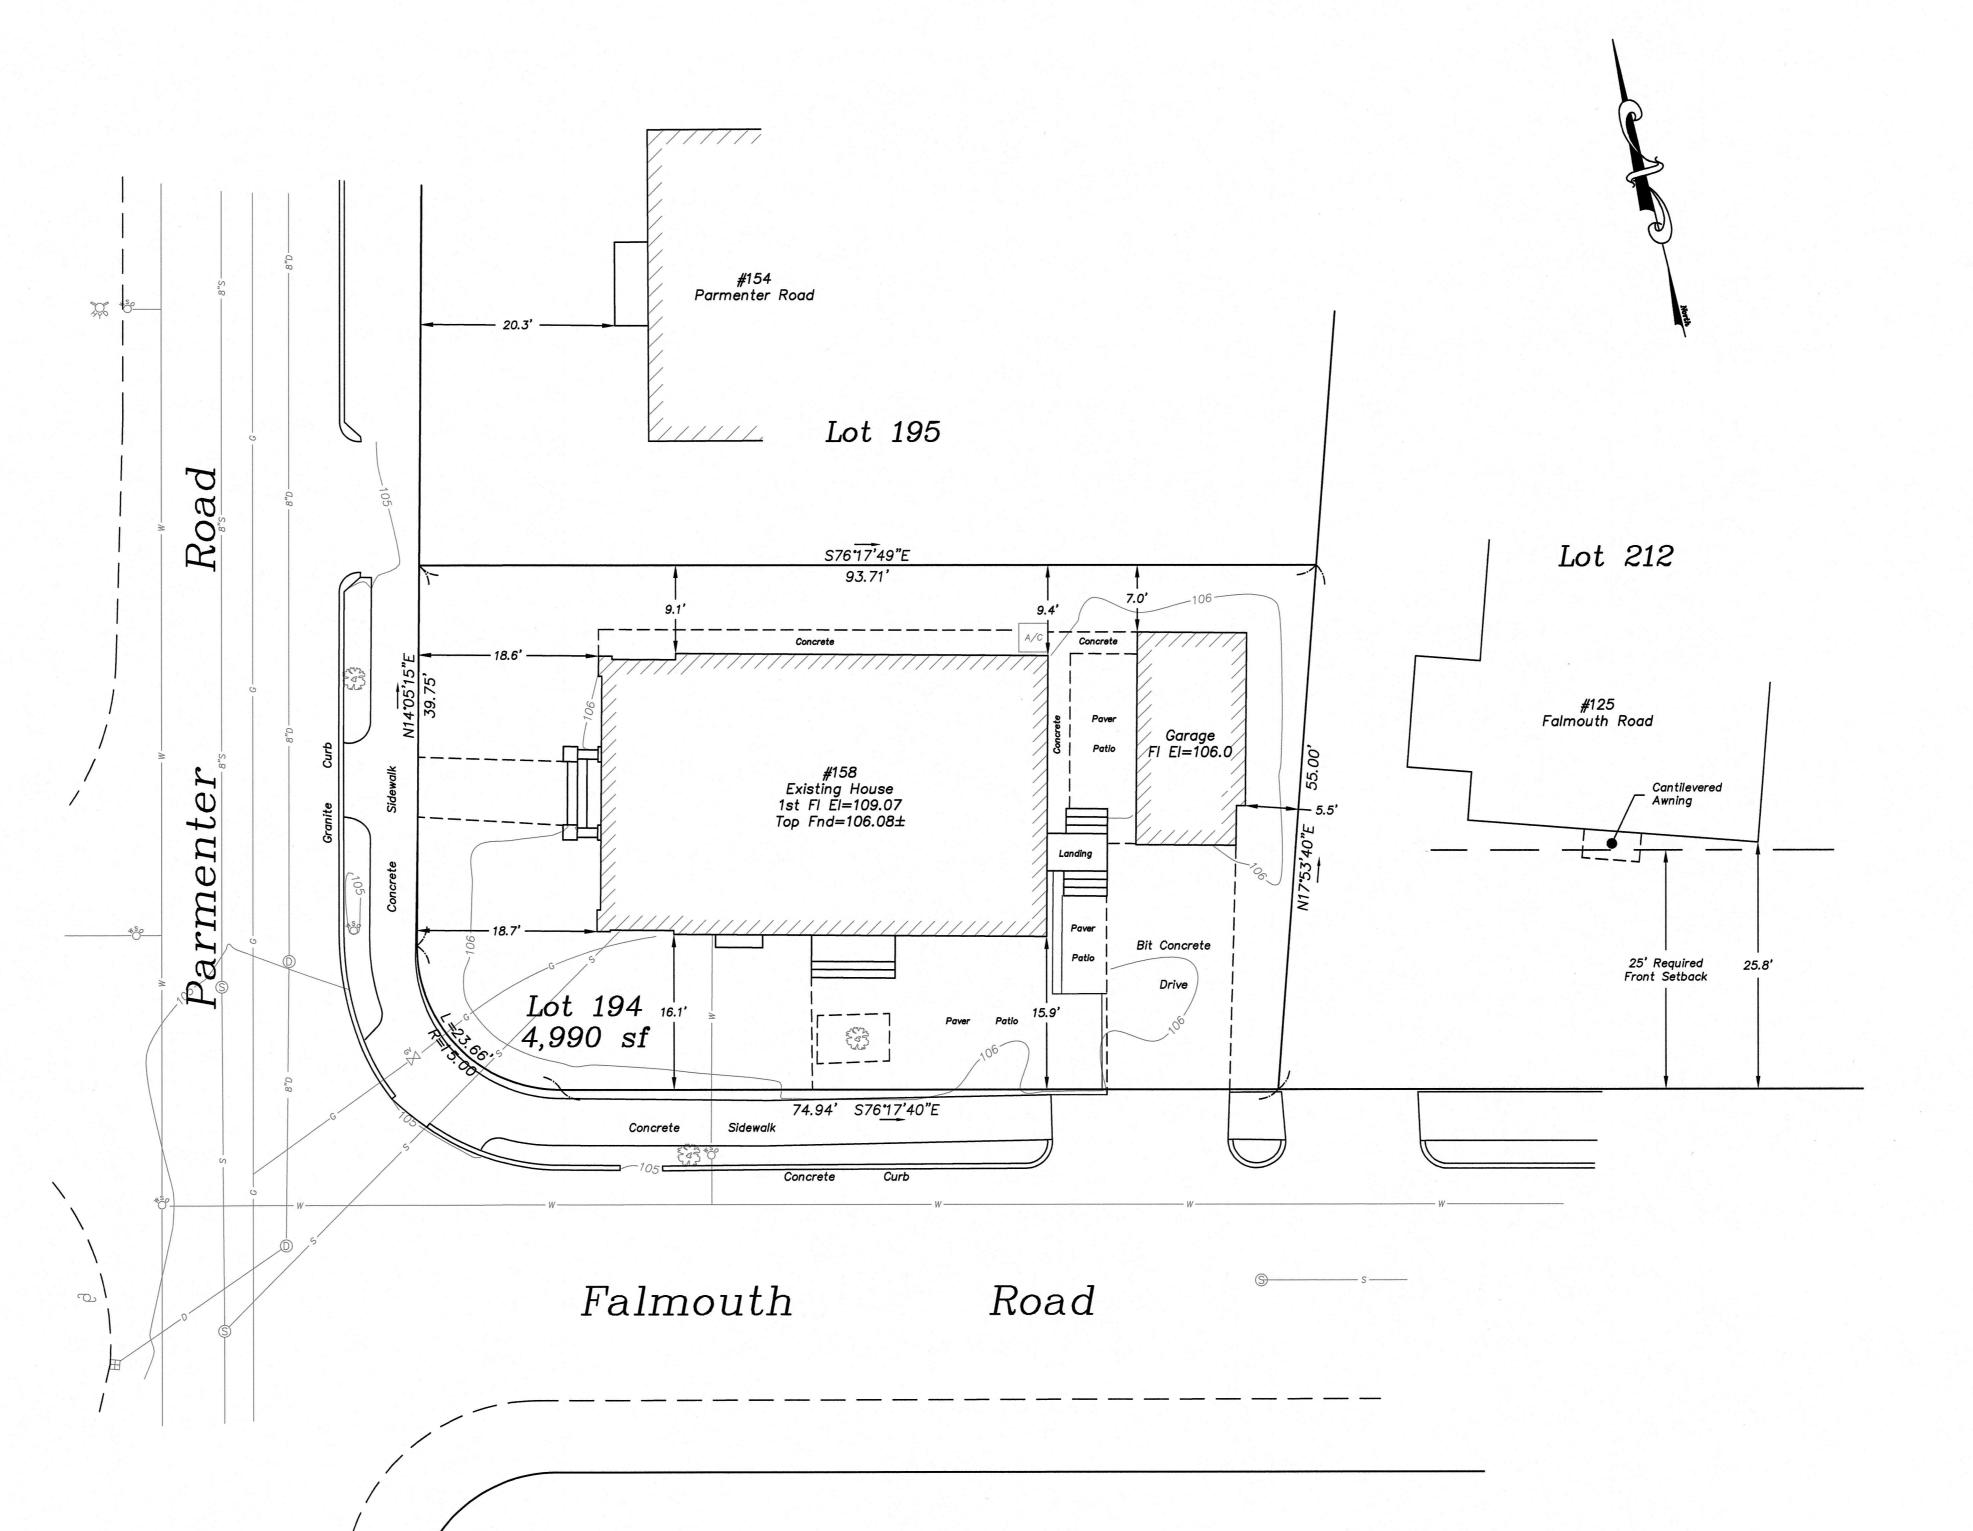

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#166 Parmenter Road

#154 Parmenter Road Dig Safe

Excavators

Before you dig contact the Dig Safe Center.

To prevent damage to telephone, gas or electric underground facilities of member utilities, call toll free

Massachusetts state law requires notilication at least three business days before you start digging operations. In an emergency, call immediately.



notes:

1. The utilities shown are from field locations and available plans of record and may or may not be correct.

Contractor is to contact Dig Safe and all local utility companies as required and field verify all locations prior to any excavation.

2. Upon City of Newton Special Permit/Variance approval the Applicant will need to apply for a separate Building Permit with Inspectional Services and Engineer Division review.

3. In association with the proposed addition, and after City of Newton Engineering Division review, it may be determined that the Applicant install an on—site drainage system that meets City of Newton requirements. If required, the applicant must contact the Engineer of record to schedule soil testing and design.

4. In association with the proposed addition, and after City of Newton Engineering Division review, it may be determined that the Applicant update/replace the existing water and sewer services.

5. The utilities shown are from field locations and available plans of utility companies and may or may not be correct. Contractor is to contact Dig Safe, all local utility companies and field verify all locations as required prior to any excavation.

An erosion control barrier shall be in place prior to any construction and all materials must be contained on site.

7. No excavation is allowed within any City right of way between November 15th and April 15th. If an emergency exists or there are extenuating circumstances, Applicant ma seek permission for such work from the City DPW Commissioner via City Engineer. If permission is granted, special construction standards will be applied. Applicant or Applicant's representative must contact the City Engineering Department prior to start of work for clarification.

8. As of January 1, 2009, all trench excavation contractors shall comply with M.G.L. Chapter 82A, Trench Excavation Safety Requirements, to protect the general public from unauthorized access to unattended trenches. Trench Excavation Permit required. This applies to all trenches on public and private property.

9. Any tree removed from site must comply with City of Newton Tree Ordinance.

 An erosion control barrier shall be in place prior to any construction and all materials must be contained on site.



Section 34 - Block 47 - Lot 1


Existing Condition Plan

Scale: 1"=10'

June 16, 2020

VERNE T. PORTER Jr., PLS
Land Surveyors — Civil Engineers

354 Elliot Street Newton, Massachusetts 02464

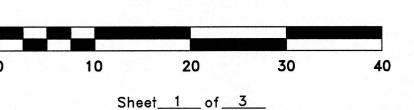

Project: 20004

Checked By: V. Porter Jr.

Drawn By: R. Jardine Jr.



REVISIONS

DATE

2-12-21

DESCRIPTION

PLAN UPDATE

