
CITY OF NEWTON, MA DEPARTMENT OF PUBLIC WORKS TRAFFIC CALMING AT WALTHAM STREET / DERBY STREET / FAIRWAY DRIVE INTERSECTION

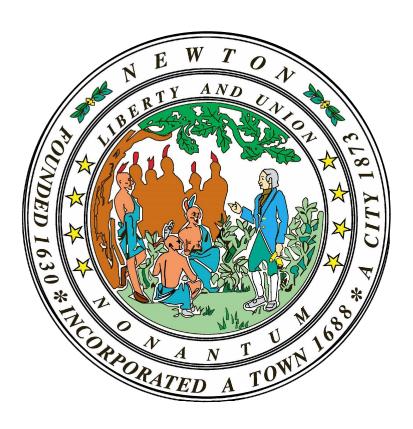

MAYOR

RUTHANE FULLER


CITY COUNCIL

MARC LAREDO, PRESIDENT DAVID KALIS, VICE PRESIDENT R. LISLE BAKER, PRESIDENT EMERITUS DAVID A. OLSON, CLERK OF THE COUNCIL

DEPARTMENT OF PUBLIC WORKS

JAMES MCGONAGLE, COMMISSIONER LOU TAVERNA, CITY ENGINEER JASON SOBEL, DIRECTOR OF TRANSPORTATION

Project-Location

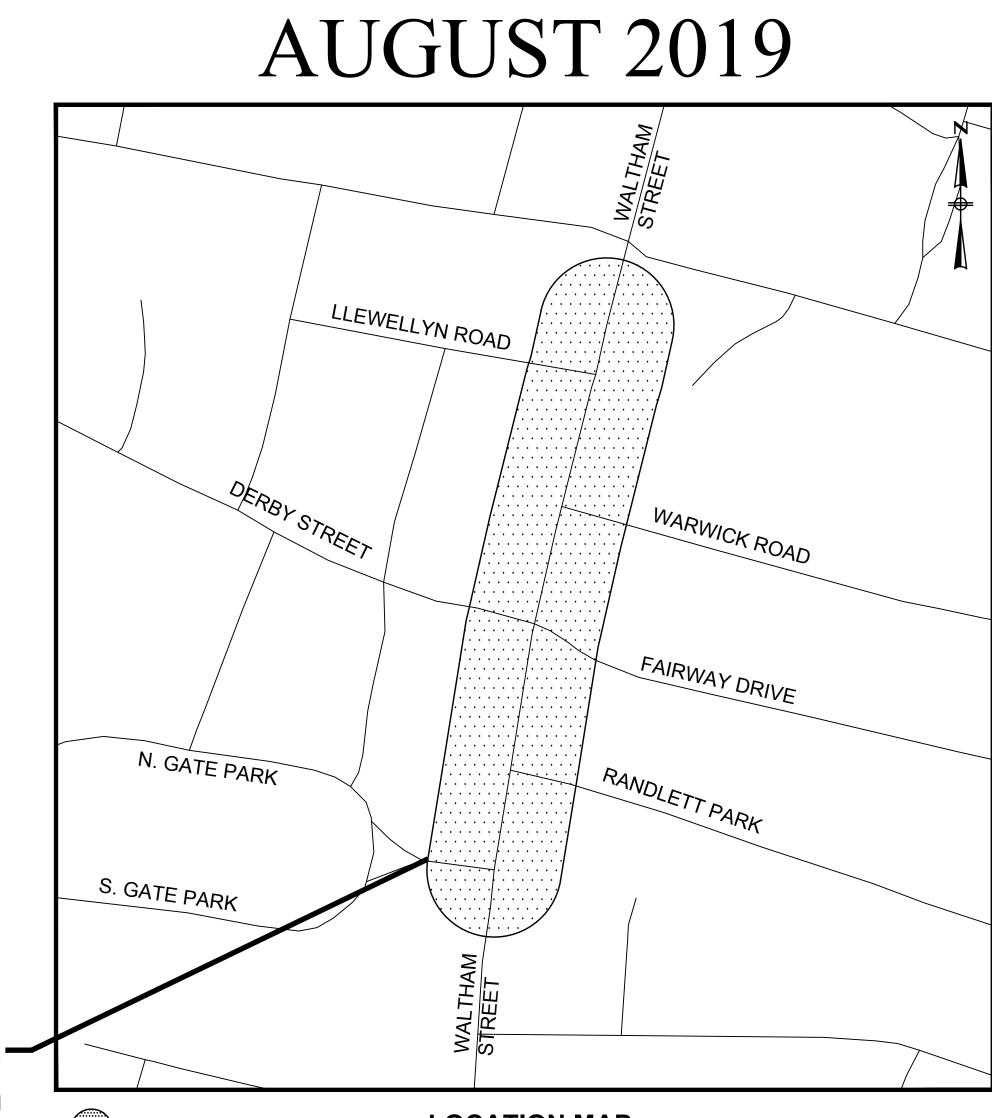

PROJECT LOCATION

LOCATION MAP

PREPARED BY:




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ISSUE DATE: AUGUST 15, 2019

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9/6/19

LEGEND

GENERAL SYMBOLS

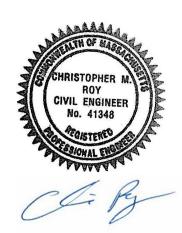EXISTING

PROPOSED

	EXISTING	PROPOSED		
			CURB OR BERM (TYPE AS NOTED) EDGE OF PAVEMENT	
	СВ	œCB	CATCH BASIN (OR GUTTER INLET, LEACHING BASIN, DROP INLET, CATCH BASIN CURB INLET)	
	ОЕНН	ОЕНН	ELECTRIC HANDHOLE (NUMBER AS NOTED)	
	E	O EMH	ELECTRIC MANHOLE	
	$\overline{\mathbb{O}}$	О ТМН	TELEPHONE MANHOLE	
		O WMH	WATER MANHOLE	
	S	S SMH	SEWER MANHOLE	
	D	DMH	DRAINAGE MANHOLE	
	o GG	o GG	GAS GATE	
	∘WG	o WG	WATER GATE	
	° CS	o cs	CURB STOP	
	HYD.	≁ HYD	HYDRANT	
	E FA	' ■ FAB	FIRE ALARM BOX	
	• PM	0	PARKING METER	
	-¢- LP	 ●_^¥	STREET LIGHT POLE	
	UP	- — UP	UTILITY POLE	
	JUPL	-Q- UPL	UTILITY POLE w/ LIGHT	
	L 		SIGN	
	O- GUY	O – GUY	GUY POLE	
	12" RCP		DRAIN PIPE (SIZE AS NOTED)	
	8" VCP		SEWER MAIN (SIZE AS NOTED)	
	F	10'-8" PVC	ELECTRIC DUCT	
	4" HP	10'-4" HP	GAS MAIN (SIZE AS NOTED)	
	8" CI		WATER MAIN (SIZE AS NOTED)	
		10'-8" PVC	TELEPHONE DUCT (SIZE AS NOTED)	
	EOH	<u> </u>	OVERHEAD WIRE	
	□ MB	🗆 мв	MAIL BOX	
			WOOD GUARD RAIL STEEL BEAM GUARD,	
			WOOD OR STEEL POSTS (TYPE AS NOTED)	
			STEEL GUARD RAIL, STEEL POSTS (TYPE NOTED)	
	- 0000000000000000000000000000000000000		STONE WALL	
			RETAINING WALL (TYPE NOTED)	
(MADOI-E.SIB)	BND SHLO (Date of Layout)	BND	HIGHWAY/PROPERTY BOUND (TYPE AS NOTED)	
			STATE HIGHWAY LAYOUT LINE (SHLO)	
	Boundary Name		CITY, TOWN OR COUNTY LAYOUT LINE (R.O.W.)	
- WALIHAM-DEKBY-FAIKWAYIDKAWING FILESIPLANSE I ILEGEND.DWG			CITY, TOWN, COUNTY OR STATE BOUNDARY LINE	
END.	P		PROPERTY LINE	
		2+00	EASEMENT LINE (TYPE NOTED)	
	N00°00'00"E		CONSTRUCTION BASELINE	
			SURVEY LINE	
			RAILROAD OR STREET RAILWAY TRACKS WITH SIDELINES	.S
JKAW	• 24" PINE	\mathbf{O}	TREE (SIZE AND TYPE AS NOTED)	
A Y IL	Current and a second se	<i></i>		
-AIKV	₩F−1 X	x x x	FENCE (SIZE AND TYPE AS NOTED) EDGE OF WETLAND W/ FLAGGED NUMBER	
7- 7- 7-			EDGE OF WETLAND W/ FLAGGED NOMBER	
			100-FT. WETLAND BUFFER LIMIT	
НАМ			100-FT. RIVER FRONT LIMIT	
			200-FT. RIVER FRONT LIMIT	
ת			WOODED AREA / LIMIT OF CLEARING	
UN UN-CALLITASK	× 00.0	× 00.00	SPOT GRADE	
-CAL	× 00.0	x 00.00	SAW CUT LINE	
		TP-1	TEST PIT	
		в-1	BORING	
7 - NE	—— — ——ЕСВ ——	— — — ECB —	EROSION CONTROL BARRIER/COMPOST FILTER TUBES	
0.:054005/03472 - NEW	· · · ·		DRAWN BY: REC	CIC
2010				
			DESIGNED BY:	
			CHECKED BY:	
NUMBER DATE	MADE BY CHECKED BY	REVISIONS	I	

ABBREVIATIONS

GENERAL

ABAN
ADJ
ALT
APPROX
Æ
BB
BC
BD OR BND
BLDG
BO
BOS
BOW
BSW
СС
CEM
CLF
CONC
CONST
CONT
DWY
EP, EOP
EL
ELECT
ESMT
EXIST
FDN
GRAN
GC
HOR
IP
JCT
LP
MB
MHB
OC
PCC
PC
PRC
PI
PT
PVC
PVI
PVT
PERM
PGL
PROP
PVC
PVMT
R
R&D
R&R
R&S
REM
REMOD
RET
RR
RT
SB
SW
SHT
SHLD
STA
TEMP
TOS
TOS
TYP
115
VAR
VAR VERT VGC

ABANDON ADJUST ALTERATION APPROXIMATE BASELINE **BITUMINOUS BERM BITUMINOUS CURB** BOUND BUILDING **BY OTHERS** BOTTOM OF SLOPE BOTTOM OF WALL BACK OF SIDEWALK CONCRETE CURB CEMENT CHAIN LINK FENCE CONCRETE CONSTRUCTION CONTINUOUS DRIVEWAY EDGE OF PAVEMENT ELEVATION ELECTRICAL EASEMENT EXISTING FOUNDATION GRANITE GRANITE CURB HORIZONTAL **IRON PIPE** JUNCTION LOW POINT MAIL BOX MASSACHUSETTS HIGHWAY BOUND ON CENTER POINT OF COMPOUND CURVATURE POINT OF CURVATURE POINT OF REVERSE CURVATURE POINT OF INTERSECTION POINT OF TANGENCY POINT OF VERTICAL CURVATURE POINT OF VERTICAL INTERSECTION POINT OF VERTICAL TANGENCY PERMANENT PROFILE GRADE LINE PROPOSED POINT OF VERTICAL CURVATURE PAVEMENT RADIUS OF CURVATURE REMOVE AND DISCARD REMOVE AND RESET REMOVE AND STACK REMOVE REMODEL RETAIN RAILROAD RIGHT SOUTH BOUND OR STONE BOUND SIDEWALK SHEET SHOULDER STATION TEMPORARY TOP OF SLOPE

TOP OF WALL

VERTICAL GRANITE CURB

WHEELCHAIR RAMP

TYPICAL VARIABLE VERTICAL

WCR

	IRAFFIC SIGN
R	STEADY CIRCULAR RED
Y	STEADY CIRCULAR AMBER
G	STEADY CIRCULAR GREEN
FR	FLASHING CIRCULAR RED
FY	FLASHING CIRCULAR AMBER
←FY	FLASHING YELLOW LEFT ARROW
R→	STEADY RED RIGHT ARROW
Y→	STEADY AMBER RIGHT ARROW
r⇒ G→	STEADY GREEN RIGHT ARROW
G <i>⇒</i> ←R	STEADY RED LEFT ARROW
←κ ←Y	
	STEADY AMBER LEFT ARROW
⊢G	STEADY GREEN LEFT ARROW
W	STEADY WALK (PERSON WALKING
DW	STEADY DON'T WALK (HAND) - PO
FDW	FLASHING DON'T WALK (FLASHING
	UTILITIES
ACCMP	ASPHALT COATED CORRUGATED
CAP	CORRUGATED ALUMINUM PIPE
СВ	CATCH BASIN
CBCI	CATCH BASIN WITH CURB INLET
CI	CURB INLET
CIP	CAST IRON PIPE
CIT	CHANGE IN TYPE
СМР	CORRUGATED METAL PIPE
С	CONDUIT
CPP	CORRUGATED PLASTIC PIPE
CSP	CORRUGATED STEEL PIPE
DI	DROP INLET
DIP	DUCTILE IRON PIPE
F&C	FRAME AND COVER
F&G	FRAME AND GRATE
FM	FORCE MAIN
GI	GUTTER INLET
GIP	GALVANIZED IRON PIPE
GG	GAS GATE
HDW	HEADWALL
HYD	HYDRANT
INV	INVERT ELEVATION
LP	LIGHT POLE
MH	MANHOLE
PVC	POLY-VINYL-CHLORIDE PIPE
PWW	
RCP	REINFORCED CONCRETE PIPE (CL
SD	SUBDRAIN
SMH	SEWER MANHOLE
TS	TRAFFIC SIGNAL
TSV&B	TAPPING SLEEVE, VALVE AND BO
UP	UTILITY POLE
UPL	UTILITY POLE w/ LIGHT
UPT	UTILITY POLE w/ TRANSFORMER
VCP	VITRIFIED CLAY PIPE
WIP	WROUGHT IRON PIPE
WG	WATER GATE

WATER METER/WATER MAIN

WM

TRAFFIC SIGNAL SYSTEMS

	STEADY CIRCULAR RED
	STEADY CIRCULAR AMBER
	STEADY CIRCULAR GREEN
	FLASHING CIRCULAR RED
	FLASHING CIRCULAR AMBER
	FLASHING YELLOW LEFT ARROW
	STEADY RED RIGHT ARROW
	STEADY AMBER RIGHT ARROW
	STEADY GREEN RIGHT ARROW
	STEADY RED LEFT ARROW
	STEADY AMBER LEFT ARROW
	STEADY GREEN LEFT ARROW
	STEADY WALK (PERSON WALKING) - LUNAR WHITE
	STEADY DON'T WALK (HAND) - PORTLAND ORANGE
	FLASHING DON'T WALK (FLASHING HAND) - PORTLAND ORANGE
	UTILITIES
	ASPHALT COATED CORRUGATED METAL PIPE
	CORRUGATED ALUMINUM PIPE
	CATCH BASIN
	CATCH BASIN WITH CURB INLET
	CURB INLET
	CAST IRON PIPE
	CHANGE IN TYPE
(CORRUGATED METAL PIPE
(CONDUIT
(CORRUGATED PLASTIC PIPE
(CORRUGATED STEEL PIPE
I	DROP INLET
I	DUCTILE IRON PIPE
I	FRAME AND COVER
I	FRAME AND GRATE
I	FORCE MAIN
	GUTTER INLET
	GALVANIZED IRON PIPE
	GAS GATE
I	HEADWALL
I	HYDRANT
I	NVERT ELEVATION
I	LIGHT POLE
I	MANHOLE

REINFORCED CONCRETE PIPE (CLASS III UNLESS NOTED)

SCALE ISTERED PROFESSIONAL PREPARED BY TITLE SUBCONSULTANT NONE www.BETA-Inc.com

TRAFFIC SIGNAL SYMBOLS

EXISTING	PROPOSE	D
		CONTROL CABINET GROUND MOUNTED WITH FOUNDATION
	H	CONTROL CABINET POLE MOUNTED
	Ø2	CONTROLLER PHASE
	• MA-1	MAST ARM, SHAFT & BASE (ARM LENGTH AS NOTED)
\rightarrow		VEHICULAR SIGNAL HEAD (ALPHA-NUMERIC DESIGNATION AS NOTED)
\longrightarrow		VEHICULAR SIGNAL HEAD, OPTICALLY PROGRAMMED
		VEHICULAR SIGNAL HEAD (REMOVED & RESET)
\rightarrow	->	FLASHING BEACON
		PEDESTRIAN SIGNAL HEAD
	— ₽	PEDESTRIAN SIGNAL HEAD, OPTICALLY PROGRAMMED
		PULL BOX 12"x12" OR HANDHOLE
		LOOP DETECTOR
\oplus	<u>•</u>	PEDESTRIAN PUSH BUTTON, SIGN (DIRECTIONAL ARROW AS SHOWN) AND SADDLE
	-	PRE-EMPTION DETECTOR
	-3	PRE-EMPTION CONFIRMATION STROBE
	====================================	SIGNAL CONDUIT (SINGLE RUN)
	==========	SIGNAL CONDUIT (DOUBLE RUN)
	•	SIGNAL POST & BASE
	M	MAGNETIC DETECTOR
		SCHOOL ZONE SPEED LIMIT SIGN
	 ∍))	MICROWAVE OR ULTRASONIC DETECTOR
		VIDEO DETECTION CAMERA
	******************	VIDEO DETECTION ZONE

PAVEMENT MARKINGS AND SIGNING SYMBOLS

PROPOSED

CW	CROSSWALK, 2 - 12" WHITE LINES (8" WIDTH)
SL	STOP LINE - 12" WHITE LINE 4' BEHIND CW (TYP.)
SWL	SOLID WHITE LINE - 4"
SWCHL	SOLID WHITE CHANNELIZING LINES - 12" (SPACING NOTED)
SWGL	SOLID WHITE GORE LINE 12" @ 33°, (SPACING NOTED)
SWPL	SOLID WHITE PARKING LINE - 4"
BWL	BROKEN WHITE LINE - 4"
DWLEx	DOTTED WHITE LANE EXTENSION LINE - 4" (2' LINE & 6' GAP)
DYLEx	DOTTED YELLOW LANE EXTENSION LINE - 4" (2' LINE & 6' GAP)
BYL	BROKEN YELLOW LINE - 4"
DBYL	DOUBLE YELLOW LINE - 2 - 4" LINES
SYL	SOLID YELLOW LINE - 4"
SYGL	SOLID YELLOW GORE LINE 12" @ 33°, (SPACING NOTED)
SCHOOL	SCHOOL ZONE - WHITE
Ë.	HANDICAP SYMBOL - WHITE
1	PAVEMENT ARROW - WHITE
ONLY	LEGEND "ONLY" - WHITE

Traffic Calming at Intersection of Waltham Street / Derby Street / Fairway Drive

LEGEND & ABBREVIATIONS

Newton, MA

BETA JOB NO.

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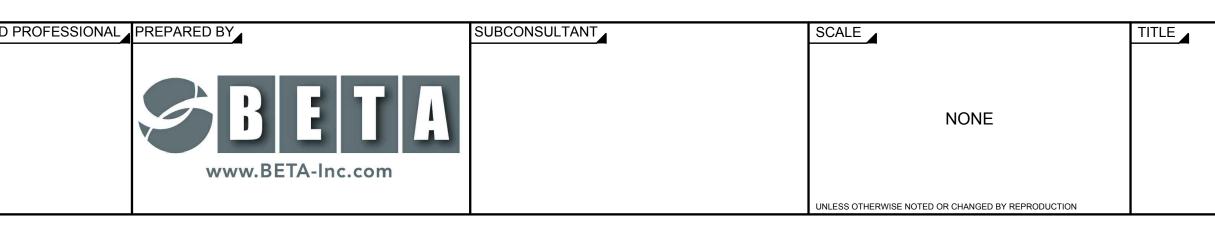
SHEET NO.

	<u>GENERAL NOTES</u>		
1.	THE LOCATION OF SUBSURFACE UTILITIES SHOWN IS APPROXIMATE AND NOT G ACCURATE. THE CONTRACTOR SHALL VERIFY THE LOCATIONS AND ELEVATIONS STRUCTURES PRIOR TO COMMENCEMENT OF WORK. THE CONTRACTOR MUST N TO ANY EXCAVATION, DEMOLITION OR EXPLOSIVE WORK IN PUBLIC OR PRIVATE RIGHT-OF-WAY OR EASEMENT.	S OF EXISTING UTILI NOTIFY DIG SAFE 72	TY LINES AN HOURS PRIC
2.	DRAINAGE ELEVATIONS ARE PROVIDED FOR DESIGN PURPOSES ONLY. THE CON PIT, THE LOCATIONS OF EXISTING UTILITIES WHICH MAY CONFLICT WITH THE PR FIELD ADJUSTMENTS REQUIRED WILL BE MADE AS APPROVED OR DIRECTED BY CONTRACTOR VERIFIES ELEVATIONS FOR THE CONSTRUCTABILITY OF THE DRA STRUCTURES BE ORDERED.	OPOSED DRAINAGE THE ENGINEER. ON	DESIGN. AI
3.	WHERE AN EXISTING UTILITY IS FOUND TO CONFLICT WITH THE PROPOSED WOR SIZE OF THE UTILITY SHALL BE ACCURATELY DETERMINED WITHOUT DELAY BY INFORMATION FURNISHED TO THE ENGINEER FOR THE RESOLUTION OF THE CO	THE CONTRACTOR,	
4.	THE CONTRACTOR SHALL MAINTAIN ACCESS TO ABUTTING PROPERTIES AT ALL IN ADVANCE OF ANY INTERRUPTIONS TO ACCESS.	TIMES AND NOTIFY	ALL ABUTTE
5.	THE CONTRACTOR SHALL ALTER THE MASONRY OF THE TOP SECTION OF ALL EX STRUCTURES AS NECESSARY FOR THE CHANGES IN GRADE, AND RESET ALL WA GRATES AND BOXES TO THE PROPOSED FINISH SURFACE GRADE. REQUIRED NE BRICK CONFORMING TO M4.05.2.	ATER AND DRAINAGI	E FRAMES,
6.	THE CONTRACTOR SHALL MAKE ALL ARRANGEMENTS FOR THE ALTERATION AND TELEPHONE, CABLE TV, FIRE ALARM AND ANY OTHER PRIVATE UTILITIES BY THE CASTING SHALL BE ADJUSTED TO FINISH GRADE BY THEIR RESPECTIVE OWNER	UTILITY COMPANIE	
7.	AREAS OUTSIDE THE LIMITS OF PROPOSED WORK DISTURBED BY THE CONTRAC RESTORED BY THE CONTRACTOR TO THEIR ORIGINAL CONDITION AT THE CONT		
8.	THE TERM "PROPOSED" (PROP.) MEANS WORK TO BE CONSTRUCTED USING NEW APPLICABLE, RE-USING EXISTING MATERIALS IDENTIFIED AS "REMOVE AND RES		HERE
9.	DRAINAGE STRUCTURES SHALL BE RETAINED UNLESS NOTED OTHERWISE.		
10.	CATCH BASIN AND MANHOLE FRAMES AND GRATES/COVERS SHALL CLEARLY AL PRECAST STRUCTURES AND THE GRADE OF THE ROADWAY.	IGN WITH THE OPEN	NINGS IN THE
11.	WHERE DRAINAGE PIPES OR STRUCTURES ARE ABANDONED IN PLACE THE CON ALL CONNECTING PIPES, DOWN SPOUT FROM BUILDING, INLETS AND OUTLETS A CONNECTIONS SHALL BE CONNECTED TO THE NEW SYSTEM.		
12.	ALL CURB TIE DIMENSIONS ARE TO THE FACE OF THE CURB (GUTTER LINE) OR E	EDGE OF TRAVEL WA	AY.
13.	CONSTRUCTION BASELINE TIES ARE SHOWN ON CURB TIE & GRADING PLANS.		
14.	PROPOSED SIDEWALKS AND WHEELCHAIR RAMPS SHALL BE CONSTRUCTED TO		RE LINE OR
15.	EXPANSION JOINT IN THE EXISTING ADJACENT WALK SURFACE AS DIRECTED BY IN ALL LOCATIONS WHERE PROPOSED SIDEWALK TRANSITIONS DOWN TO MEET	-	XISTING
16.	SIDEWALK OR PAVED AREA, SLOPE SHALL NOT EXCEED 1:12. CONTRACTOR SHALL VERIFY LOCATION OF ALL OBJECTS (SIGNS, TREES, GRATE SIDEWALK PRIOR TO FINAL PLACEMENT TO PROVIDE A MINIMUM CLEAR PATH OI		
	CONTRACTOR SHALL NOTIFY THE ENGINEER OF ANY LOCATION WHICH CANNOT REQUIREMENTS.		
17.	SIGNS, POLES AND OTHER FEATURES LOCATED IN PROPOSED CEMENT CONCRE AND PROVIDED FLEXIBLE JOINT FILLER.	ETE SIDEWALK SHAL	L BE BOXED
18.	CONTRACTOR SHALL VERIFY EXISTING GRADES. IF ANY ADJUSTMENT IS REQUIR GRADES FOUND IN THE FIELD, THE CONTRACTOR SHALL NOTIFY AND SEEK THE PRIOR TO PERFORMING THE WORK.		
19.	IN AREAS OF NEW SIDEWALK, NEW EDGE OF PAVEMENT OR CURB WITHOUT SIDE TO EXISTING GRASS AREAS, EVEN WHEN NO SLOPE-MATCHING OR GRADING IS GRADE IS MET, LOAM BORROW AND SEED SHALL BE PROVIDED AS NECESSARY DAMAGE TO THE GRADE CAUSED BY THE CONSTRUCTION PROCESS.	NECESSARY AND TH	HE EXISTING
20.	IN FILL AREAS, TOP SOIL SHALL BE REMOVED FOR A DEPTH OF 12" (MIN.) OR AS I SUBGRADE AREAS WILL BE COMPACTED PRIOR TO THE PLACEMENT OF FILL MA		NGINEER.
21.	ALL NEW GRANITE CURB SHALL BE MASSDOT TYPE VA4, UNLESS OTHERWISE NO	OTED ON THE PLANS	6.
22.	ALL EXISTING GRANITE CURB CONFLICTING WITH PROPOSED CONSTRUCTION S DISCARDED BY THE CONTRACTOR UNLESS OTHERWISE DIRECTED BY THE ENGI		AND
23.	ALL PROPOSED PAVEMENT MARKINGS ON ROADWAYS SHALL BE REFLECTORIZE THERMOPLASTIC.	ED WHITE AND YELL	WC
24.	SAFETY CONTROLS FOR CONSTRUCTION OPERATIONS SHALL BE IN ACCORDANCE AND THE LATEST VERSION OF THE MUTCD.	CE WITH MASSDOT I	REQUIREME
25.	TREES TO BE RETAINED WHICH RESTRICT SIGHT DISTANCE OR RESTRICT HORIZ SHALL BE TRIMMED AS REQUIRED BY THE ENGINEER AT NO ADDITIONAL COST.	ZONTAL OR VERTICA	AL CLEARAN
26.	NO TREE SHALL BE REMOVED PRIOR TO APPROVAL OF THE CITY OF NEWTON.		
27.	WHEN WORKING NEXT TO EXISTING WALLS, BERMS, AND OTHER STRUCTURES, EXTREME CAUTION NOT TO DISTURB THE EXISTING STRUCTURES. ANY DAMAGE		
		DRAWN BY:	REGISTERED
		DESIGNED BY:	
		CHECKED BY:	

REVISIONS

NUMBER DATE MADE BY CHECKED BY

ETE OR S AND S PRIOR NY			BY THE CONTRACTOR AT HIS OWN EXPENSE. IF ALTERATION TO EXISTING WALLS, BERMS AND S BECOMES NECESSARY DUE TO THE PROPOSED DESIGN, THE CONTRACTOR SHOULD SEEK HE ENGINEER.		
	28.	ALL PAVEMENT MAR	KINGS AND/OR SIGN NOTES ARE SHOWN ON THE SIGNS AND PAVEMENT MARKING PLANS.		
BY TEST N. ANY ER THE	29.	 THE EXPOSED EDGES OF ALL LONGITUDINAL AND TRANSVERSE SAW CUT JOINTS SHALL BE TREATED WITH HO POURED RUBBERIZED ASPHALT JOINT SEALANT MEETING MASSDOT SPECIFICATIONS. 			
		WHEELCHAIF	R RAMP NOTES		
ION AND E	1.	-	MPS SHALL CONFORM TO THE REQUIREMENTS OF THE ARCHITECTURAL ACCESS BOARD ERICANS WITH DISABILITIES ACT (A.D.A.). AND THE LATEST MASSDOT STANDARDS.		
UTTERS	2.		ROPOSED WHEELCHAIR RAMPS ARE SHOWN ON CONSTRUCTION PLANS AND THE WHEELCHAIR CT LOCATIONS MAY BE ADJUSTED, IF NECESSARY, BY THE ENGINEER IN THE FIELD.		
NITARY ES, AY	3.	WITH MASSDOT CON	ELCHAIR RAMPS SHALL HAVE DETECTABLE WARNING PANELS INSTALLED IN ACCORDANCE STRUCTION STANDARD DRAWINGS (E 107.65). THE COLOR OF THE PANEL SHALL BE THE CITY ROVED BY THE ENGINEER.		
ECTRIC, JTILITY	4.	BE REMOVED OR READJUSTED SUCH TH	E AN EXISTING MANHOLE, HANDHOLE OR OTHER "SURFACE" TYPE STRUCTURE THAT CANNOT SET, IS WITHIN THE ACTUAL WHEELCHAIR RAMP PATH, THE STRUCTURE SHALL BE CAREFULLY AT THE TOPMOST SURFACES OF THE STRUCTURE COVER SHALL BE FLUSH WITH THE RAMP MATCH THE SLOPE OF THE NEW WHEELCHAIR RAMP AS DIRECTED BY THE ENGINEER.		
_ BE	5.	EXCEED 7.5%, +/-0.5% 8.33%. PROPOSED W	OPE OF ANY CURB RAMP, EXCEPT MAXIMUM LENGTH HIGH SIDE TRANSITIONS, SHALL NOT 6 FOR TOLERANCE OF CONSTRUCTION. PER AAB 521 CMR, FINISHED SLOPE MAY NOT EXCEED /HEELCHAIR RAMP SLOPES, ESPECIALLY HIGH SIDE TRANSITIONS, SHALL BE VERIFIED BY THE R TO POURING OF CONCRETE AND ADJUSTED, IF NECESSARY, AT THE DIRECTION OF THE		
		SURVEY NOT	ES		
	1.		UTILITIES AS SHOWN WERE COMPILED UTILIZING SURVEY INFORMATION AND AVAILABLE ON PROVIDED BY LIGHTHOUSE LAND SURVEYING ON THE PLAN OF TOPOGRAPHIC SURVEY OF /XX/XXXX		
RE THAT	2.	ACCURACY AND CO DETERMINE EXACT L WORK. AT LEAST 72 (888)344-7233. ALL C	OUTILITIES, AS SHOWN ON THE PLANS, HAVE BEEN COMPLIED FROM RECORD PLANS, THE MPLETENESS ARE NOT GUARANTEED. IT SHALL BE THE CONTRACTOR'S RESPONSIBILITY TO OCATION, SIZE, TYPE, ETC. OF ALL UNDERGROUND UTILITIES THAT MAY BE AFFECTED BY THE HOURS BEFORE DIGGING BEGINS THE CONTRACTOR IS REQUIRED TO CALL DIG SAFE AT TY OWNED UTILITY STRUCTURES WITHIN AREAS AFFECTED BY THE WORK SHALL BE ADJUSTED RADE AS DIRECTED BY THE ENGINEER. ANY UTILITY POLES AND/OR GUY POLES WITHIN AREAS		
OR		AFFECTED BY THE V	VORK SHALL BE REMOVED AND RESET BY THE RESPECTIVE UTILITY COMPANY. ALTERATIONS TO ED BY THE CITY SHALL BE MADE BY THE RESPECTIVE UTILITY OWNERS.		
G	3.	THE CONTRACTOR S	HALL FIELD VERIFY CONDITIONS AND DIMENSIONS PRIOR TO CONSTRUCTION.		
	4.	ALL EXISTING PROP LOCATIONS ARE NO	ERTY LINES HAVE BEEN ESTABLISHED FROM AVAILABLE INFORMATION AND THEIR EXACT I GUARANTEED.		
VITHIN 3.	5.	PLANS IS BASED UP	I REFER TO NAVD 88 VERTICAL DATUM. THE COORDINATE INFORMATION INCLUDED ON THESE ON MASSACHUSETTS GRID SYSTEM, NAD 1983, AS DERIVED FROM GPS CONTROL COORDINATES ASSDOT HIGHWAY DEPARTMENT SURVEY SECTION.		
OXED	6.	BENCHMARK INFORM	MATION: I BASELINE TIES SHEET 8 FOR BENCHMARK INFORMATION AND LOCATIONS.		
ISTING		PAVEMENT N	OTES		
EER		FULL DEPTH PAVEME	<u>NT</u>		
ACENT TING		SURFACE COURSE:	2" SUPERPAVE SURFACE COURSE 12.5 - POLYMER (SSC-12.5-P) OVER ASPHALT EMULSION FOR TACK COAT OVER		
ANY		INTERMEDIATE COURSE:	2.5" SUPERPAVE INTERMEDIATE COURSE 19.0 (SIC-19.0) OVER ASPHALT EMULSION FOR TACK COAT OVER		
ER.		BASE COURSE:	4.5" SUPERPAVE BASE COURSE 37.5 (SBC-37.5) OVER		
		SUB-BASE:	4" DENSE GRADED CRUSHED STONE OVER 8" GRAVEL BORROW, TYPE b		
		<u>BOX WIDENING ≤4' WI</u>	DE		
		SURFACE COURSE:	2" SUPERPAVE SURFACE COURSE 12.5 - POLYMER (SSC-12.5-P) OVER ASPHALT EMULSION FOR TACK COAT OVER		
		INTERMEDIATE COURSE:	2.5" SUPERPAVE INTERMEDIATE COURSE 19.0 (SIC-19.0) OVER ASPHALT EMULSION FOR TACK COAT OVER		
REMENTS		BASE COURSE:	6" HES CEMENT CONCRETE BASE COURSE OVER		
RANCES		SUB-BASE:	8" GRAVEL BORROW, TYPE b		
		CEMENT CONCRETE S	DEWALKS AND WHEELCHAIR RAMPS		
		SURFACE:	4" CEMENT CONCRETE WALK SURFACE 4000 PSI, 3/4", 610 OVER		
RCISE FURES		FOUNDATION:	8" GRAVEL BORROW, TYPE b		



Traffic Calming at Intersection of Waltham Street / Derby Street / Fairway Drive

GENERAL NOTES

Newton, MA

BETA JOB NO.


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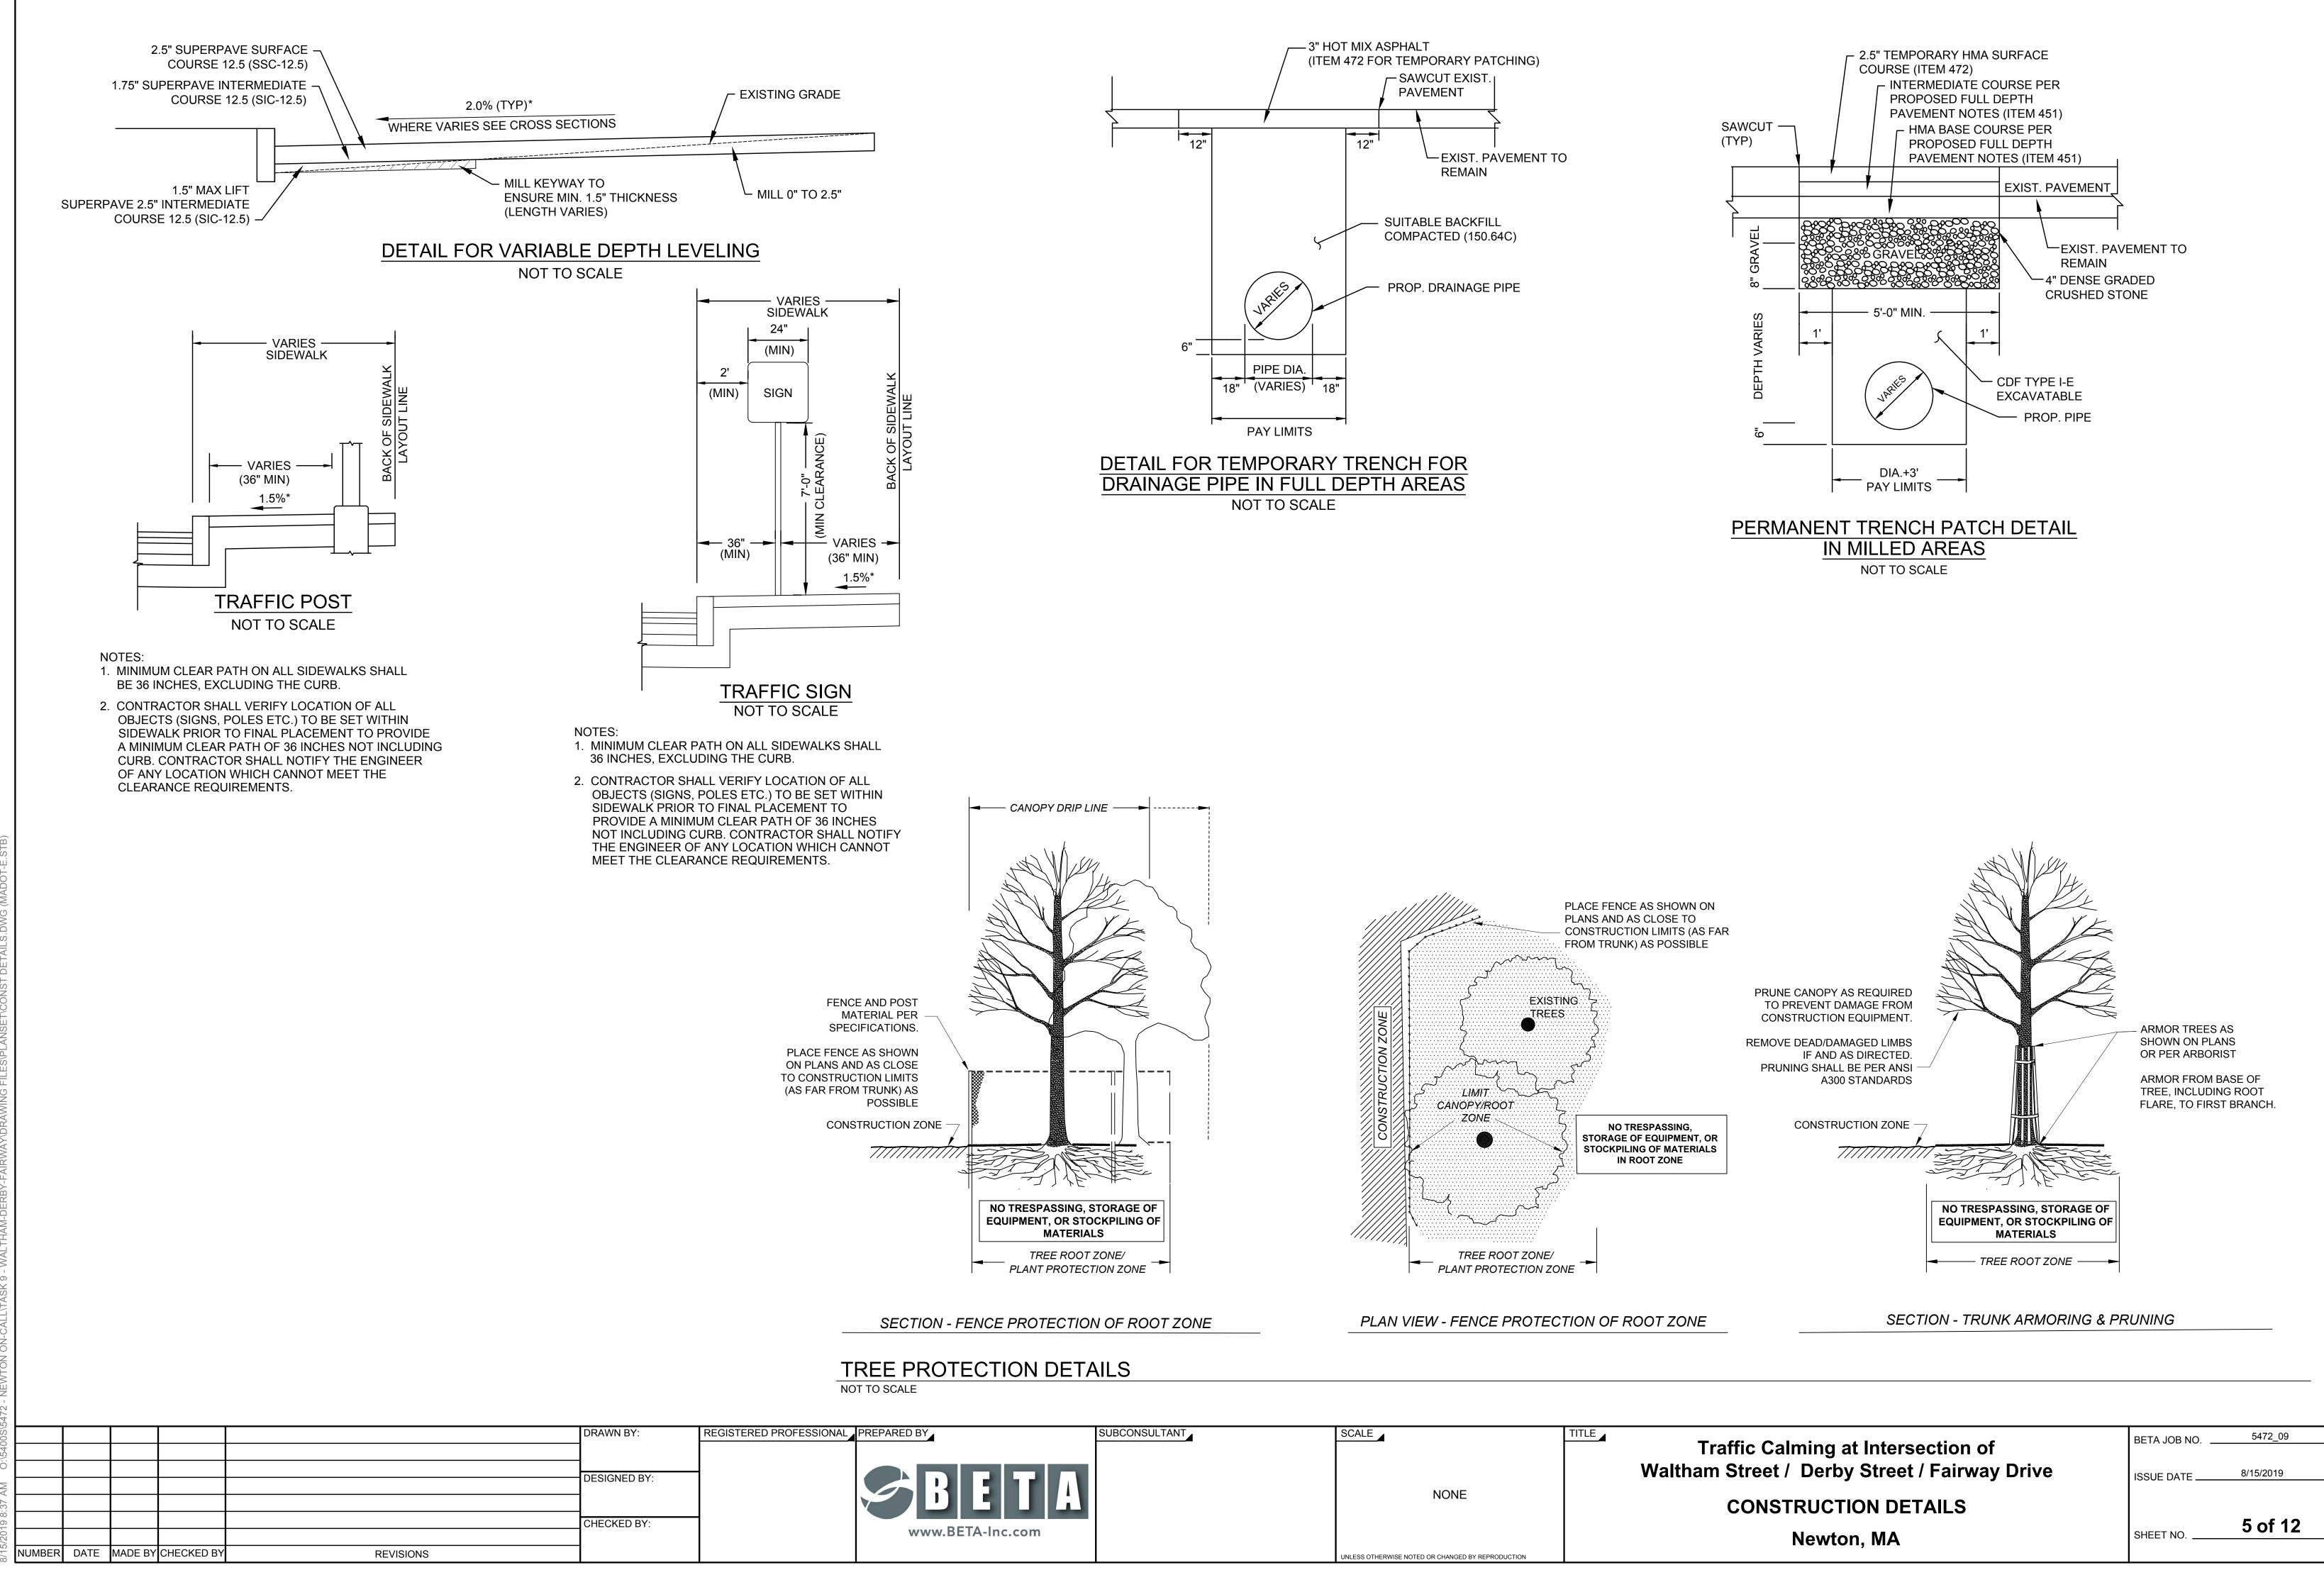
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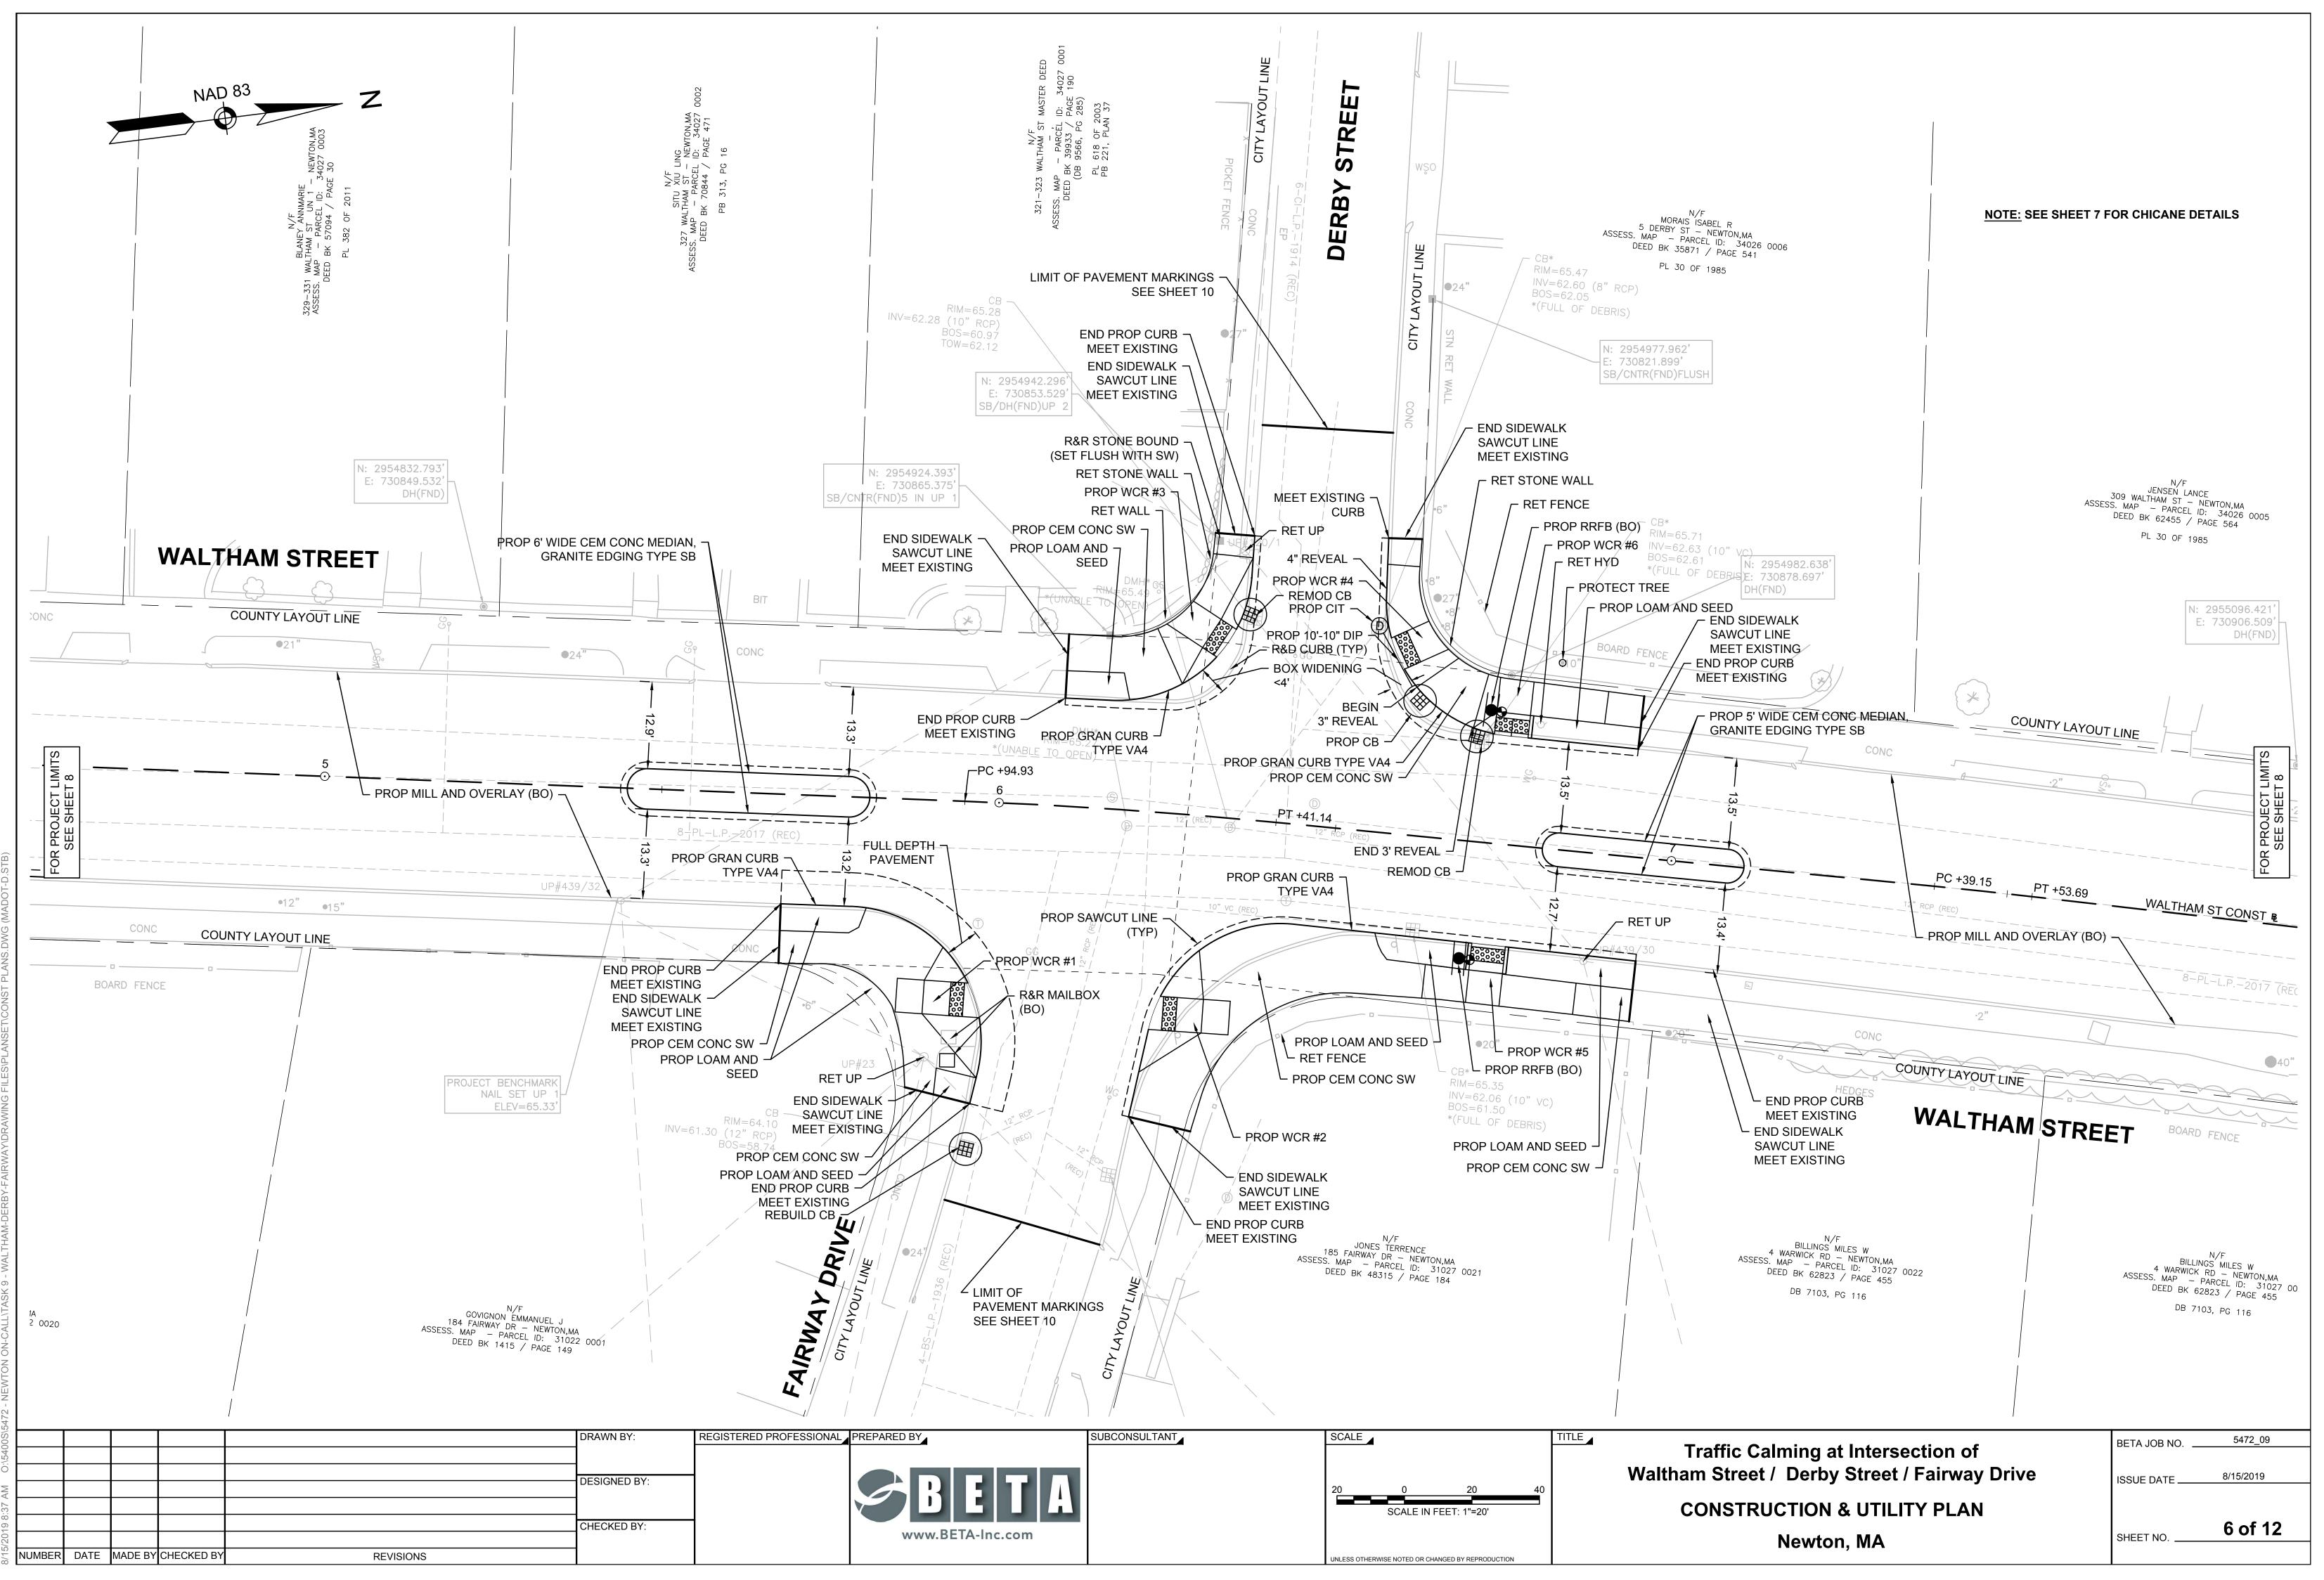
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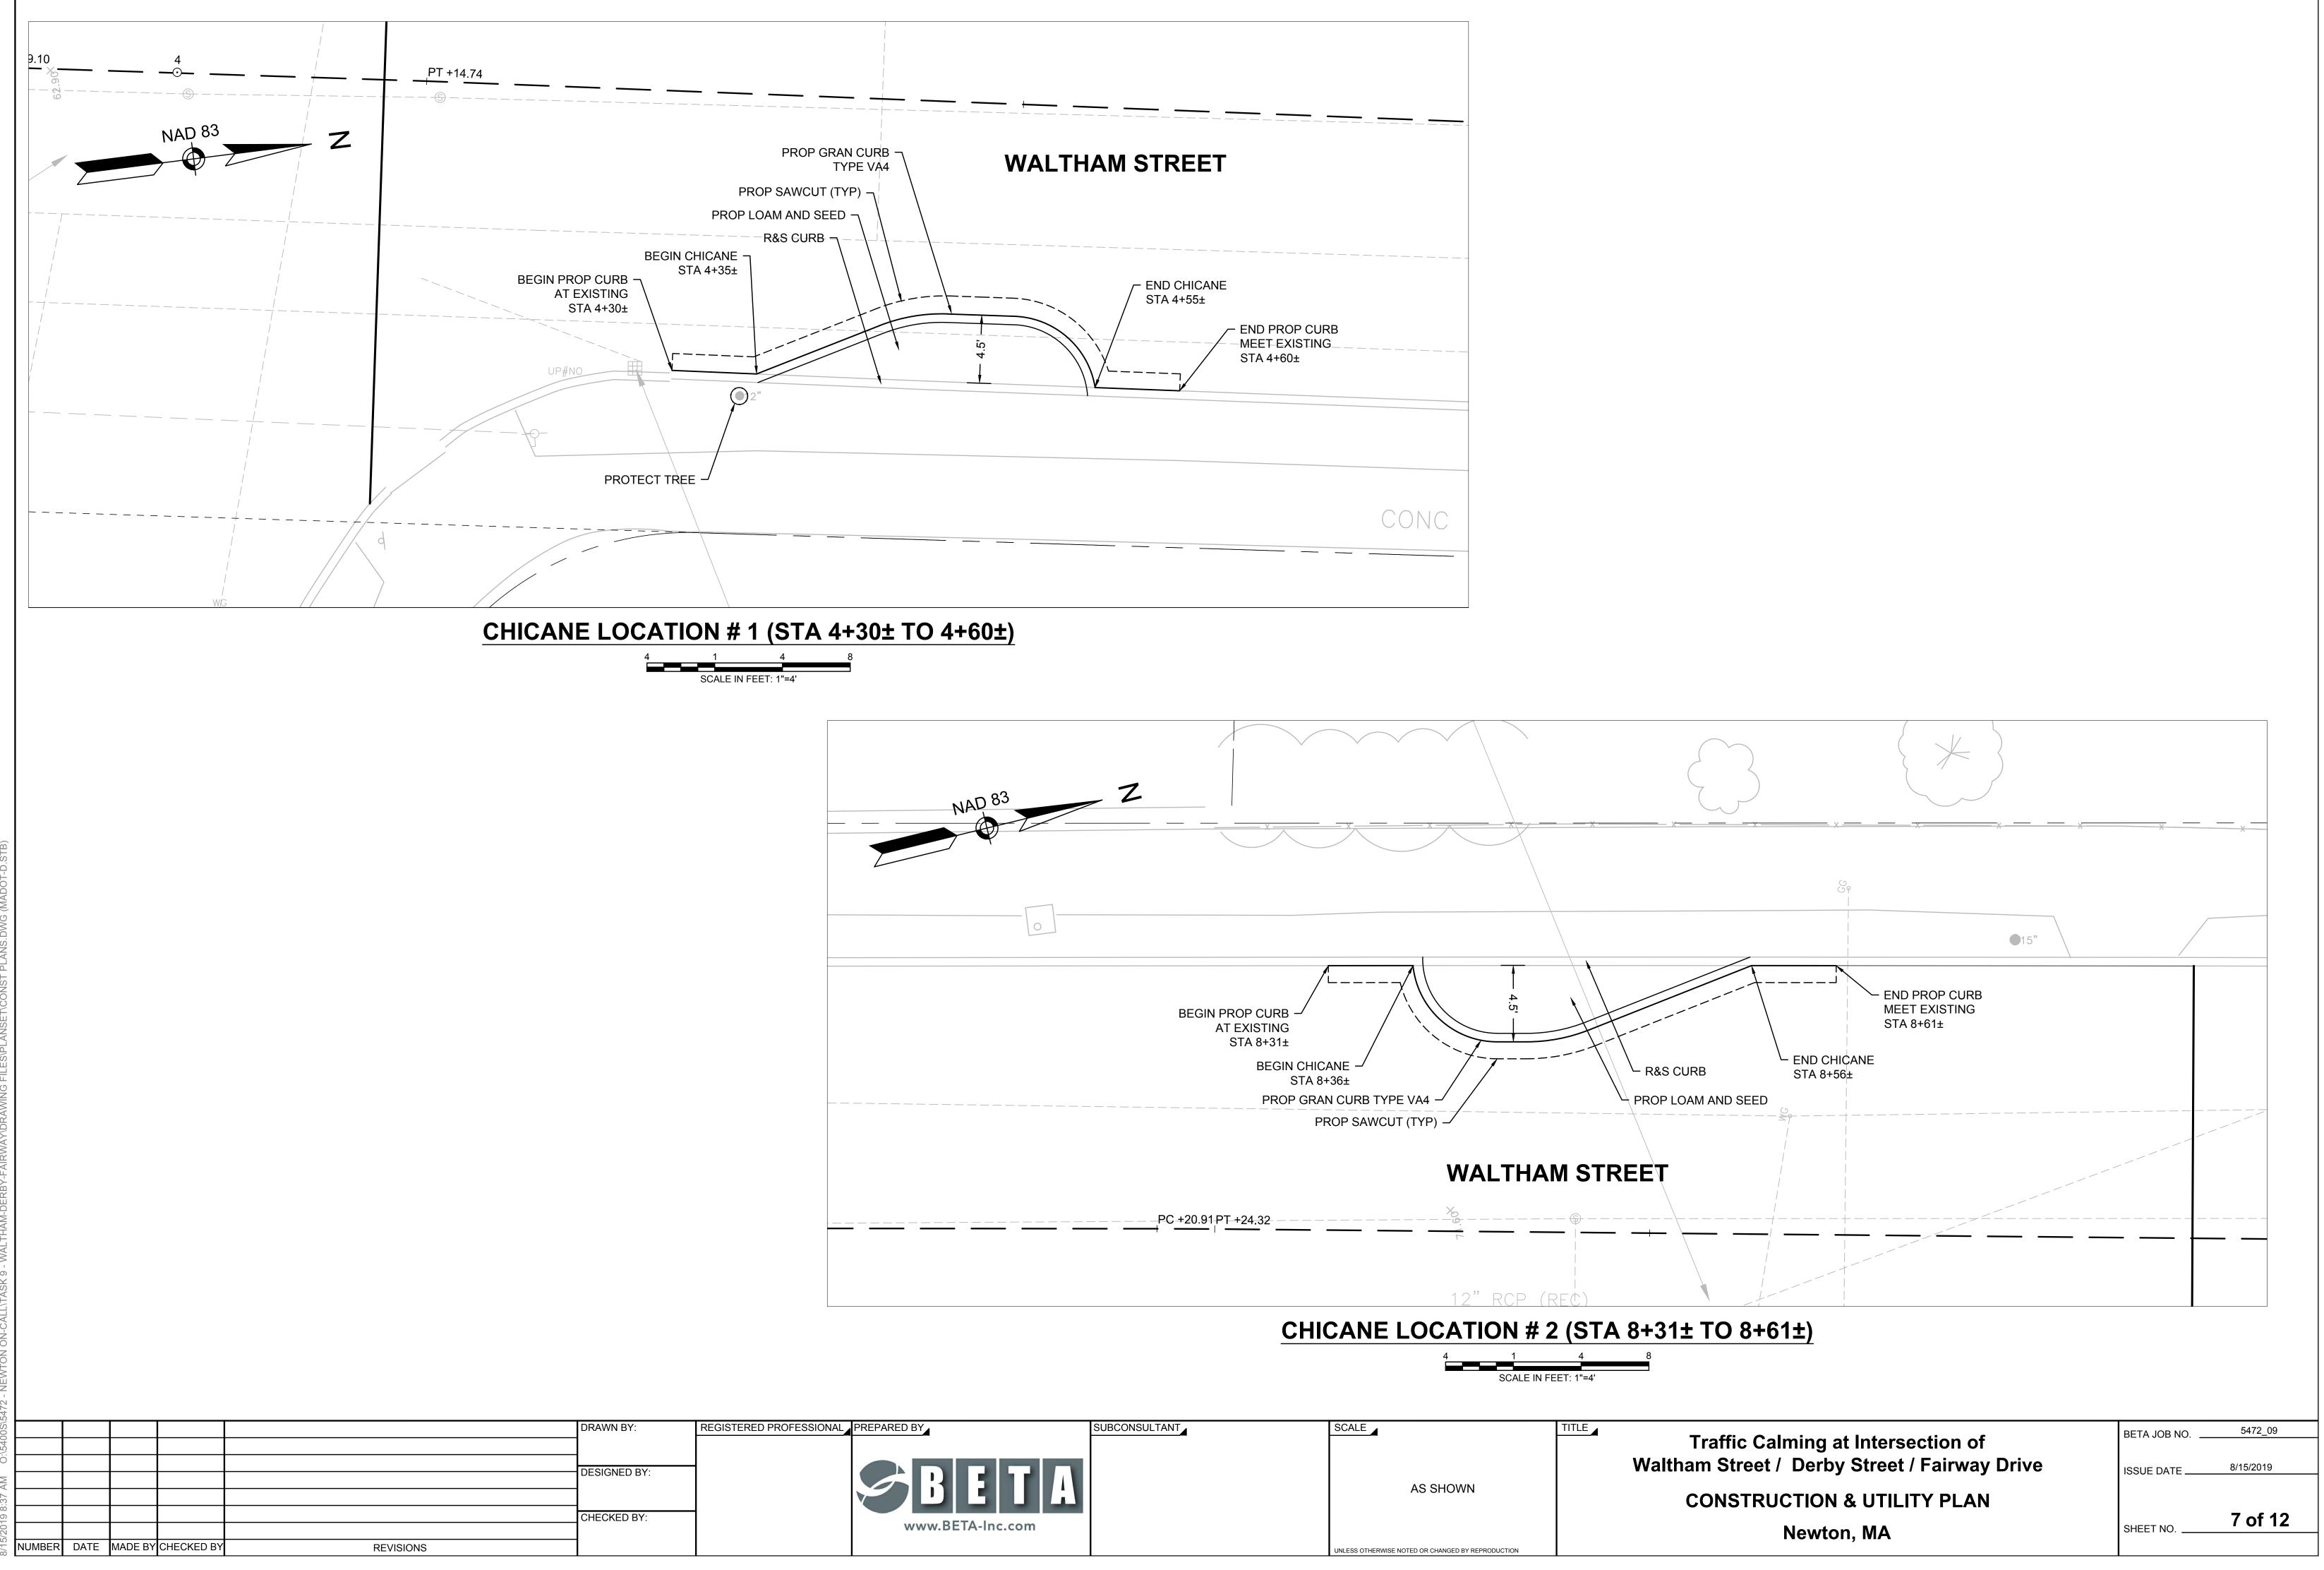
5472_09

	WHEEL CHAIR RAMP TYPE A DATA						
WCR	LOCATION	RAMP REFERENCE POINT		GUTTER	LENGTH OF	WIDTH OF RAMP OPENING	
NO.		STATION	OFFSET	PROFILE SLOPE	L	W	
1	WALTHAM ST	05+97.6'	29.4' RT	-1.7%	6.5' TO 8.5'	5.0'	
2	WALTHAM ST	06+25.20'	29.6' RT	-1.3%	6.4' TO 7.8'	5.0'	
3	WALTHAM ST	06+31.71'	25.7' LT	2.2%	2.5' TO 2.7'	5.0'	
4	WALTHAM ST	06+56.58'	26.6' LT	2.1%	6.2' TO 7.3'	5.0'	
5	WALTHAM ST	06+74.25'	15.05' RT	-2.6%	4.0'	5.0'	
6	WALTHAM ST	06+74.59'	16.1' LT	2.9%	3.3'	5.0'	










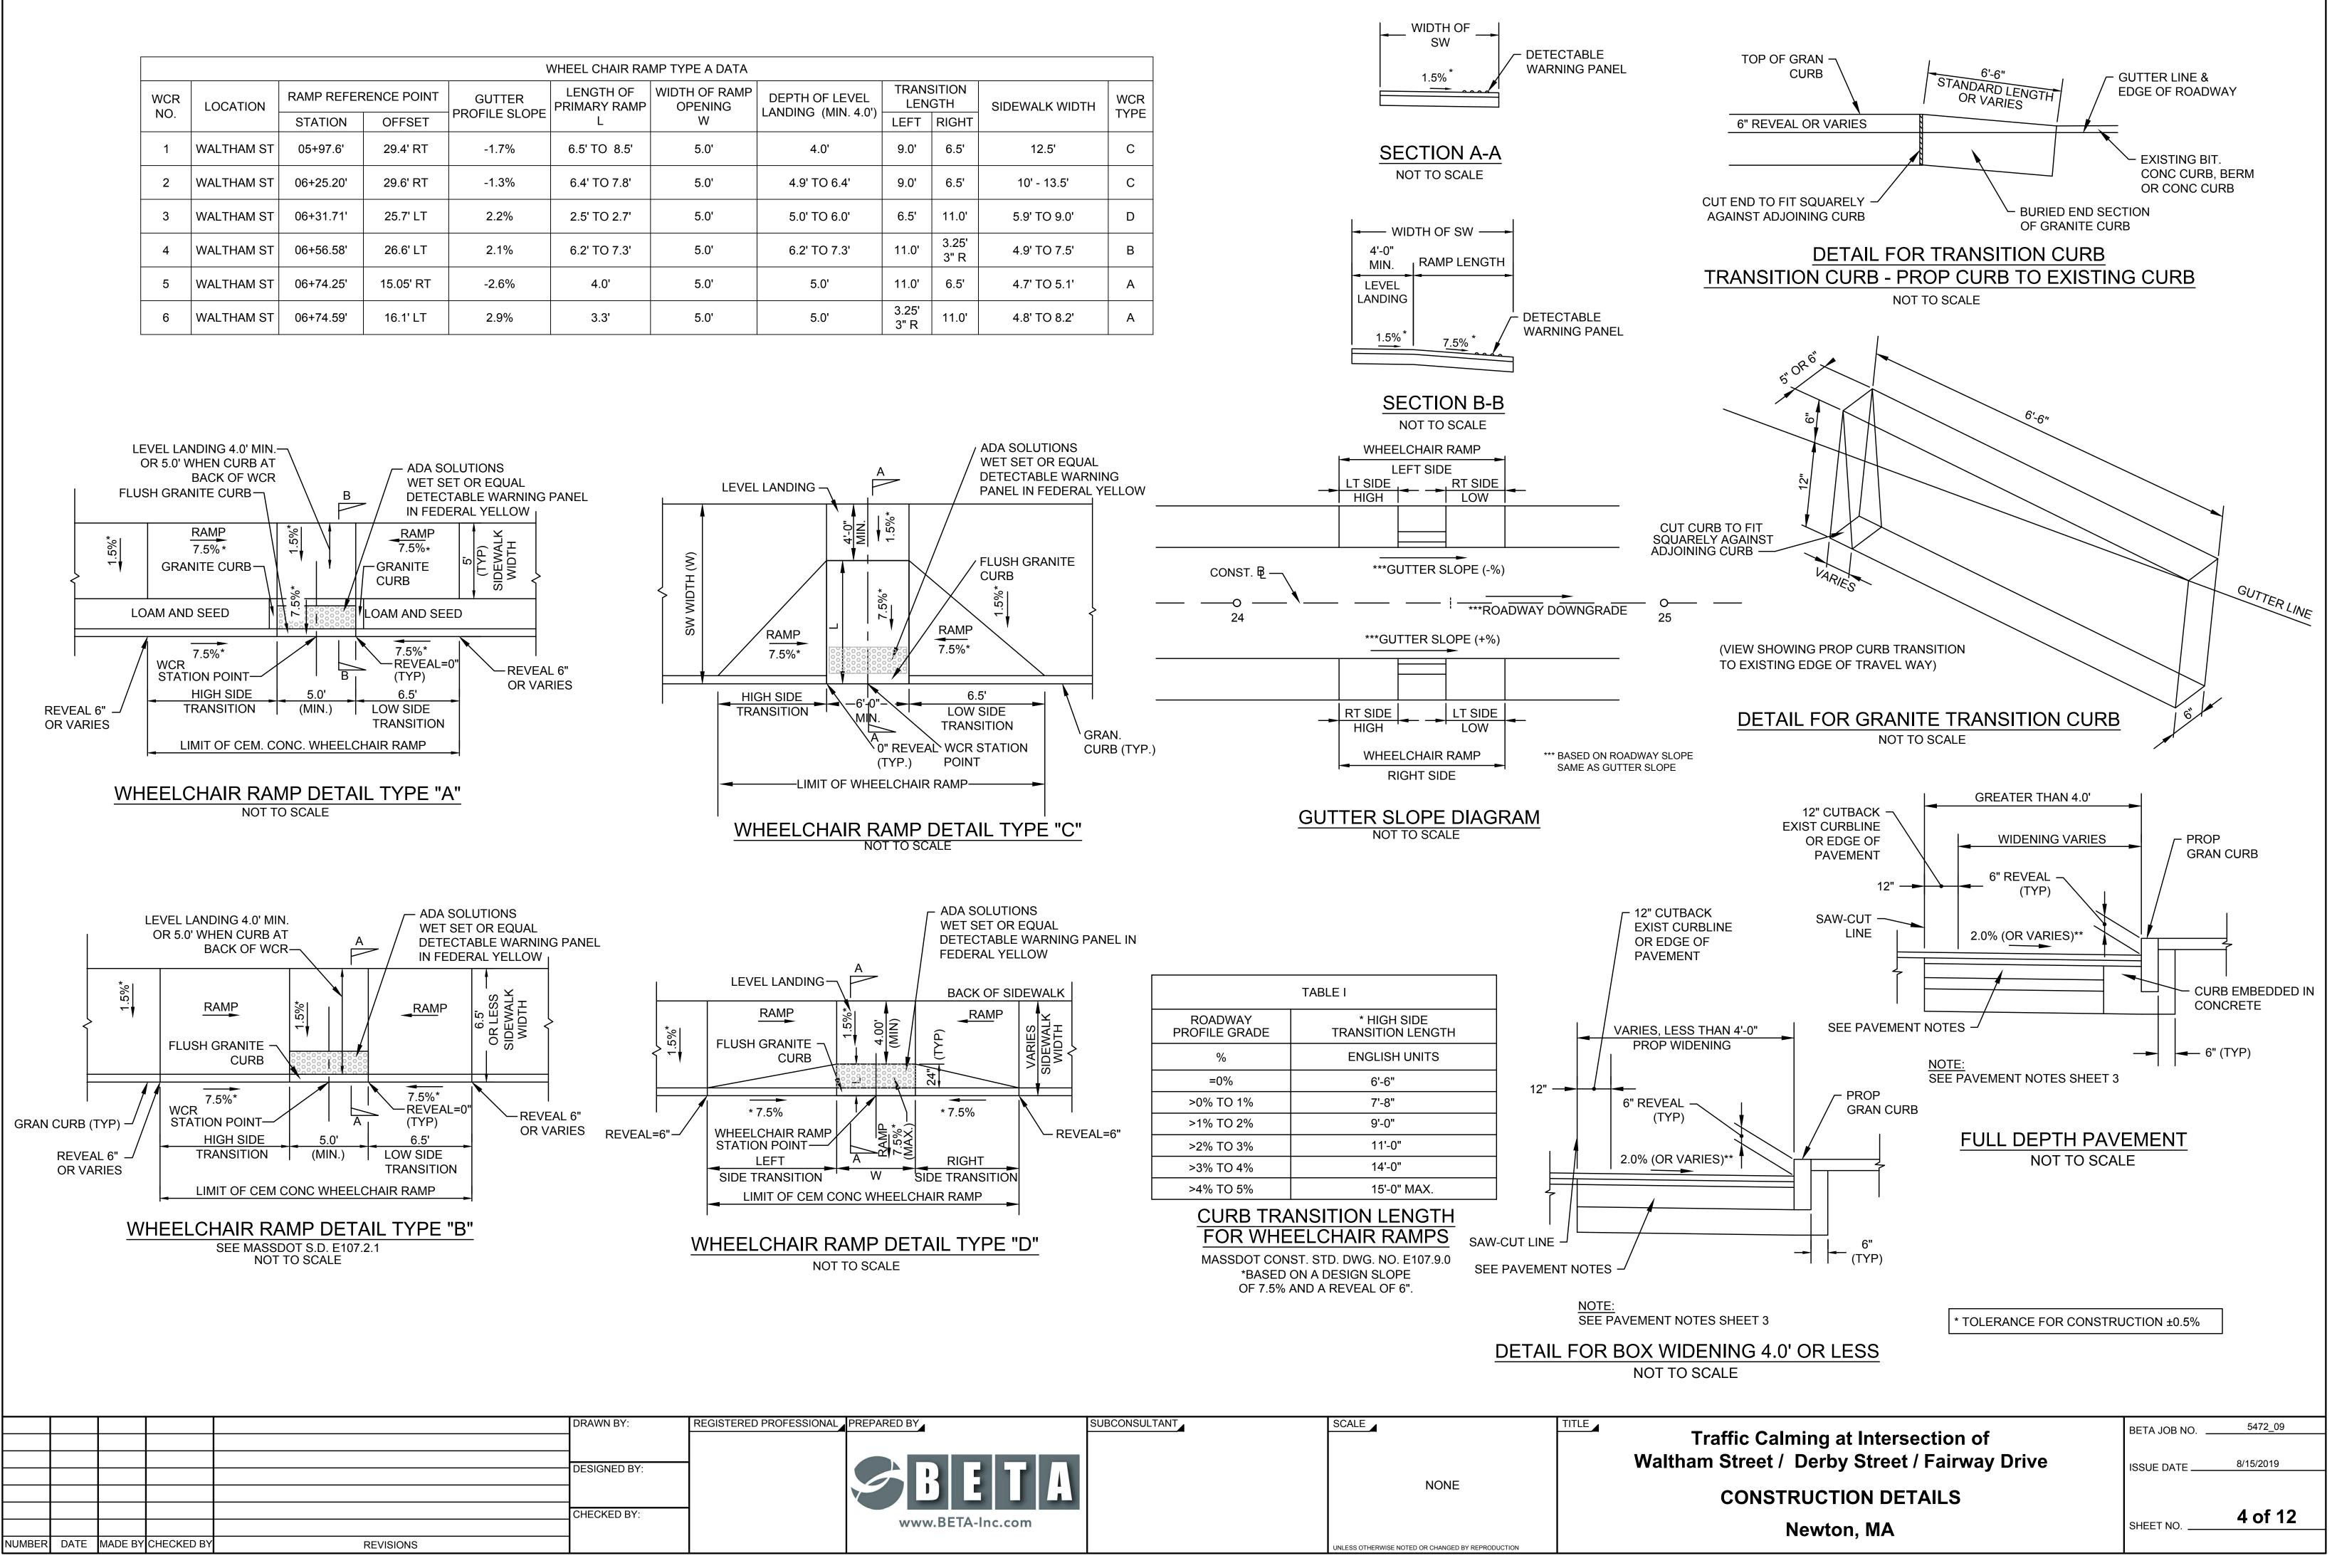

ROFESSIONAL	PREPARED BY	SUBCONSULTANT	SCALE	TITLE
	SBETA-Inc.com		AS SHOWN	
			UNLESS OTHERWISE NOTED OR CHANGED BY REPRODUCTION	

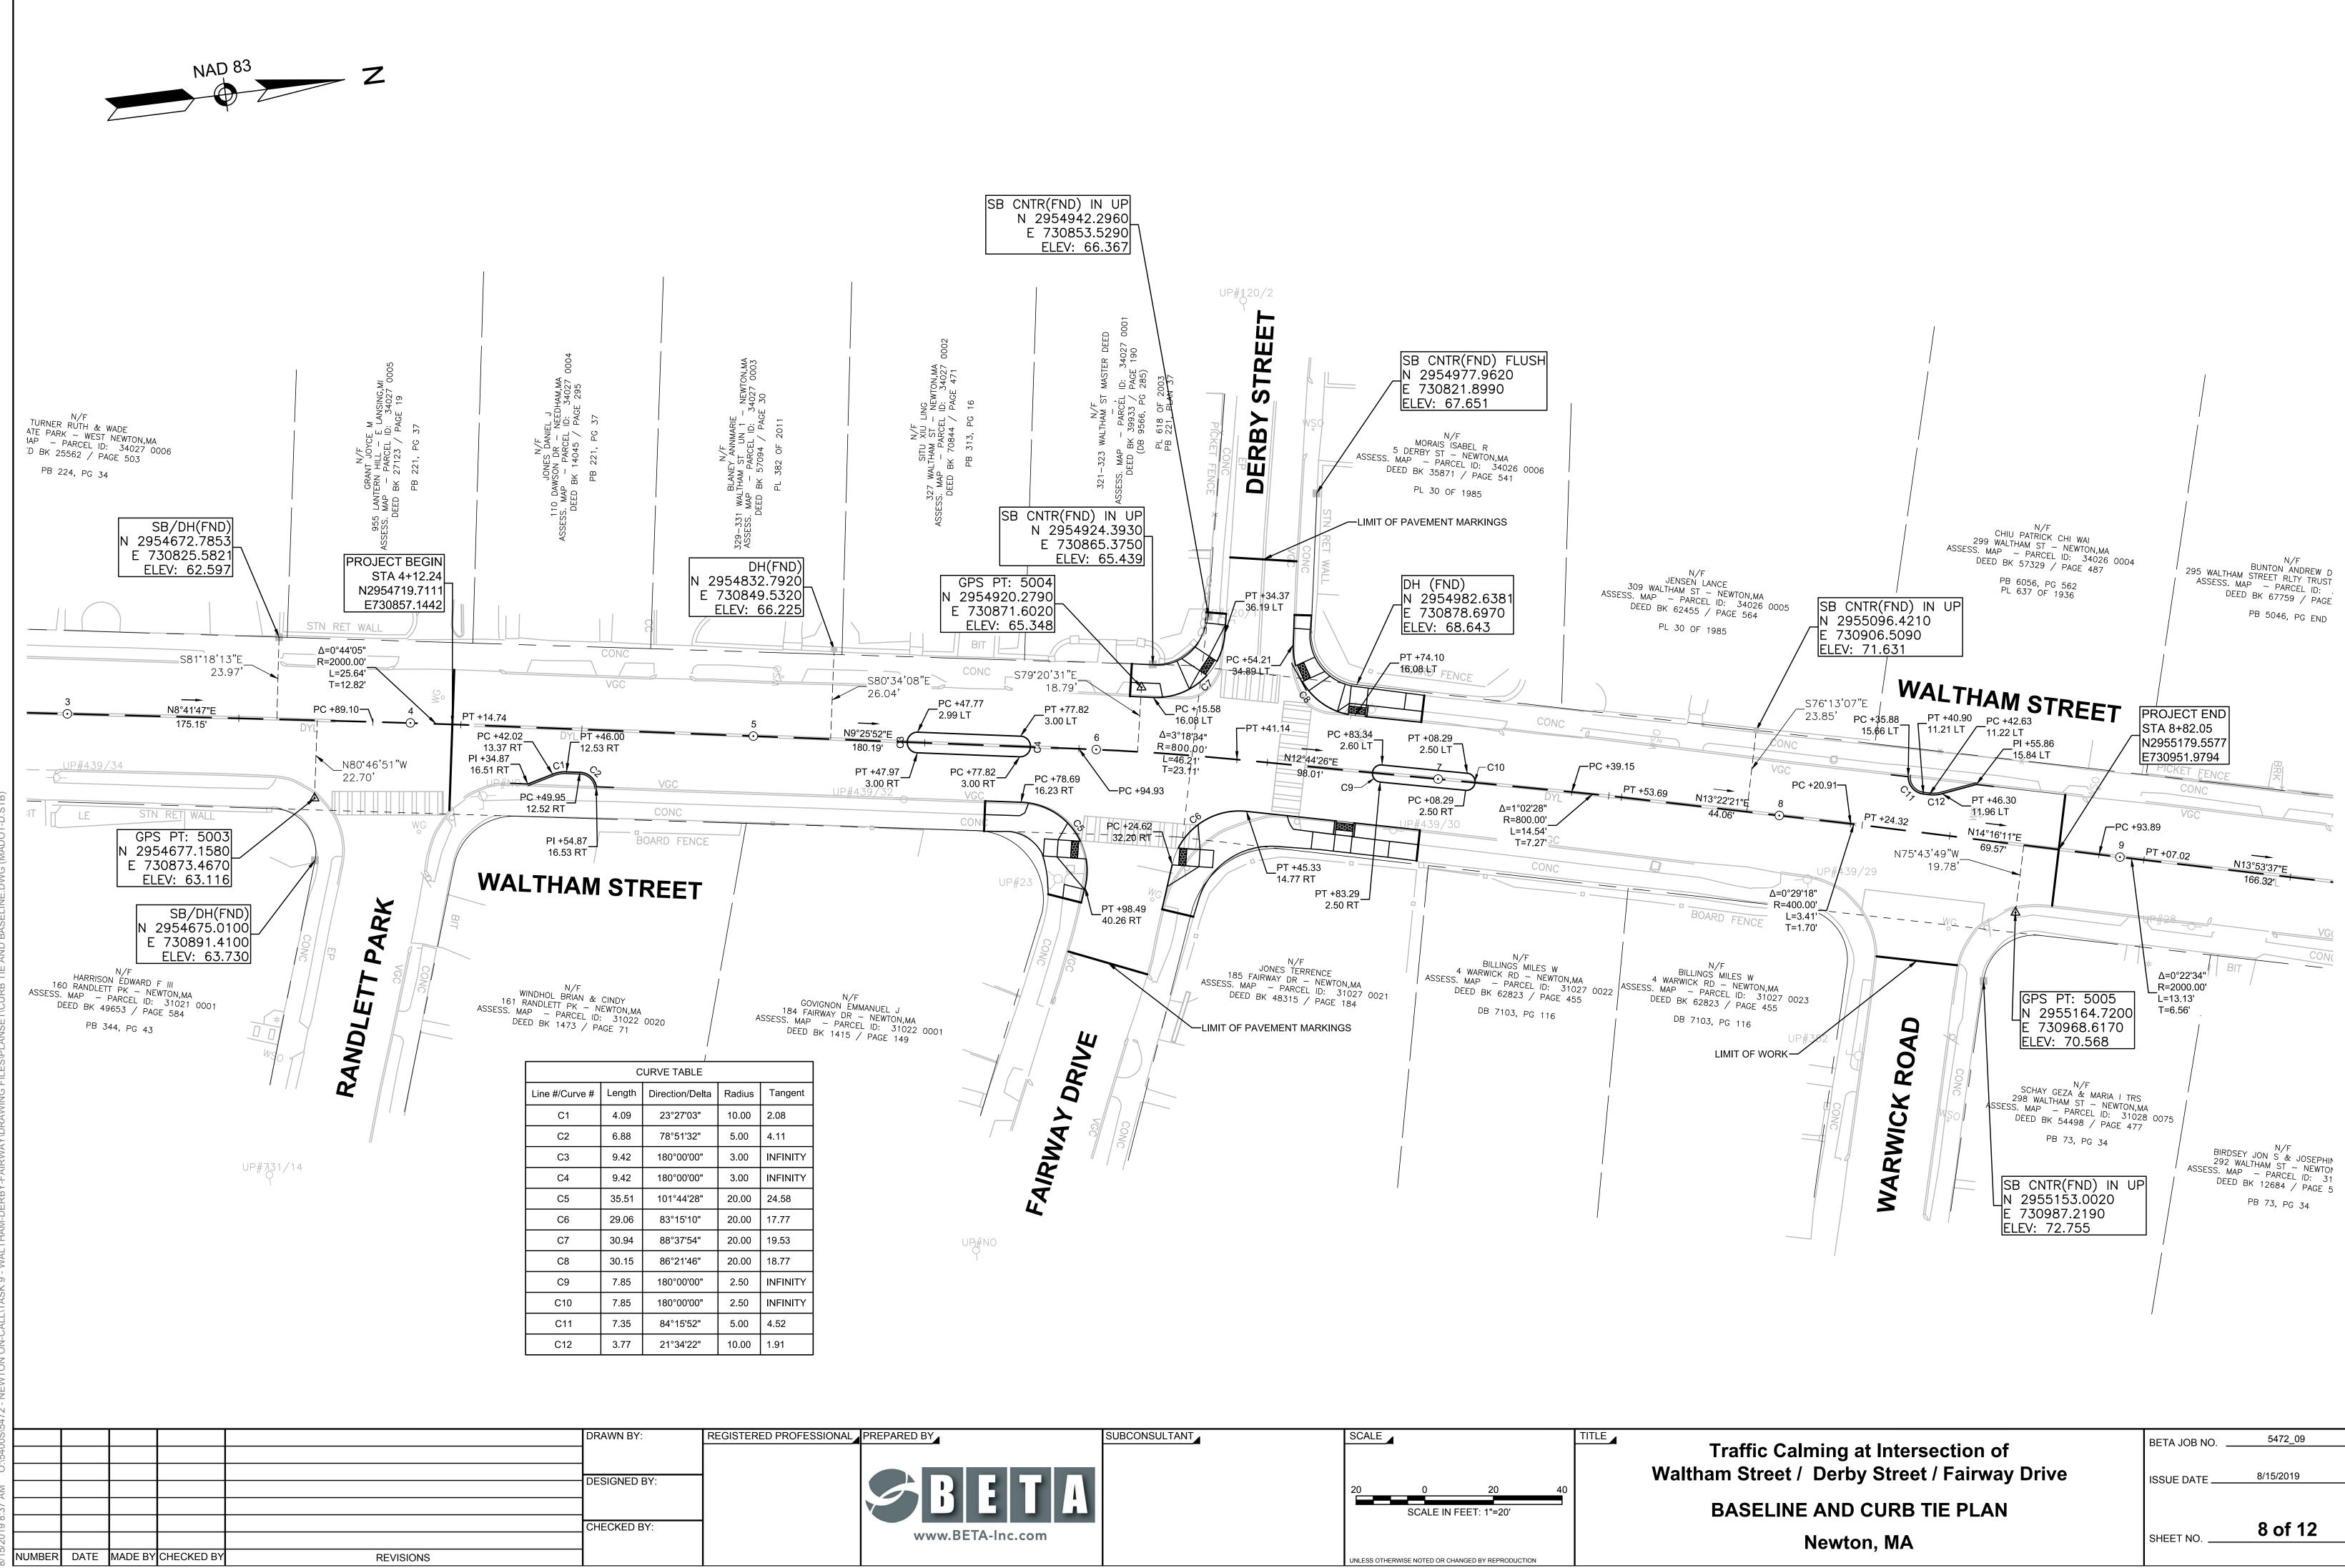

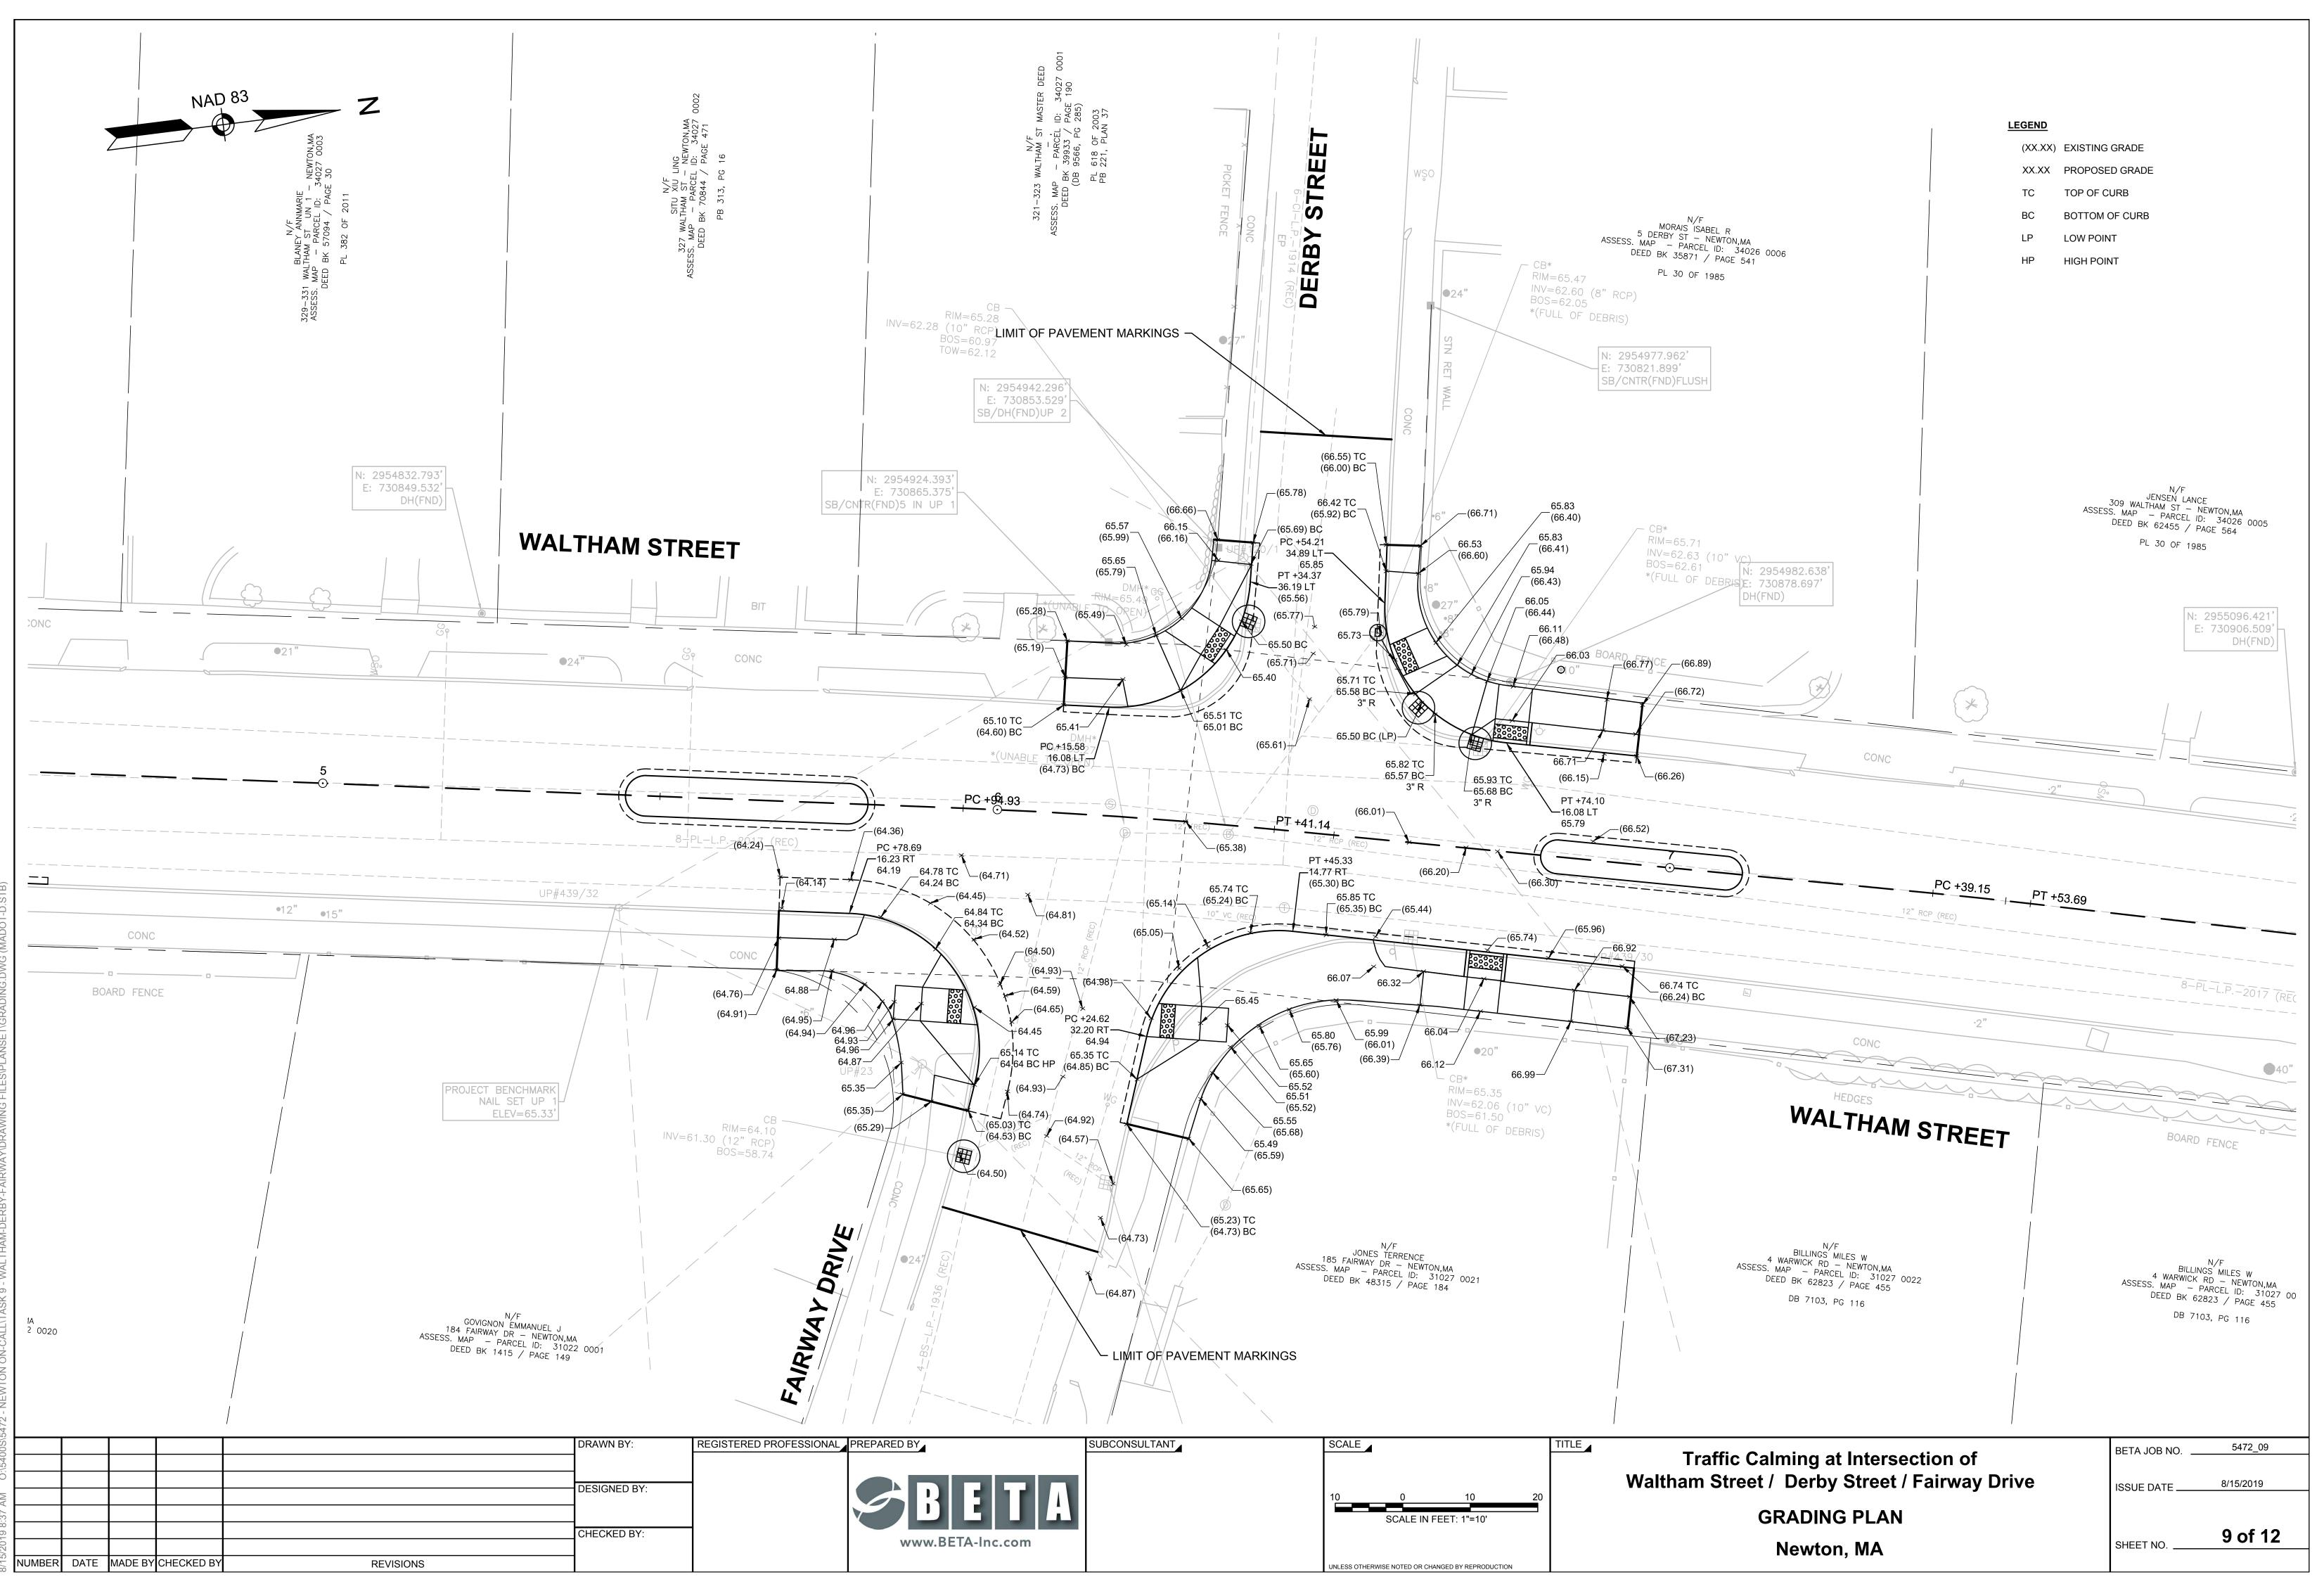

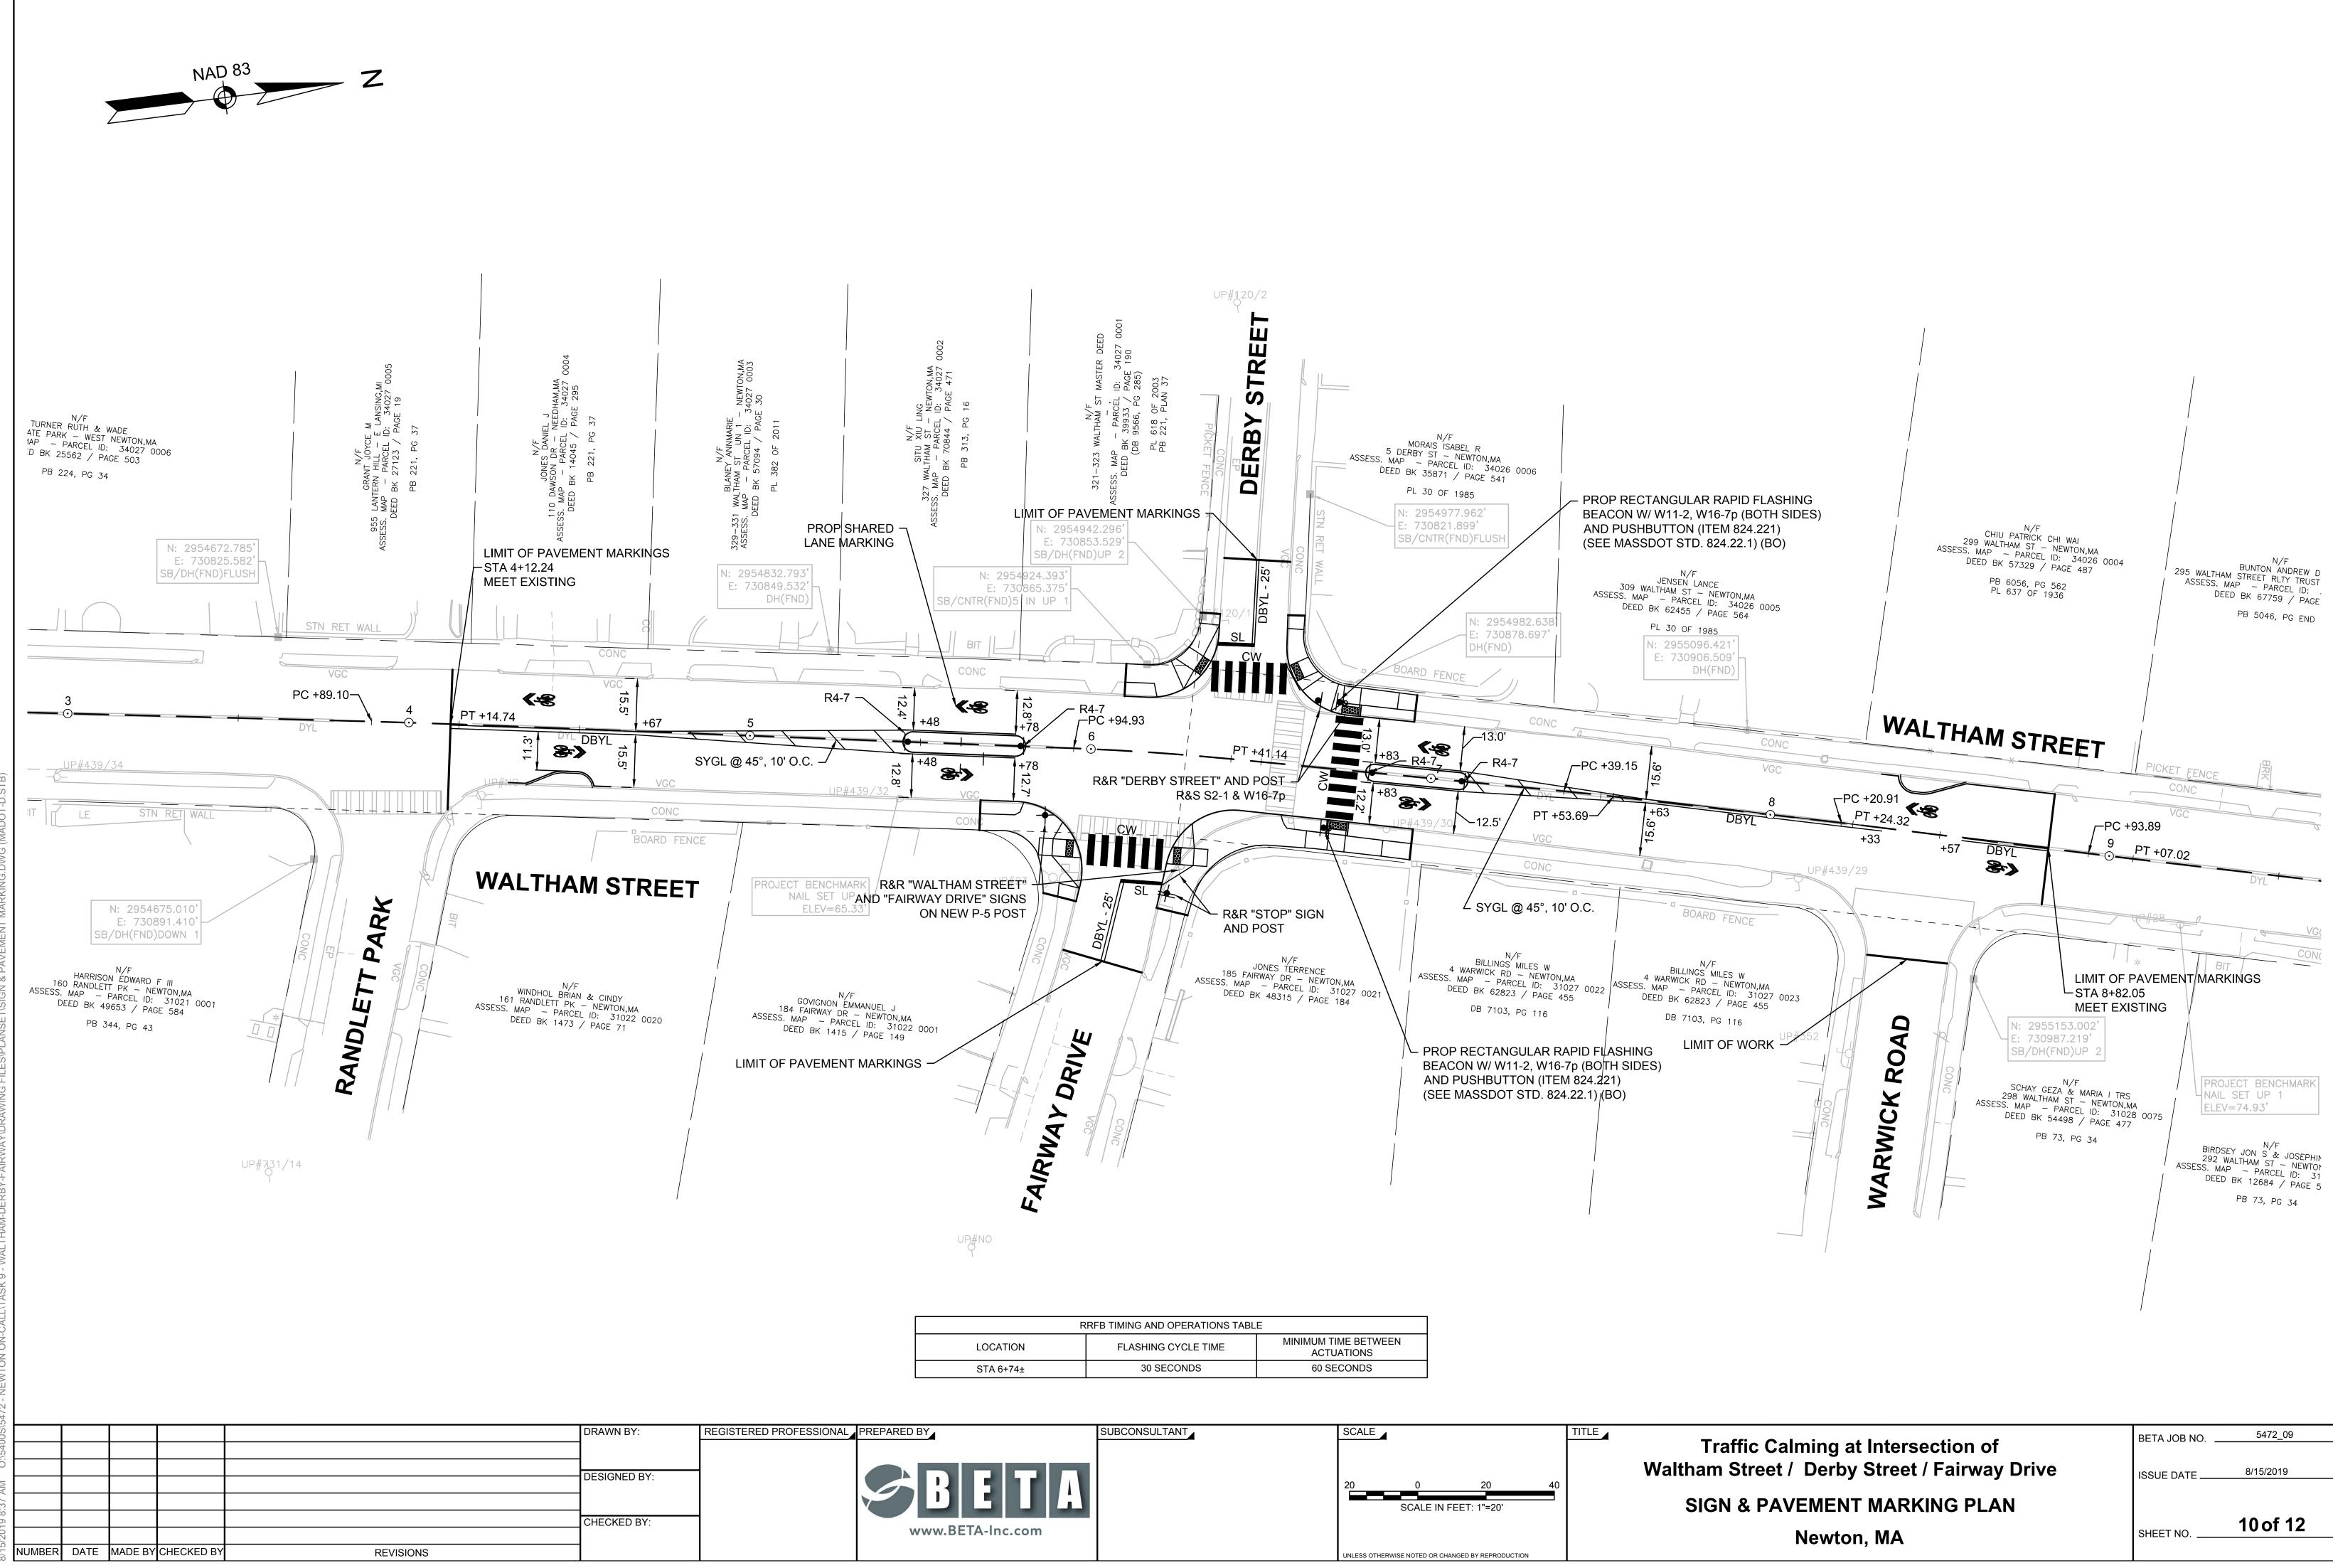


RRFB TIMING AND OPERATIONS TABLE				
LOCATION	FLASHING CYCLE TIME	MINIMUM TIME BETWEEN ACTUATIONS		
STA 6+74±	30 SECONDS	60 SECONDS		


IDENTIFI- CATION NUMBER	SIZE OF SIGN		TEXT	DIMENSIONS (in)		NUMBER OF SIGNS	COLOR			POST SIZE AND	UNIT AREA IN	AREA IN SQUARE						
	WIDTH	HEIGHT		LETTER HEIGHT	VERTI SPAC		ARROW	REQUIRED	BACK- GROUND	LEGEND	BORDER	NUMBER REQUIRED	SQUARE FEET	FEET				
R4-7	24 in	30 in	7	SEE 2009 MUTCD		۸	4	WHITE	BLACK	BLACK	P-5 4	5.0	20.0					
R10-25	9 in	12 in	PUSH BUITON TO TURN ON WARNING LIGHTS		MUTC) MUTO	ARDS	2	WHITE	BLACK	BLACK	MOUNT ON RRFB	0.75	1.5				
W11-2	30 in	30 in			EE 2009	EE 200	EE 200	EE 200	EE 200	STAND		4	FYG	BLACK	BLACK	MOUNT ON RRFB	6.25	25.0
W16-7p	24 in	12 in			SE			4	FYG	BLACK	BLACK	MOUNT ON RRFB	2.0	8.0				


PAVEMENT MARKING & SIGN NOTES

- 1. ALL EXISTING SIGNS AND SIGN POSTS WITHIN THE PROJECT LIMITS SHALL BE RETAINED UNLESS OTHERWISE NOTED ON PLANS.
- 2. HIGH INTENSITY ENCAPSULATED LENS REFLECTIVE SHEETING CONFORMING TO SECTION M9:30.0, TYPE III OR IV, OF THE MASSDOT STANDARD SPECIFICATIONS SHALL BE USED FOR ALL SIGNS.
- 3. ALL PROPOSED POSTS SHALL BE P5 TYPE (TELESCOPIC POST). POSTS SHALL CONFORM TO THE DIMENSIONS AND REQUIREMENTS OF THE MASSDOT "STANDARD DRAWINGS FOR SIGNS AND SUPPORTS" (LATEST EDITION).
- 4. SEE THE 2009 "MANUAL ON UNIFORM TRAFFIC CONTROL DEVICES" AND "STANDARD HIGHWAY SIGNS" FOR THE LATEST SPECIFICATIONS ON TEXT DIMENSIONS AND COLOR. (ALSO SEE SECTION M9.30.0 TYPE III MASSDOT STANDARD SPECIFICATION, THE "MASSACHUSETTS MANUAL OF UNIFORM TRAFFIC CONTROL DEVICES," AND "GUIDE SIGN POLICY FOR SECONDARY STATE HIGHWAYS" (LATEST EDITIONS) BY THE MASSACHUSETTS DEPARTMENT OF TRANSPORTATION).
- 5. UNLESS OTHERWISE PROVIDED FOR IN THE MUTCD, ALL SIGNS SHOULD BE 90° TO THE CURB AND FACING THE FLOW OF TRAFFIC.
- 6. STREET NAME SIGNS SHALL BE MOUNTED PARALLEL WITH THE STREET.
- 7. SIGNS TO BE MOUNTED NEAR THE CURB LINE IN AREAS WITHOUT SIDEWALK SHALL BE SET BACK 2' FROM THE EDGE OF THE SIGN PANEL TO THE CURB LINE. NO SIGN SHALL OVERHANG THE CURB LINE.
- 8. ALL SIGNS SHALL BE MOUNTED TO PROVIDE A 7' MINIMUM CLEARANCE BETWEEN THE BOTTOM OF THE SIGN AND FINISHED GRADE.
- 9. PBS: PAINTED BOTH SIDES.
- 10. FYG: FLUORESCENT YELLOW GREEN
- 11. ALL PROPOSED PAVEMENT MARKINGS SHALL BE THERMOPLASTIC. ALL EXISTING PAVEMENT MARKINGS THAT CONFLICT WITH THE PROPOSED PAVEMENT MARKINGS SHALL BE REMOVED BY AN APPROVED METHOD.
- 12. PROPOSED PAVEMENT MARKINGS (LEGENDS & ARROWS) SHALL BE INSTALLED IN ACCORDANCE WITH THE MUTCD & MASSDOT - 1996 CONSTRUCTION AND TRAFFIC STANDARD DETAILS, AS AMENDED.

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400S/5						DRAWN BY:	REGISTERED
:\540							
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AM						DESIGNED BY:	
38 /							
19 0.						CHECKED BY:	
/201							
8/15	NUMBER	DATE	MADE BY	CHECKED BY	REVISIONS		
-	-						

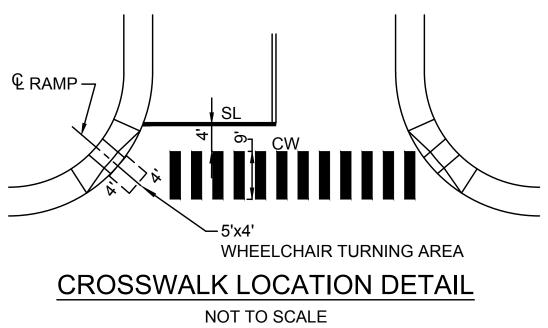

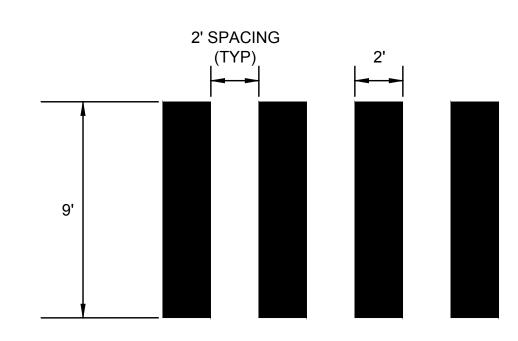

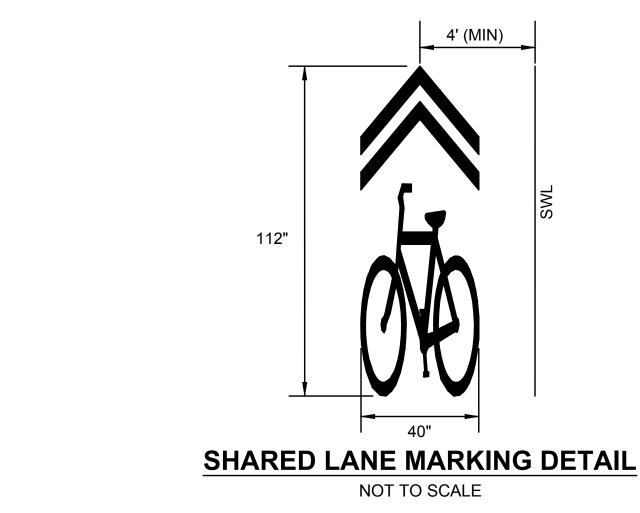

PROFESSIONAL PREPARED BY	SUBCONSULTANT	SCALE	TITLE
SBET www.BETA-Inc.com	A	20 0 20 4 SCALE IN FEET: 1"=20'	⁴⁰ SIC
		UNLESS OTHERWISE NOTED OR CHANGED BY REPRODUCTION	

CROSSWALK DETAIL NOT TO SCALE

> Traffic Calming at Intersection of Waltham Street / Derby Street / Fairway Drive

IGN SUMMARY AND PAVEMENT MARKING DETAILS

Newton, MA

BETA JOB NO.

ISSUE DATE ____

5472_09

SHEET NO.

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8/15/2019

NOTES:	
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- 1. ALL TEMPORARY TRAFFIC CONTROL WORK SHALL CONFORM TO THE 2009 EDITION OF THE "MANUAL ON UNIFORM TRAFFIC CONTROL DEVICES" (MUTCD) AND ALL REVISIONS.
- 2. ALL SIGN LEGENDS, BORDERS AND MOUNTING SHALL BE IN ACCORDANCE WITH THE MUTCD, EXCEPT THAT BACKGROUND COLOR SHALL BE FLUORESCENT ORANGE, IN ACCORDANCE WITH MASSDOT SPECIFICATIONS.
- 3. TEMPORARY CONSTRUCTION SIGNING AND ALL OTHER TRAFFIC CONTROL DEVICES SHALL BE IN PLACE PRIOR TO THE START OF ANY WORK
- 4. TEMPORARY CONSTRUCTION SIGNING, BARRICADES AND ALL OTHER NECESSARY WORK ZONE TRAFFIC CONTROL DEVICES SHALL BE REMOVED FROM THE HIGHWAY OR COVERED WHEN THEY ARE NOT REQUIRED FOR CONTROL OF TRAFFIC.
- 5. SIGNS AND SIGN SUPPORTS LOCATED ON OR NEAR THE TRAVELED WAY, AND REFLECTORIZED PLASTIC DRUMS WITH LIGHTING DEVICES MOUNTED ON THEM, MUST PASS THE CRITERIA SET FORTH IN NCHRP REPORT 350, "RECOMMENDED PROCEDURES FOR THE SAFETY PERFORMANCE EVALUATION OF HIGHWAY FEATURES" AND/OR "MANUAL FOR ASSESSING SAFETY HARDWARE" (MASH).
- 6. CONTRACTORS SHALL NOTIFY EACH ABUTTER AT LEAST 24 HOURS IN ADVANCE OF THE START OF ANY WORK THAT WILL REQUIRE THE TEMPORARY CLOSURE OF ACCESS. SUCH AS CONDUIT INSTALLATION. EXISTING PAVEMENT EXCAVATION. TEMPORARY DRIVEWAY PAVEMENT PLACEMENT AND SIMILAR OPERATIONS.
- 7. THE FIRST TEN PLASTIC DRUMS OF A TAPER SHALL BE MOUNTED WITH TYPE A LIGHTS.
- 8. THE ADVISORY SPEED LIMIT, IF REQUIRED, SHALL BE DETERMINED BY THE ENGINEER
- 9. DISTANCES ARE A GUIDE AND MAY BE ADJUSTED IN THE FIELD BY THE ENGINEER.
- 10. MAXIMUM SPACING OF TRAFFIC DEVICES IN A TAPER (DRUMS OR CONES) IS EQUAL IN FEET TO THE SPEED LIMIT IN MPH.
- 11. MINIMUM LANE WIDTH IS TO BE 11 FEET UNLESS OTHERWISE SHOWN. MINIMUM LANE WIDTH TO BE MEASURED FROM THE EDGE OF DRUMS OR MEDIAN BARRIER
- 12. ALL SIGNS SHALL BE MOUNTED ON THEIR OWN STANDARD SIGN SUPPORTS
- 13. TEMPORARY CONSTRUCTION SIGNING AND ALL OTHER NECESSARY WORK ZONE TRAFFIC CONTROL NOT COVERED IN THE PLAN SHALL REFER TO MASSDOT "STANDARD DETAILS AND DRAWINGS FOR THE DEVELOPMENT OF TRAFFIC MANAGEMENT PLANS".

	I
LEGEND:	
•	REFLECTORIZED PLASTIC DRUM
	TYPE III BARRICADE
	FLASHING ARROW PANNEL
•••	FLASHING ARROW PANNEL
	WORK ZONE
	DIRECTION OF TRAFFIC
	IMPACT ATTENUATOR
	MEDIAN BARRIER
	MEDIAN BARRIER WITH WARNING LIGHTS
E	WORK VEHICLE
	TRUCK MOUNTED ATTENUATOR
	TRAFFIC OR PEDESTRIAN SIGNAL
	SIGN
Р	POLICE DETAIL
F	FLAGGER

TAPER LENGTH


MA-R2-10a

W20-1A

SPEED LIMIT	FORMULA
40 MPH or Less 45 MPH or Greater	2 L=WS/60 L=W x S
L = TAPER LENGTH	I IN FEET


W = WIDTH OF OFFSET IN FEET S = POSTED SPEED IN MPH

W8-1

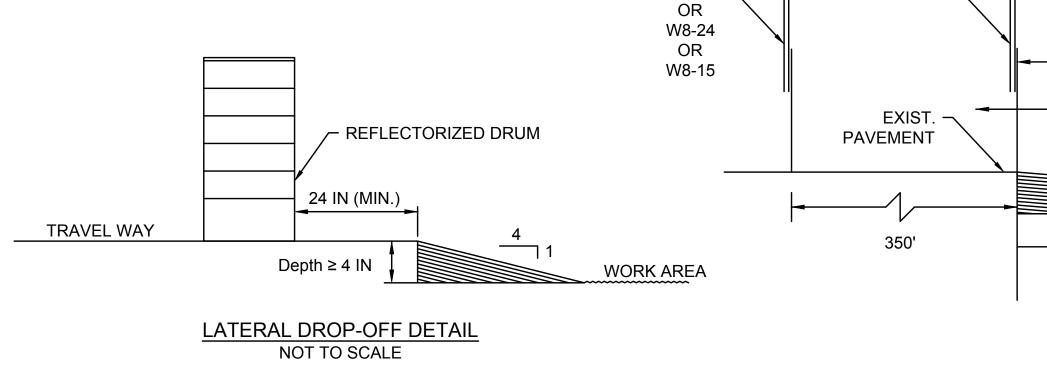

W8-3

\$\S\\O					DRAWN BY:	REGISTERED
<u>c</u>						
Ö					DESIGNED BY:	
AM					DEGIGINED DT.	
0:38						
10					CHECKED BY:	
2/20						
	R DATE	MADE BY	CHECKED BY	REVISIONS		

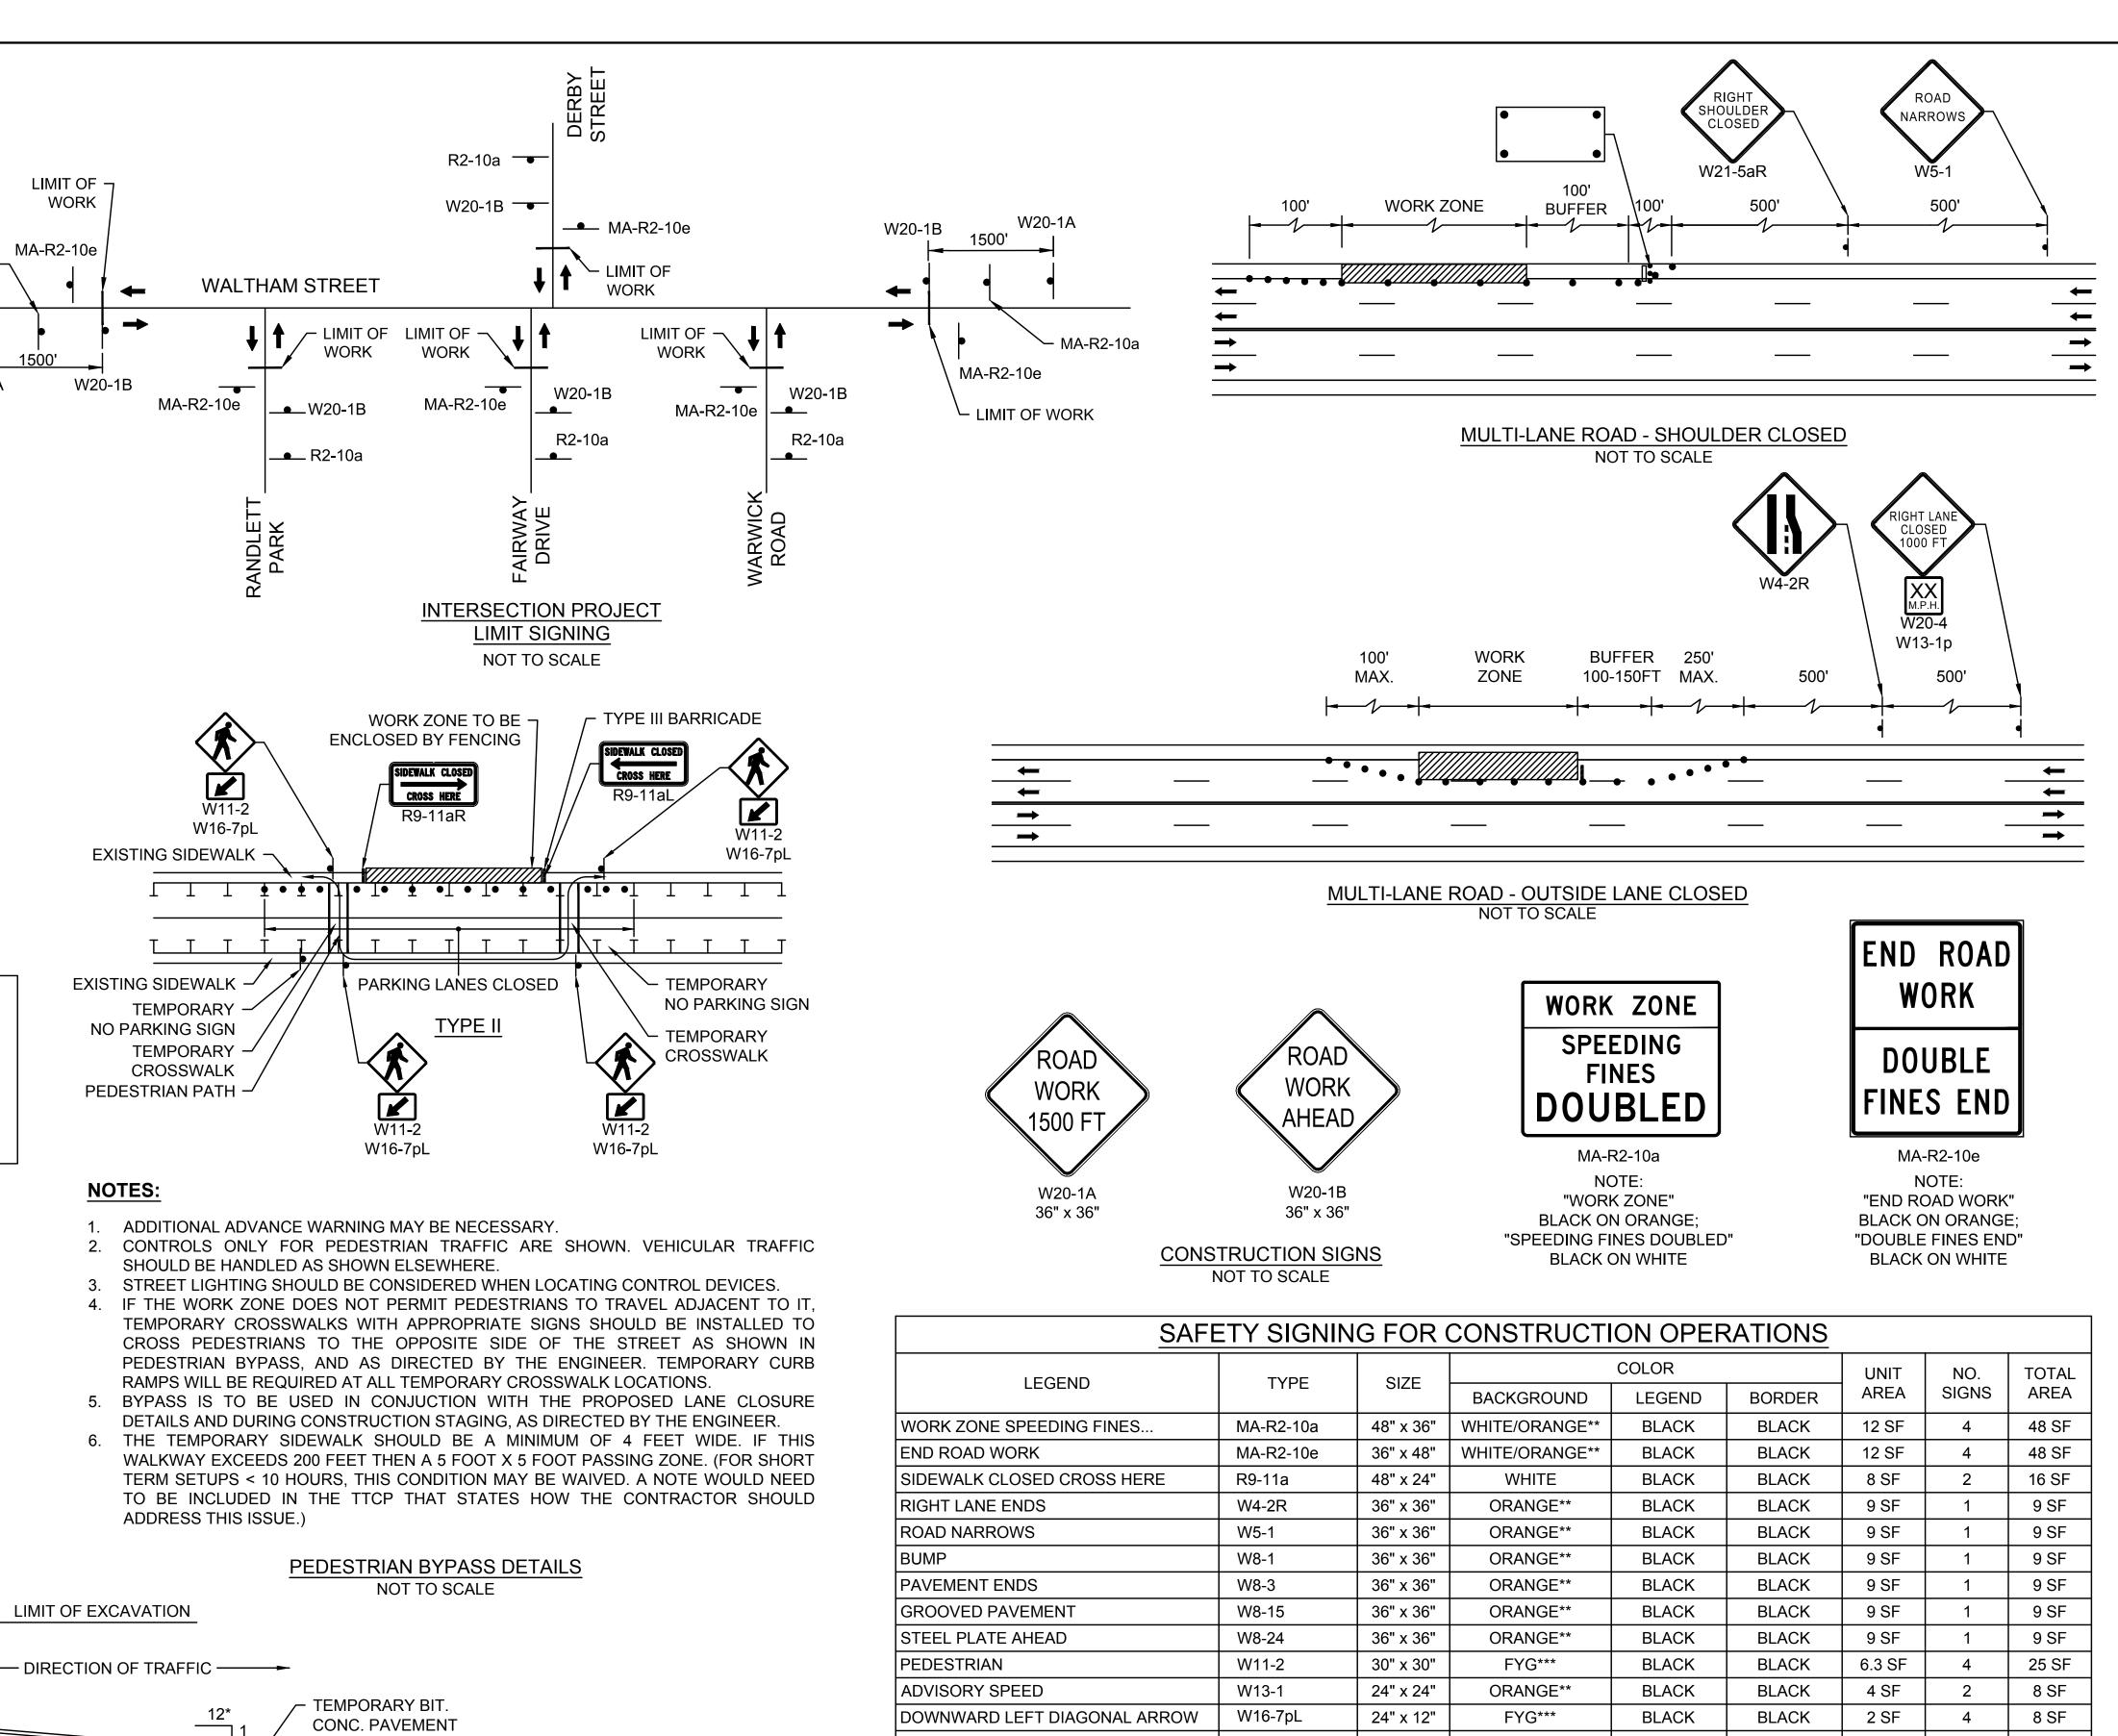

GRAVEL BORROW / SUBBASE

* - INCREASE SLOPE RATIO FOR HIGHER SPEEDS

LONGITUDINAL DROP-OFF DETAIL NOT TO SCALE





SUBCONSULTANT SCALE ITLE NONE ILESS OTHERWISE NOTED OR CHANGED BY REPRODUCTION

W21-5aR 36" x 36" ORANGE** * NO. OF SIGNS ARE ESTIMATED FOR BIDDING PURPOSES ONLY

** ALL CONSTRUCTION SIGNAGE SHALL HAVE FLUORESCENT ORANGE BACKGROUND

36" x 36"

36" x36"

36" x 36"

*** FLUORESCENT YELLOW GREEN

W20-1A

W20-1B

W20-5R

ROAD WORK 1500 FT

ROAD WORK AHEAD

RIGHT LANE CLOSED 1000 FT

RIGHT SHOULDER CLOSED

Traffic Calming at Intersection of Waltham Street / Derby Street / Fairway Drive

ORANGE*

ORANGE*

ORANGE**

BLACK

BLACK

BLACK

BLACK

TEMPORARY TRAFFIC CONTROL PLAN

Newton, MA

BETA JOB NO.

8/15/2019 ISSUE DATE -

2

6

1

5472 09

18 SF

54 SF

9 SF

9 SF

297 SF

SHEET NO.

9 SF

9 SF

9 SF

9 SF

TOTAL AREA OF SIGNS:

BLACK

BLACK

BLACK

BLACK

12 of 12