

336 Cabot Street

Newton, Massachusetts

Owner: Dalfior Development

Permit Set Issued - 10/28/2021 - Issued for Revision: 03/30/2022


Modifications from the original set dated 10/28/2021 included in this drawing set:

1. Extensive refinement of exterior materials and window configurations.
2. Interior reconfiguration of unit layout and new rear addition with bedrooms proposed on level 2.
3. Existing level 3 attic space to remain unchanged.

ELEVATION TARGET



INTERIOR ELEVATION TARGET

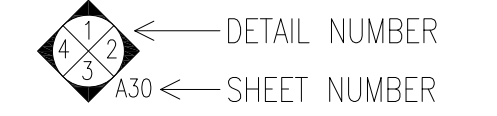

DETAIL TARGET



WINDOW TARGET



GENERAL NOTES:

1. ALL WORK SHALL COMPLY WITH STATE, NATIONAL CODES, REGULATIONS AND RESTRICTIONS WHICH APPLY TO THIS PROJECT.
2. THE CONTRACTOR SHALL VISIT THE SITE AND BE KNOWLEDGEABLE OF CONDITIONS THEREON. THE CONTRACTOR SHALL INVESTIGATE, VERIFY AND BE RESPONSIBLE FOR ALL CONDITIONS OF THE PROJECT AND SHALL NOTIFY THE ARCHITECT OF ANY CONDITIONS REQUIRING MODIFICATION BEFORE PROCEEDING WITH THE WORK.
3. THE CONTRACTOR IS RESPONSIBLE FOR OBTAINING AND POSTING ALL NECESSARY VALID CONSTRUCTION PERMITS FROM ALL LOCAL, STATE AND FEDERAL AUTHORITIES HAVING JURISDICTION PRIOR TO THE START OF ON-SITE CONSTRUCTION.
4. THE CONTRACTOR SHALL KEEP ALL BUILDING MEANS OF EGRESS CLEAR OF ANY OBSTRUCTIONS AT ALL TIMES. THE GENERAL CONTRACTOR MUST COORDINATE WITH THE BUILDING FACILITIES MANAGER ALL ACTIVITIES INCLUDING, BUT NOT LIMITED TO WORK WHICH WILL GENERATE EXCESSIVE NOISE AND MODIFICATION TO UTILITIES. WORK MUST NOT INTERFERE WITH EXISTING SMOKE DETECTORS, ALARMS OR BUILDING SYSTEM MANAGEMENT
- 5.1. THE GENERAL CONTRACTOR SHALL REVIEW AND BE FAMILIAR WITH ANY TENANT DESIGN AND CONSTRUCTION MANUAL AND ANY OTHER BUILDING OWNER OR BUILDING STANDARDS.
6. THE CONTRACTOR IS SOLELY RESPONSIBLE FOR ALL CONSTRUCTION ACTIVITIES, MATERIALS, MEANS AND METHODS. THE CONTRACTOR IS TO COORDINATE ALL SUBCONTRACTORS TO COMPLETE THE FULL SCOPE OF WORK AS INDICATED IN THE CONSTRUCTION DOCUMENTS.
- 6.1. THE CONTRACTOR IS SOLELY RESPONSIBLE FOR PROPERLY LAYING OUT THE WORK AND FOR ALL LINES AND MEASUREMENTS FOR THE WORK.
- 6.2. BUILDING OR SITE COMPONENTS WHICH ARE AFFECTED OR DAMAGED BY THE WORK SHALL BE REPLACED OR RESTORED TO ORIGINAL CONDITION AND COLOR, OR AS APPROVED BY THE OWNER.
- 6.3. WHERE THE DESIGN INTENT CANNOT BE DETERMINED FROM THE DRAWINGS, CONSULT THE ARCHITECT BEFORE PROCEEDING WITH THE WORK. (312) 780-9456
7. THE CONTRACTOR SHALL VERIFY THE DIMENSIONS SHOWN ON THE DRAWINGS BEFORE LAYING OUT THE WORK, AND SHALL BE HELD RESPONSIBLE FOR ANY ERRORS OR INACCURACIES RESULTING FROM FAILURE TO DO SO.
 - 7.1. DETAILS SHOWN ARE INDICATIVE OF THE CHARACTER, PROFILES, MATERIALS AND SYSTEMS REQUIRED FOR THE WORK INCLUDING THOSE CONDITIONS NOT COVERED BY SPECIFIC DETAILS.
 - 7.2. DIMENSIONS SHALL GOVERN, DO NOT SCALE THE DRAWINGS. WHERE THERE APPEARS TO BE A CONFLICT OR WHERE DIMENSIONS CANNOT BE DETERMINED, CONSULT THE ARCHITECT BEFORE PROCEEDING WITH THE WORK.
 - 7.3. ALL DIMENSIONS ARE TO INSIDE FACE OF WALLS.
 - 7.4. UNLESS SHOWN OTHERWISE, ALL DOORS SHALL BE LOCATED SUCH THAT THERE IS A 2 INCH WALL RETURN BETWEEN THE JAMB FRAME AND THE ADJACENT PERPENDICULAR WALL.
8. CONSULT WITH THE ARCHITECT OR ENGINEER BEFORE PENETRATING ANY JOISTS, BEAMS, OR OTHER STRUCTURAL MEMBERS
9. ALL CONSTRUCTION MATERIALS AND EQUIPMENT ARE TO BE STORED NEATLY WITHIN THE SCOPE OF WORK AREA ONLY.
10. ALL MATERIALS AND EQUIPMENT SHALL BE INSTALLED ACCORDING TO MANUFACTURER'S SPECIFICATIONS
 - 10.1. SUBMIT SHOP DRAWINGS AND SAMPLES FOR ALL STEEL, MILLWORK, SIGNAGE, HARDWARE AND INTERIOR FINISHES
 - 10.2. SUBMIT PRODUCT DATA FOR FIXTURES AND HARDWARE
 - 10.3. ALL INTERIOR AND EXTERIOR FINISHES, COLORS AND MATERIALS ARE TO BE SELECTED AND APPROVED BY THE OWNER PRIOR TO CONSTRUCTION
 - 10.4. ALL INTERIOR FINISHES AND FURNISHINGS ARE TO BE CLASS 'A' FIRE RATED AND ARE TO COMPLY WITH MASSACHUSETTS BUILDING CODE AND THE NEWTON FIRE CODE
 - 10.5. ALL WOOD COMPONENTS SHALL BE FIRE TREATED
 - 10.6. CONFIRM THAT ALL MATERIALS AND FINISHES, INCLUDING THEIR FABRICATION AND INSTALLATION WILL NOT RELEASE FUMES OR AROMAS WHICH MAY BE A HAZARD OR NUISANCE TO PERSONNEL
11. THE GENERAL CONTRACTOR SHALL BE RESPONSIBLE FOR ALL PANEL CONTROL AND CIRCUIT DESIGN AND FOR COMPLIANCE WITH ALL BUILDING, LIFE SAFETY, AND STATE AND NATIONAL ELECTRICAL CODES WHICH MAY APPLY
 - 11.1. ALL EXPOSED UTILITY WIRES AND PIPES SHALL BE INSTALLED IN A WAY THAT DOES NOT OBSTRUCT OR PREVENT THE CLEANING OF FLOORS, WALLS AND CEILINGS; THEY SHALL BE INSTALLED A MINIMUM OF 6" OFF OF FLOORS AND 1" OFF OF WALLS, CEILINGS OR ADJACENT PIPES OR WIRES
12. WHERE APPROPRIATE, EXISTING SPRINKLER HEADS ALARM SYSTEM AND DETECTORS ARE TO REMAIN. MODIFY LOCATIONS ONLY WHERE CEILING IS ALTERED OR AS INDICATED ON FIRE PROTECTION DRAWINGS.
13. EQUIPMENT INFORMATION AND SPECIFICATIONS, INCLUDING EQUIPMENT SUPPLIED BY THE OWNER, ARE TO BE THE MOST CURRENT AT THE TIME OF DOCUMENTATION PREPARATION.
 - 13.1. THE GENERAL CONTRACTOR SHALL BE RESPONSIBLE FOR VERIFYING THE EXACT DIMENSIONS AND EQUIPMENT CONNECTION REQUIREMENTS.
 - 13.2. MAKE ALL FINAL CONNECTIONS, INSTALL THE SET UP IN WORKING ORDER, CHECK WARRANTIES, TEST AND NOTE VOID WARRANTIES.
 - 13.3. COORDINATE WITH THE OWNER DELIVERY, STORAGE AND INSTALLATION OF ALL EQUIPMENT, INCLUDING THAT SUPPLIED BY THE OWNER.
14. PROVIDE ALL TEMPORARY FACILITIES AND SERVICES, CONSTRUCTION AND SUPPORT FACILITIES AND SECURITY AND PROTECTION AS NEEDED TO PROTECT NEW AND EXISTING CONSTRUCTION FOR THE DURATION OF THE WORK
15. ALL MATERIALS AND WORKMANSHIP SHALL BE GUARANTEED FOR A PERIOD OF ONE YEAR FROM THE DATE OF FINAL ACCEPTANCE UNLESS OTHERWISE SPECIFIED FOR A LONGER PERIOD OF TIME FOR A CERTAIN ITEM
16. SEAL AND CAULK AROUND ALL PENETRATIONS, CRACKS AND CREVICES AND ANY OPENINGS CAPABLE OF HARBORING INSECTS OR RODENTS
17. EMPLOY EXPERIENCED WORKERS FOR FINAL CLEANING. CLEAN TO COMMERCIAL BUILDING PROGRAM STANDARDS
 - 17.1. DISPOSE OF ALL WASTE AND DEBRIS OFF THE PREMISES



1 LOCATION PLAN
SCALE: NOT TO SCALE

APPLICABLE CODES:

1. BUILDING CODE: CMR 780 MASSACHUSETTS STATE BUILDING CODE, 9TH EDITION (AMENDED INTERNATIONAL BUILDING CODE 2015, INTERNATIONAL RESIDENTIAL CODE 2015 AND THE 2015 INTERNATIONAL EXISTING BUILDING CODE W/ MASSACHUSETTS AMENDMENTS)
2. ACCESSIBILITY: MASSACHUSETTS ARCHITECTURAL ACCESS BOARD CMR 521 AND UNIFORM FEDERAL ACCESSIBILITY STANDARDS
3. FIRE PROTECTION: MASSACHUSETTS COMPREHENSIVE FIRE SAFETY CODE CMR 527 1.00 - 2012 NFPA 1: FIRE CODE WITH AMENDMENTS
4. ELECTRICAL: 527 CMR 12.00 MASSACHUSETTS ELECTRICAL CODE - 2014 NFPA 70 NATIONAL ELECTRICAL CODE WITH AMENDMENTS
5. MECHANICAL: INTERNATIONAL MECHANICAL CODE 2015 W/ AMENDMENTS
6. PLUMBING: 248 CMR BOARD OF STATE EXAMINERS OF PLUMBERS AND GAS FITTERS - UNIFORM STATE PLUMBING CODE
7. ENERGY: INTERNATIONAL ENERGY CONSERVATION CODE 2018 (IECC)
8. AMERICANS WITH DISABILITIES ACT
9. NEWTON ZONING CODE
10. MGL CH. 148 SECTION 26G

BUILDING DESCRIPTION:

245 SF ADDITION TO EXISTING TWO UNIT BUILDING. FINISHING BASEMENT, ADDING FULL BATH TO THIRD FLOOR AND CHANGING FLOOR PLANS ON LEVELS 1 AND 2 - MOVING ALL BEDROOMS TO LEVEL 2 AND LIVING ON LEVEL 1. PARKING TO REMAIN AS EXISTING.

CODE SUMMARY:


1. PROPOSED USE OR OCCUPANCY: RESIDENTIAL - R-3
 - 1.1 OCCUPANT LOAD: (200 GROSS SF/PERSON PER TABLE 1004.1.2) APPROX. 3571 SF = 17 PERSONS
2. CONSTRUCTION TYPE: V.B. - TABLE 504.4
 - 2.1 PER TABLE 601: STRUCTURAL FRAME, BEARING WALLS, FLOORS AND ROOF ARE NOT REQUIRED TO BE RATED
 - 2.2 MAX. AREA IS UNLIMITED PER TABLE 506 AND MAXIMUM HEIGHT IS 3 STORIES ABOVE GRADE - 504.4
3. PER 1006.3.3 FOR USE GROUP R-3 - ONLY ONE EXIT IS REQUIRED
4. MINIMUM WIDTH OF EGRESS STAIR: 36 INCHES PER SECTION 1011.2
5. MAXIMUM LENGTH OF EXIT TRAVEL: 200 FEET PER 1017.2
6. FIRE RATED CONSTRUCTION:
 - 6.1 PER TABLE 602, IN V.B CONSTRUCTION EXTERIOR WALLS MORE THAN 10' FROM PROPERTY LINE ARE NOT REQUIRED TO BE RATED, 10' OR LESS MUST BE 1 HOUR RATED.
 - 6.2 DEMISING PARTITION/CORRIDORS MUST BE 1 HOUR IN A TYPE V.B BUILDING 420.2 AND 708.3
 - 6.3 HORIZONTAL SEPARATION BETWEEN DWELLING UNITS: 1 HOUR IN A TYPE V.B BUILDING PER 420 AND 711.2.4.3 - REFER TO DETAIL ON A-20
 - 6.4 STAIRWAYS CONNECTING 4 OR MORE STORIES ARE TO BE 2 HOUR RATED, STAIRS CONNECTING LESS THAN 4 STORIES ARE TO BE 1 HOUR RATED PER 1023.2
 - 6.5 PER TABLE 716.5: 1 HOUR ENCLOSURES AND EXIT ACCESS SHALL HAVE 1 HOUR DOORS. 1 HOUR AND 1/2 HOUR CORRIDORS SHALL HAVE A MINIMUM 20 MIN. RATED DOOR. 2 HOUR ENCLOSURES AND EXIT ACCESS SHALL HAVE 90 MINUTE RATED DOORS.
7. DEMISING PARTITION MINIMUM: STC 50 PER SECTION 1207.2
8. ACCESSIBILITY REQUIREMENTS:
 - 8.1 CMR 521 9.3 - EXISTING BUILDINGS RENOVATED FOR RESIDENTIAL USE ARE EXEMPT FROM MAAB REQUIREMENTS PER 521 CMR; ARCHITECTURAL ACCESS BOARD, PARAGRAPH 9.2.1

ENERGY REQUIREMENTS:

- MASSACHUSETTS ENERGY STRETCH CODE, CHAPTER 4 - RESIDENTIAL ENERGY EFFICIENCY - RESIDENTIAL BUILDINGS, INTERNATIONAL ENERGY CONSERVATION CODE (IECC) 2018
1. CLIMATE ZONE 5H PER TABLE 301.1
 2. EXISTING WALLS AND CEILINGS: FILL EXISTING WALL AND CEILING CAVITIES WITH INSULATION PER IECC 503.1.1
 3. PER IECC TABLES 402.1.2 AND R402.1.4, FENESTRATION SHALL HAVE A U-FACTOR OF 0.30 OR BETTER.
 4. SKYLIGHTS SHALL HAVE A U-FACTOR OF 0.55 OR BETTER PER 402.1.2 AND 402.1.4.
 5. VAPOR RETARDER IS REQUIRED TO COMPLY WITH R402.1.1 OF THE IECC AND R702.7 OF THE INTERNATIONAL RESIDENTIAL CODE. VAPOR RETARDER IS NOT REQUIRED IN BASEMENT OR BELOW GRADE WALLS.
 6. R402.1.2 - CEILING: R=49; WOOD FRAME WALL: R=20 OR 13(CAVITY)+5(CONTINUOUS); FLOOR R=30; BASEMENT WALLS AND CRAWL SPACES: R=15 CONTINUOUS OR R=19 IN CAVITY OR R=13 IN CAVITY WITH R=5 CONTINUOUS; SLAB R=10
 7. DEMAND RECIRCULATION WATER SYSTEMS SHALL HAVE CONTROLS THAT COMPLY WITH REQUIRED CODES
 8. HOT WATER PIPES IN UNCONDITIONED SPACES SHALL ALL BE INSULATED TO AT LEAST R-3, AND HOT WATER PIPES IN CONDITIONED SPACES 3/4" AND LARGER SHALL BE INSULATED TO AT LEAST R-3.

| ZONING ANALYSIS: | SR2 | PROPOSED | COMMENTS |
|---------------------------------------|-----------|-----------------|---------------------------------|
| LOT AREA MIN. | 10000 SF | 9817 SF | UNCHANGED |
| MIN. LOT WIDTH | 50' | 65' | UNCHANGED; |
| MIN. LOT FRONTAGE | 80' | 65' | UNCHANGED |
| MAX. BUILDING HEIGHT (STORIES/HEIGHT) | 2.5 / 36' | 2.5 / 33' 11" | UNCHANGED; |
| MAX. FLOOR AREA RATIO | .38 | 0.38 | BASEMENT AND ATTIC NOT INCLUDED |
| MIN. FRONT YARD SETBACK | 25' | 25' | UNCHANGED; |
| MIN. SIDE YARD SETBACK | 7.5' | 7.5' | UNCHANGED |
| MIN. REAR YARD SETBACK | 15' | 70' | UNCHANGED |
| OPEN SPACE REQUIREMENT | 70% | 7310 SF (74.5%) | |
| PARKING REQUIREMENT | 2/UNIT | 2/UNIT | UNCHANGED |

- LIST OF DRAWINGS**
- A-01 ANALYSIS, DRAWING LIST AND NOTES
 - A-10 PROPOSED PLANS
 - A-11 PROPOSED PLANS
 - A-12 FAR DIAGRAM
 - A-20 PROPOSED SECTION
 - A-21 STAIR DETAILS
 - A-30 PROPOSED ELEVATIONS
 - A-31 PROPOSED ELEVATIONS
 - A-32 ELEVATION AREA DIAGRAM
 - E-40 PROPOSED ELECTRICAL PLANS
 - E-41 PROPOSED ELECTRICAL PLANS
 - X-A1 EXISTING PLANS
 - X-A2 EXISTING PLANS
 - X-A3 EXISTING ELEVATIONS

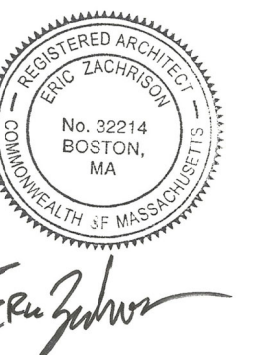

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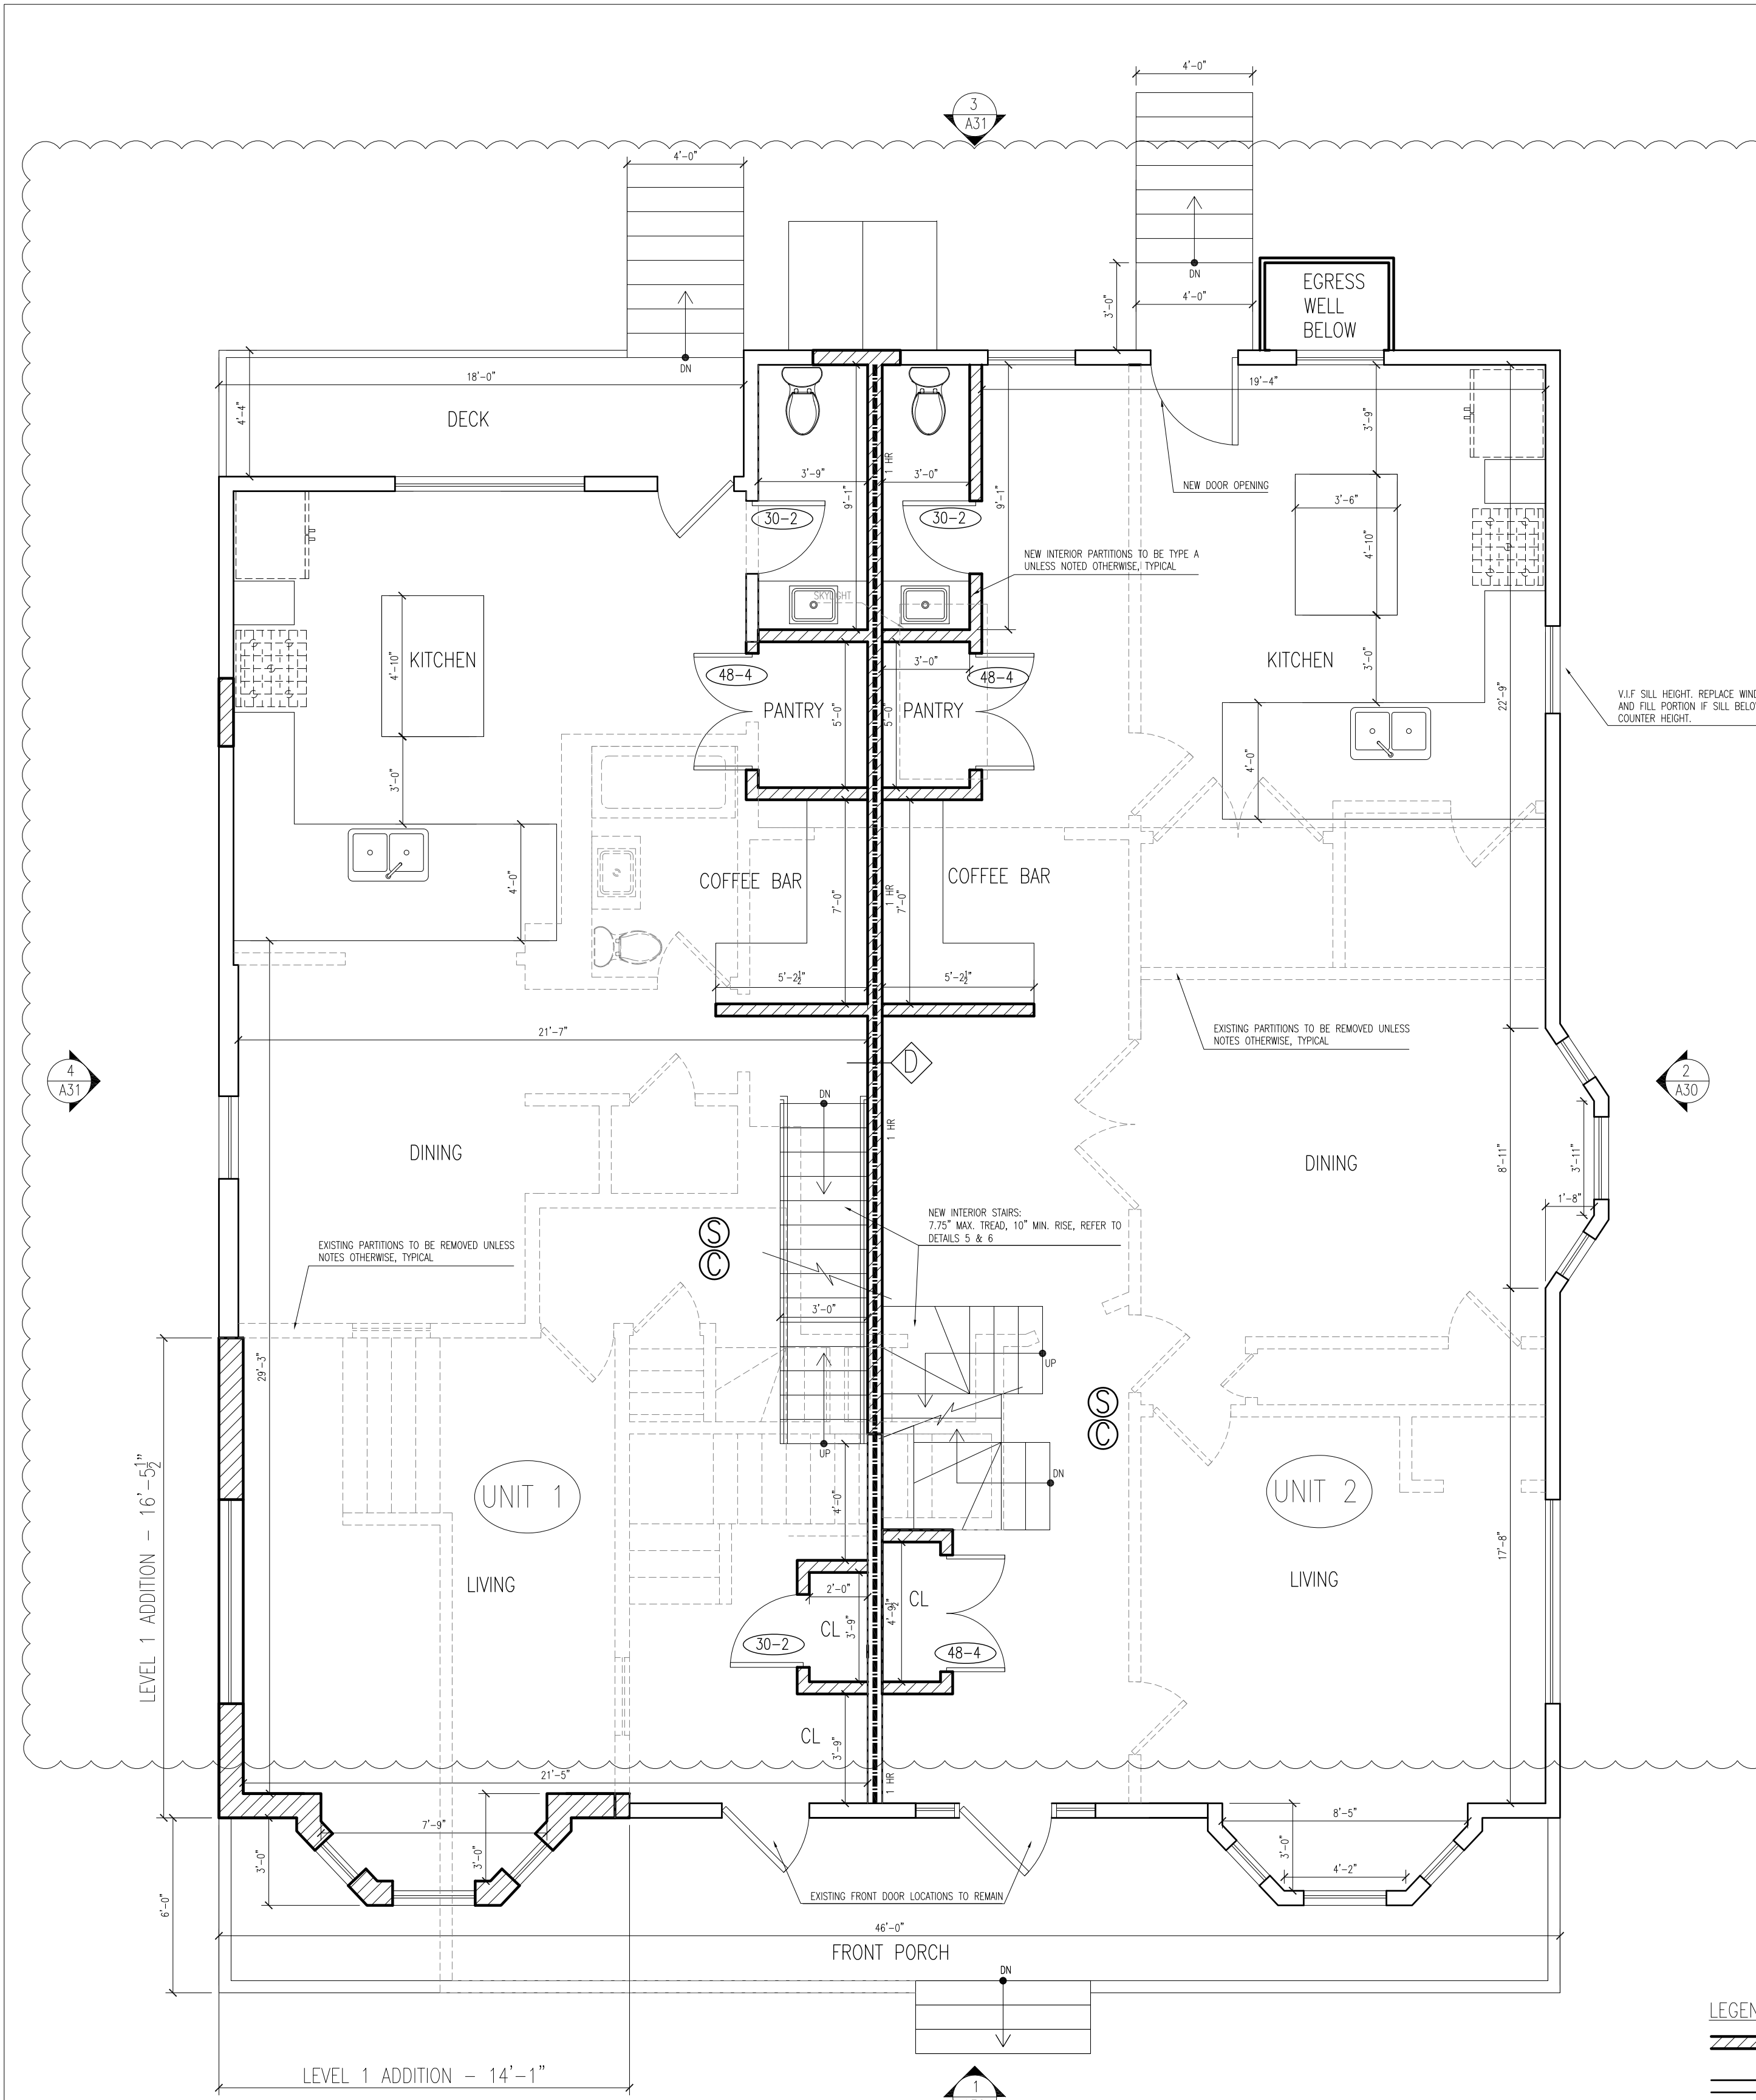
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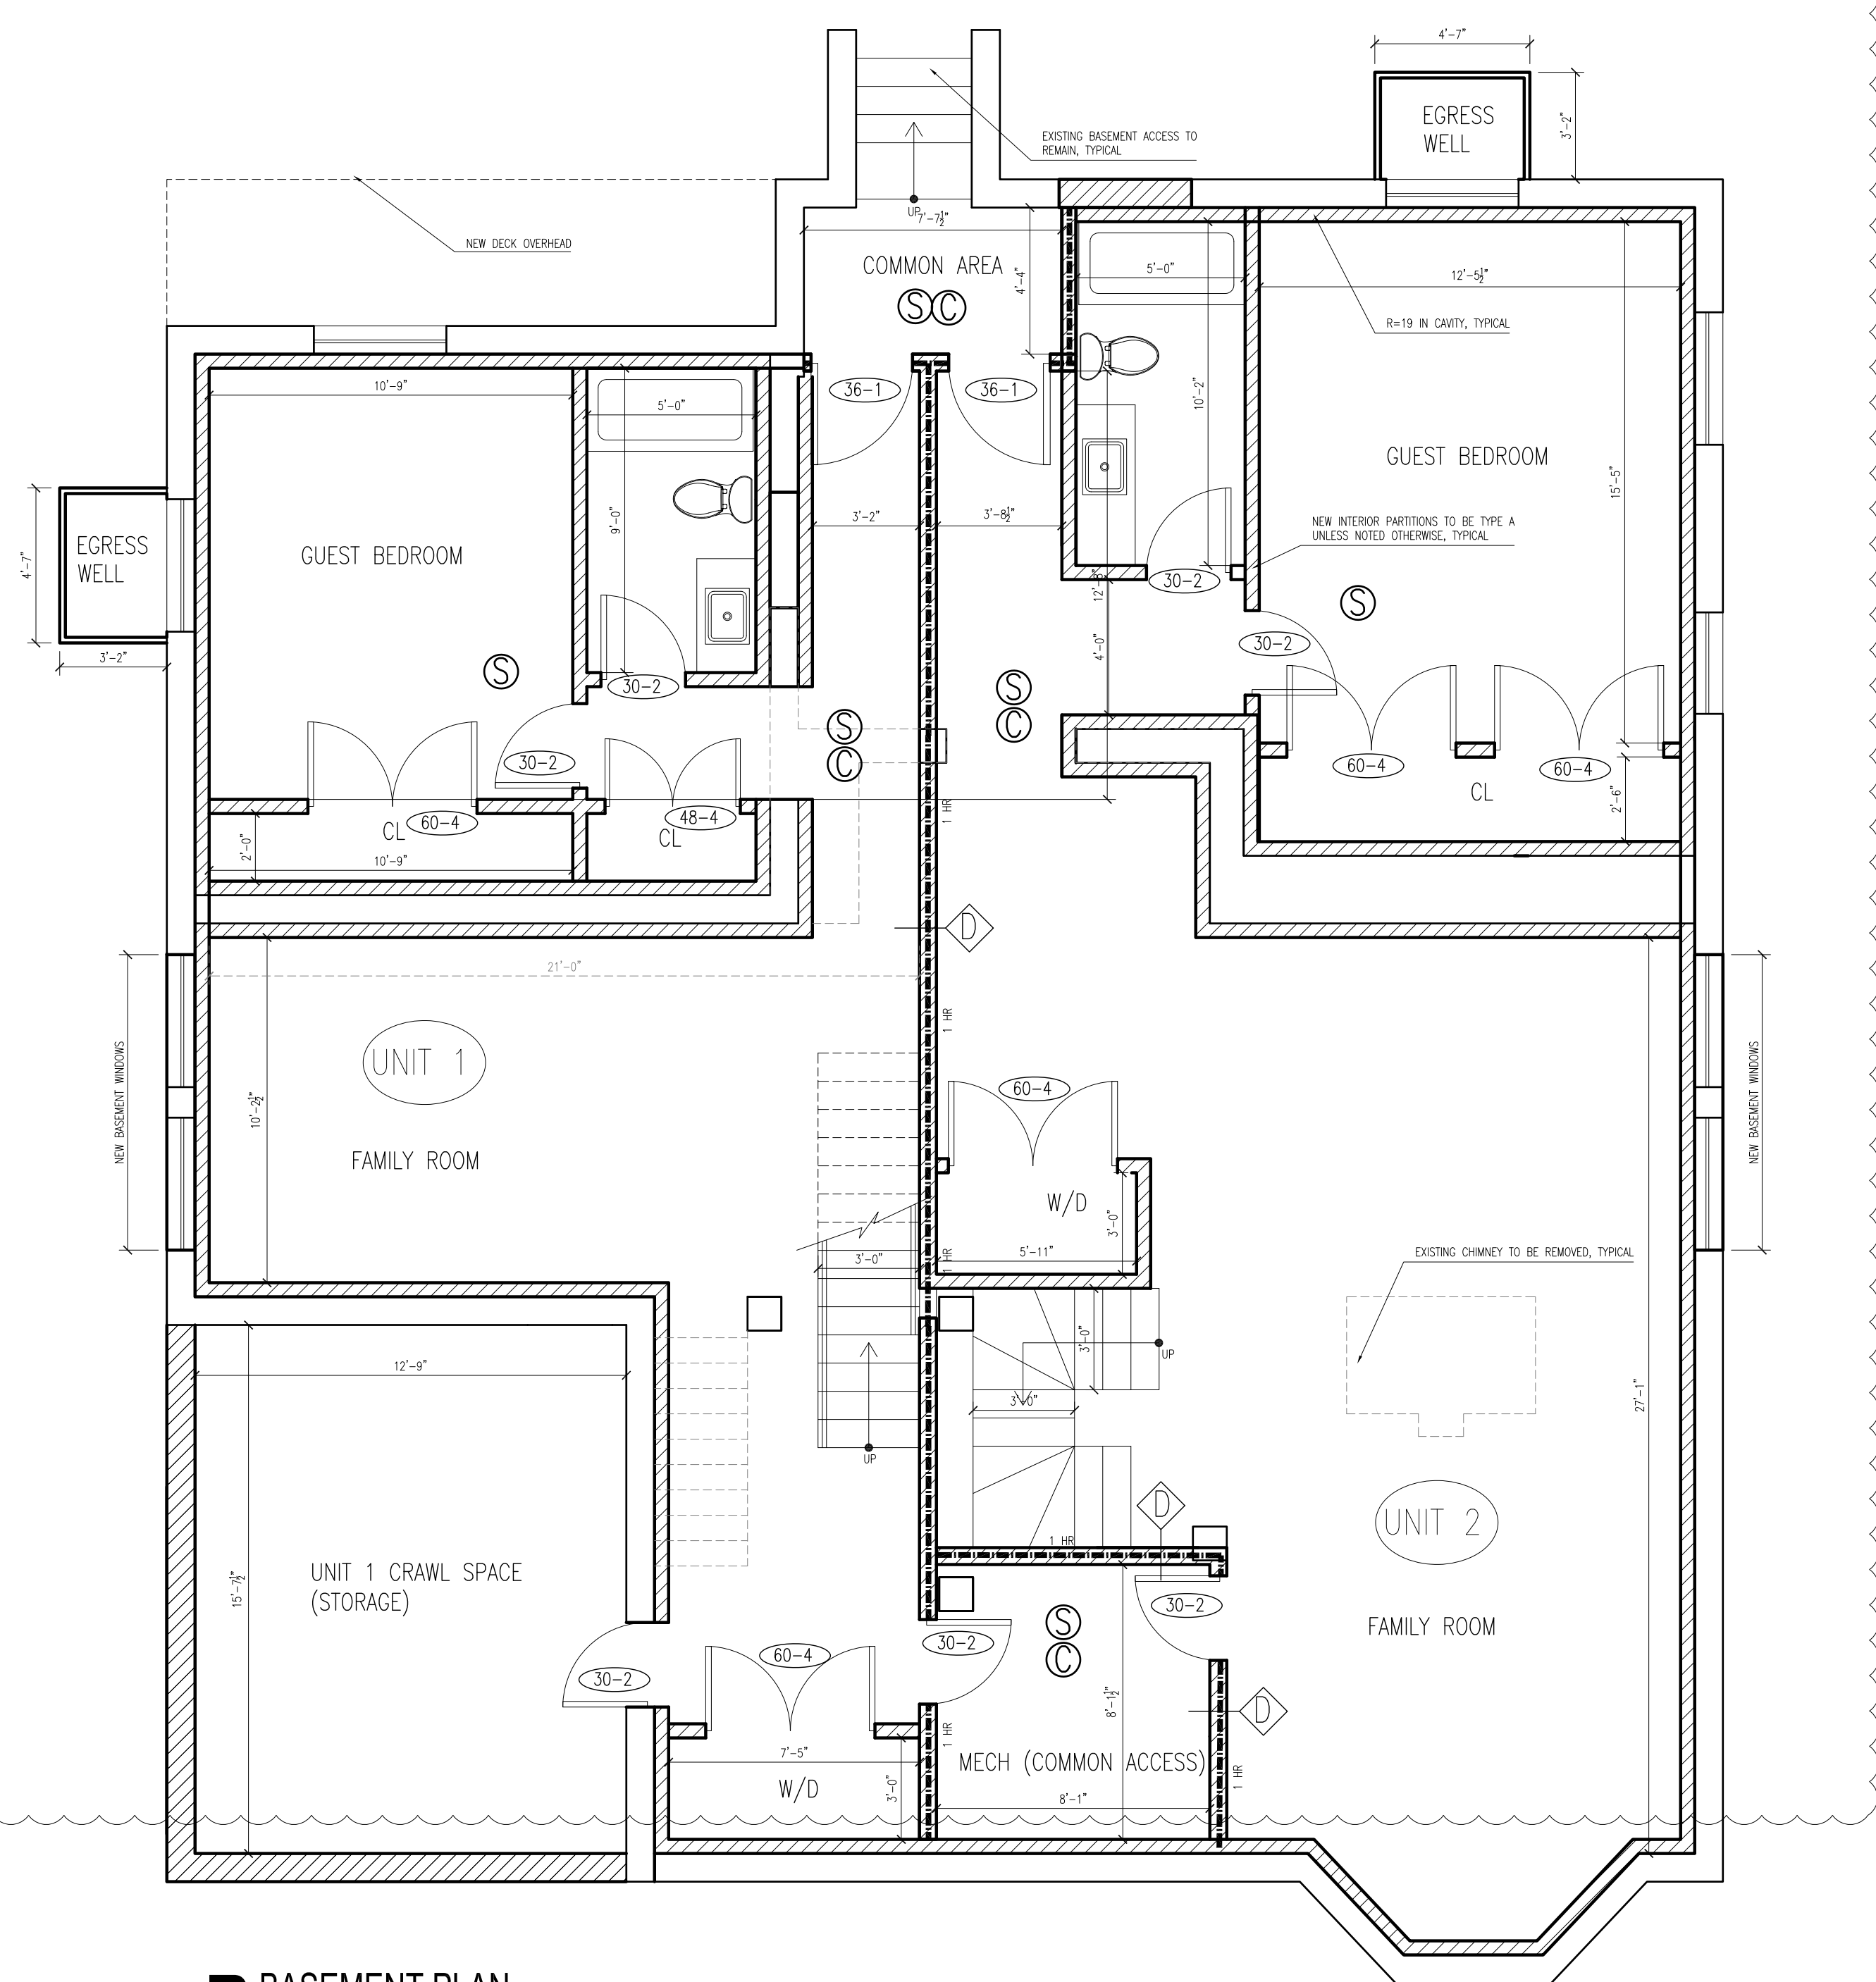
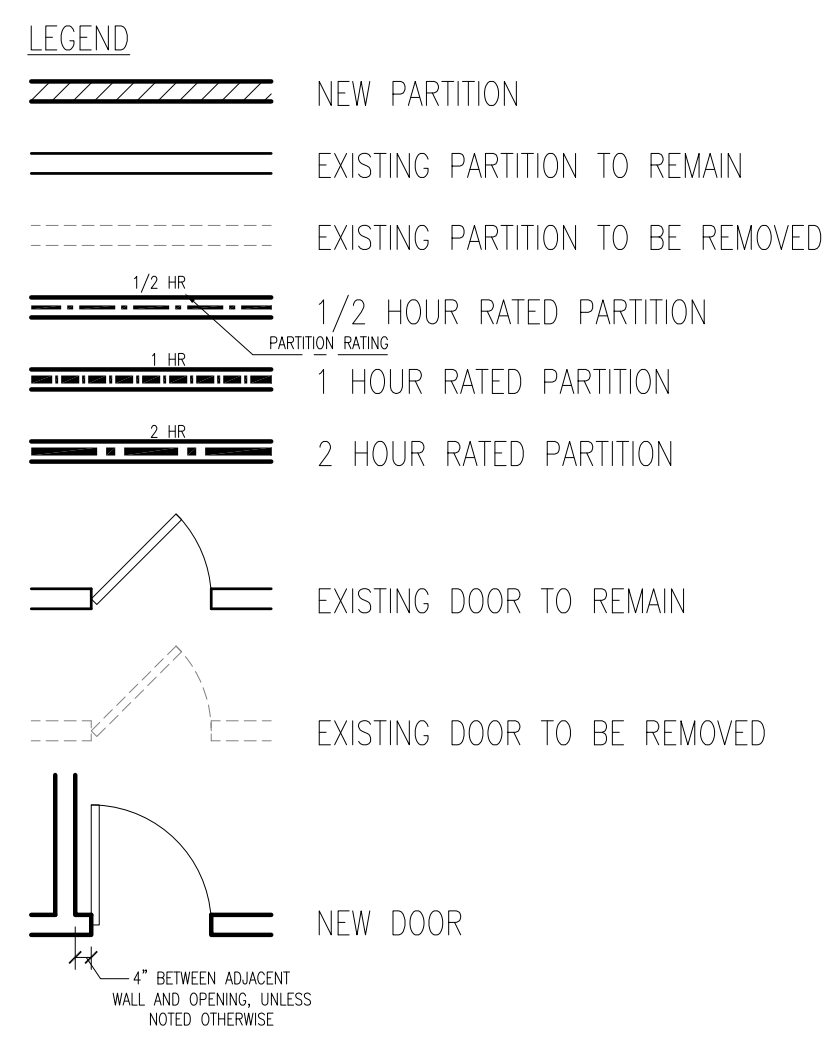
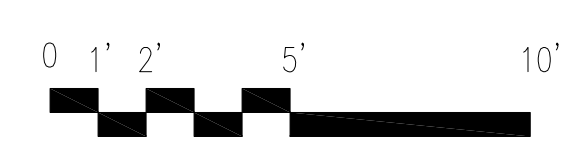
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Project No.: 0--- **Checked by:** EZ

A-01





1 LEVEL 1 PLAN
SCALE: 1/4" = 1'-0"

- Ⓢ SMOKE DETECTOR, HARDWIRED AND INTERCONNECTED
- ⓐ CARBON MONOXIDE DETECTOR, HARDWIRED AND INTERCONNECTED
- Ⓜ HEAT DETECTOR, HARDWIRED AND INTERCONNECTED
- ⓐ WALL TYPE, REFER TO DRAWING A-01



B BASEMENT PLAN
SCALE: 1/4" = 1'-0"

- FINISH NOTES:**
- ALL WALLS TO BE PAINTED GWB, (WHITE TO MATCH ARCHITECT'S SAMPLE)
 - FLOORS TO BE HARDWOOD UNLESS NOTED OTHERWISE.
- DOOR NOTES:**
- ALL NEW DOORS TO BE 6'-8" HIGH, 1 3/4" THICK SOLID CORE WOOD DOORS WITH WOOD FRAMES.
 - INTERIOR DOORS ARE TO BE PAINTED WHITE, CONFIRM EXTERIOR DOOR COLOR AND FINISH WITH OWNER AND ARCHITECT
 - DOOR TARGETS: — DOOR WIDTH

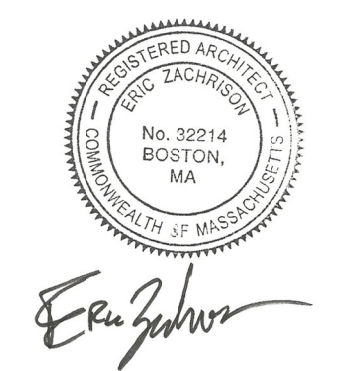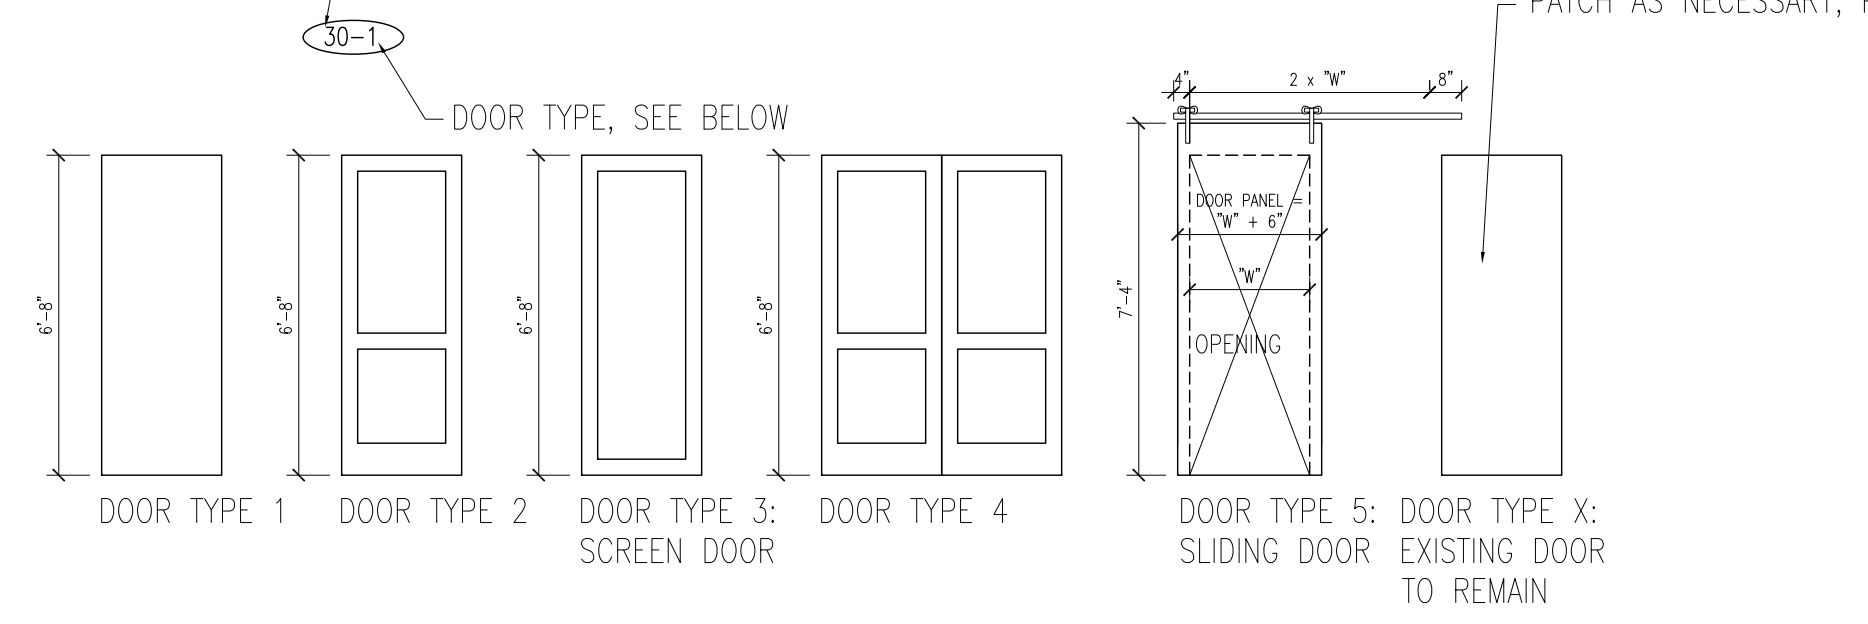



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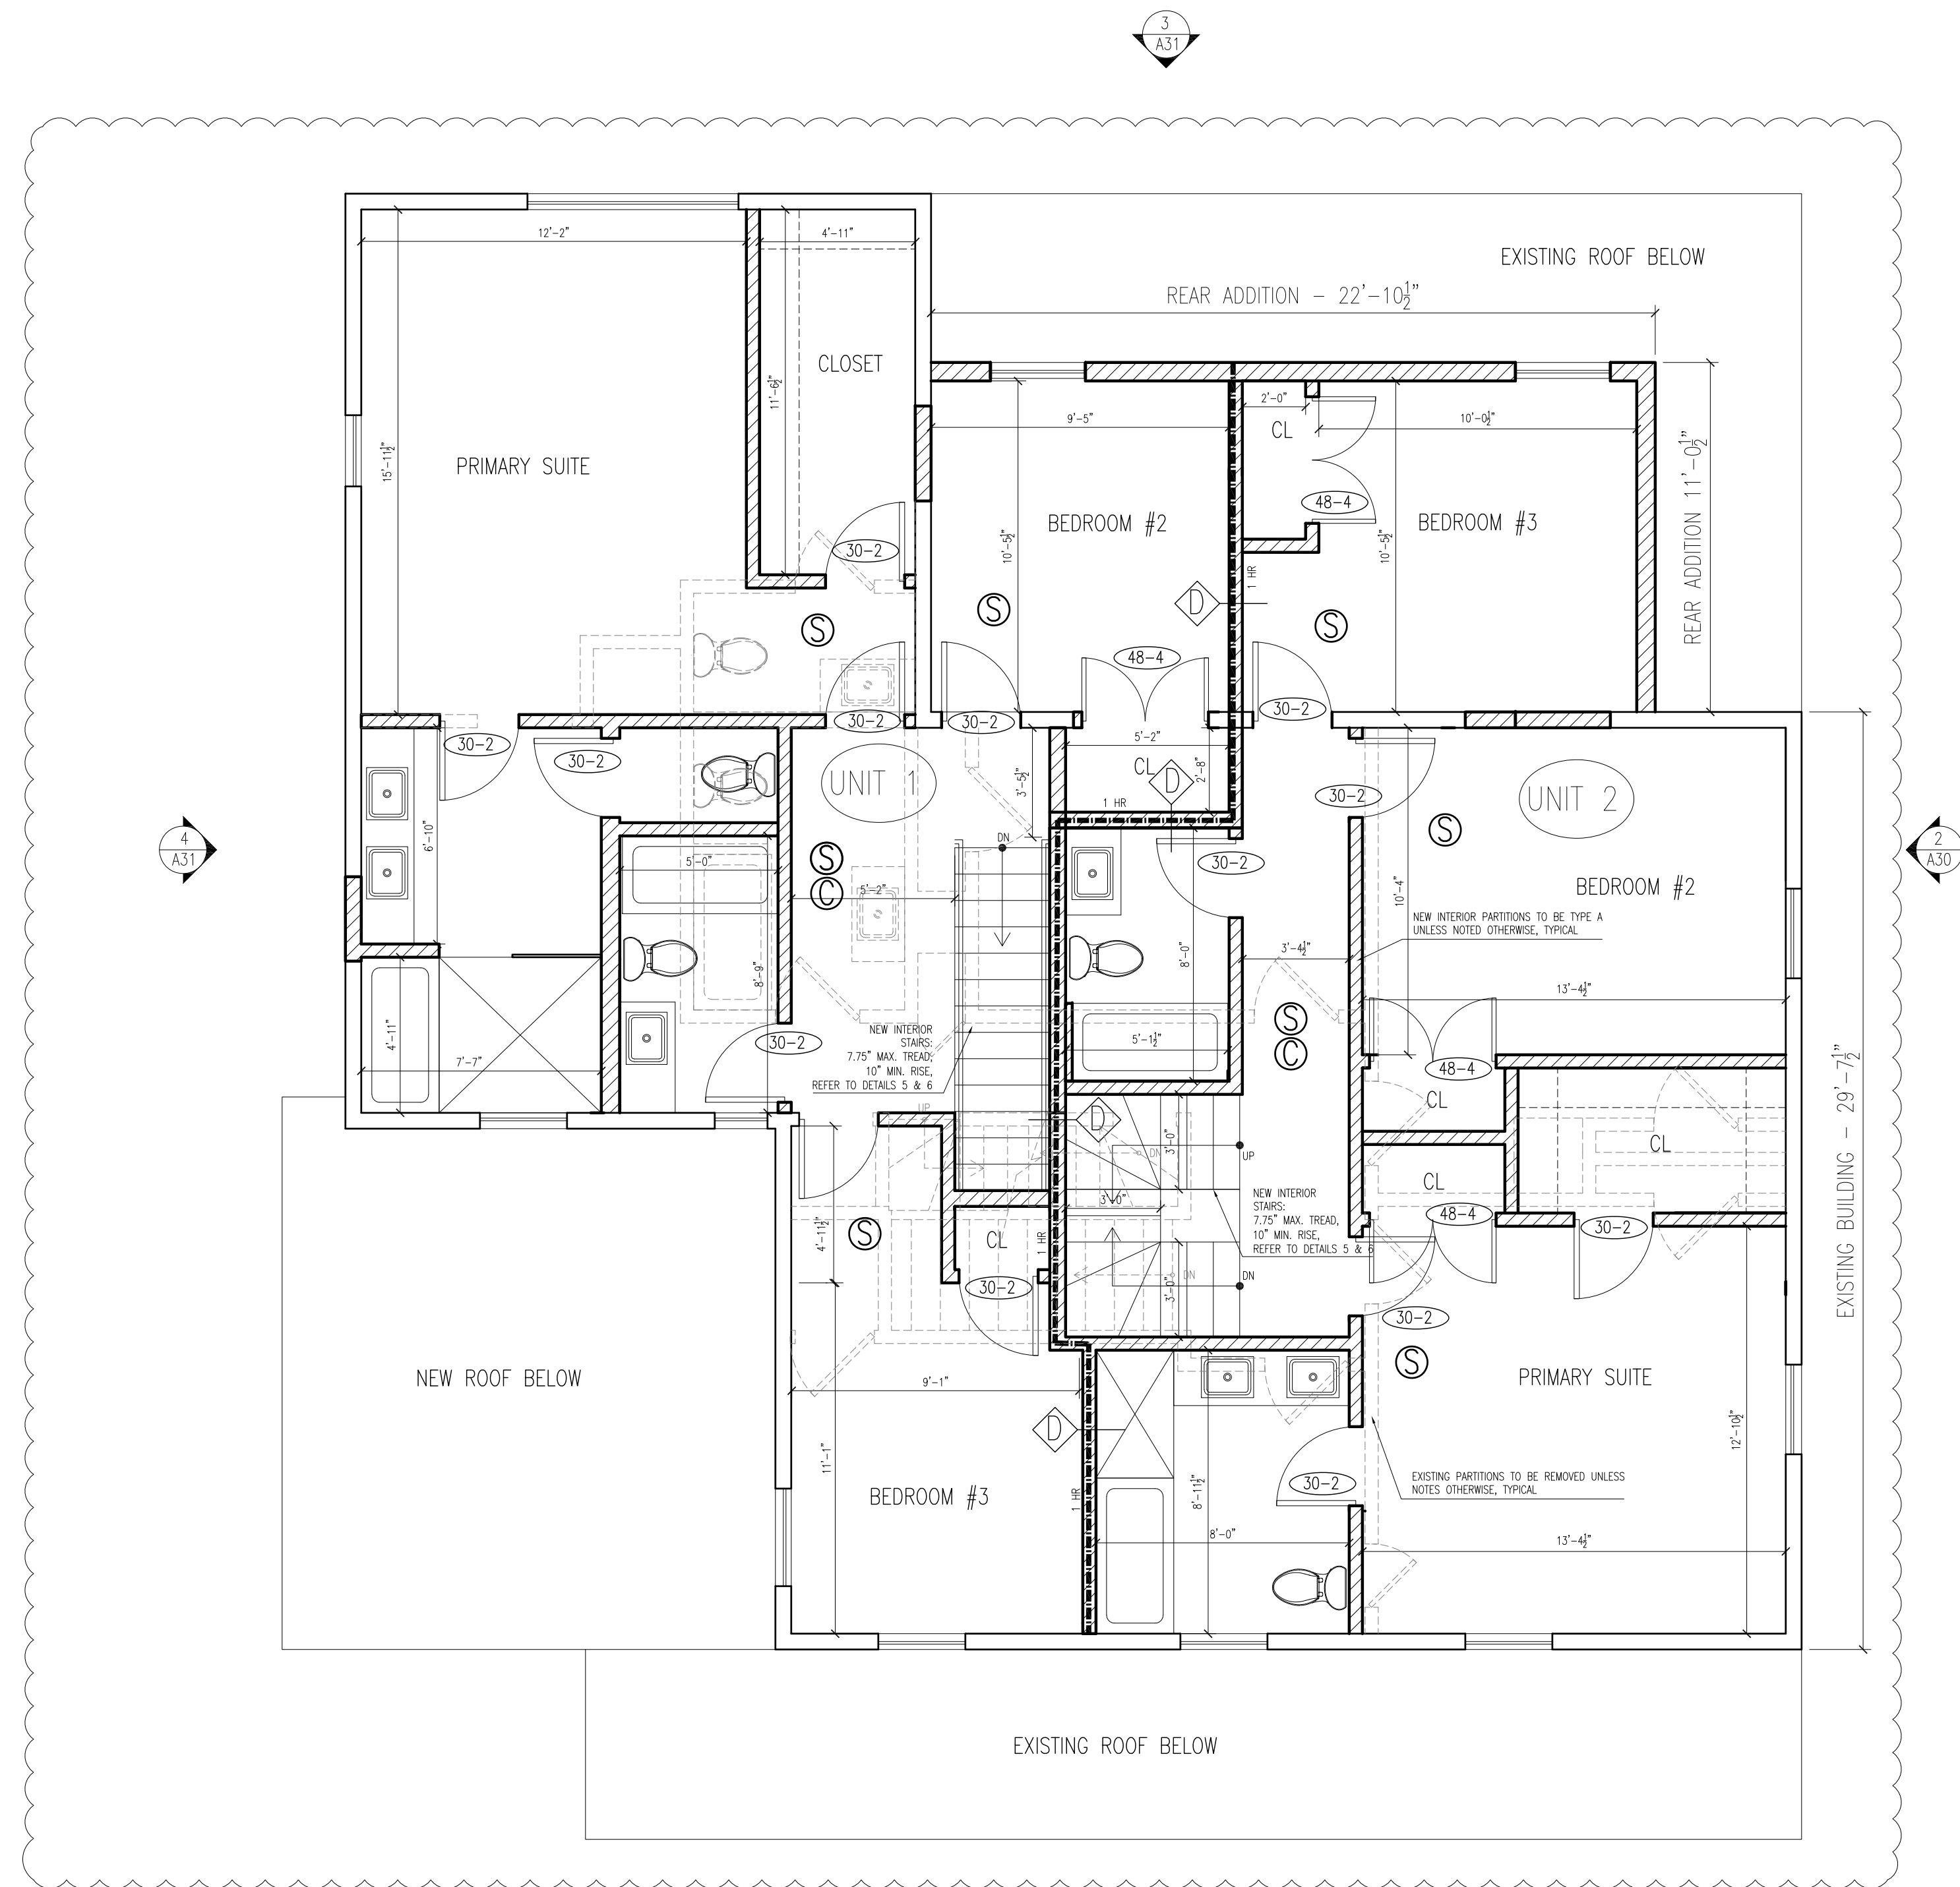
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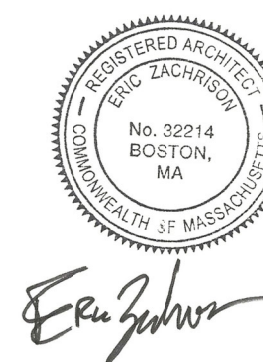
A-10



3 LEVEL 3 PLAN
SCALE: 1/4" = 1'-0"



2 LEVEL 2 PLAN
SCALE: 1/4" = 1'-0"

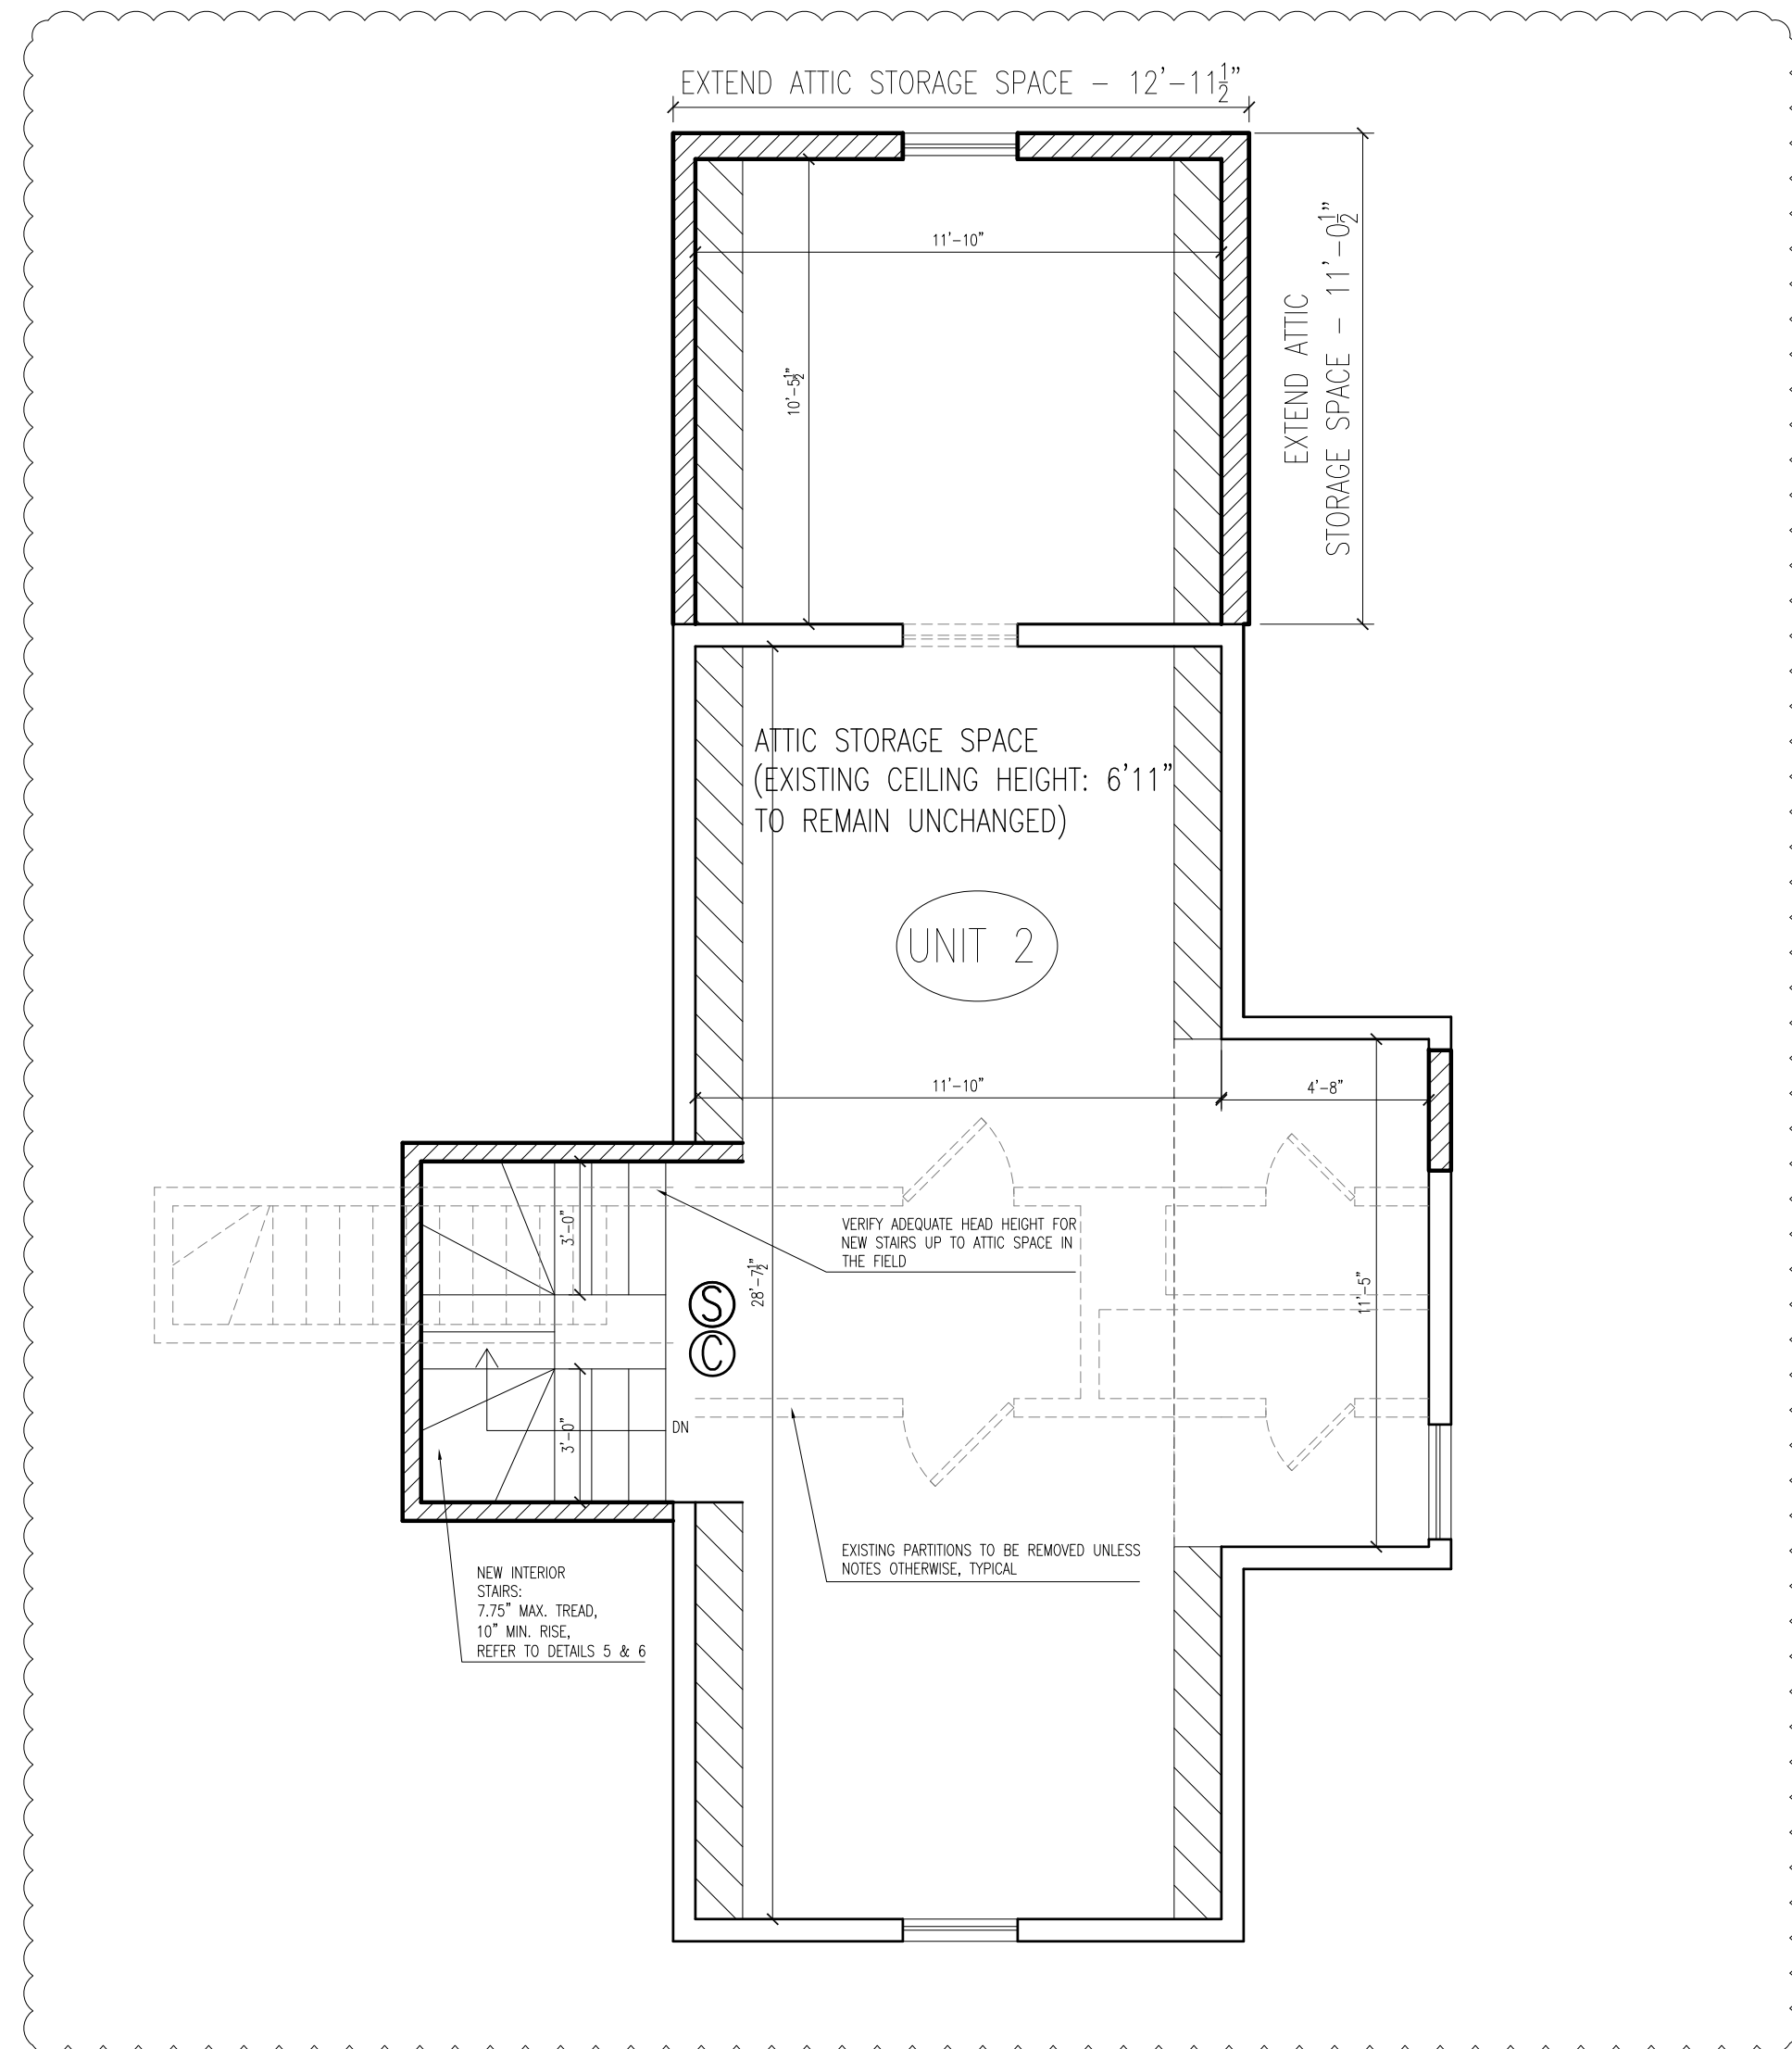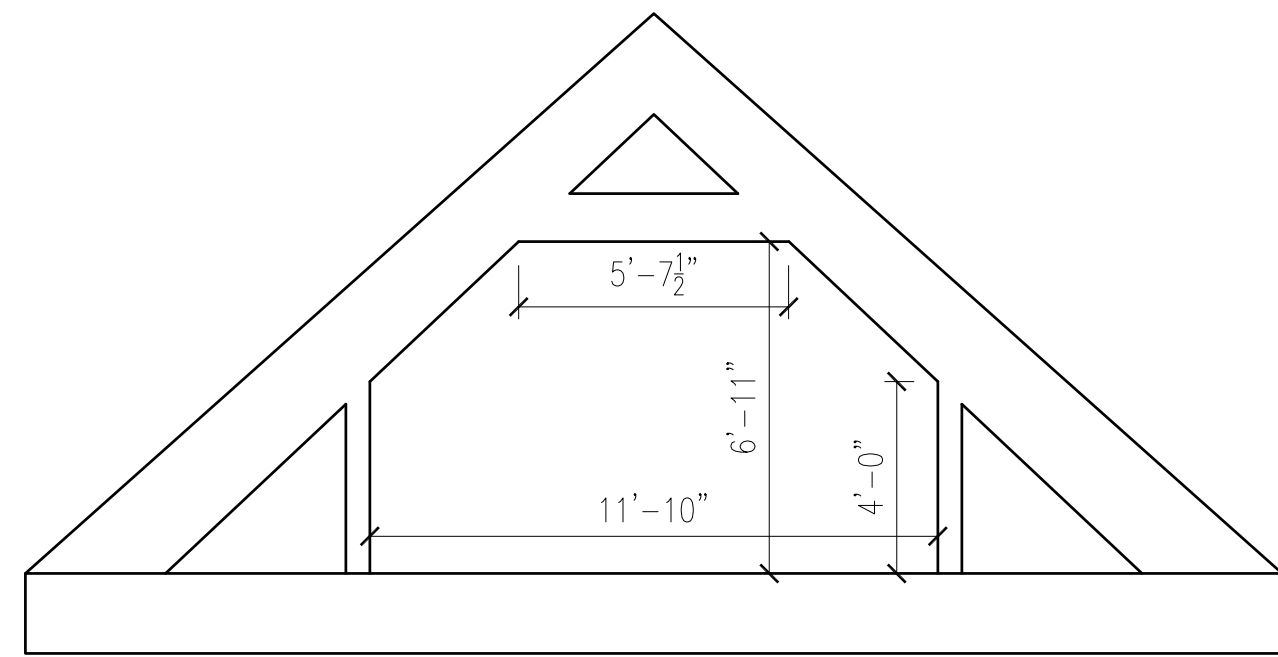

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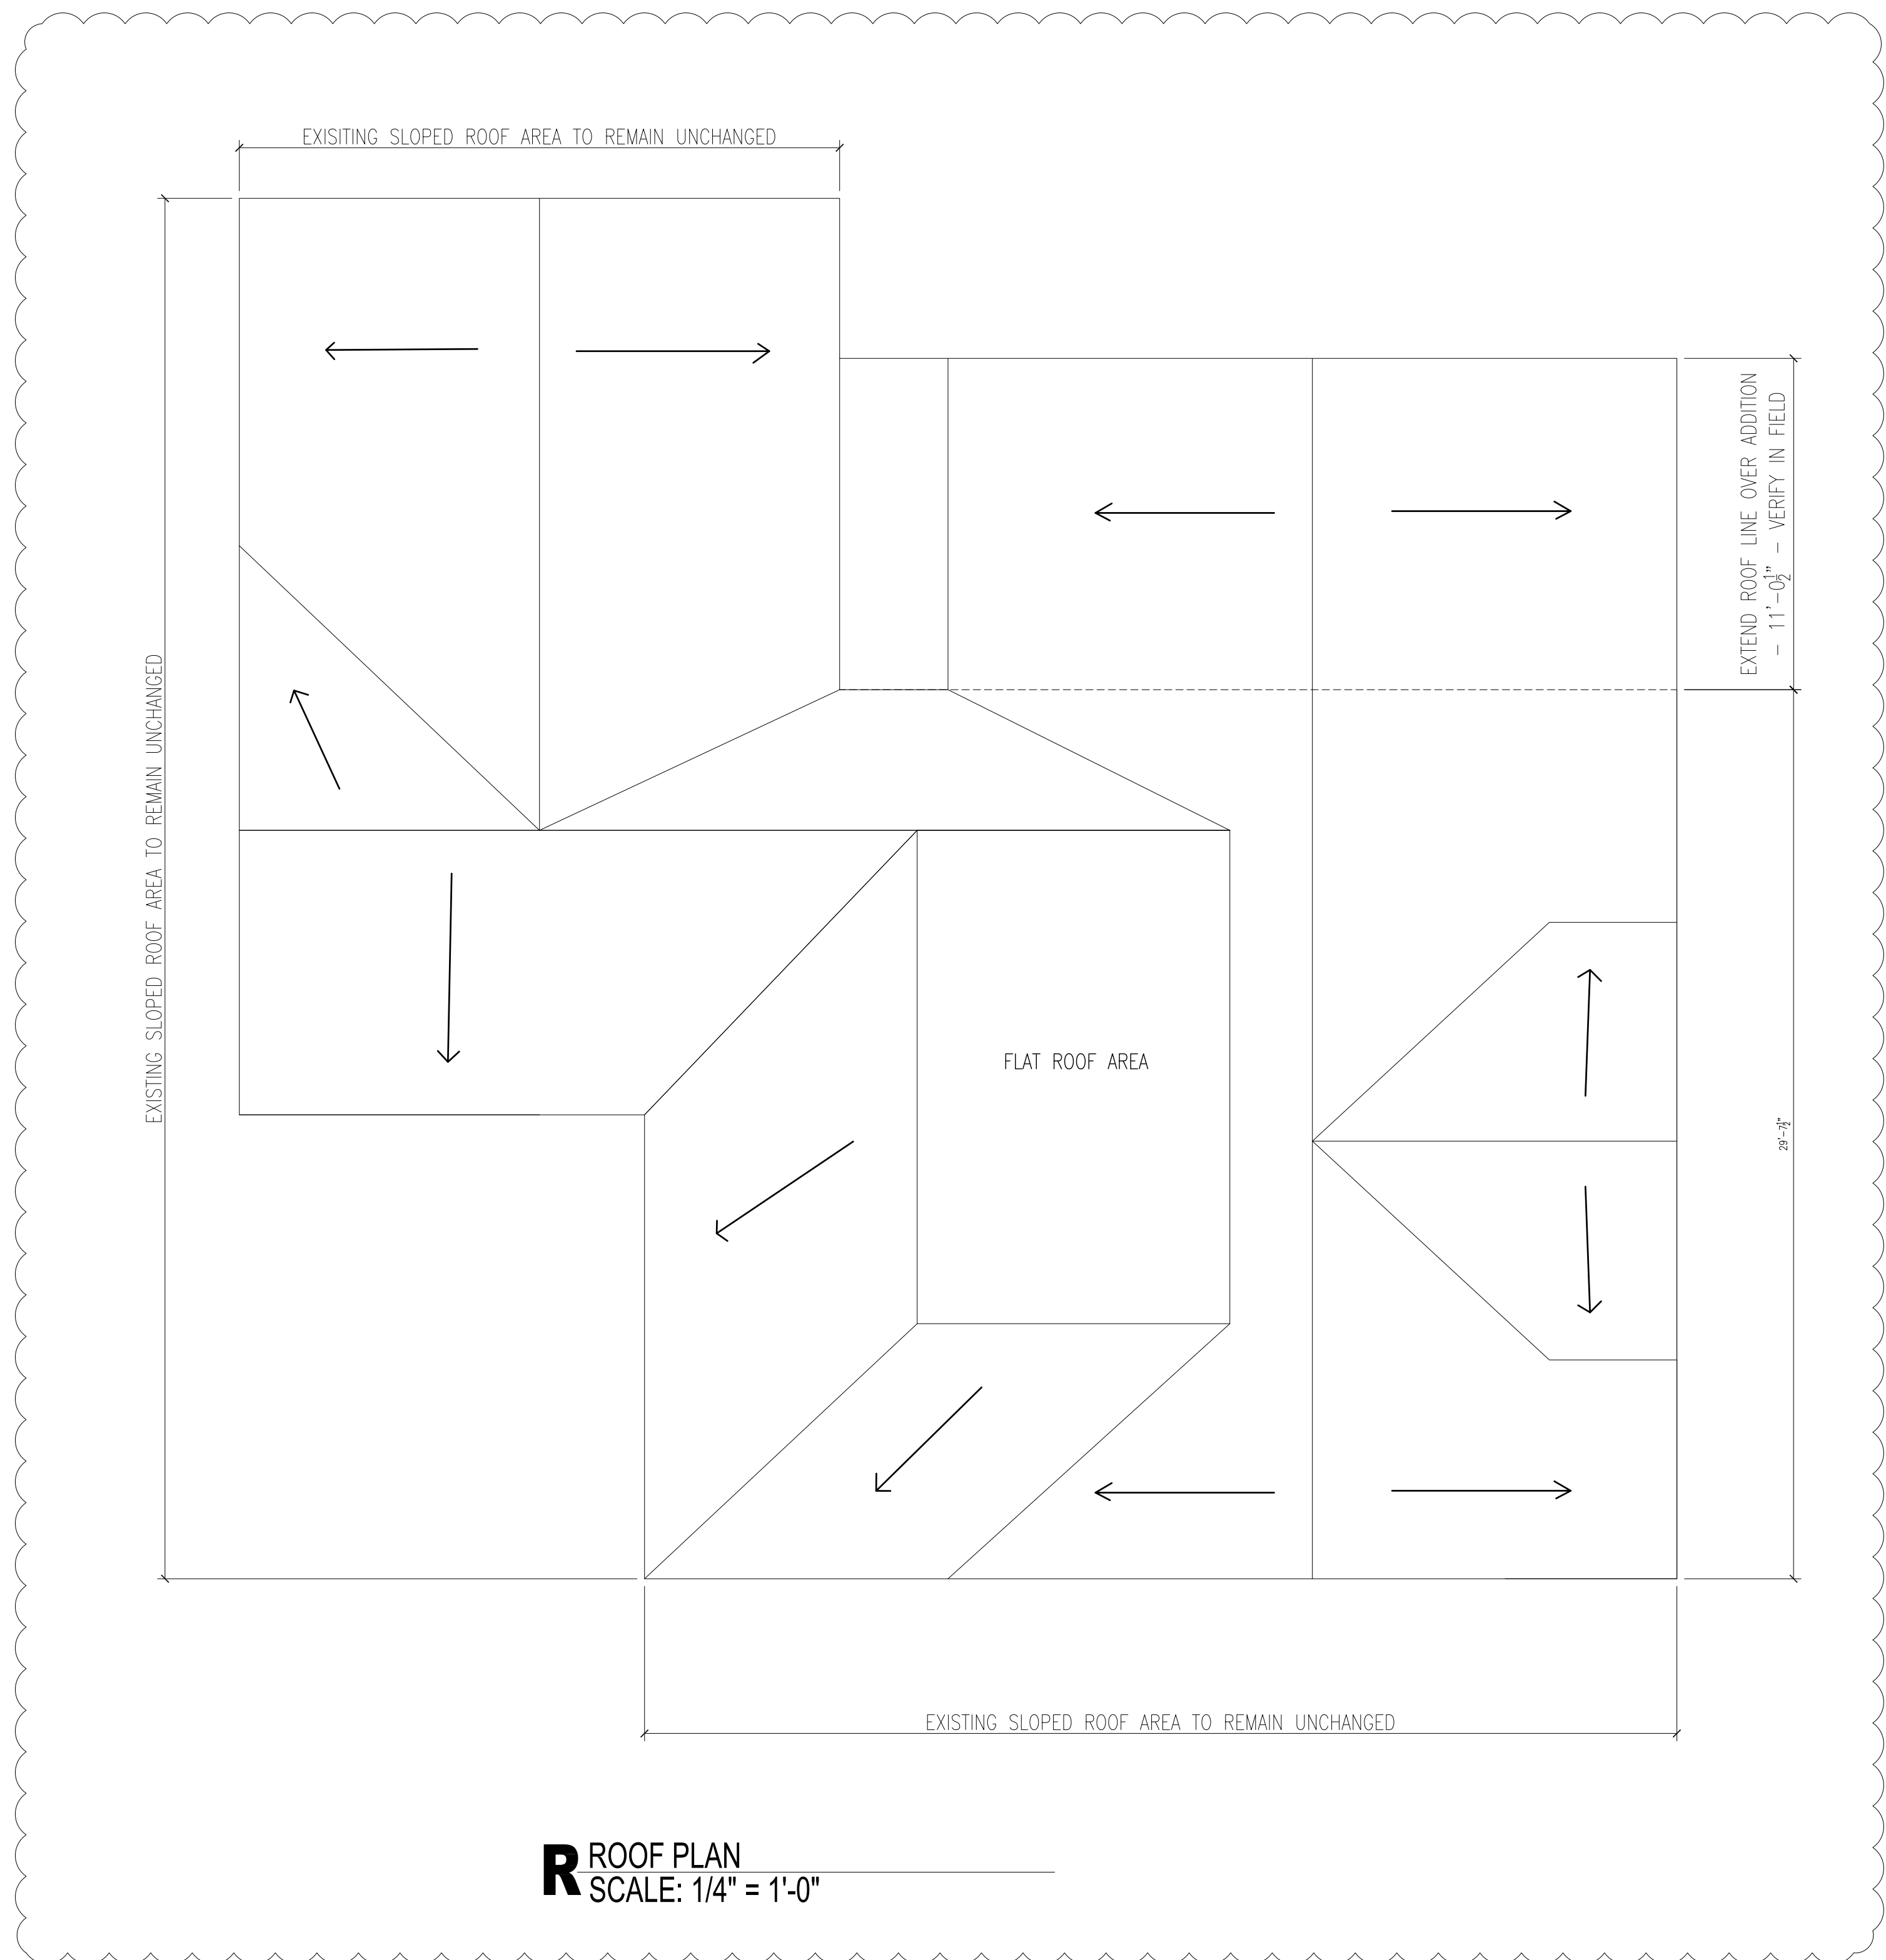
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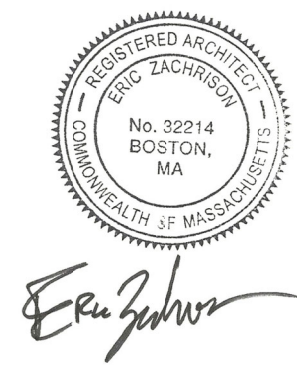
Drawing Title: Proposed Plans

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A-11



R ROOF PLAN
SCALE: 1/4" = 1'-0"



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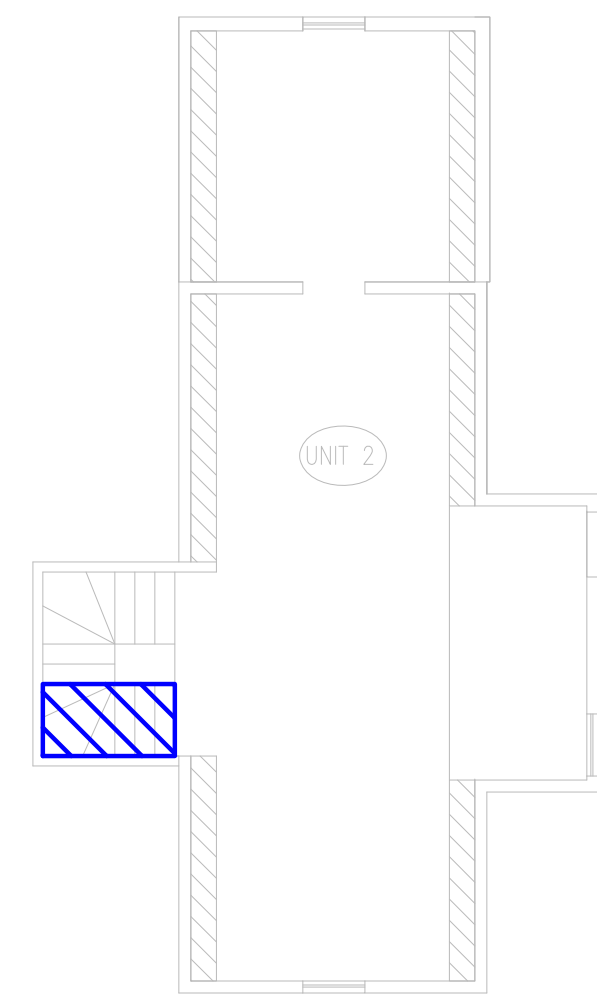
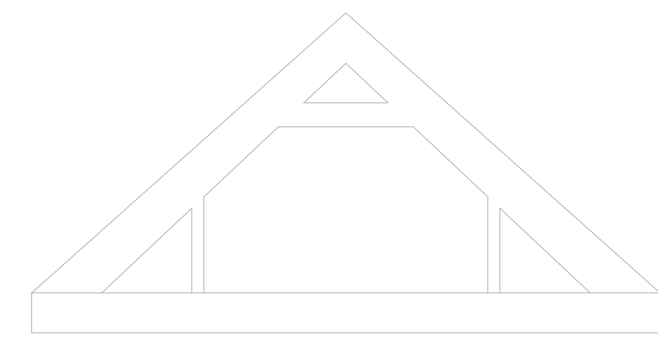
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A-12


$$\text{FAR} = 0.38$$

$$(3751 \text{ SF} / 9817 \text{ LOT AREA})$$




LEVEL 3 – 16 SF

3 FLOOR AREA CALCULATIONS
SCALE: 1/8" = 1'-0"

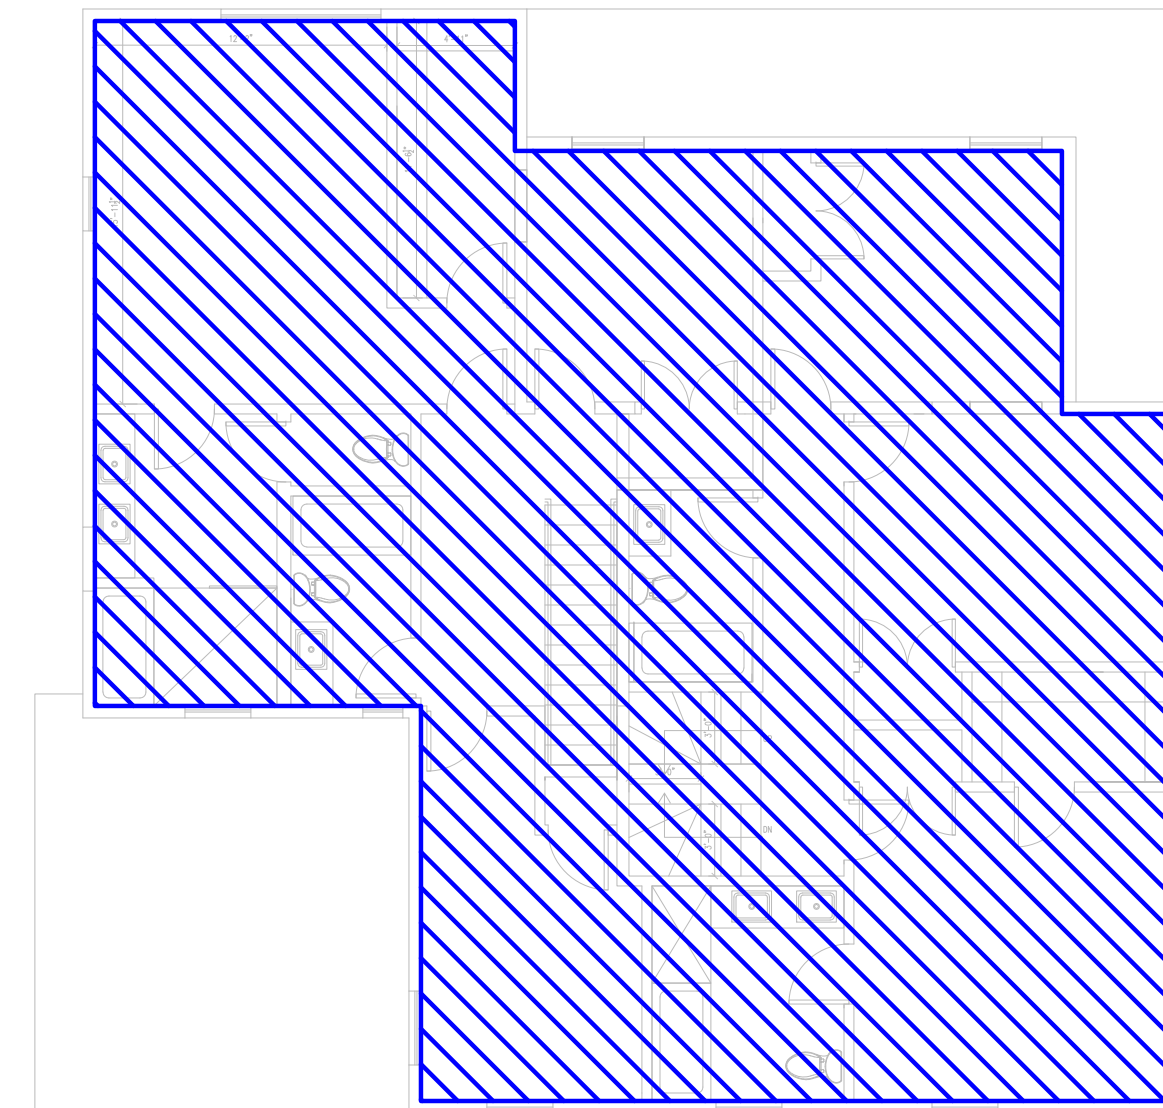


LEVEL 2 – 1600 SF

2 FLOOR AREA CALCULATIONS
SCALE: 1/8" = 1'-0"

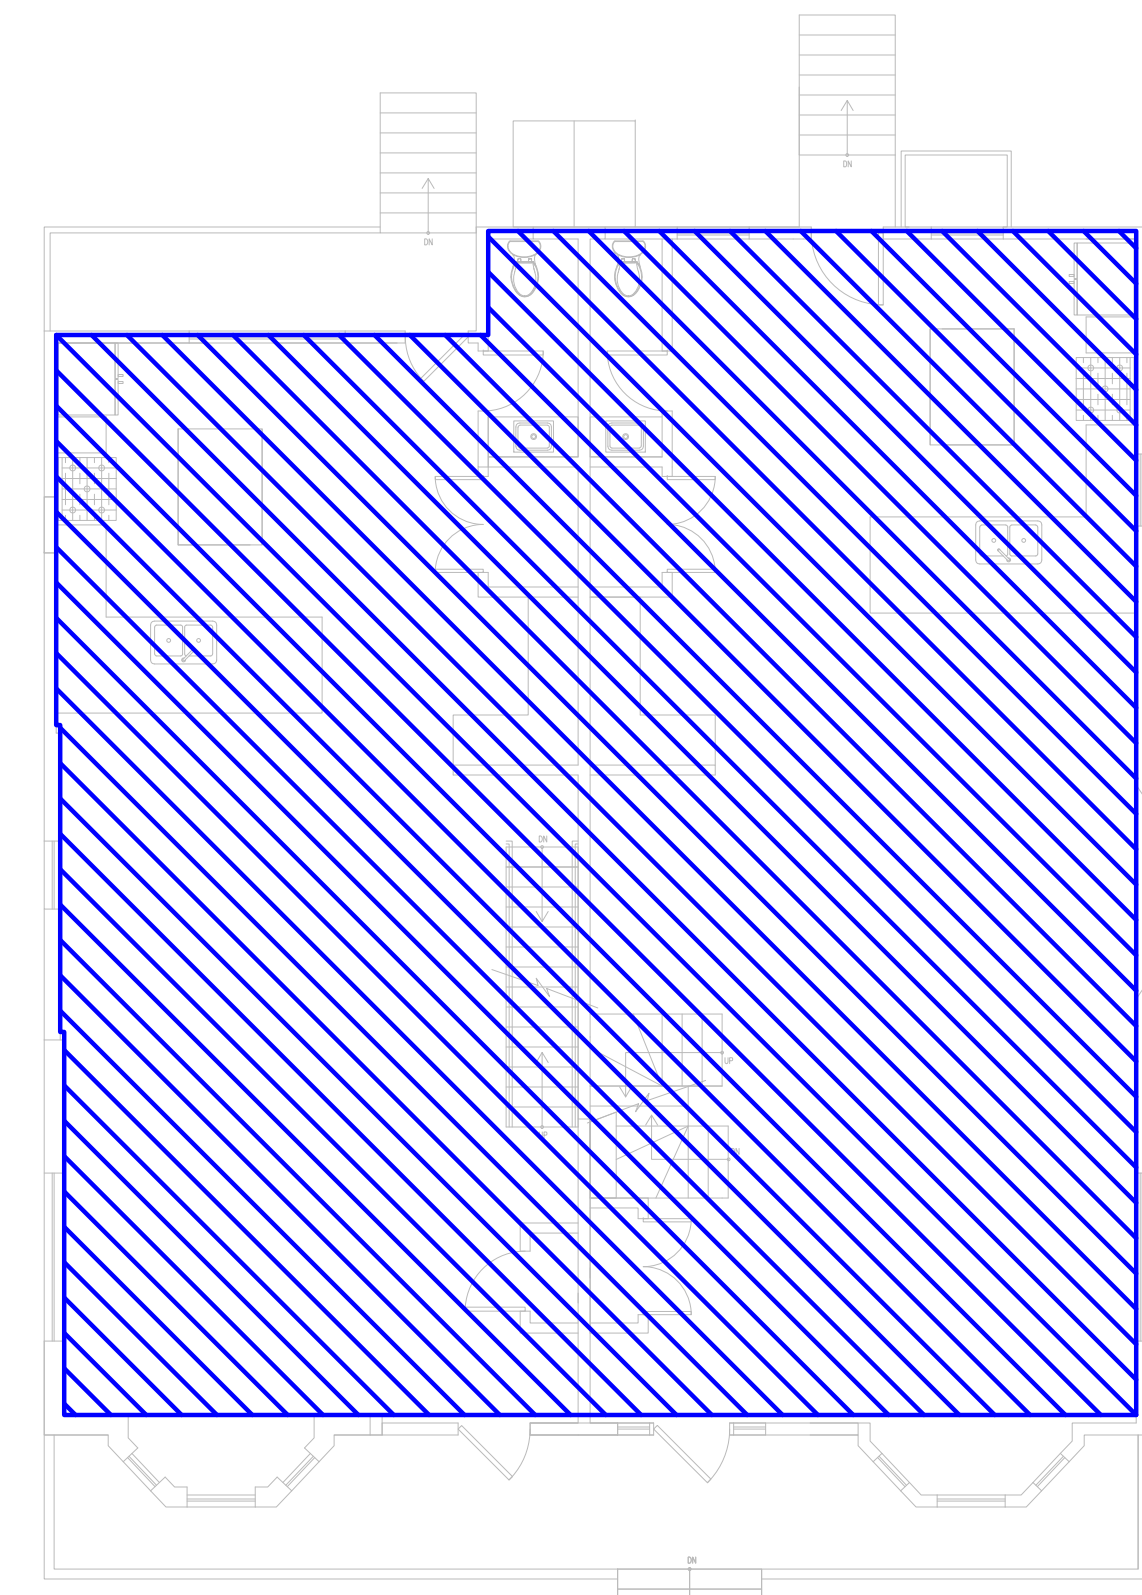

LEVEL 1 – 2135 SF

1 FLOOR AREA CALCULATIONS
SCALE: 1/8" = 1'-0"

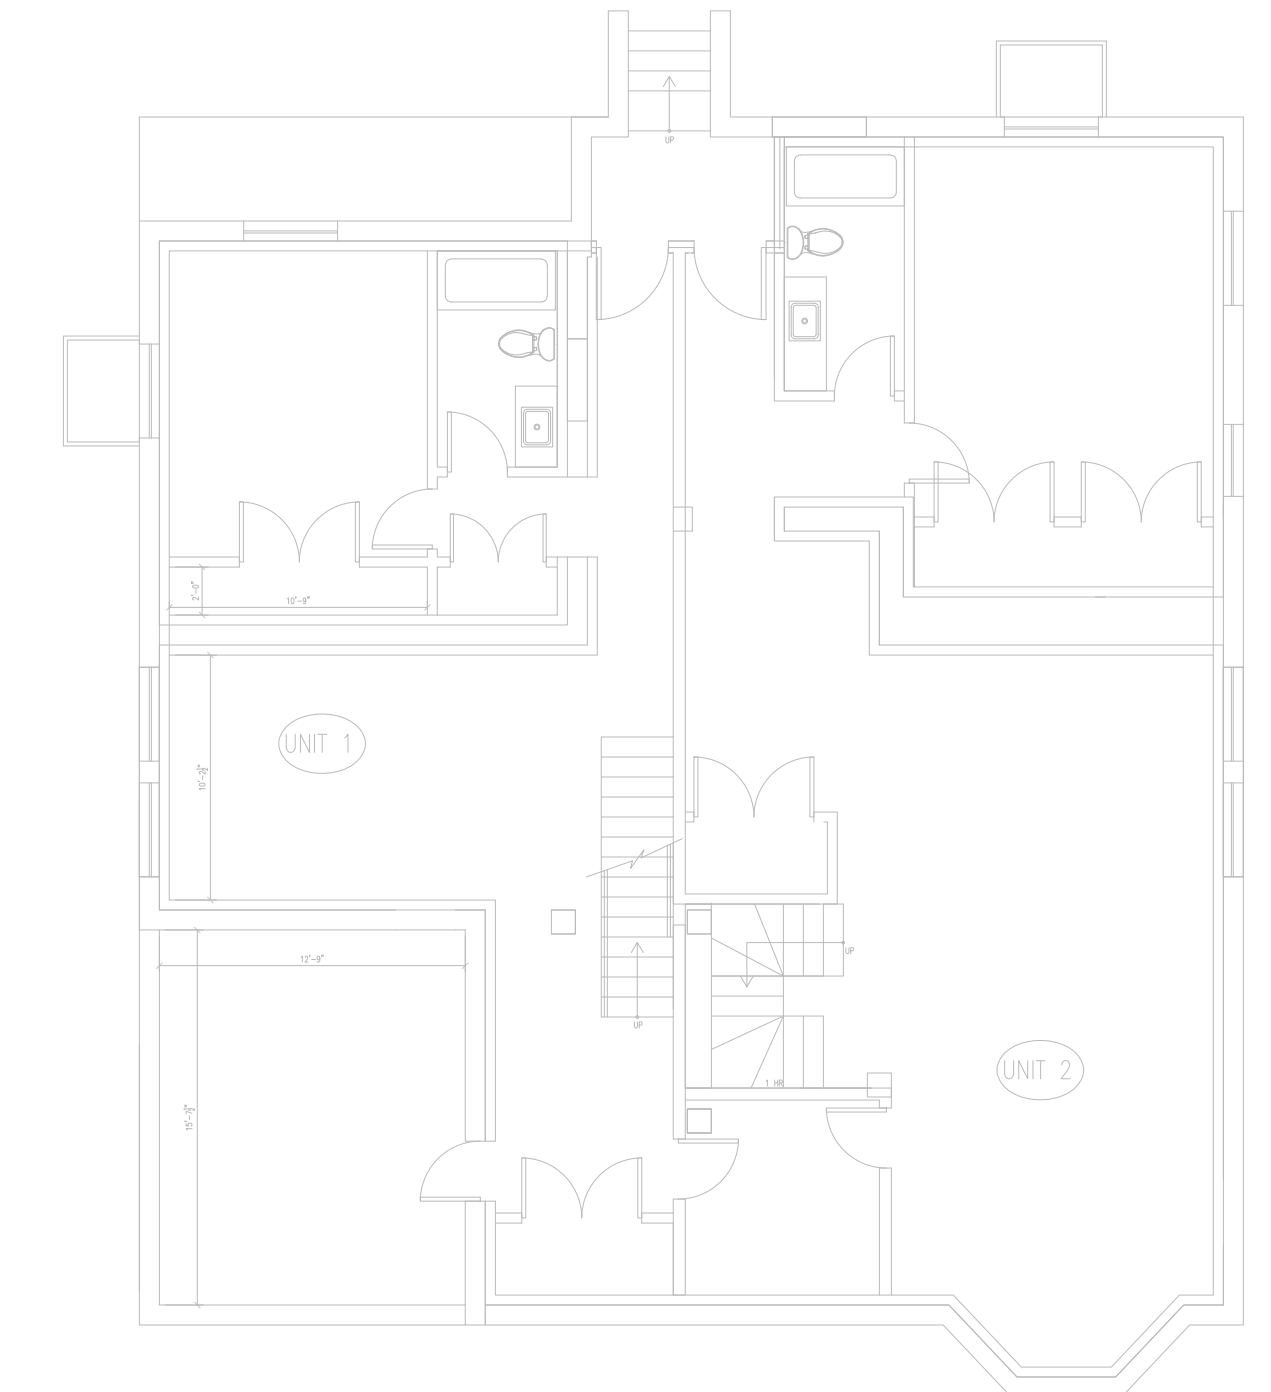

BASEMENT – 0 SF

B FLOOR AREA CALCULATIONS
SCALE: 1/8" = 1'-0"



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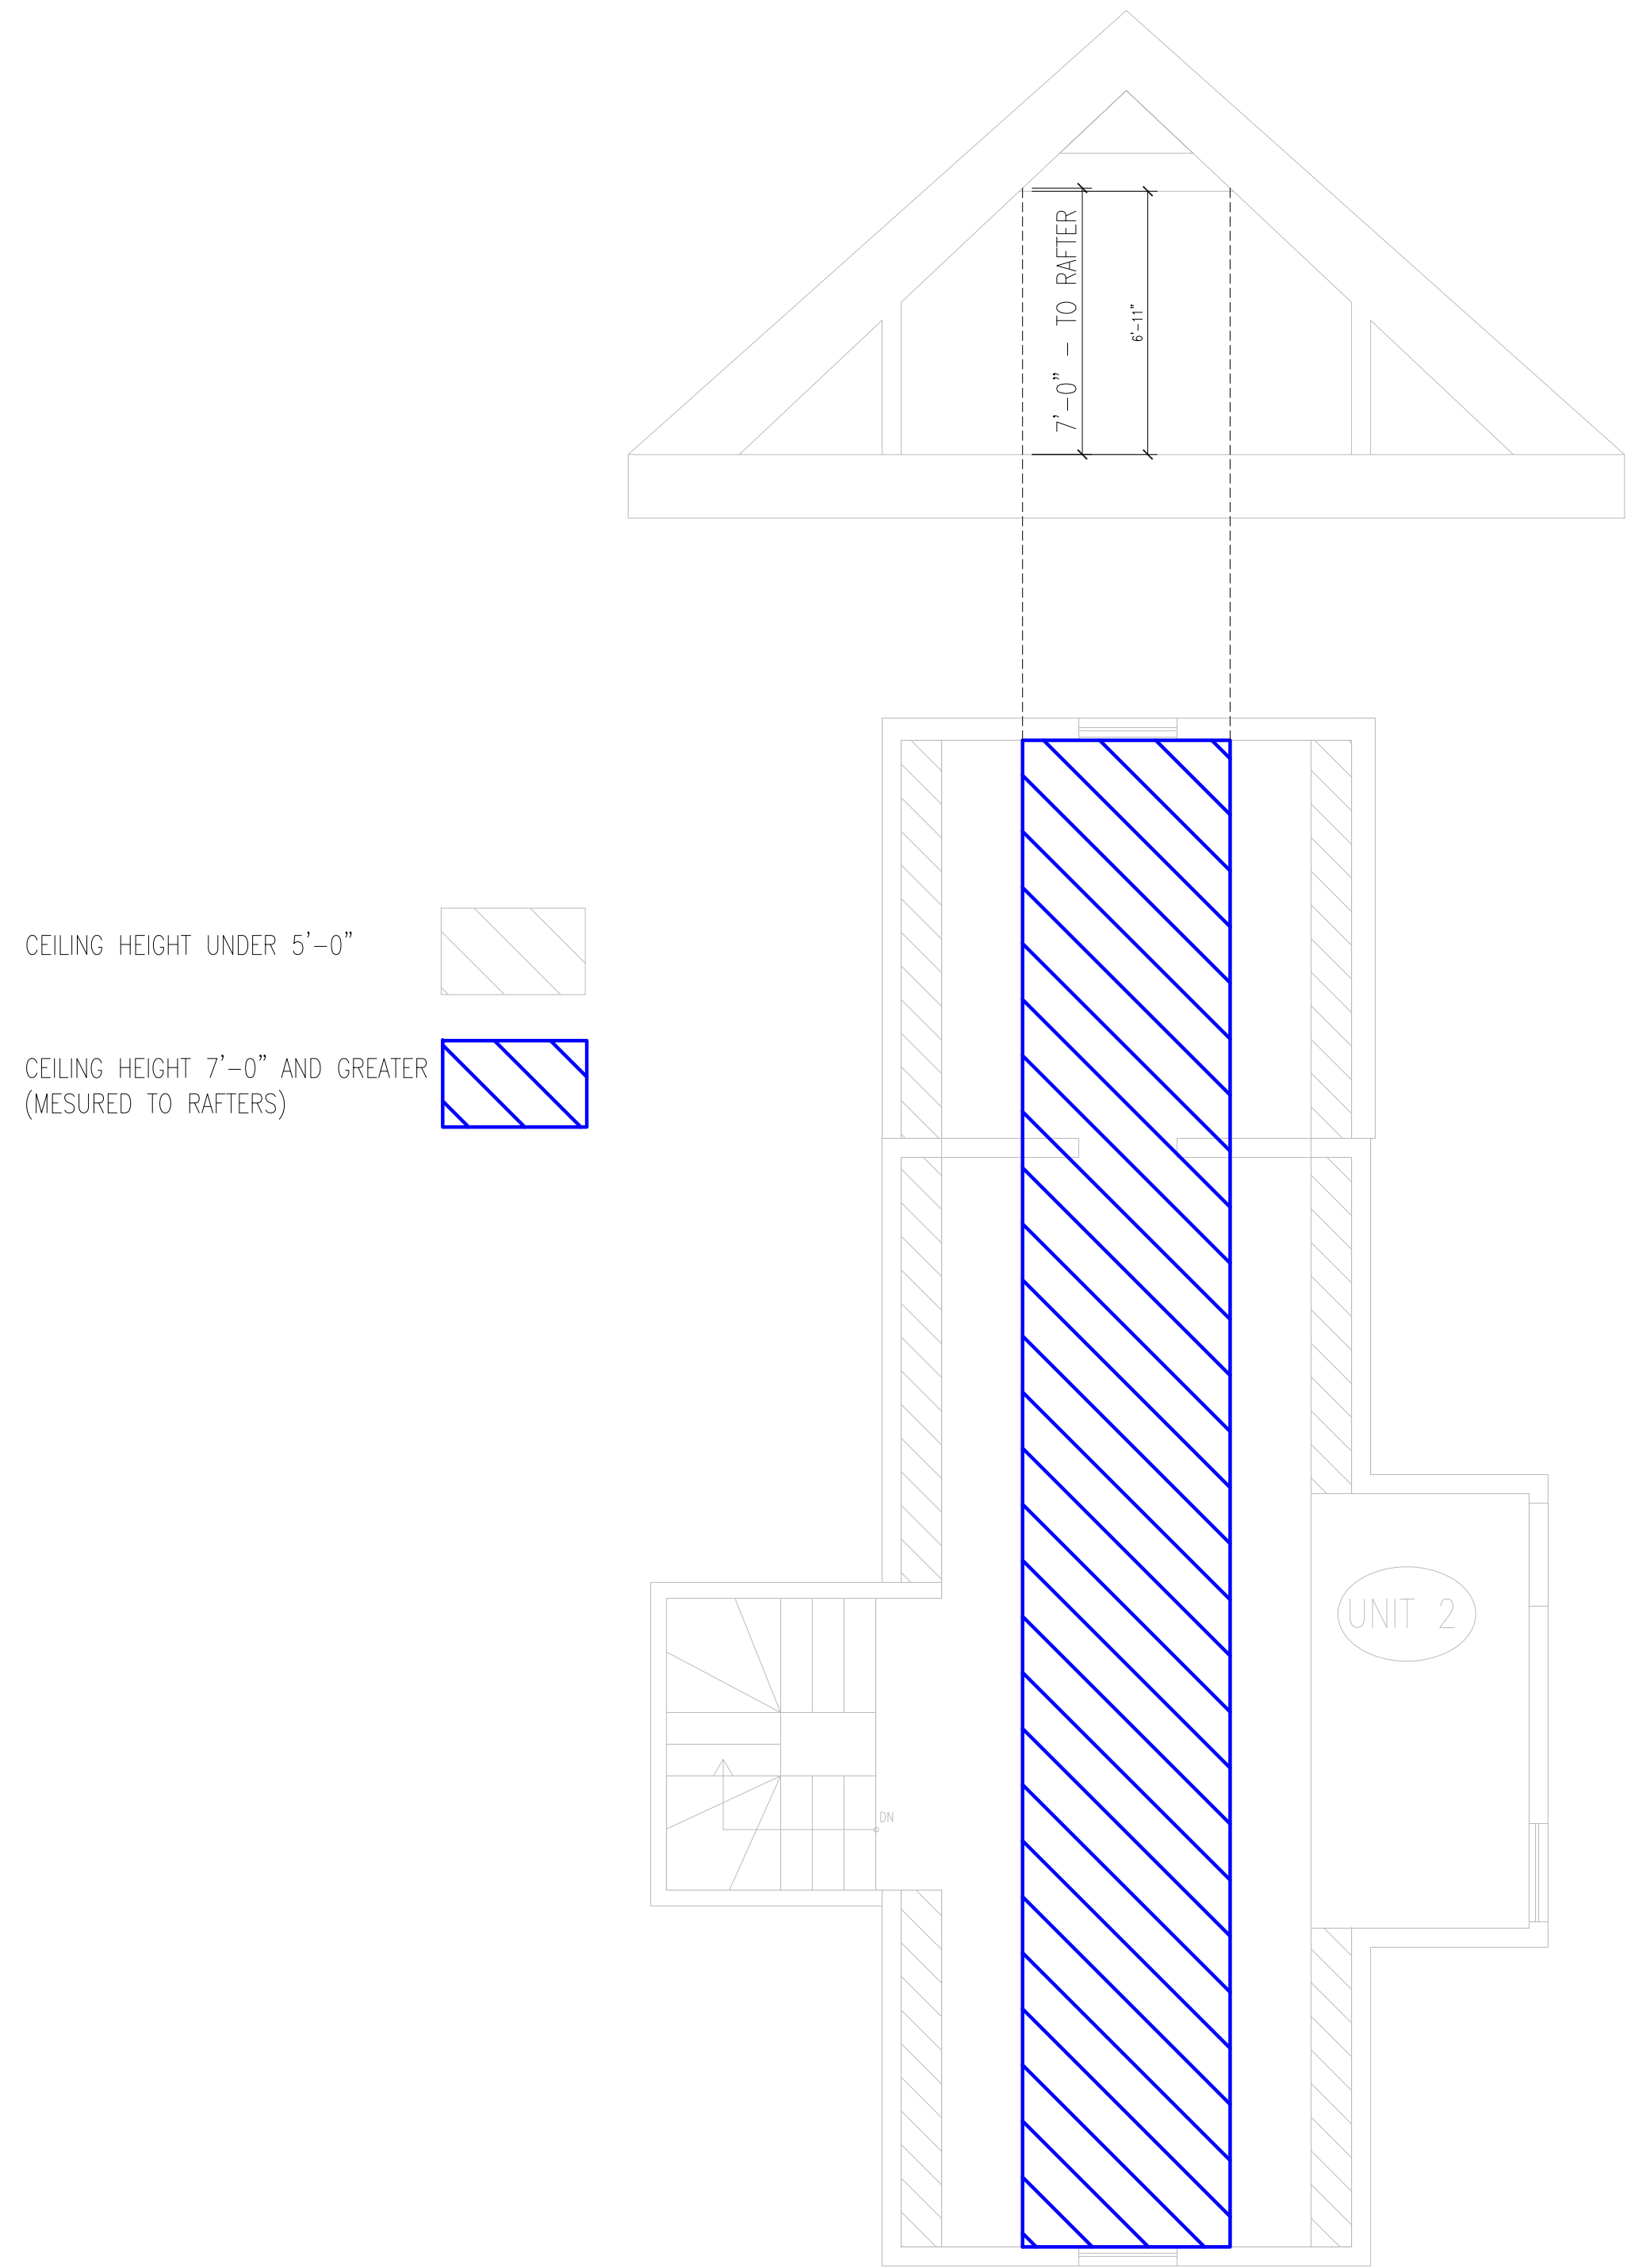
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Drawing Title: FAR Diagram

Project No.: 0--- Checked by: EZ

A-20

336 Cabot - Top Floor Area Diagram (Storage Space)



LEVEL 3 = 479 SF WITH CEILING HEIGHT 5'-0" +
 LEVEL 3 AREA ABOVE 7'-0"
 (AS MEASURED TO RAFTERS) = 215 SF
 215 SF / 479 SF = 45%

3 FLOOR AREA CALCULATIONS
 SCALE: 1/4" = 1'-0"



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Drawing Title: FAR Diagram

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A-21



1 CABOT ST ELEVATION
SCALE: 1/4" = 1'-0"



2 SIDE ELEVATION
SCALE: 1/4" = 1'-0"



Eric Johnson

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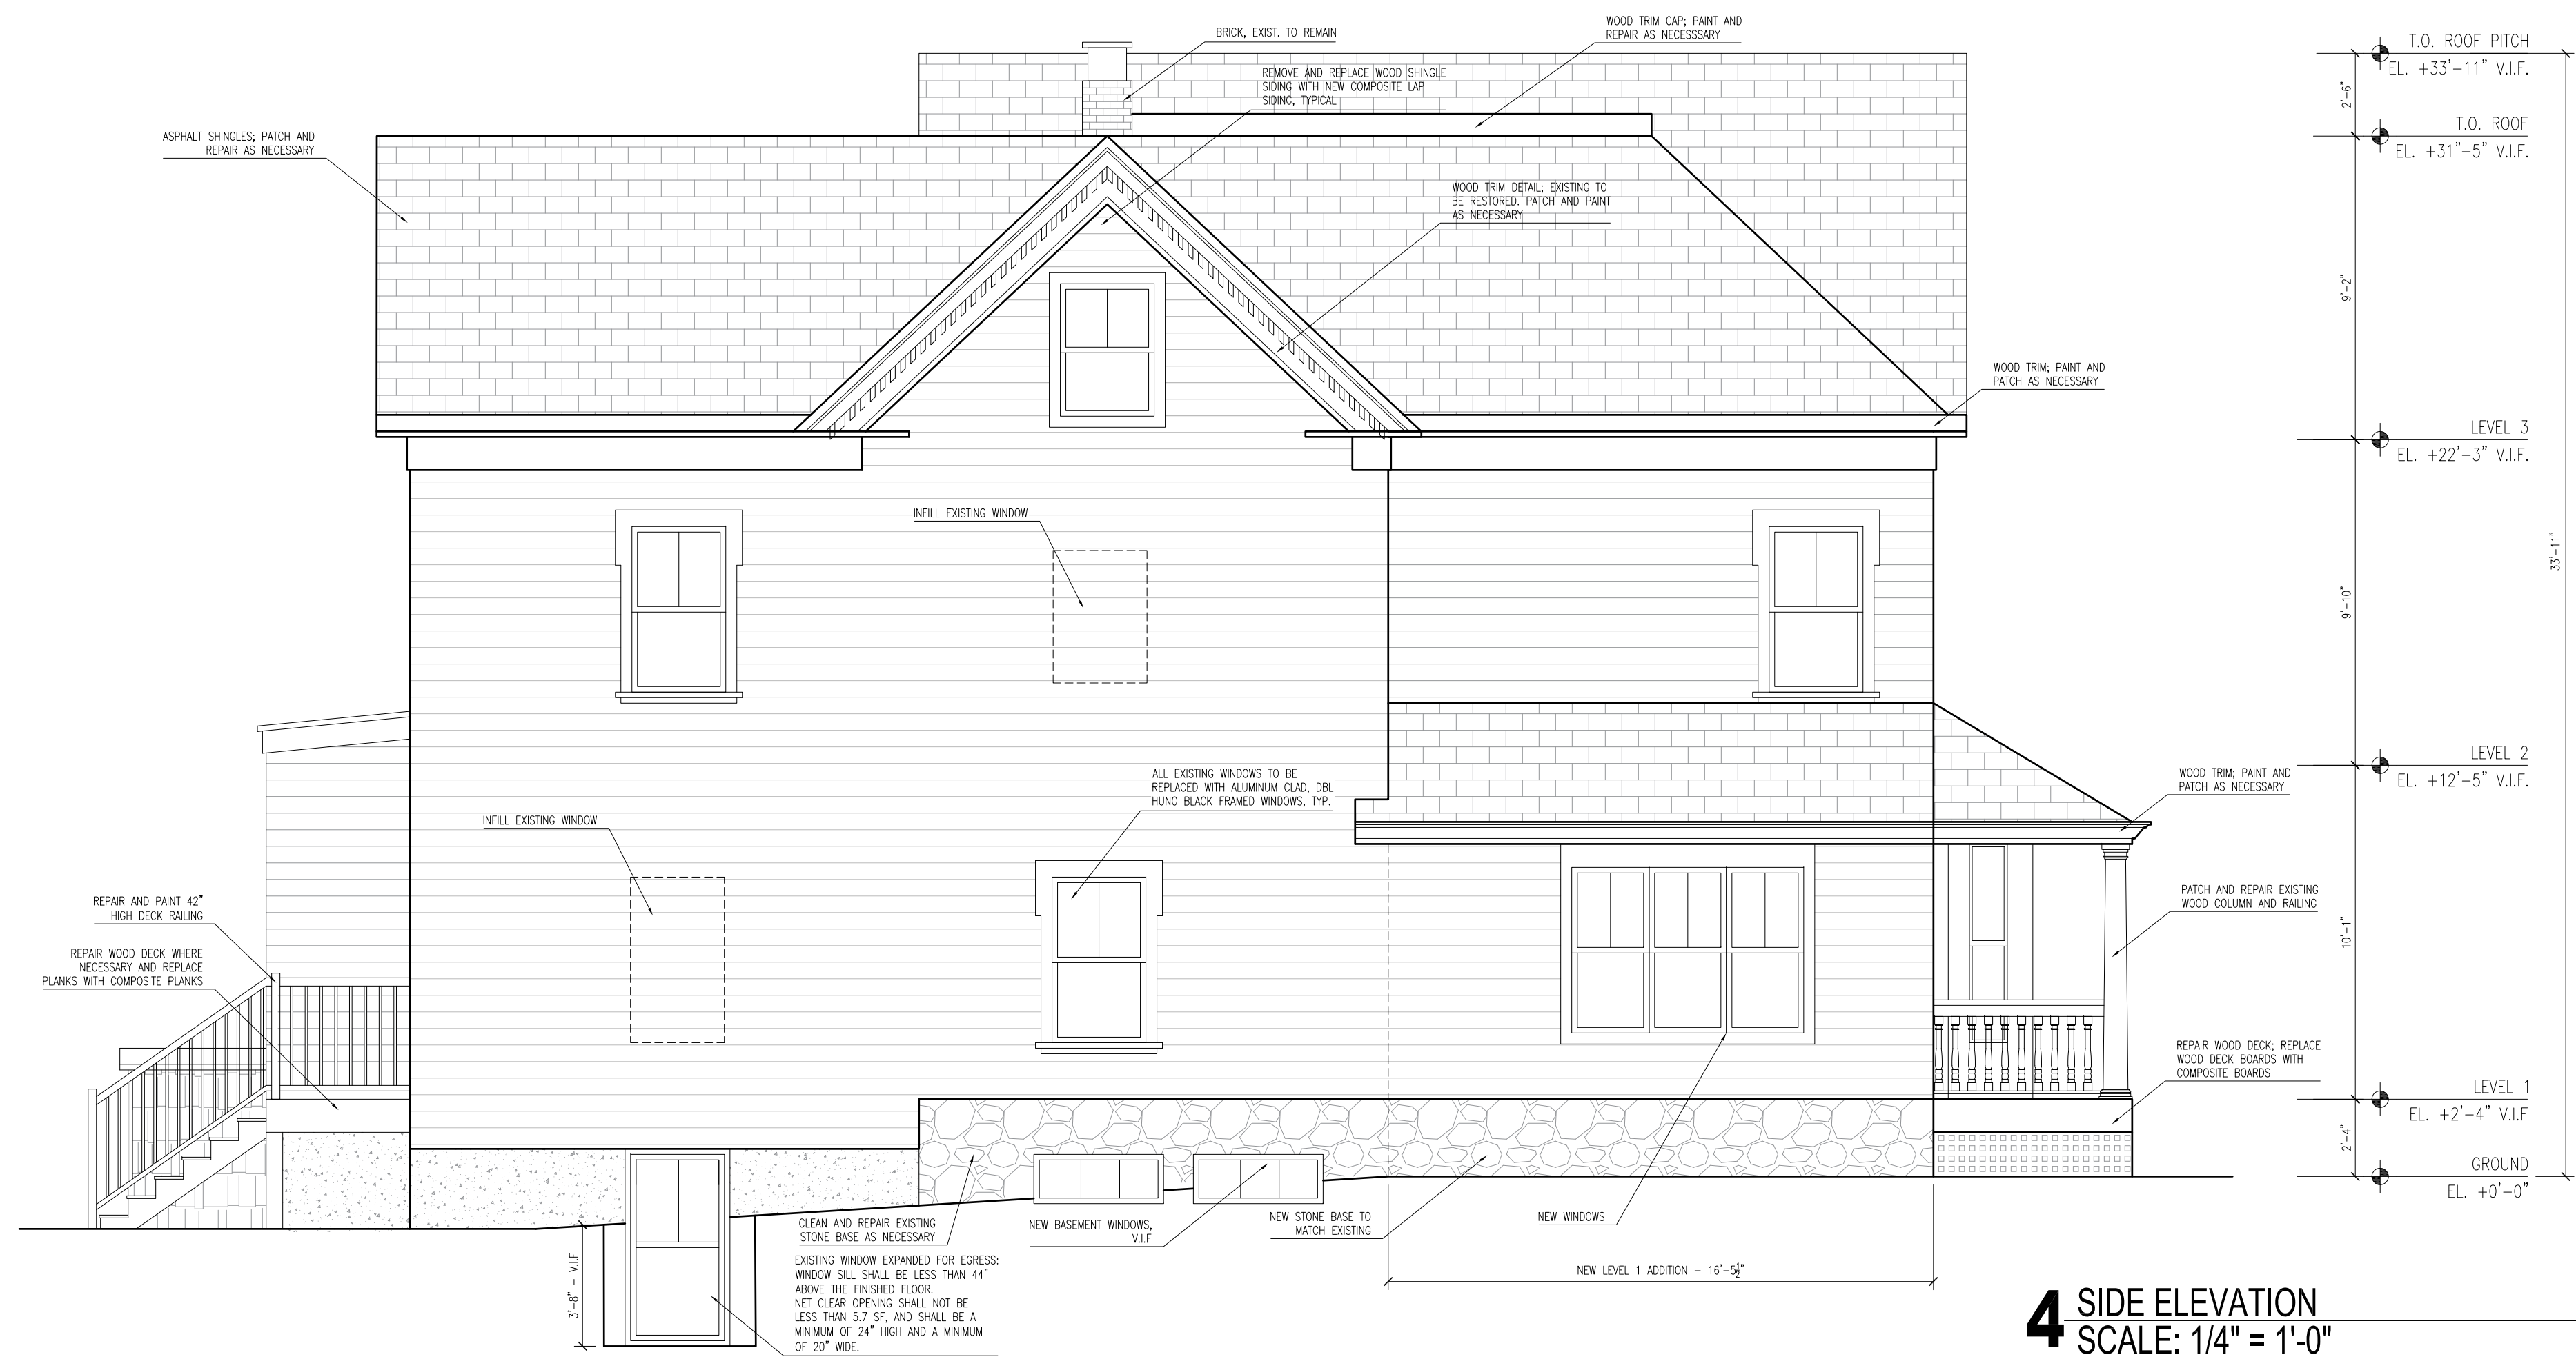
Drawing Title: Proposed Elevations

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A-30



3 REAR ELEVATION
SCALE: 1/4" = 1'-0"



4 SIDE ELEVATION
SCALE: 1/4" = 1'-0"



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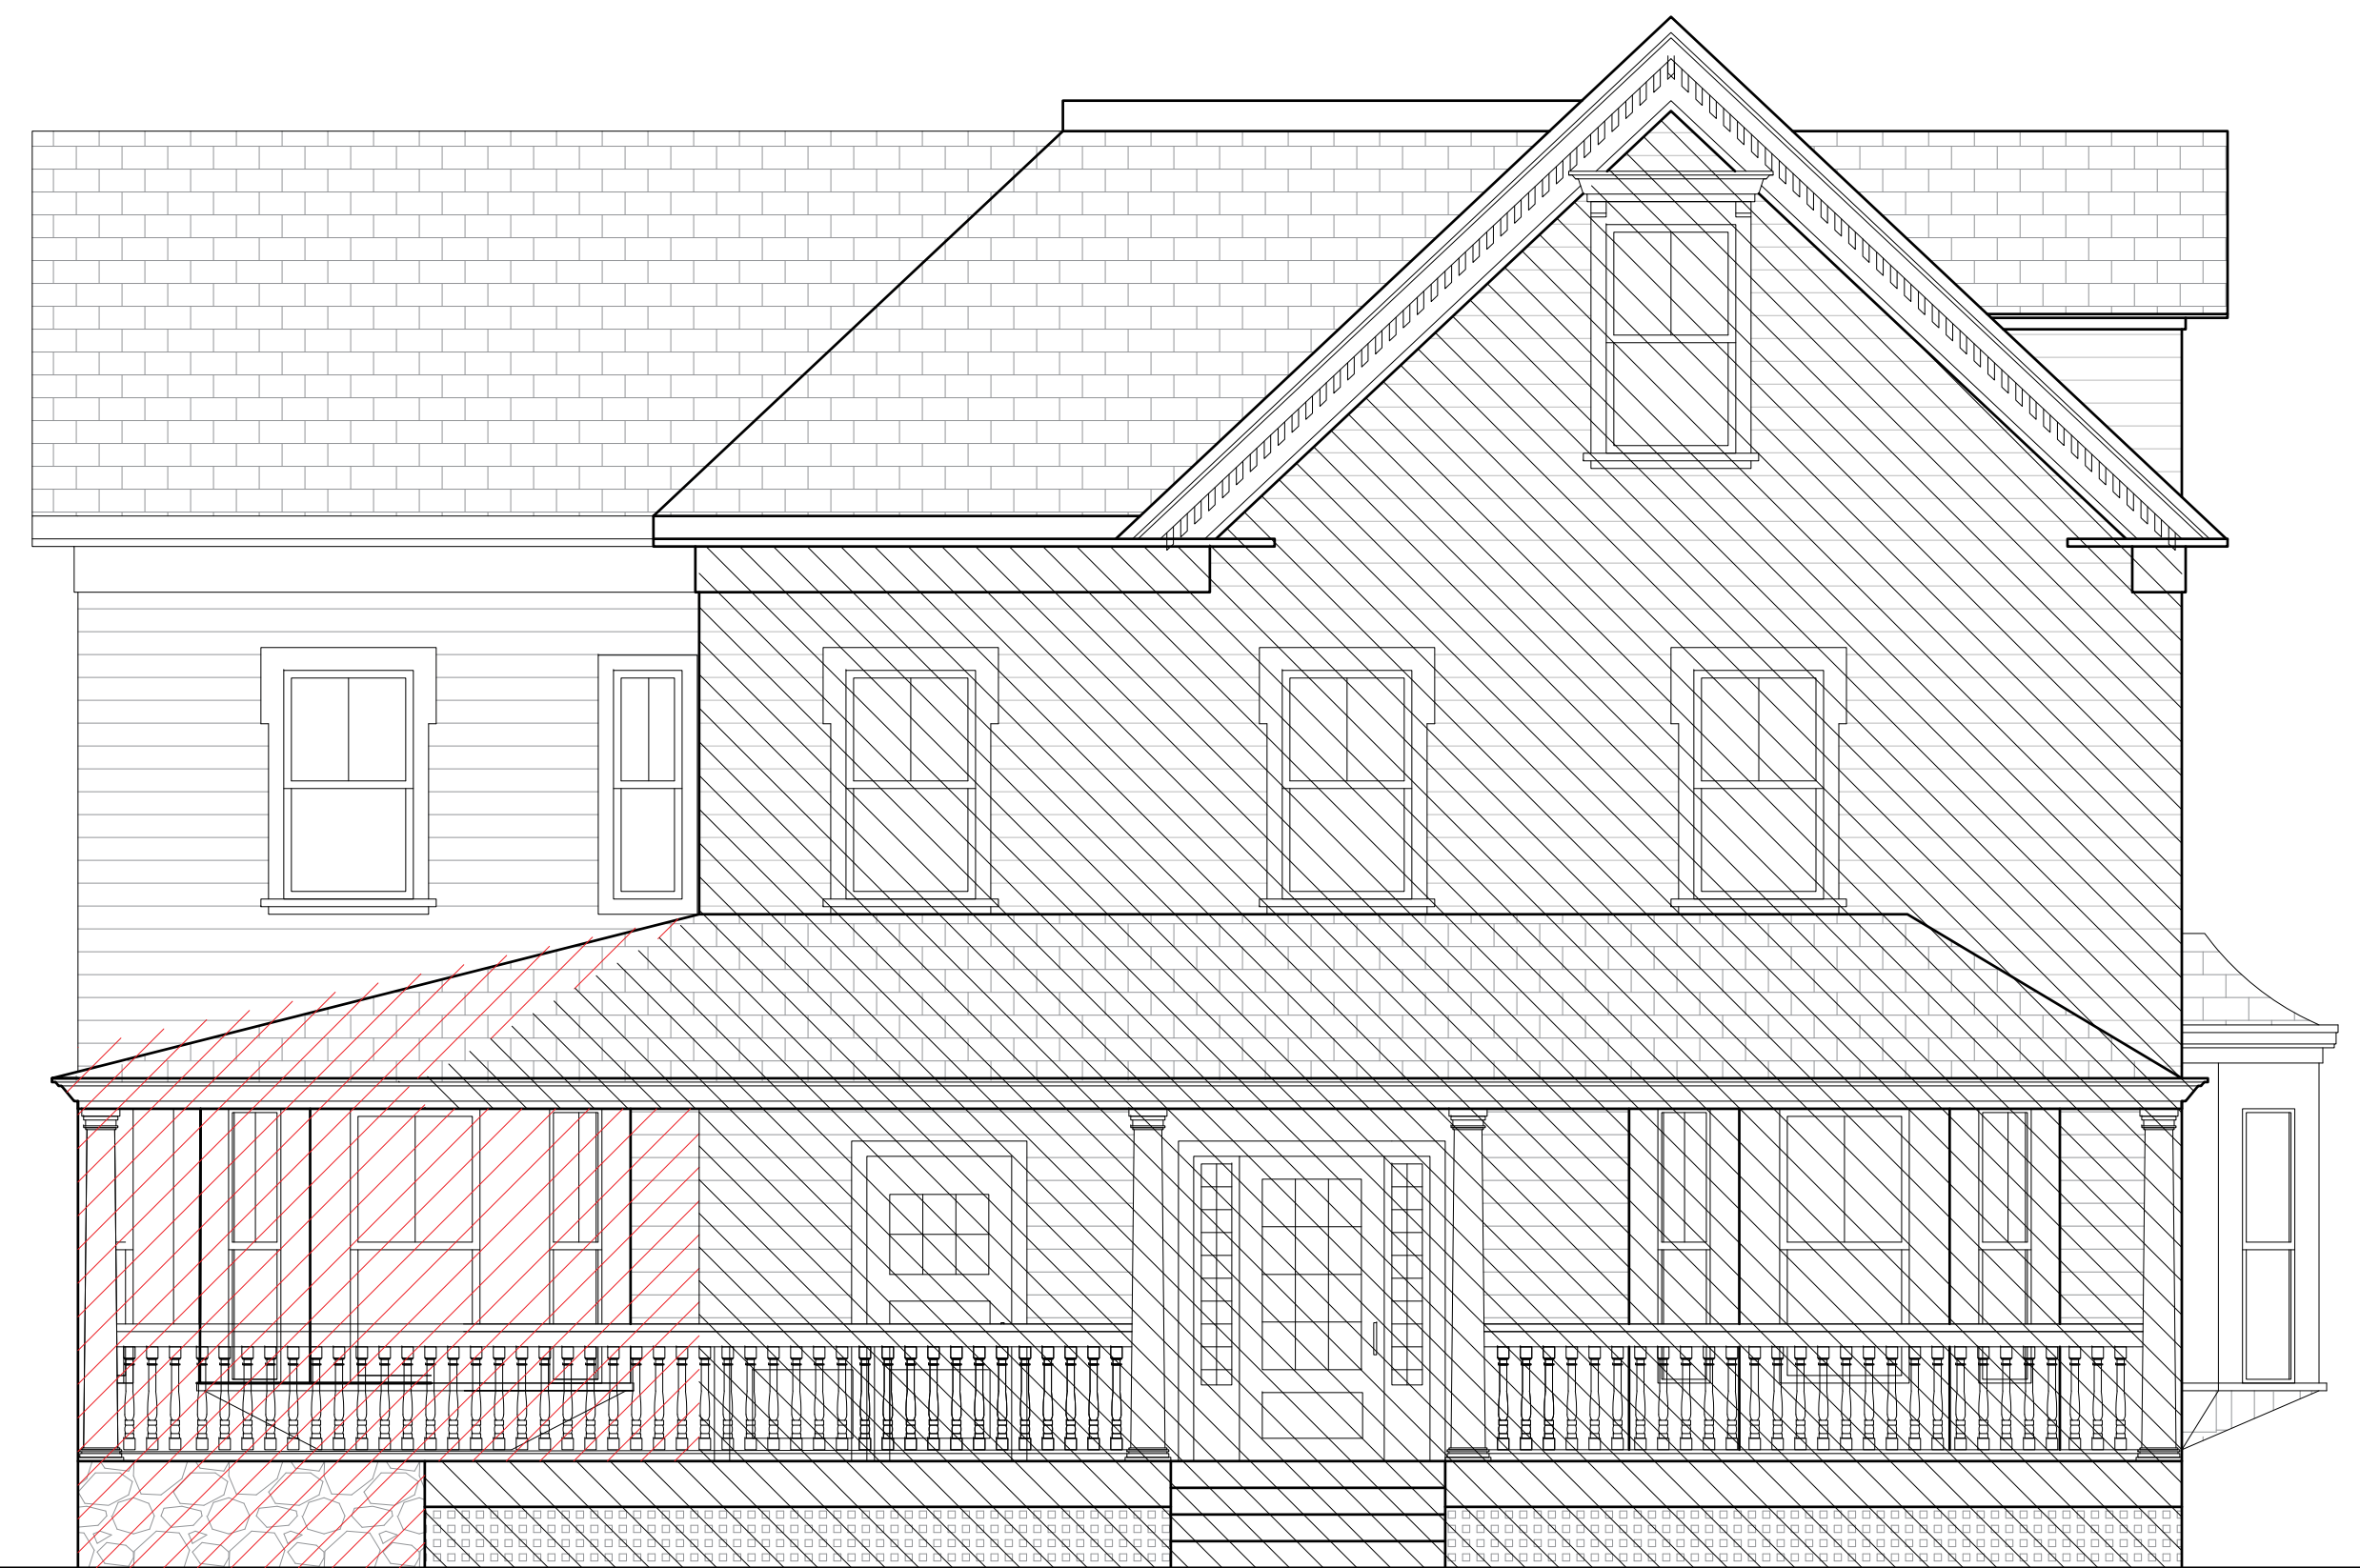
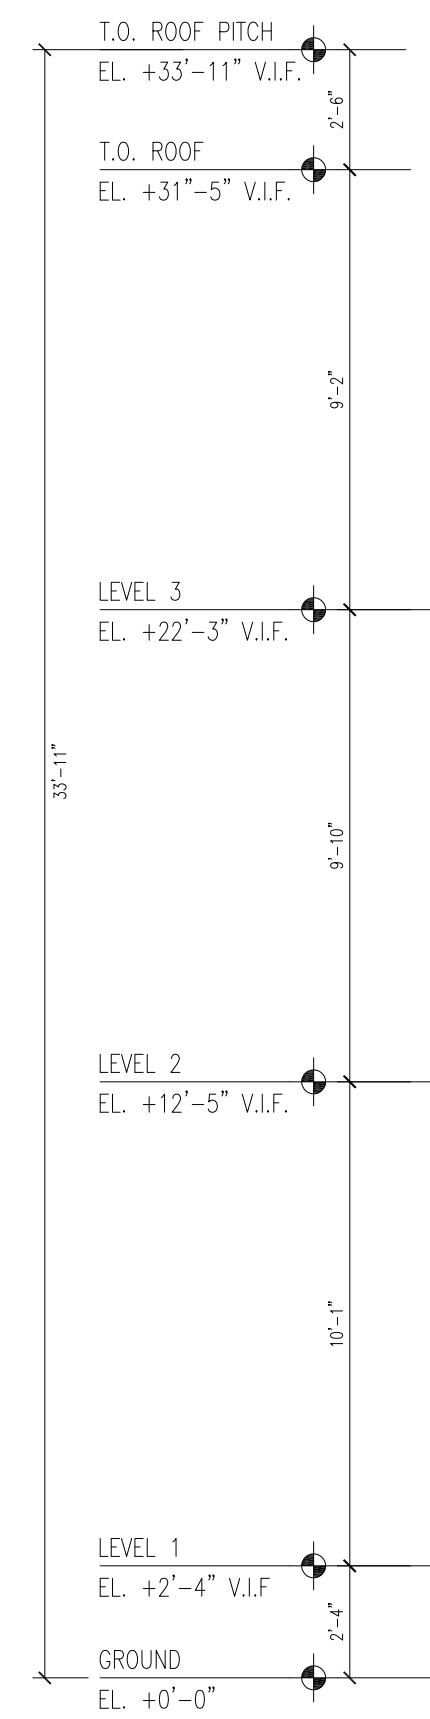
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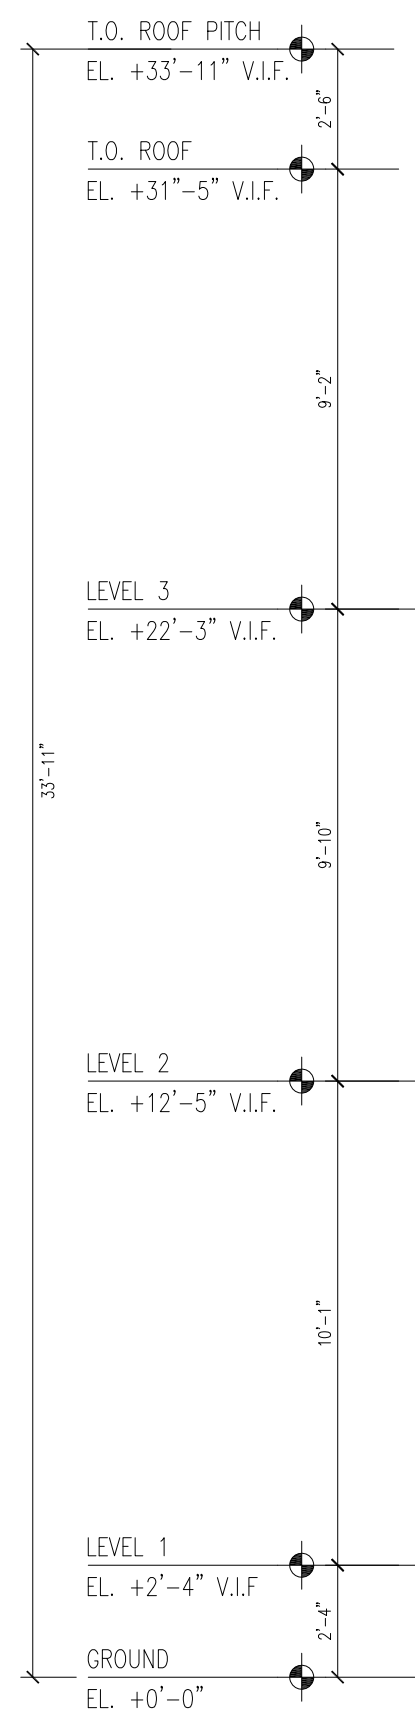


NEW ELEVATION AREA: 145 SF EXISTING ELEVATION AREA: 849 SF

$145 \text{ SF} / 849 \text{ SF} = 17\%$

$145 \text{ SF} / (145 \text{ SF} + 849 \text{ SF}) = 15\%$

1 CABOT ST ELEVATION
SCALE: 1/4" = 1'-0"



EXISTING ELEVATION AREA: 1072 SF

NEW ELEVATION AREA: 89 SF

$89 \text{ SF} / 1072 \text{ SF} = 8\%$

$89 \text{ SF} / (89 \text{ SF} + 1072 \text{ SF}) = 7\%$

2 SIDE ELEVATION
SCALE: 1/4" = 1'-0"



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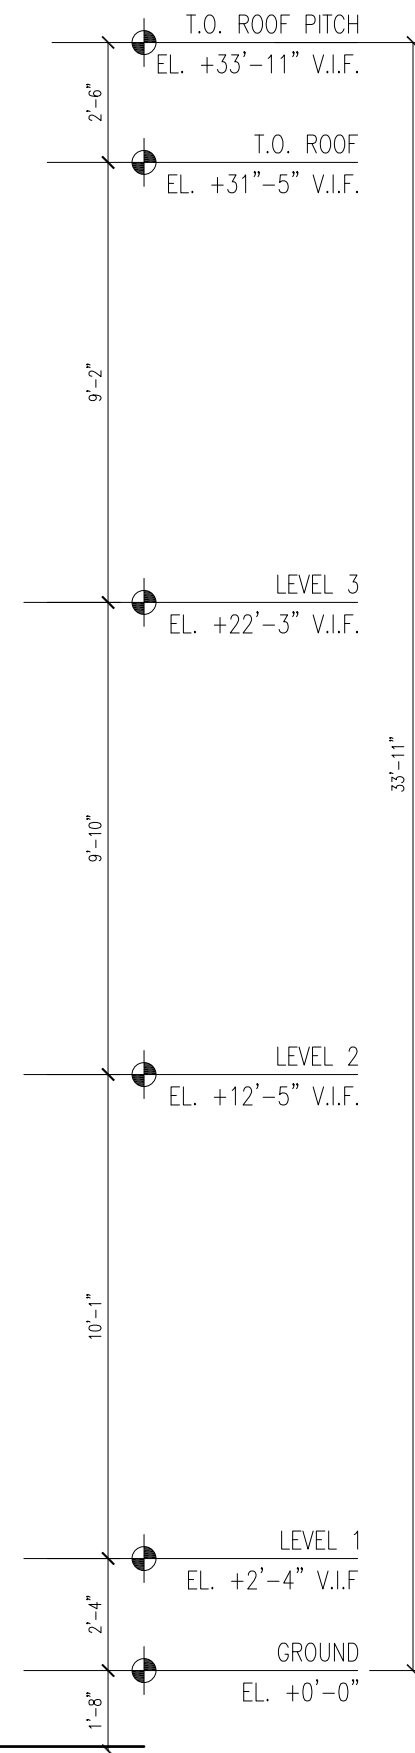
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Drawing Title: Proposed Elevations

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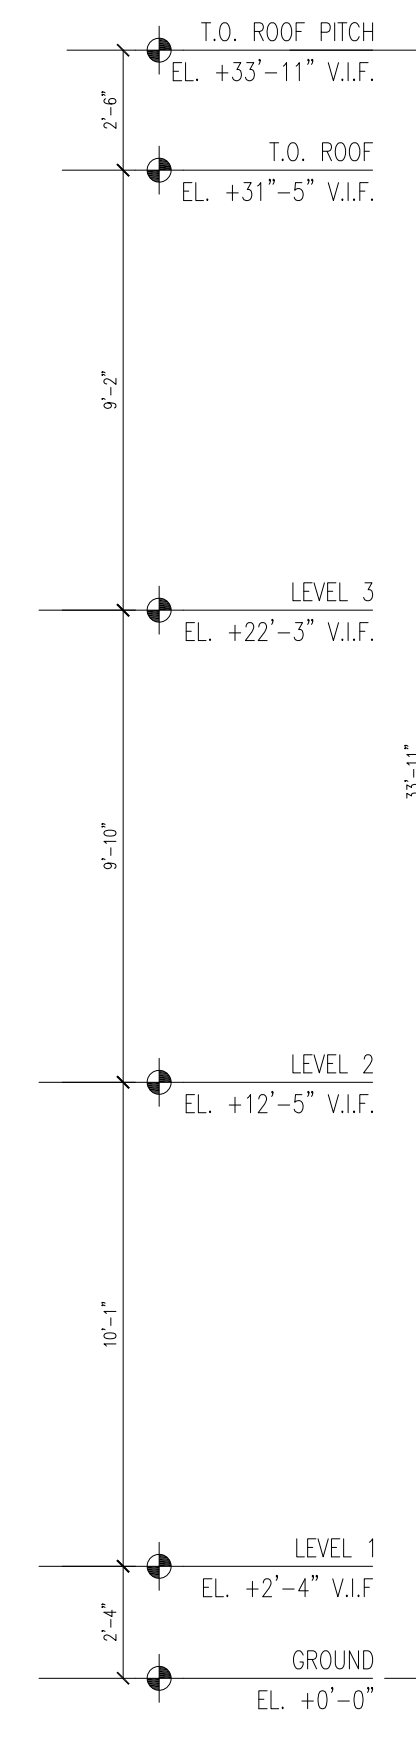
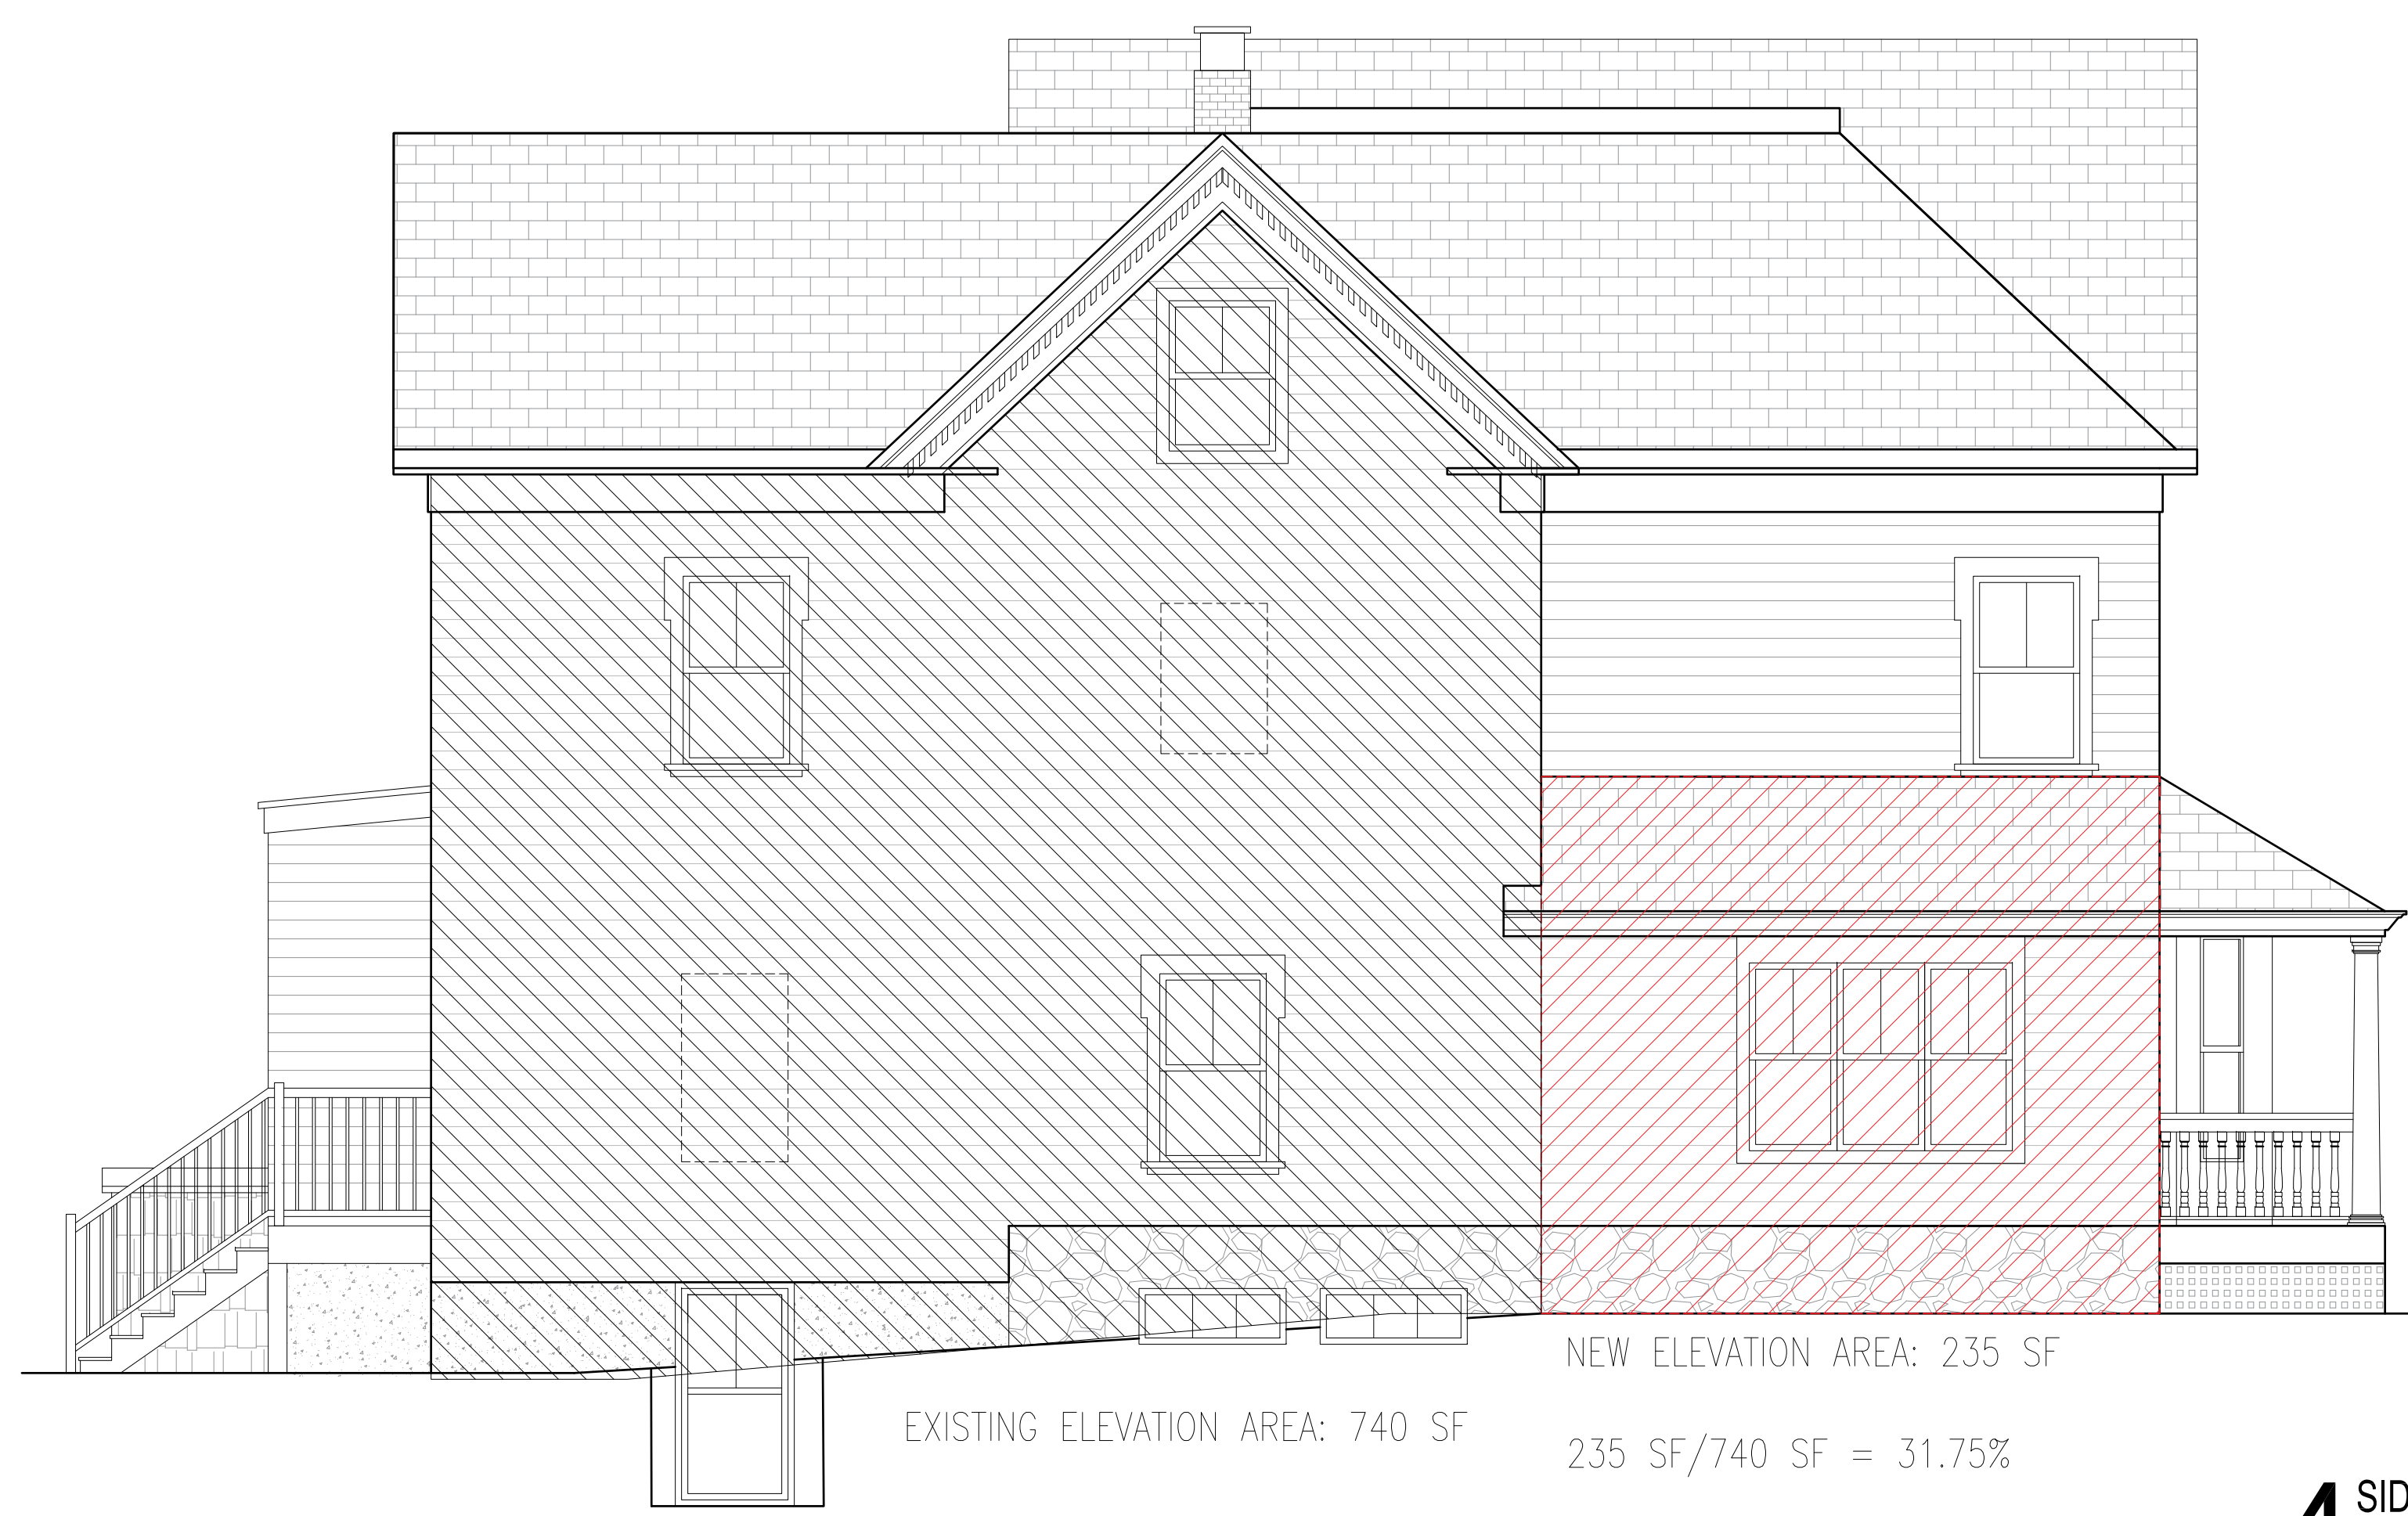
A-32



NEW ELEVATION AREA: 326 SF EXISTING ELEVATION AREA: 965 SF
 $326 \text{ SF} / 965 \text{ SF} = 33\%$

$326 \text{ SF} / (326 \text{ SF} + 965 \text{ SF}) = 25\%$

3 REAR ELEVATION
 SCALE: 1/4" = 1'-0"



NEW ELEVATION AREA: 235 SF
 EXISTING ELEVATION AREA: 740 SF
 $235 \text{ SF} / 740 \text{ SF} = 31.75\%$
 $235 \text{ SF} / (235 \text{ SF} + 740 \text{ SF}) = 24.1\%$

4 SIDE ELEVATION
 SCALE: 1/4" = 1'-0"



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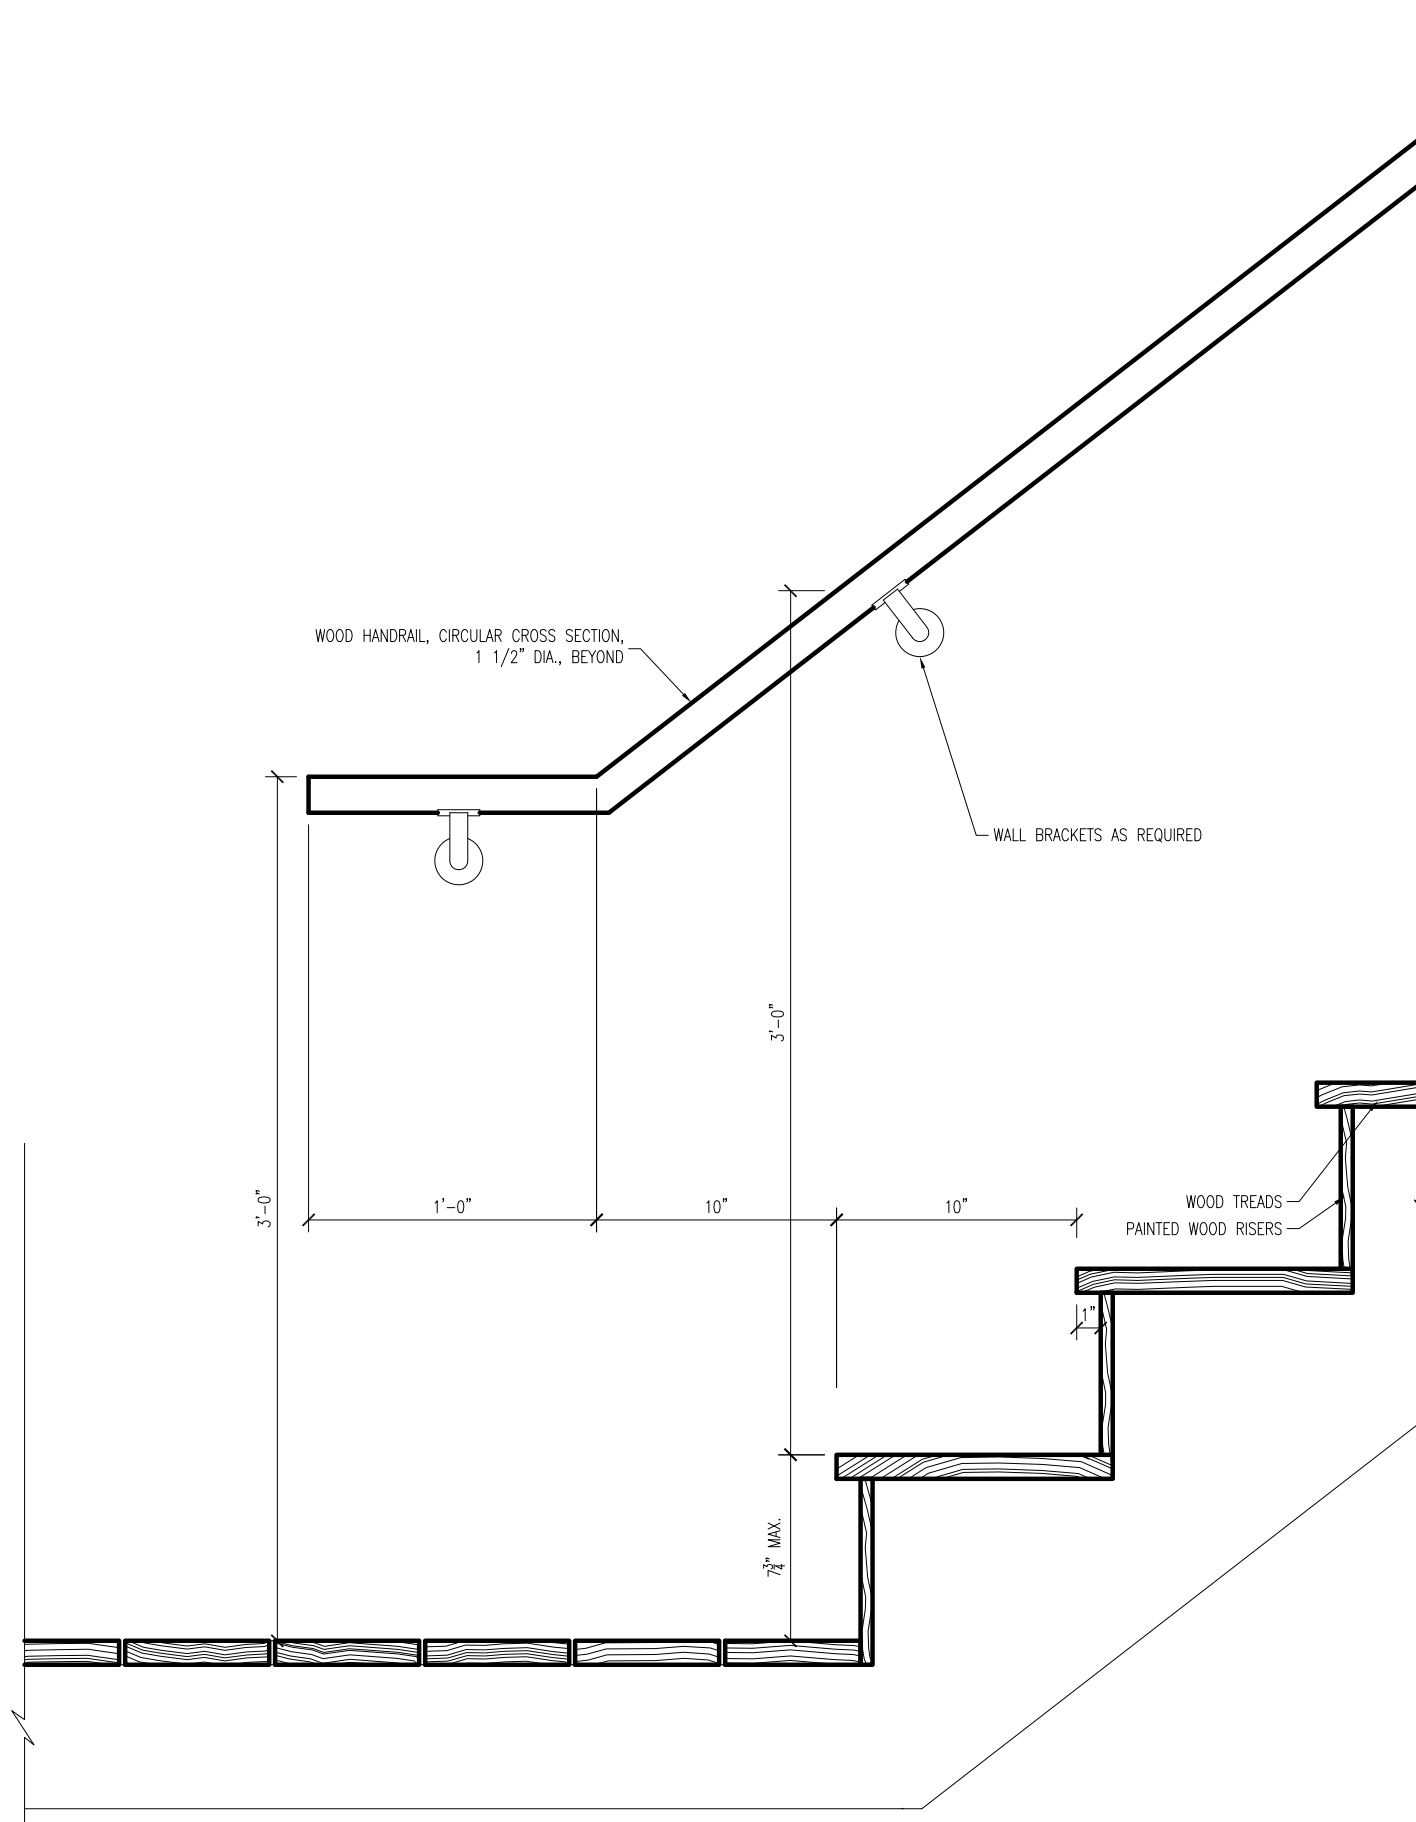
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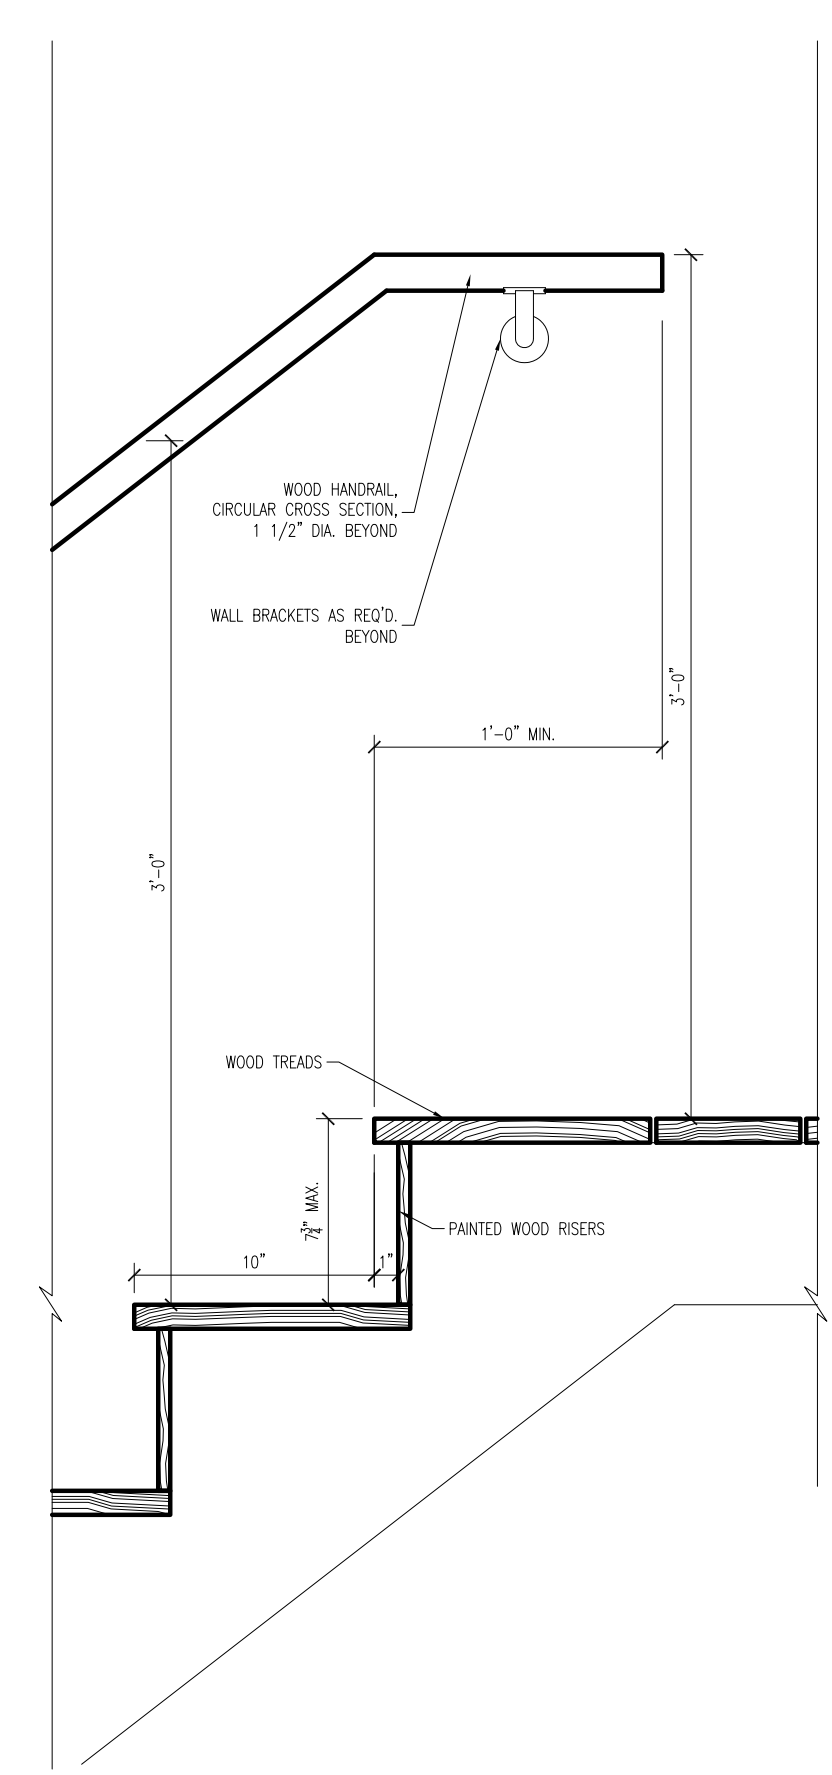
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| 02 | Issued for Revision | 03/30/2022 |
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| No. | Description | Date |
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| Drawing Title: Proposed Elevations | | |
| Project No.: 0--- | | |
| | | Checked by: EZ |


A-33




5 STAIR SECTION AT BASE OF STAIR
SCALE: 1 1/2" = 1'-0"




6 STAIR SECTION AT TOP OF STAIR
SCALE: 1 1/2" = 1'-0"

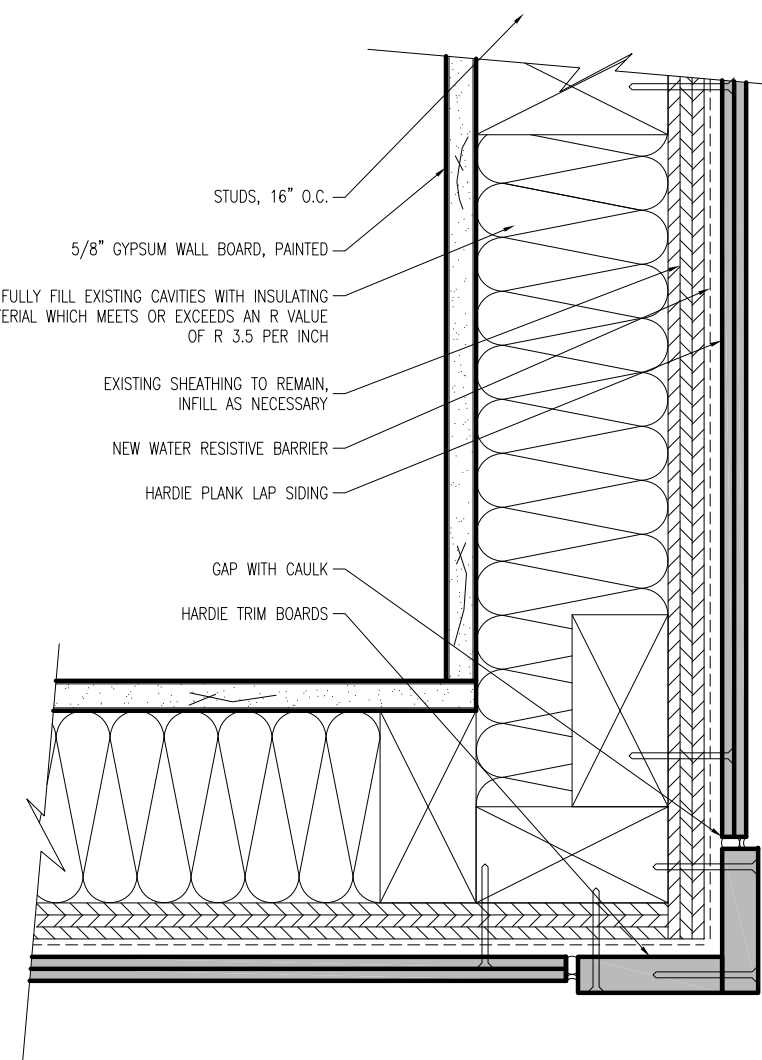


2 EXTERIOR WALL PLAN DETAIL
SCALE: 3" = 1'-0"

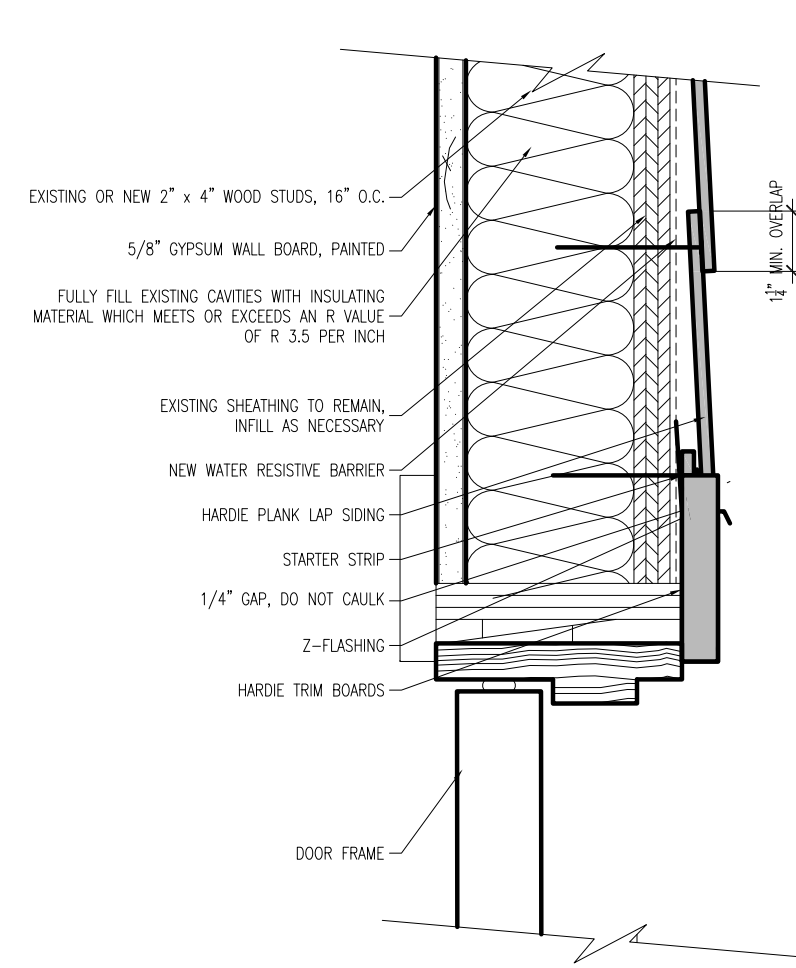


3 EXTERIOR WALL SECTION DETAIL
SCALE: 3" = 1'-0"

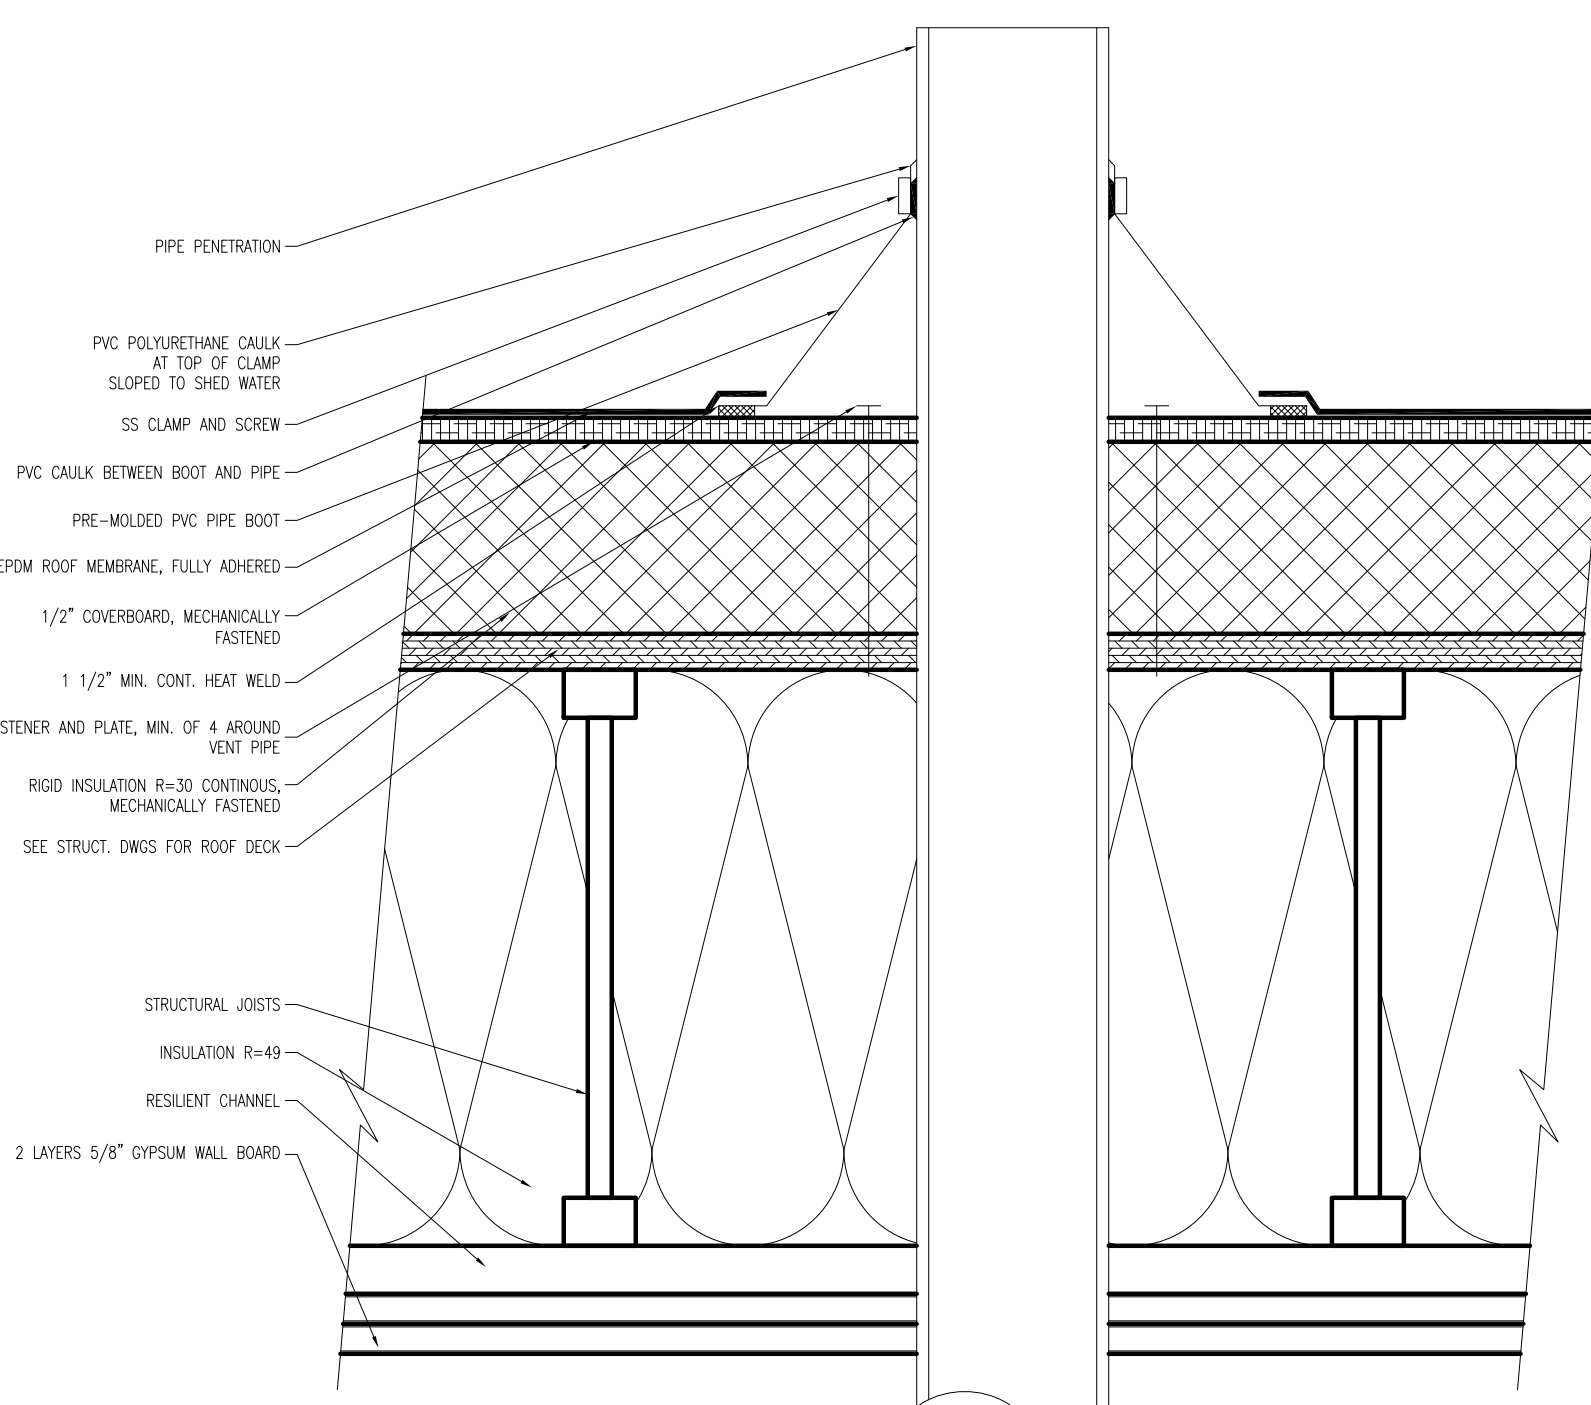


4 ROOF PENETRATION SECTION DETAIL
SCALE: 3" = 1'-0"

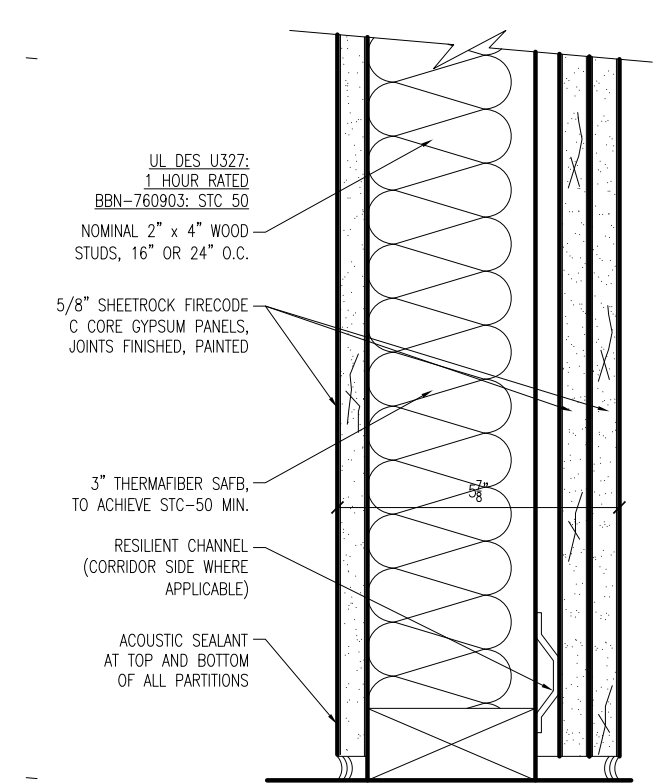


D WALL TYPE D
1 HOUR RATED
SCALE: 3" = 1'-0"

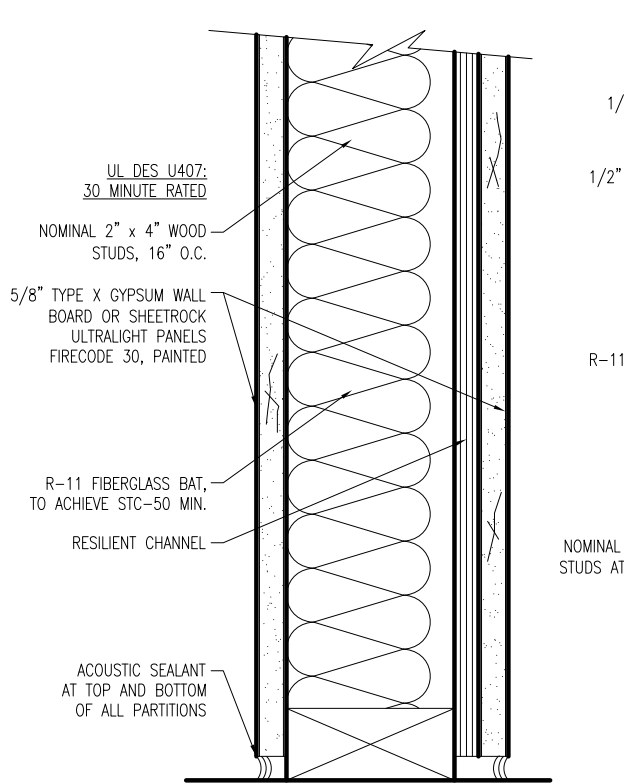


C WALL TYPE C
30 MINUTE RATED
SCALE: 3" = 1'-0"

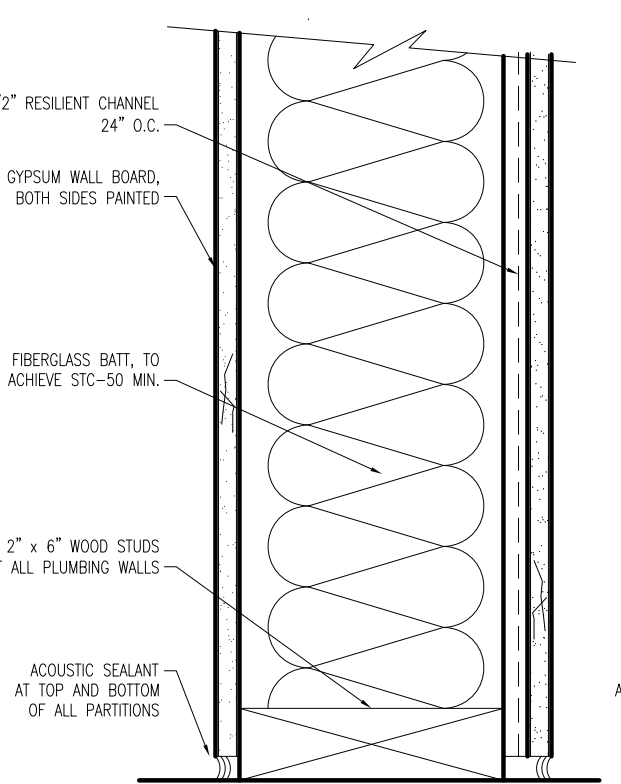


B WALL TYPE B
SECTION DETAIL
SCALE: 3" = 1'-0"

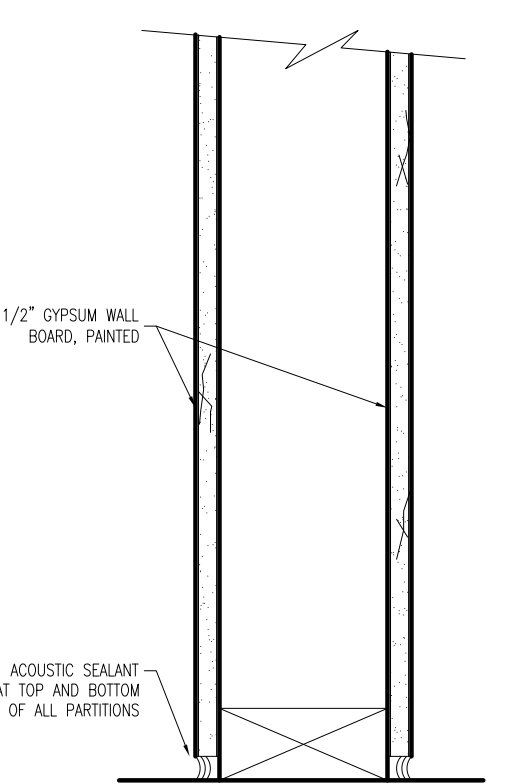

A WALL TYPE A
SECTION DETAIL
SCALE: 3" = 1'-0"

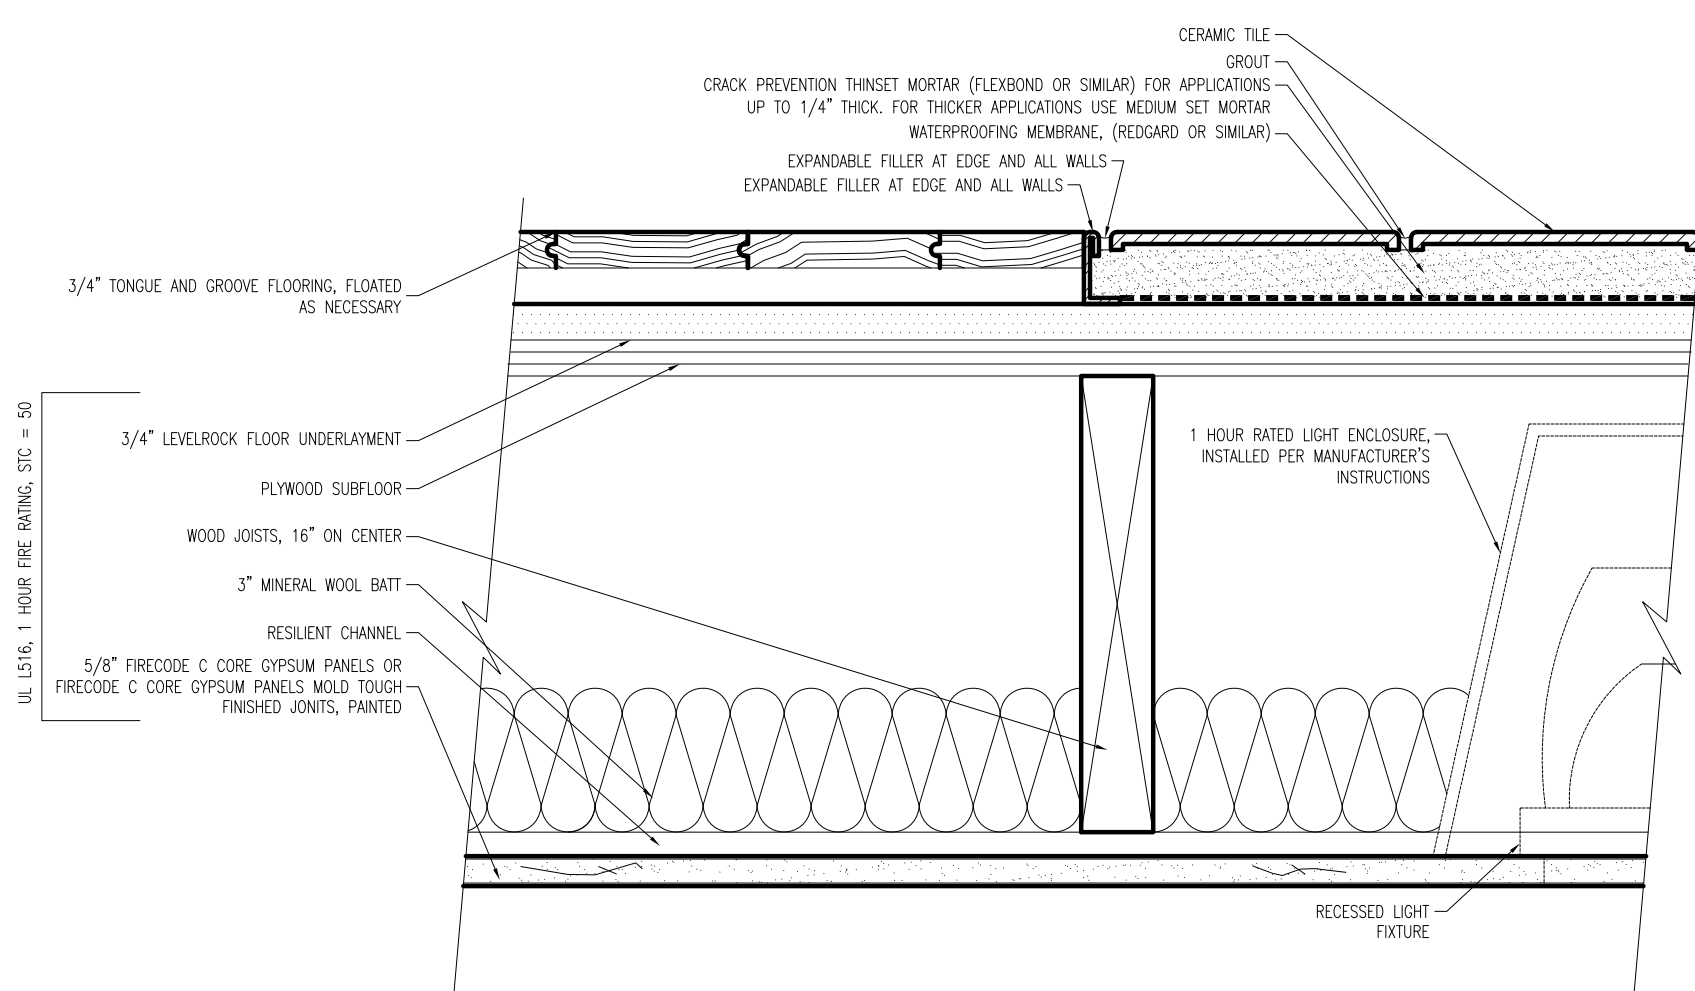

7 FLOOR SANDWICH SECTION DETAIL
SCALE: 3" = 1'-0"

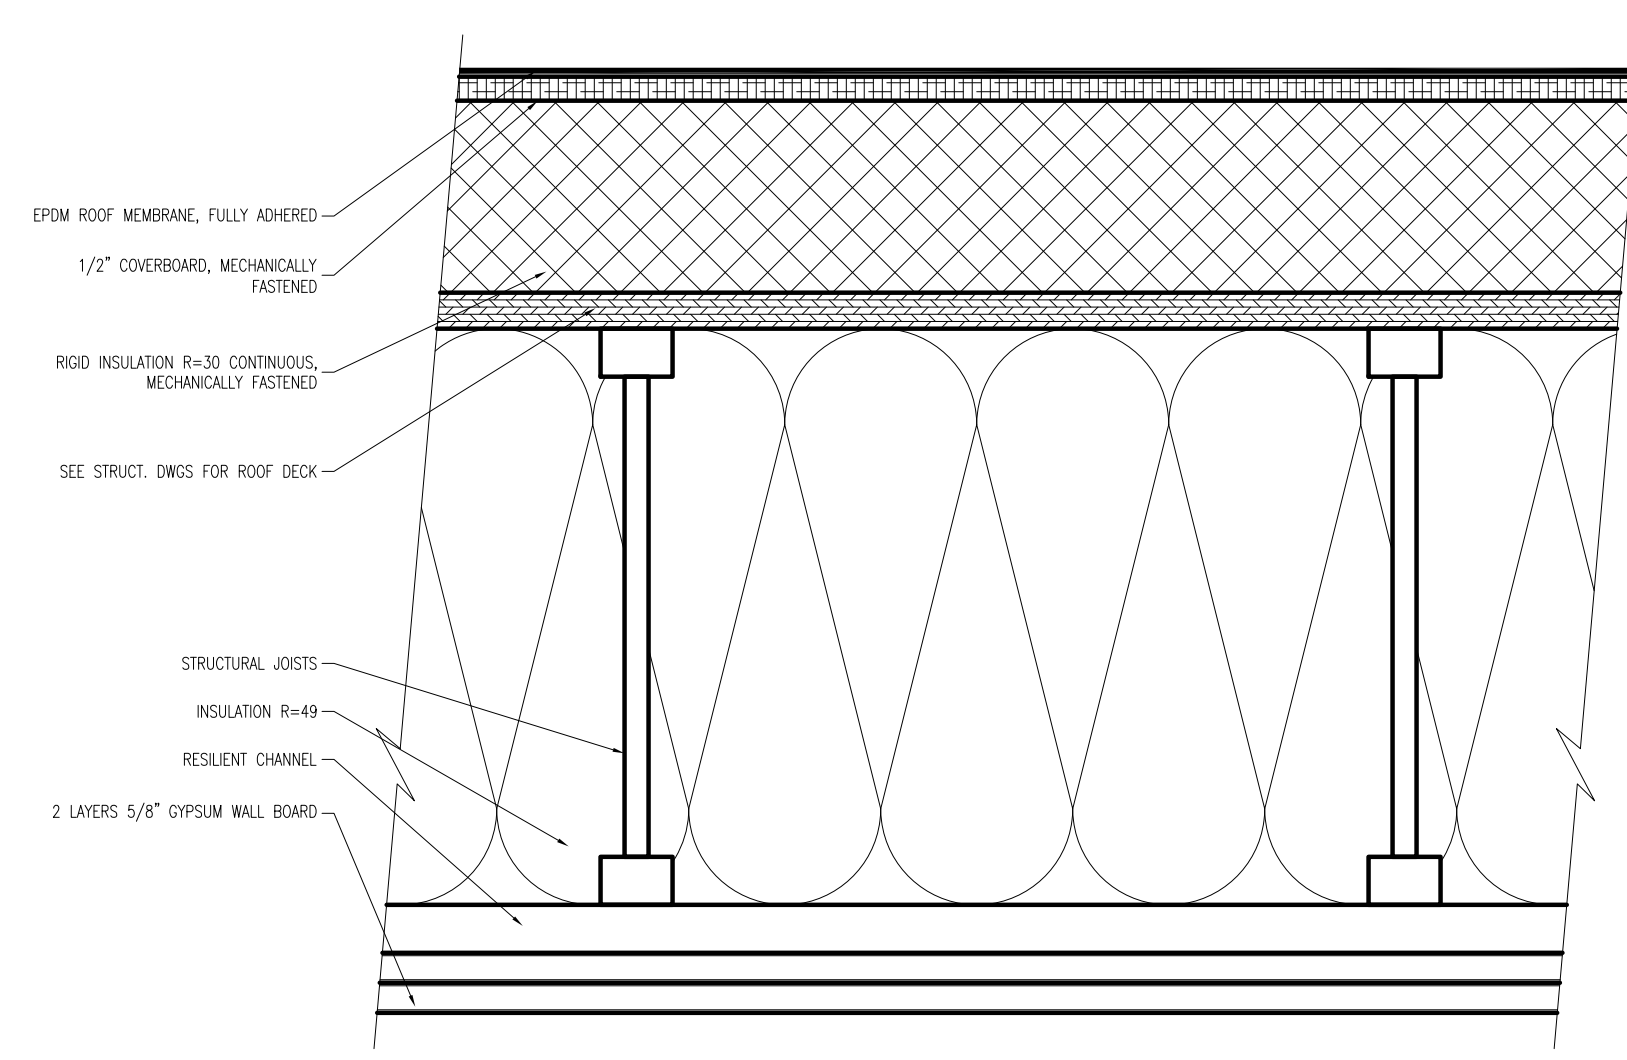

4 ROOF SANDWICH SECTION DETAIL
SCALE: 3" = 1'-0"



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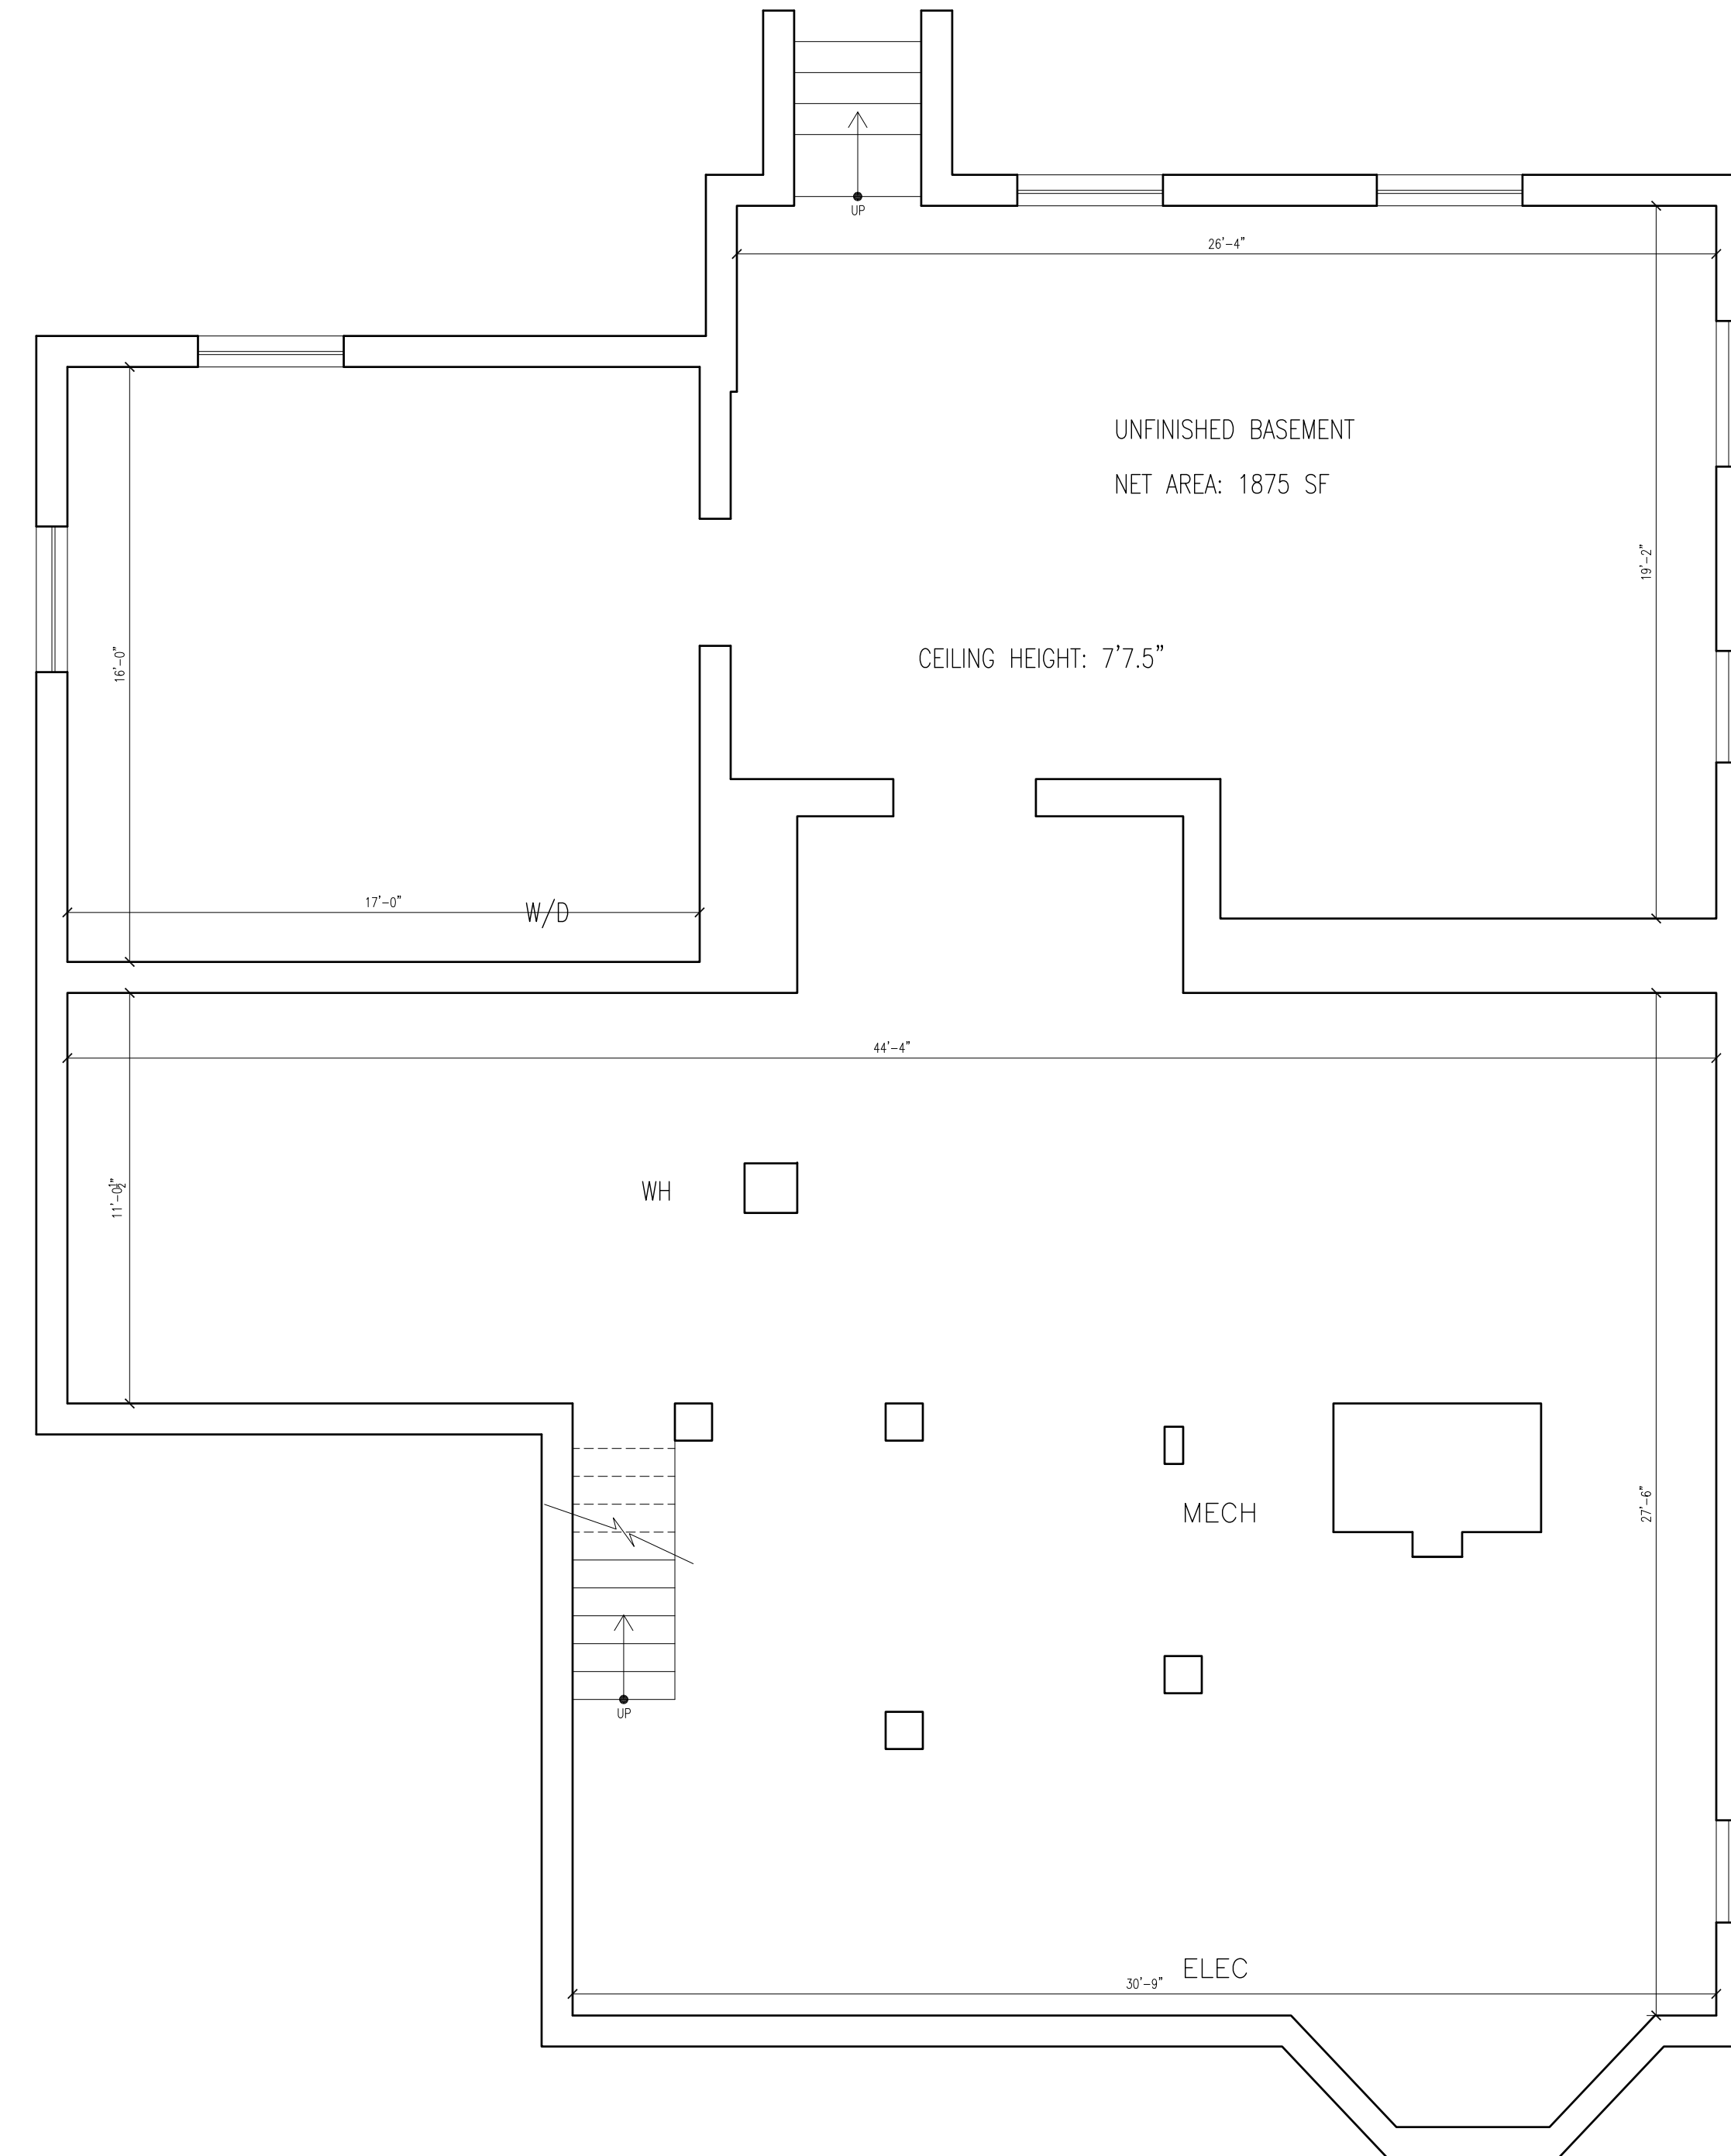
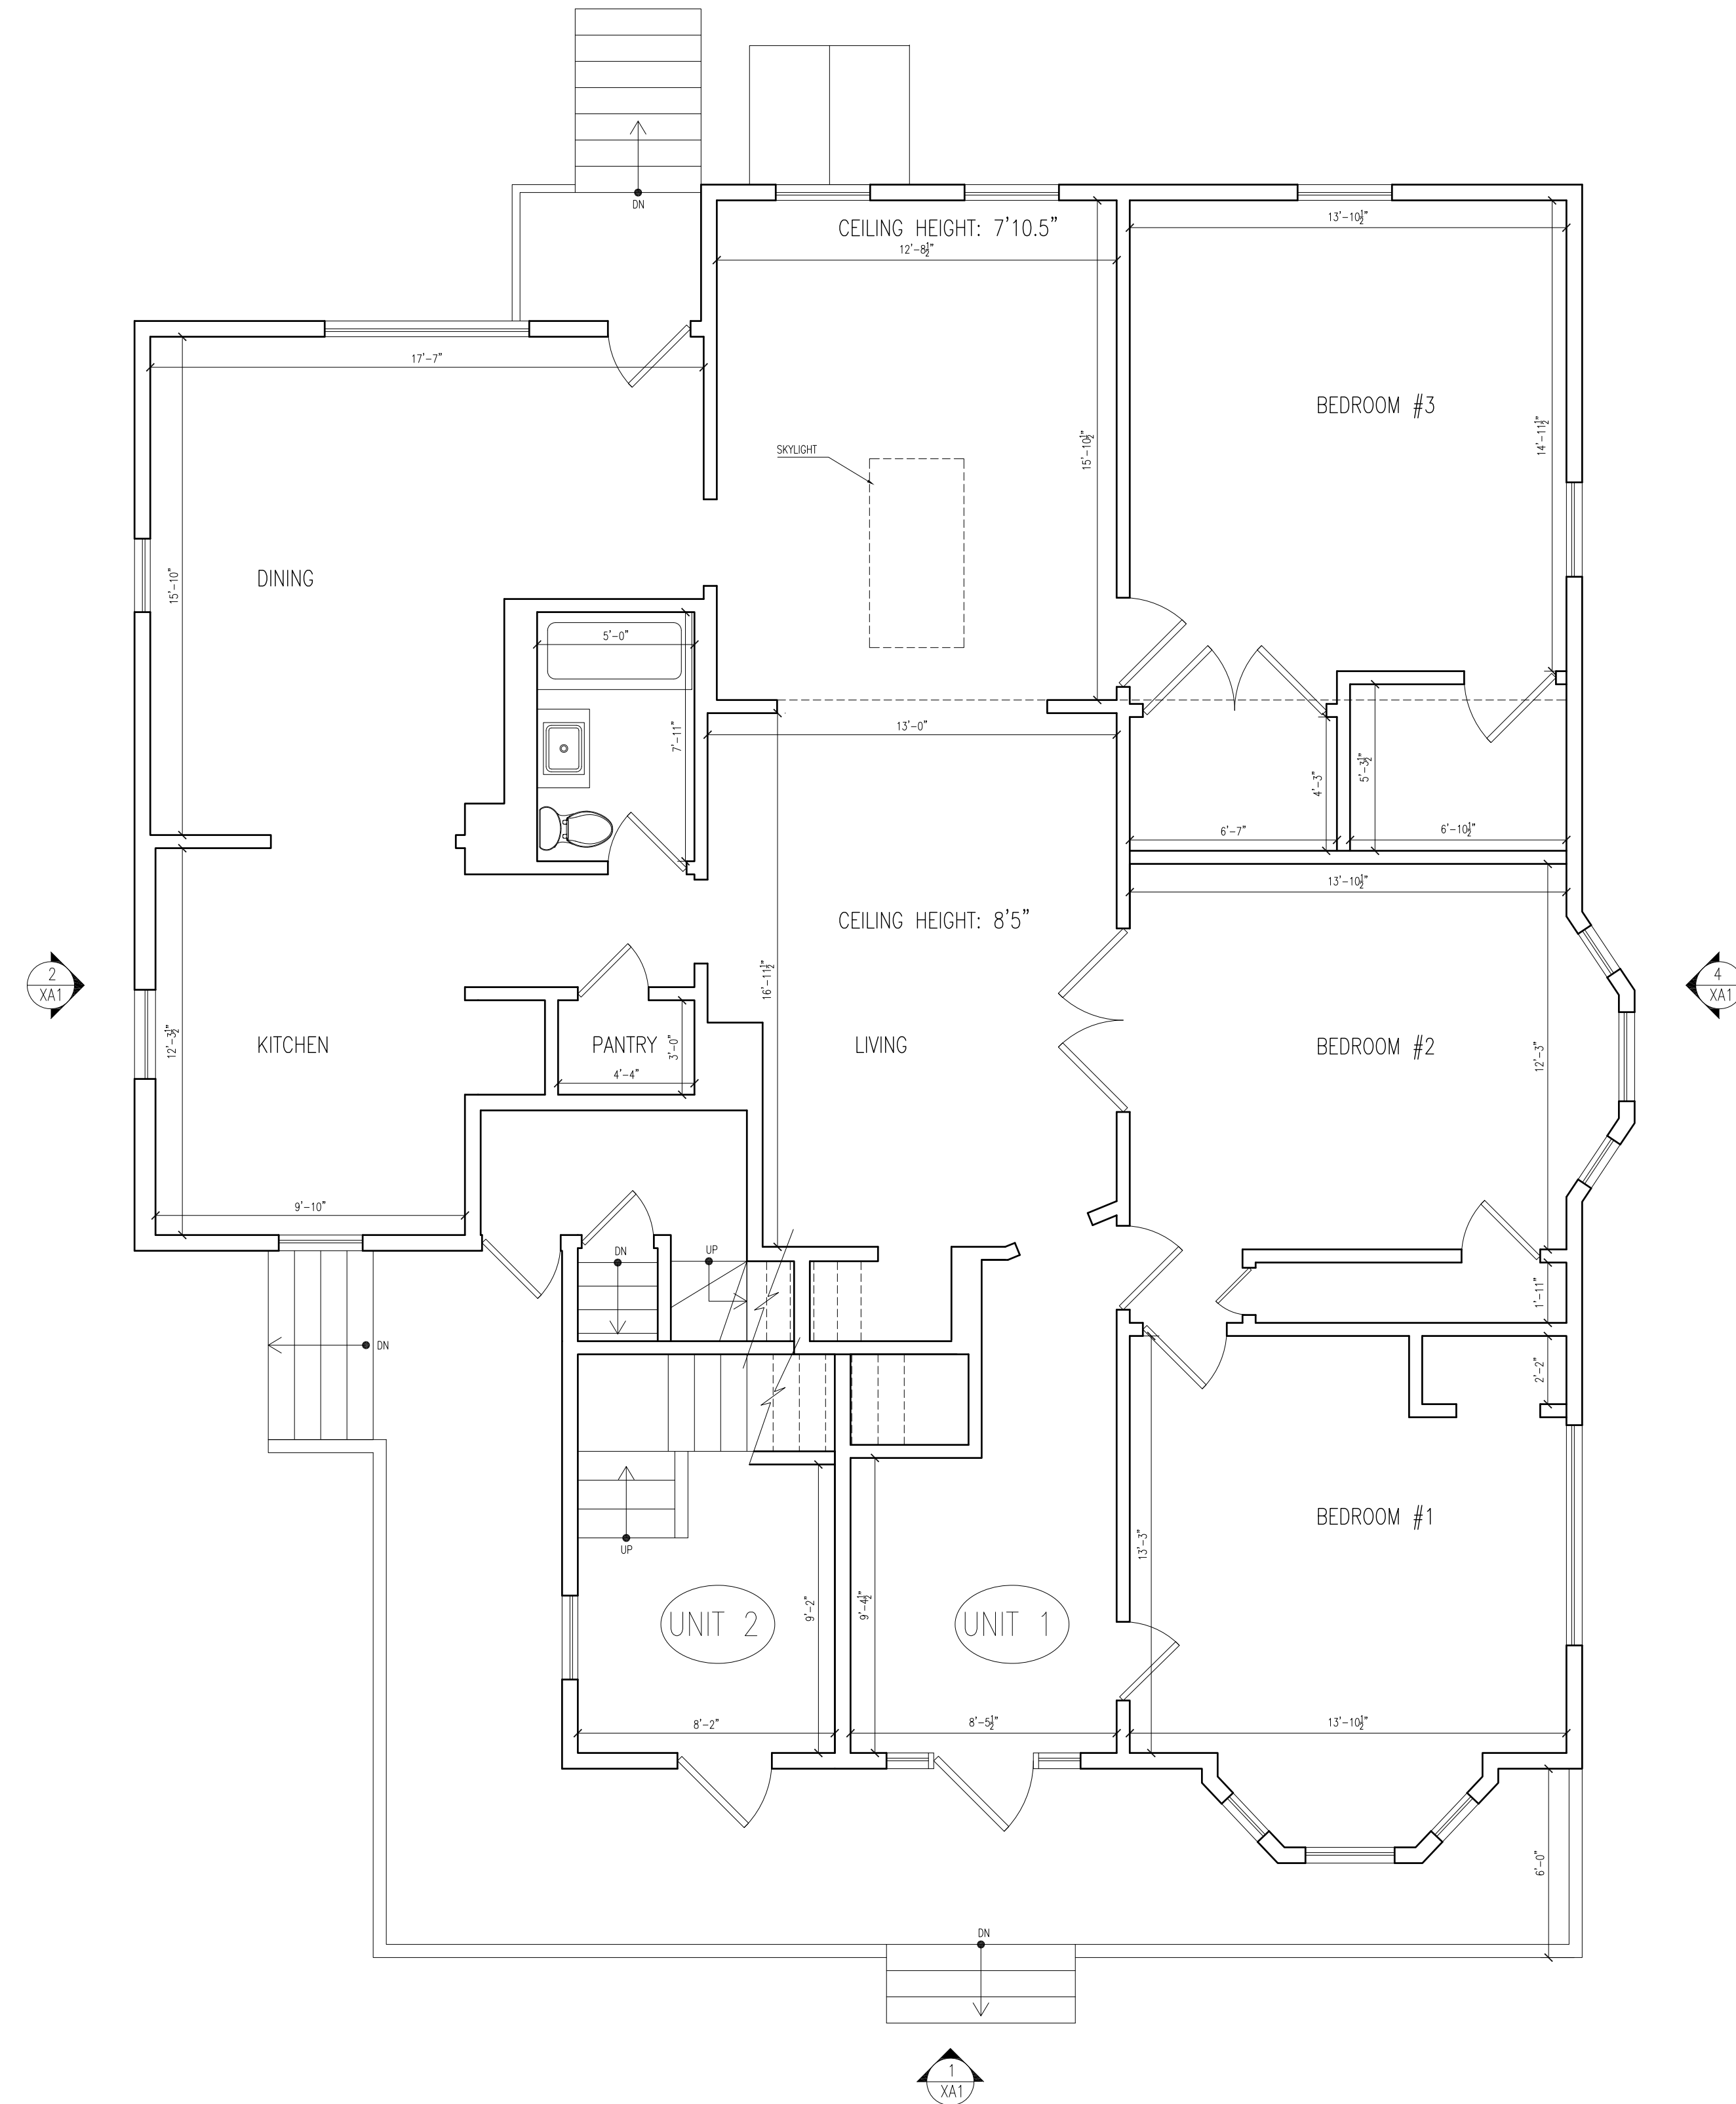
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| Drawing Title: Proposed Section and Details | | |

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A-40



B BASEMENT PLAN
SCALE: 1/4" = 1'-0"





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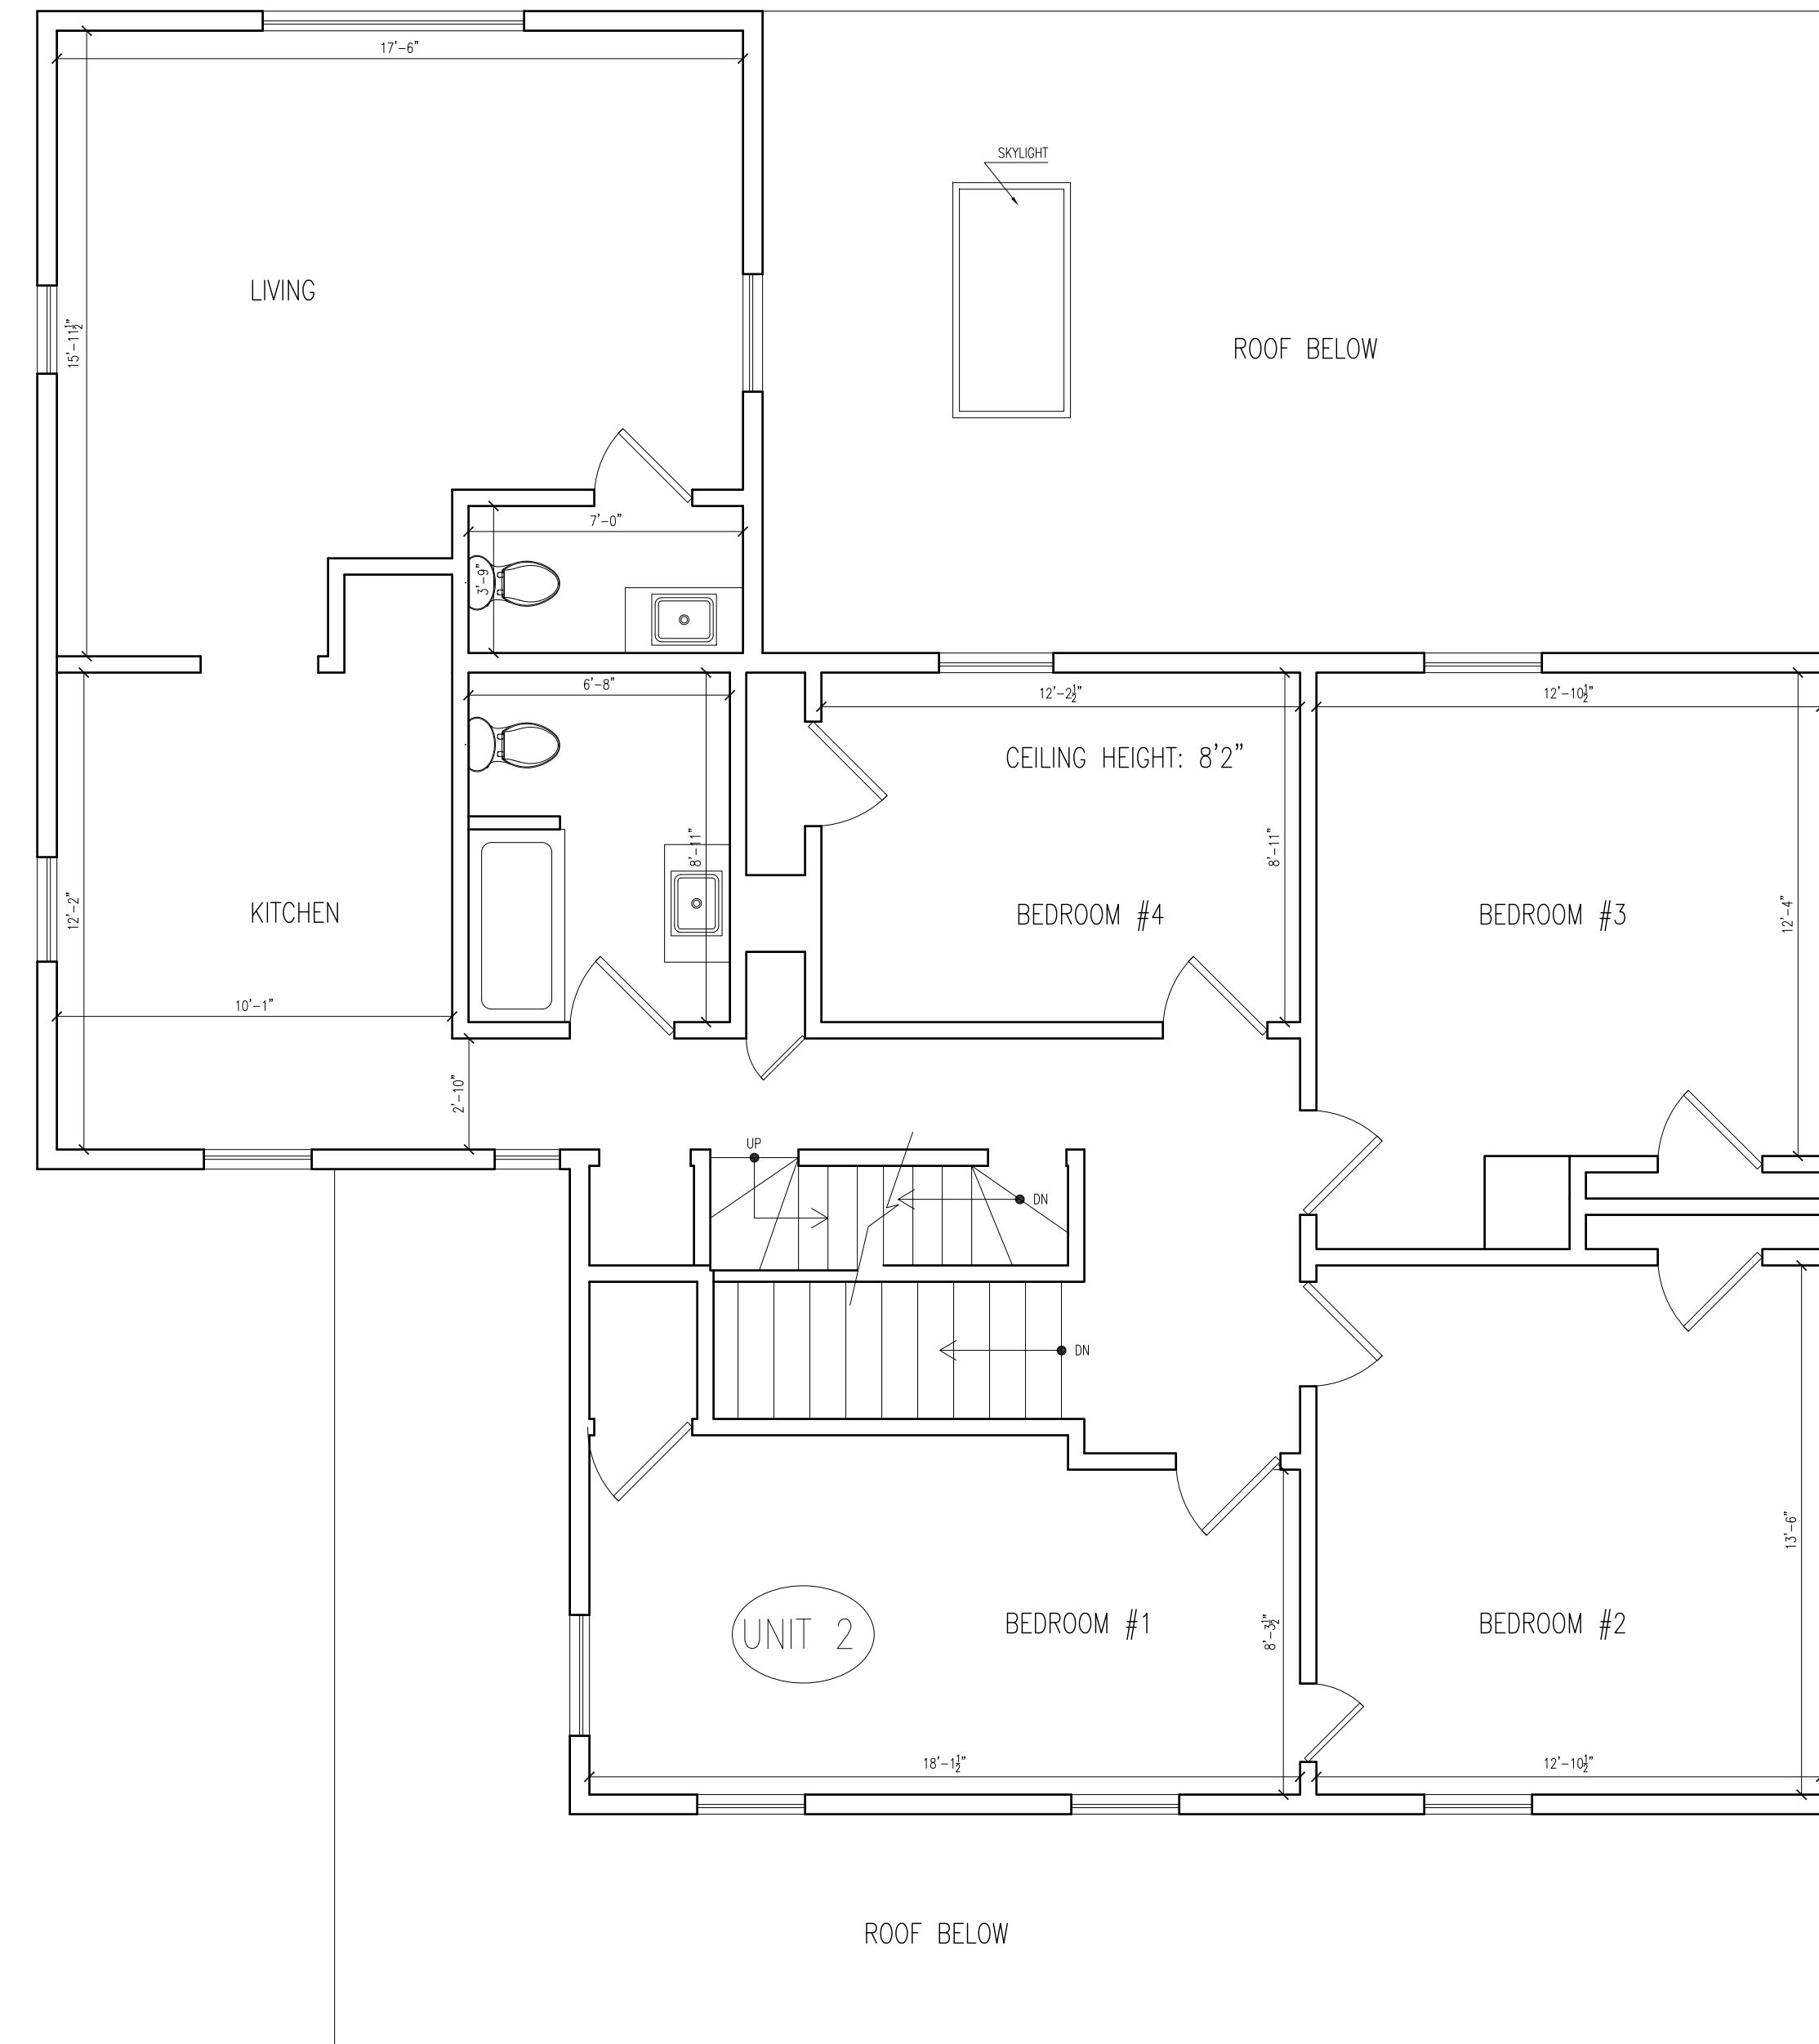
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| No. | Description | Date |
| Drawing Title: Existing Plans | | |
| Project No.: 0--- | | Checked by: EZ |

XA-1



3 LEVEL 3 PLAN
SCALE: 1/4" = 1'-0"

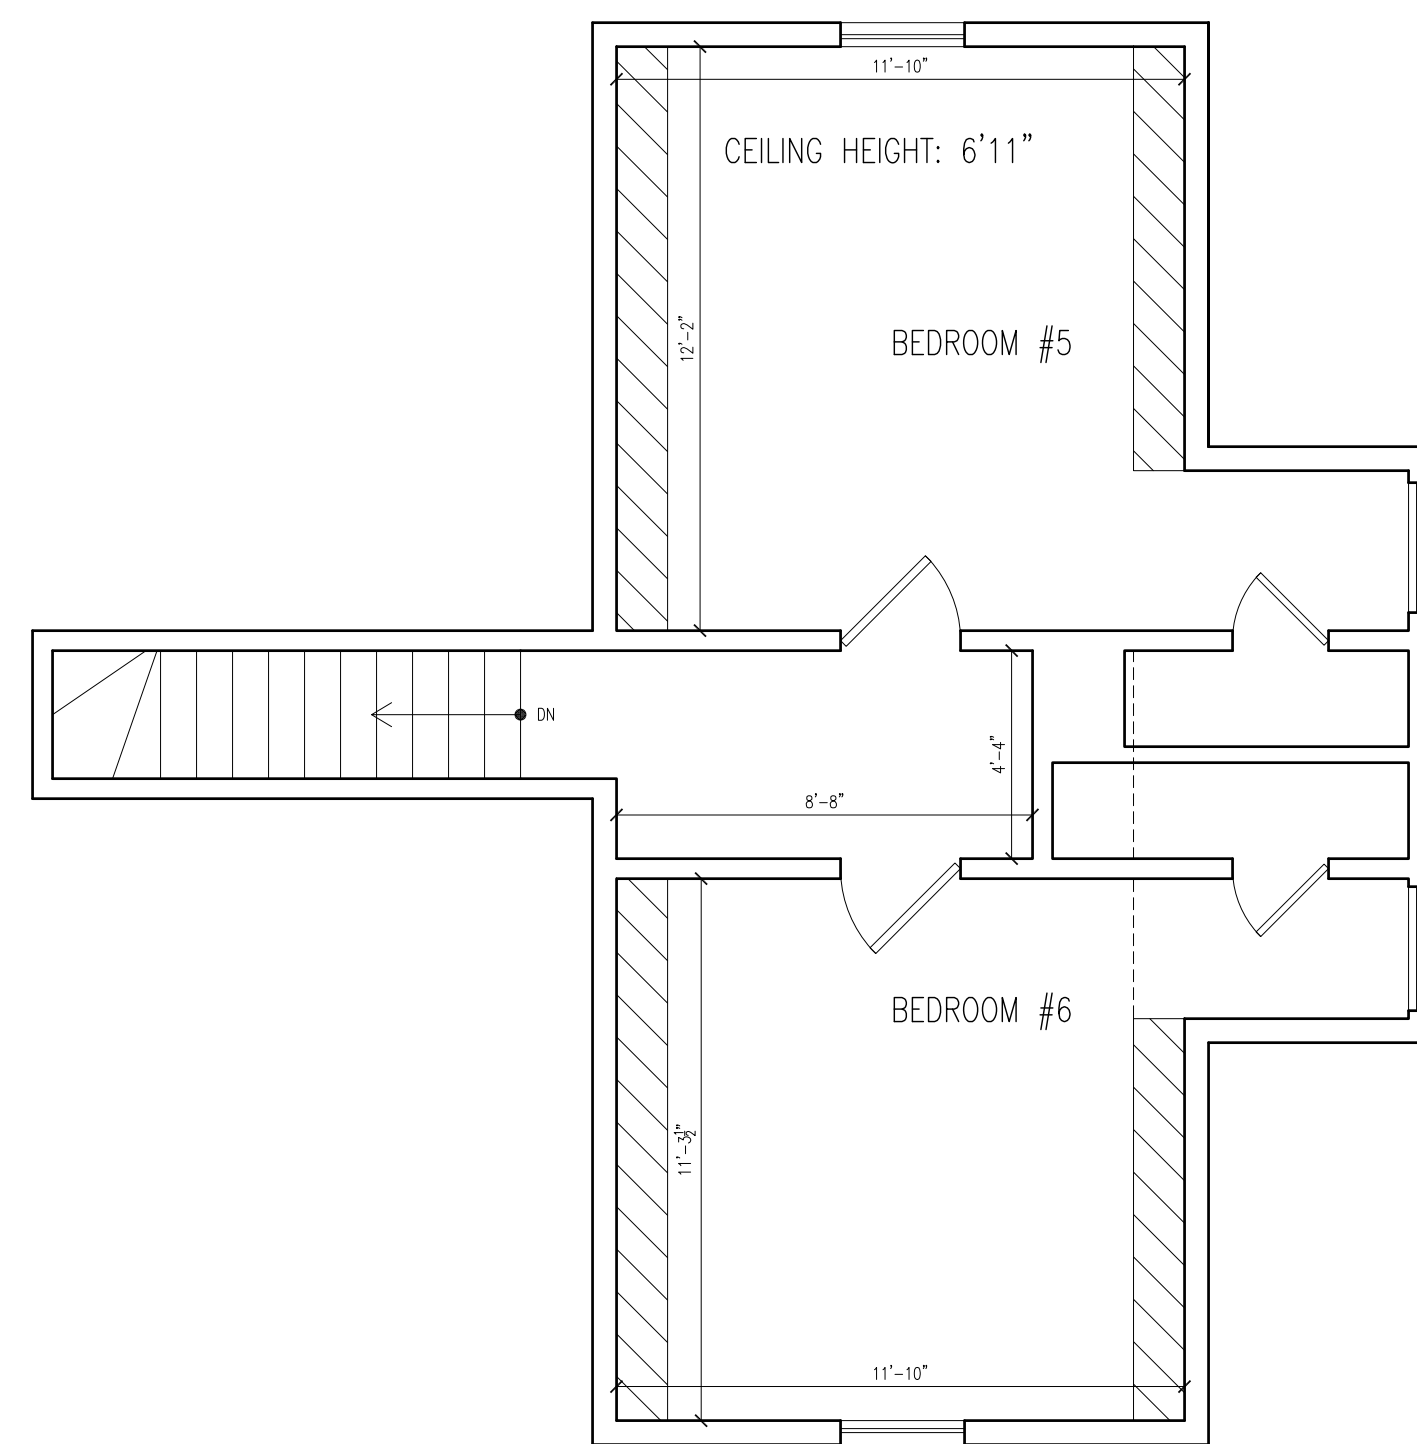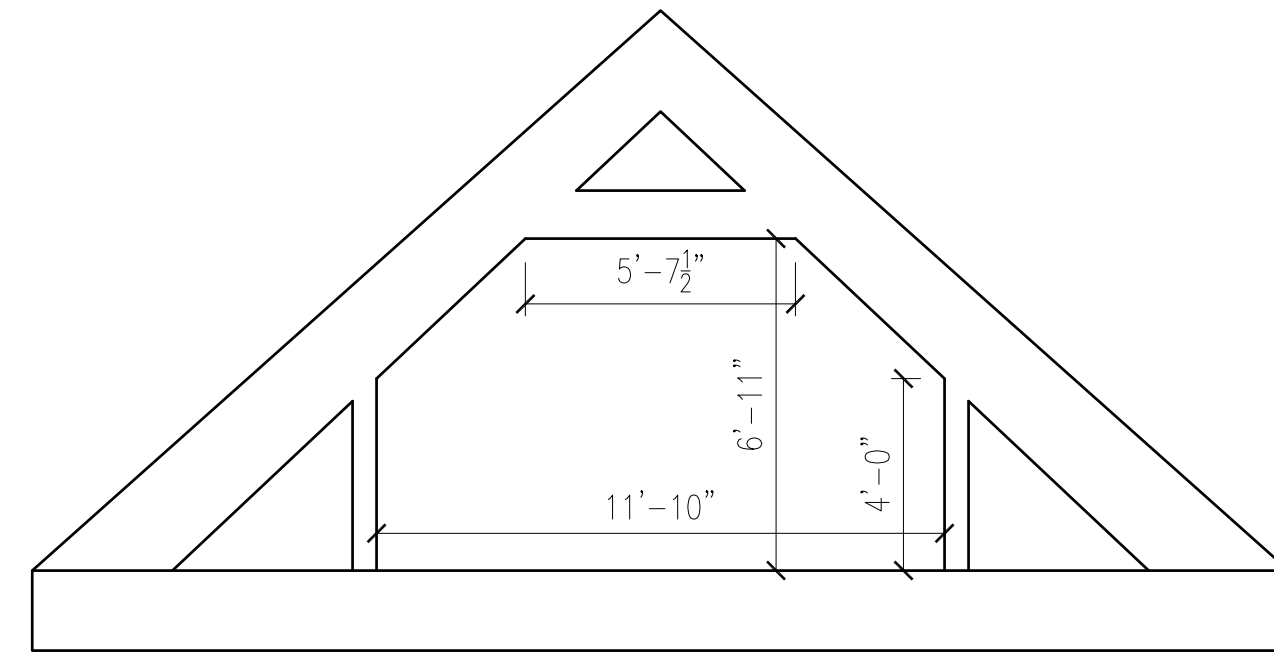

2 LEVEL 2 PLAN
SCALE: 1/4" = 1'-0"

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Drawing Title: Existing Plans

Project No.: 0--- Checked by: EZ



Eric Zacher

XA-2



1 EXISTING CABOT ST ELEVATION
SCALE: 1/4" = 1'-0"



2 EXISTING SIDE ELEVATION
SCALE: 1/4" = 1'-0"



3 EXISTING REAR ELEVATION
SCALE: 1/4" = 1'-0"



4 EXISTING SIDE ELEVATION
SCALE: 1/4" = 1'-0"



Eric Johnson

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Drawing Title: Existing Elevations

Project No.: 0--- **Checked by:** EZ

XA-3