# 113 GROVE ST REMODELING & ADDITION

113 GROVE STREET

NEWTON, MASS

LIST OF DRAWINGS: A-1 AS BUILT FLOOR PLANS


A-2 AS BUILT EXTERIOR ELEVATIONS

A-3 NEW DESIGN FLOOR PLANS

A-4 NEW DESIGN ELEVATIONS




113 GROVE ST REMODELING & ADDITION						
SCALE		PATE SD 2-20-22	DRAWING NO.			
TITLE	+1+1 =					
TITLE SHEET						
	C, D, C A	LHOU	N			

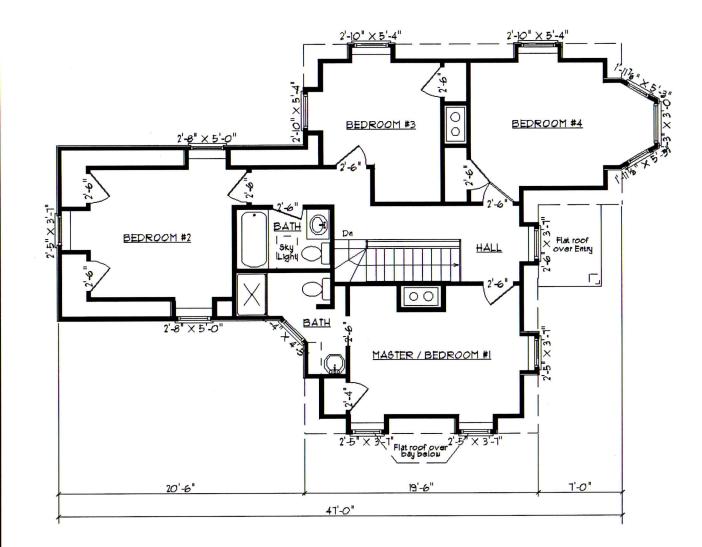

### AS BUILT SECOND FLOOR PLAN

Total living area = 889 SF

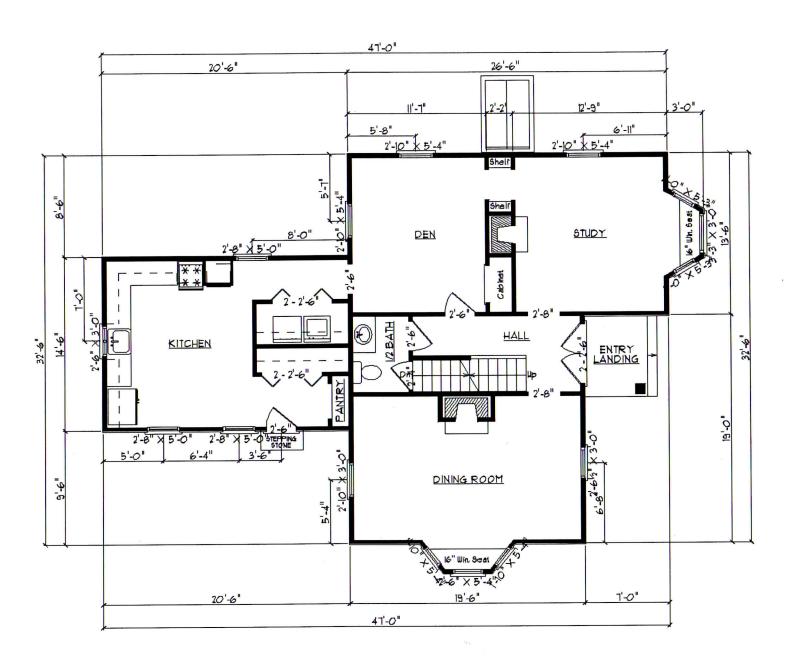

## AS BUILT FIRST FLOOR PLAN


Total living area = 1,071 SF



\* GENERAL AND OR 6UB CONTRACTOR 6HALL VERIFY ALL DIMENSIONS PRIOR TO ORDERING MATERIALS AND STARTING CONSTRUCTION. ALL STATE AND LOCAL BUILDING CODES SHALL BE ADHERED TO ANY DISCREPANCIES SHALL BE BROUGHT TO OWNER OR C.D. CALHOUNS ATTENTION. DO NOT FIELD MEASURE DRAWINGS FOR LAYOUT PURPOSES ASK QUESTIONS!





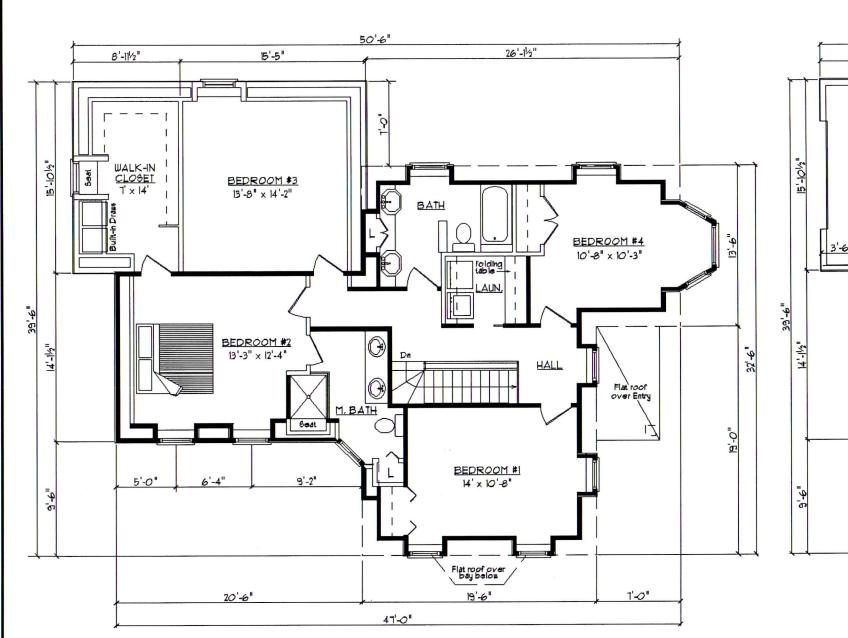



Total living area = 1,277 SF [Exist. 889 SF + 388 SF]

NEW DESIGN SECOND FLOOR PLAN

Total area = 1,459 SF [ Exist. 1,071 SF + 388 SF [ Garage ]

20'-6"

KITCHEN 14'-1" × 13'-10"

7' ISLAND

STEPPING STONE

14'-6"



50'-6"

24'-41/2"

CAR GARAGE

23'-6" × 15'

MUD RM

POWDER RM

6'-0"

26'-1/2"

 $\bigcap$ 

LIVING ROOM

17'-6" × 16'-6"

DINING ROOM 19' X 12'

Server above \_ Storage below 3'-0"

HOME OFFICE

8' × 13'

ENTRY LANDING

5'-4"

1'-0"

### LEGEND:

FOYER

WALLS SHOWN AS SOLID ARE EXISTING.

WALLS SHOWN AS HOLLOW ARE NEW 

□


REMODEL & ADDITON TO 113 GROVE STREET

1/8" = 1'-0" DATE SD 2-14-22 REVISED A - 3 A - 3

NEW DESIGN FLOOR PLANS

51 SACHEM DRIVE SAGAMORE BEACH, MASS. 02532 508 - 833 - 3706



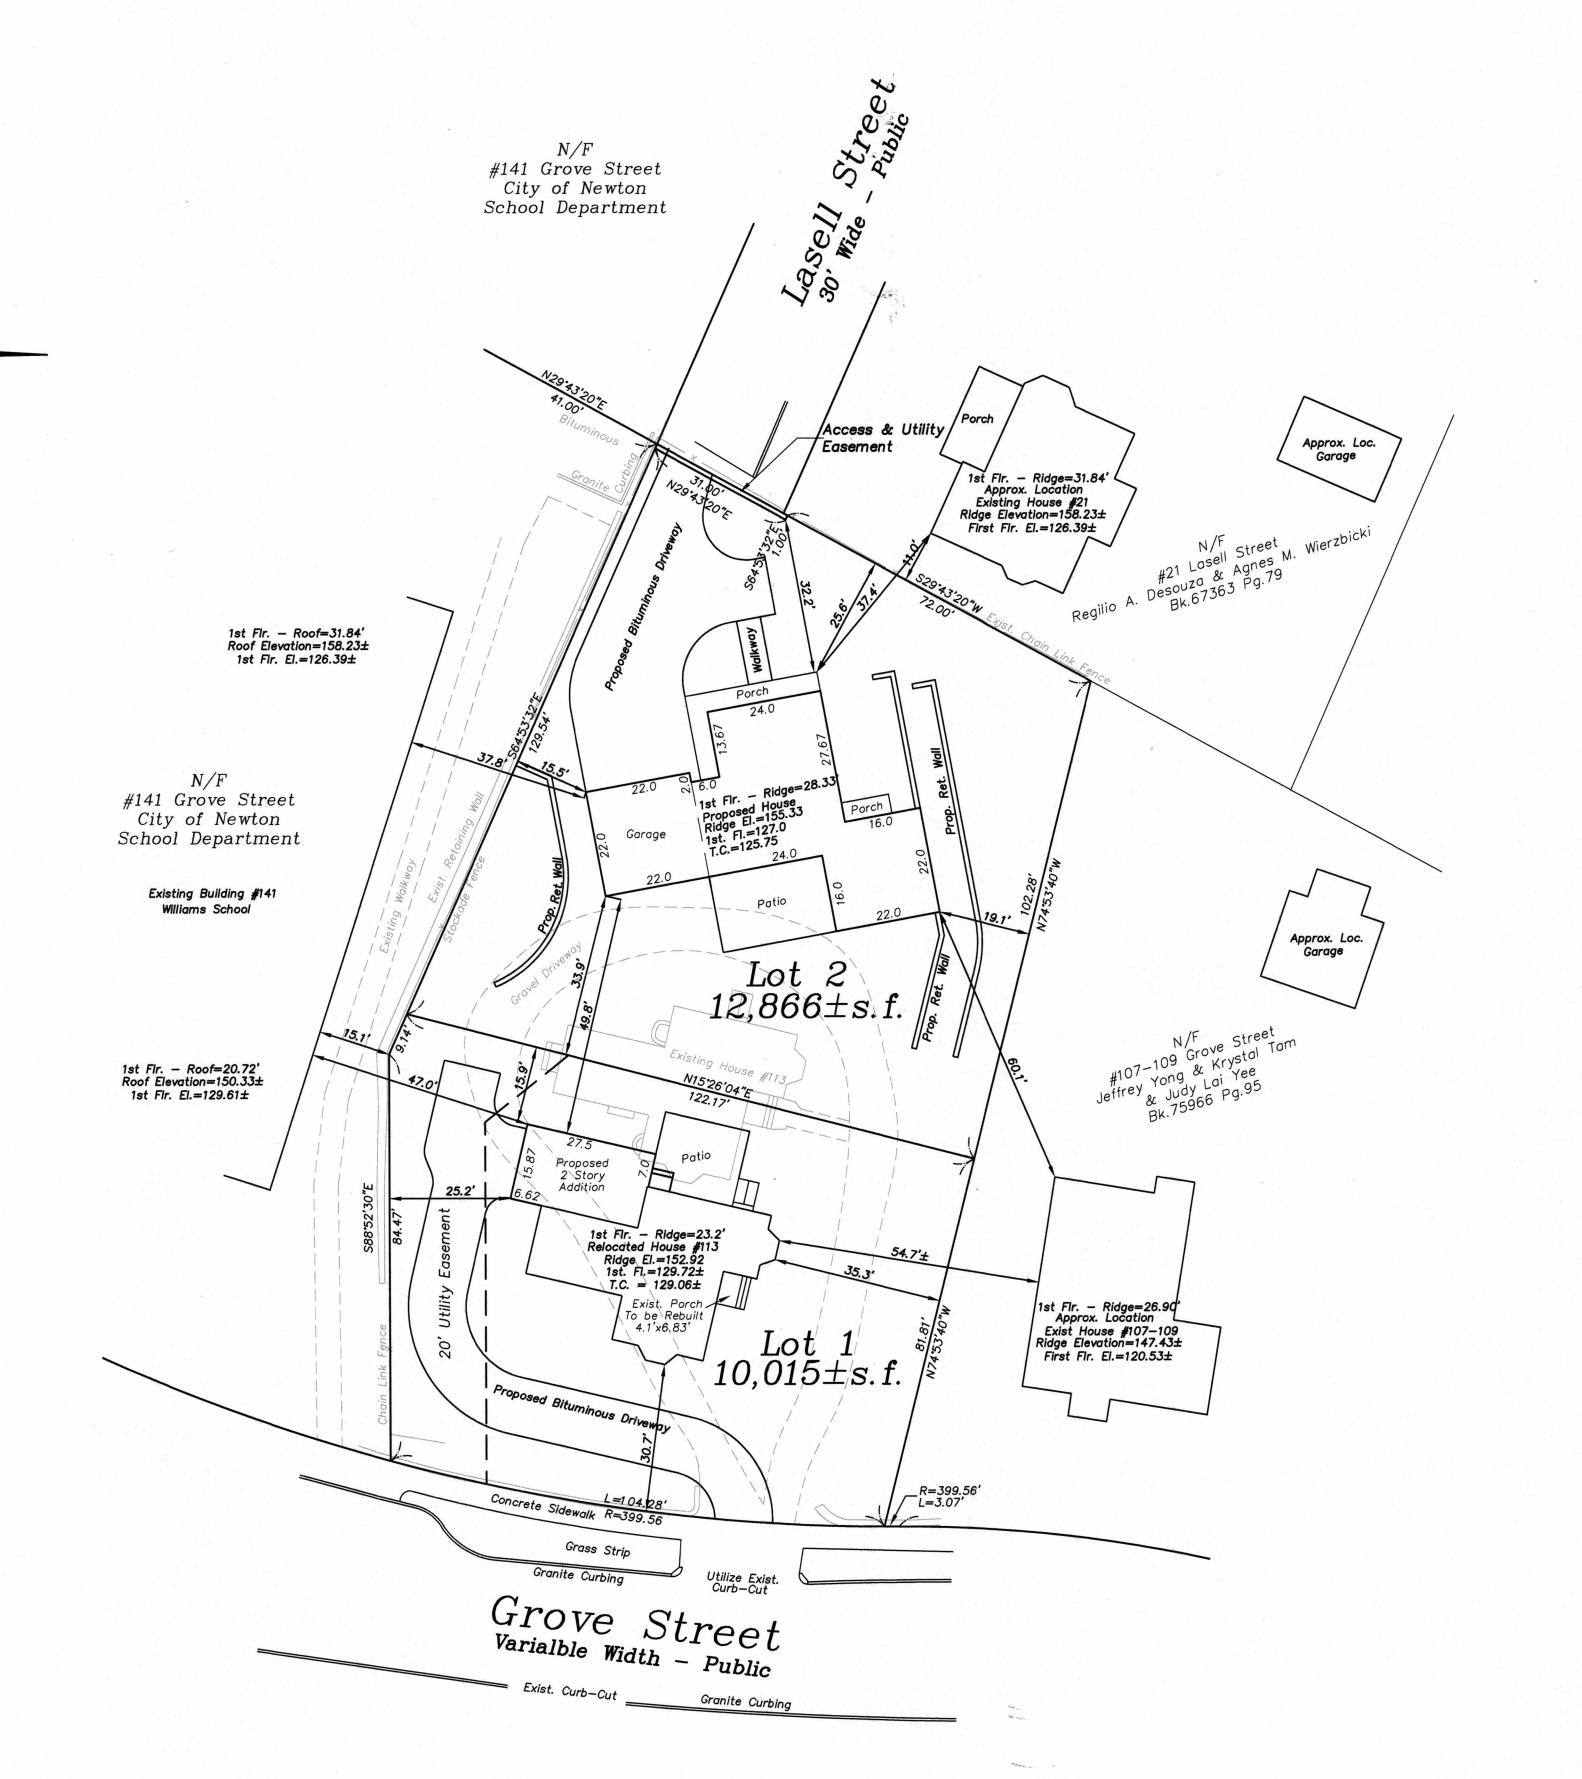

Dig Safe

Excavators

Before you dig contact the Dig Safe Center.

To prevent damage to telephone, gas or electric underground facilities of member utilities, call toll free

Massachusetts state law requires notification at least three business days before you start digging operations. In an emergency, call immediately.



	ZON	IING CHA	NRT	
113 Grov	e Street	, Newton	n, Massachuse	tts
	ZONE	: SR-3	New	
REGULATION	REQU Front Lot 1	IIRED Rear Lot 2	Front Lot 1	Rear Lot 2
LOT AREA	10,000SF	12,000SF	10,015S.F.	12,866S.F.
LOT FRONTAGE	80'	80'	104.28'	122.17'
FRONT SETBACK	30'	30'	30.7'	33.9'
SIDE SETBACK	10.0'	15.0'	25.2'/35.3'	15.5'/19.1'
REAR SETBACK	15.0'	23.0'	15.9'	25.6'
BUILDING HEIGHT	36.0'	36.0'	26.0'+/-	32.0'+/-
LOT COVERAGE	30%	25%	15.23%	16.60%
OPEN SPACE	50%	50%	68.20%	71.24%
FAR Existing			0.20	0
FAR Proposed			0.26	0.23
FAR Allowed	0.41	0.24		

~Zoning Plan~ 113 Grove Street

Newton, Massachusetts

REVISIONS


DESCRIPTION ABBUTING BUILDING HEIGTS, ELEVATIONS

July 22, 2022 Scale: 1"=20'

VERNE T. PORTER Jr, PLS

Land Surveyors — Civil Engineers

354 Elliot Street, Newton, Ma. 02464

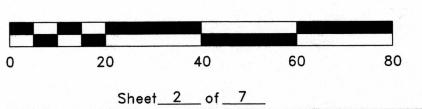

Job #21043 Design By:GNB Checked By:VTP Drawn By:GNB

# DIMENSIONAL CRITERIA: SETBACKS, LOT COVERAGE, OPEN SPACE BUILDING HEIGHT, FAR

#### **SETBACKS**

- Lot 1 front setback 31 feet (30 feet required)
- RIGHT (north) side setback 35.3 feet (10 feet required)
- LEFT (south) side setback 25.2 (10 feet required)
- REAR (west) setback 15.4 feet (15 feet required)
- Lot 2 front setback 33.9 feet (30 feet required)
- Left (south) side setback- 15.5 feet (15 feet required)
- Right (north) side setback 19.1 feet (15 feet required)

#### LOT COVERAGE

- LOT 1: Lot Coverage 15.23%, below the maximum 20.0% allowed
- LOT 2 Lot Coverage 16.6%, well below the maximum 25% allowed

#### **OPEN SPACE**

- LOT1 Open Space 71.2%, well above the required 50%.
- LOT 2 Open Space 68.2%, well above the required 50%.

#### **FAR**

- LOT 1 has a floor area ratio (FAR) of 0.26, well below the max 0.41 allowed by right.
- LOT 2: has a floor area ratio (FAR) of 0.23, below the maximum 0.24 allowed for a single family detached dwelling on a rear lot in an SR3 zone.
- In aggregate the two dwellings contain 5,579 sq. ft. of floor area. On the
  existing undivided 23,063 SF lot this would represent a combined FAR of
  0.24, less than the maximum 0.37 allowed for a single-family dwelling on a
  lot that size in a SR3 district.

#### **BUILDING HEIGHT**

- LOT 1: 29.98 feet, below the maximum 36 feet allowed
- LOT 2: 32 feet, below the maximum 36 feet allowed.

### City Council shall also consider the following additional criteria:

- whether the proposed buildings or structures exceed the respective average height of abutting residential buildings (§7.3.4.B.1)
- SCALE OF PROPOSED BUILDINGS in relation to adjacent residential buildings and character of the neighborhood (§7.3.4.B.2)
- TOPOGRAPHIC DIFFERENTIALS, if any, between proposed buildings or structures (§7.3.4.B.3)
- proposed LANDSCAPE SCREENING (§7.3.4.B.4)
- ADEQUACY OF VEHICULAR ACCESS, including, but not limited to fire and other public safety equipment, (§7.3.4.B.5)
- HISTORIC OR CONSERVATION PUBLIC BENEFIT is advanced by the proposed development (§7.3.4.B.6)
- SITING OF THE BUILDINGS WITH REFERENCE TO ABUTTING RESIDENTIAL BUILDINGS (§7.3.4.B.8);
- IMPACT OF PROPOSED LIGHTING ON THE ABUTTING PROPERTIES

  (§7.3.4.B.9)